

LOCATION

SCOPE OF WORK:

- TENANT IMPROVEMENT FOR KOREAN BBQ RESTAURANT ON EXISTING RESTAUNT.

APPLICABLE CODES

- 2015 INTERNATIONAL BUILDING CODE
- 2014 NATIONAL ELECTRIC CODE
- 2015 INTERNATIONAL PLUMBING CODE
- 2015 INTERNATIONAL MECHANICAL CODE
- 2015 INTERNATIONAL FUEL GAS CODE
- 2015 INTERNATIONAL ENERGY CONSERVATION CODE
- 2004 ANSI A117.1
- SALT LAKE COUNTY HEALTH DEPARTMENT REGULATION

LEGAL DESCRIPTION

PARCEL NUMBER: 22-30-107-038-0000
ZONING: S5
ZONING DESCRIPTION: STATE STREET
LOT SIZE: 0.83 ACRES
LOT USE: COMMERCIAL

LEGAL DESCRIPTION
BEG E 265.38 FT & S 1020.01 FT FR NW COR SEC 30, T2S, R1E, S1M; S 89,142.16" E 265.3 FT; N 151.58 FT; W 75.69 FT; S 3,156.10 FT; W 180 FT; S 4,100.25" W 139.15 FT TO BEG. LESS & EXCEPT BEG E 253.45 FT & 1190.31 FT S FR NW COR SD SEC 30; N04,100'25" E 284.66 FT; S 02,127'11" W 142.58 FT; S 04,115'42" W 95.82 FT; S 1Y ALG 44 FT RADIUS CURVE TO THE L 17.66 FT (CHD S 07 1/4' E 17.54 FT); S 81,148'08" E 5.29; S 43,116'39" E 88.37 FT; N 89,142'16" W 41.69 FT TO BEG. 0.83 AC M OR L. 6034-2962 5996-702 3366-383 3039-805 806 2837-146 739-602 604 6242-1819 8863-7462 10105-2412

PROJECT DATA

BUILDING USE: COMMERCIAL
CONSTRUCTION TYPE: TYPE VA
PROPOSED
NUMBER OF STORY: 1 STORY
OCCUPANCY GROUP: A-2
FLOOR AREA: 4,700 SF
OCCUPANT LOAD

PROPOSED OCCUPANT LOAD ANALYSIS			
ROOM	AREA	F.A./OCC	OCCU. LOAD
DINING AREA	2334 SF	FIXED SEAT	179
STORAGE/MECH	454 SF	300	2
KITCHEN	620 SF	200	4
BAR	108 SF	200	1
LOCKER	48 SF	50	1
REST. RM	1131 SF	0	0
CORRIDOR			
TOTAL	4700 SF		187

DEMOLITION NOTES

A. ALL DEBRIS SHALL BE WET AT TIME OF HANDLING TO PREVENT DUST.
B. NO STRUCTURAL MEMBER IN ANY STORY SHALL BE DEMOLISHED UNTIL THE STORY ABOVE IS COMPLETELY REMOVED.
C. THERE WILL BE NO FREE FALL DUMPING OVER EXTERIOR WALL FOR A HEIGHT OF MORE THAN 25 FEET.
D. CALL FOR INSPECTION AT LEAST 24 HOURS BEFORE STARTING WORK
E. APPROVAL OF PROTECTION FENCES AND CANOPIES IS REQUIRED PRIOR TO DEMOLITION.
F. ALL BASEMENT FILLS SHALL BE CLEAN AND UNIFORM.

SEPARATE PERMIT REQUIRED

I. FIRE SPRINKLER

GENERAL NOTES

CONSTRUCTION NOTES
1. EXISTING DIMENSIONS ARE (+/-) AND MUST BE FIELD VERIFIED PRIOR TO COMMENCING WITH THE WORK. SAID DIMENSIONS MAY AFFECT OTHER DIMENSIONS AS INDICATED WITH (+/-) SYMBOL.
2. THE ARCHITECT IS NOT RESPONSIBLE FOR THE ACCURACY OF EXISTING DIMENSIONS AND CONDITIONS.
3. APPROVAL TO PROCEED WITH THE WORK IS SUBJECT TO VERIFICATION OF CONDITIONS AND COMPLIANCE WITH PROCEDURES WITH LOCAL GOVERNING AGENCY.
4. CONTRACTOR IS RESPONSIBLE FOR FULL COMPLIANCE WITH ALL REQUIREMENTS DICTATED BY THE LANDLORD'S FIRE PROTECTION SYSTEMS ENGINEER DURING CONSTRUCTION AND ALL SUBSEQUENT FIELD INSPECTIONS.
5. ALL MATERIALS MUST MEET FLAME RESISTANCE REQUIREMENT OF LOCAL CODES, BUT NO LESS THAN 25 IN IN SPRINKLED AREA ABOVE THE CEILING; 15 ON STOREFRONT; AND 200 IN SPRINKLERED AREAS.
6. MOOD BLOCKING, DECKING AND FRAMING MATERIALS ARE ONLY ALLOWED BELOW THE FINISHED CEILING LINE WHEN FIRE-RETARDANT TREATED AND MARKED AS SUCH.
7. SUPPORT WIRES FOR SUSPENDED CEILINGISTS MUST NOT CONNECT TO ANY OF THE LANDLORD'S MECHANICAL, ELECTRICAL, PLUMBING OR FIRE PROTECTION PIPING OR EQUIPMENT.
8. ANY PENETRATIONS OF OR MODIFICATIONS TO THE EXISTING STRUCTURAL SYSTEMS, CONCRETE, STEEL, ETC. MUST BE COORDINATED WITH THE LANDLORD AND LOCAL AUTHORITIES. ANY MODIFICATIONS MUST BE APPROVED BY THE LANDLORD AFTER SUBMISSION OF A DETAILED SCOPE OF WORK OUTLINE.
9. FURNISH AND INSTALL CLEAR FLEXIGLASS GUARDS TO COUNTER HEIGHT AT UNPROTECTED END WALLS WHERE VINYL WALL COVERING IS FINISHED WALL MATERIAL.
10. CLAIMS FOR ADDITIONAL COSTS DUE TO LANDLORD REQUIREMENTS ESTABLISHED AFTER AWARD OF CONTRACT SHALL BE NEGOTIATED AS A CHANGE ORDER.

NOTE: THESE DRAWINGS ARE AUGMENTED AND/OR MODIFIED BY INFORMATION CONTAINED IN A PROJECT MANUAL CONSISTING OF ALL APPENDIX, GENERAL CONDITIONS, TECHNICAL SPECIFICATION, EQUIPMENT CUT SHEETS AND LANDLORD DESIGN AND CONSTRUCTION CRITERIA USE OF THE DRAWINGS WITHOUT THE PROJECT MANUAL IS NOT ADVISED. CLAIMS FOR ADDITIONAL COSTS DUE TO LANDLORD DESIGN CRITERIA INCLUDED IN THE PROJECT MANUAL WILL NOT BE ACCEPTED.

PROJECT TEAM

OWNER:

TYAC ENTERPRISE
CONTACT: MICHAEL J LEE

STRUCTURAL ENGINEER:

JUNE ENGINEERING
CONTACT: JUNE WANG
1908 SOUTH VIEW STREET
SALT LAKE CITY, UTAH 84105
TEL: 801-533-8040

ELECTRICAL ENGINEER:

PC ENGINEERING, INC
CONTACT: PHIL K. CHON
2975 WILSHIRE BLVD, #530
LOS ANGELES, CA 90010
TEL: 213-421-3605

ARCHITECT :

WOU DESIGN PARTNERS
CONTACT: HARRY KIM
3470 WILSHIRE BLVD, STE 930
LOS ANGELES, CA 90010
TEL: 213-318-3180

MECHANICAL/ PLUMBING ENGINEER:

YMC ENGINEERING, INC
CONTACT: MICHAEL LEE
6910 OSLO CIRCLE, SUITE
BUENA PARK, CA 90621
TEL: 714-562-8003

CONTRACTOR

SYMBOLS

EARTH

ROCK BASE

SAND

CONCRETE

BRICK

CONCRETE BLOCK

STONE

STEEL SECTION

INSULATION, BATT

INSULATION, RIGID

CERAMIC TILE

CEILING-MOUNTED FLUORESCENT LIGHT FIXTURE

CEILING-MOUNTED LIGHT FIXTURE W/EXHAUST FAN-S (AIR CHANGE TO OUTSIDE AIR PER 1 HR. VIA BACKDROP DAMPER.)

WALL SURFACE-MOUNTED LIGHT (STAIR)

SURFACE-MOUNTED FLUORESCENT

2'X4' KITCHEN FLUORESCENT

FIRE SPRINKLER HEAD

RECESSED LIGHTING

EXIT LIGHT

EXIT LIGHT

PRECAST CONCRETE

COLUMN LINE

DETAIL NUMBER SHEET NUMBER

DOOR MARK HDWR. NUMBER

METAL LATH

WOOD FINISH

WOOD FRAMING

WOOD FRAMING

PLYWOOD

GLASS

ACoustic TILE OR BOARD

GYPSUM BOARD

EXHAUST FAN

SMOKE DETECTOR

FLUORESCENT STRIP FIXTURE

RECESSED LIGHTING (FLUORESCENT)

RECESSED HALOGEN LIGHT

REVISION

ROOM NAME

ROOM NUMBER

SECTION NUMBER

SHEET NUMBER

WALL TYPE

MATCH LINE

ELEVATION LETTER

SHEET NUMBER

KEY NUMBER

SHEET NUMBER

X'-X'X'-X" CEILING HEIGHT CHANGE

SHEET INDEX

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STATE STREET

EXIST. ACCESSIBLE PARKINGS, PATH OF TRAVEL AND ALL PARKING LAYOUT TO REMAIN (NO CHANGE)

1 SITE PLAN
Scale: 3/32" = 1'-0"

WOU

DESIGN PARTNERS

3470 WILSHIRE BLVD, SUITE 930
LOS ANGELES, CA 90010

- ARCHITECTURE BRANDING
- INTERIOR BRANDING
- PLANNING
- LAND-USE CONSULTATION

STATE OF UTAH
HARRY KIM
No. 10718308-0301
EXPIRES 12-20-2024
LICENSED ARCHITECT

TITLE

Korean BBQ of Utah

7157 S. State Street
Midvale, Utah, 84047

REVISIONS

Δ CORRECTION SWRF 4-19-18

Δ CORRECTION BLDG. 4-26-18

NO.	ISSUE	DATE

PROJECT DATA

PROJECT NUMBER :

DATE :

DRAWN BY :

CHECKED BY :

APPROVED BY :

SCALE

SHEET NAME

TITLE SHEET & SITE PLAN

SHEET NUMBER

A-0.1

HEALTH DEPARTMENT NOTES

GENERAL REQUIREMENTS
FOOD SERVICE FACILITY OWNERS/CONTRACTORS/DESIGN PROFESSIONALS ARE REQUIRED TO SUBMIT PLANS TO THE BUREAU OF FOOD PROTECTION BEFORE CONSTRUCTING A NEW FOOD SERVICE FACILITY, CONVERTING AN EXISTING STRUCTURE FOR USE AS A FOOD SERVICE FACILITY, REMODELING OF A FOOD SERVICE FACILITY, OR CHANGING THE TYPE OF FOOD SERVICE OR FOOD OPERATION.
NOTE: REMODELING IS DEFINED AS CHANGE IN DESIGN AND EQUIPMENT INVOLVING 50% OR MORE OF THE FOOD PREPARATION AREA OR SIGNIFICANT CHANGES FROM THE ORIGINAL DESIGN OR OPERATION OF THE FACILITY. PLANS MUST BE DRAWN IN A CONCISE, DETAILED, AND PROFESSIONAL MANNER, WHILE IT IS NOT A REQUIREMENT THAT PLANS BE PROFESSIONALLY DRAWN, THEY MUST INCLUDE SUFFICIENT INFORMATION AND DETAIL TO DEMONSTRATE COMPLIANCE WITH HEALTH DEPARTMENT REQUIREMENTS. INCOMPLETE PLANS WILL NOT BE REVIEWED. CONSTRUCTION MUST BEGIN WITHIN 6 MONTHS (180 DAYS) OF PLAN APPROVAL. PLEASE CONTACT US AT 385-468-3845 IF YOU REQUIRE MORE TIME.

EQUIPMENT—GENERAL
ALL FOOD SERVICE EQUIPMENT MUST BE COMMERCIAL GRADE AND MUST MEET THE STANDARDS OF THE AMERICAN NATIONAL STANDARDS INSTITUTE (ANSI)/ NATIONAL SANITATION FOUNDATION INTERNATIONAL (NSF) OF DESIGN, MATERIALS AND WORKMANSHIP. AN ANSI/NSF OR OTHER NATIONALLY RECOGNIZED TESTING AGENCY SEAL IS USUALLY A GOOD INDICATOR THAT THE EQUIPMENT MEETS FOOD CODE REQUIREMENTS. IN GENERAL, WOOD IS PROHIBITED FROM USE IN FOOD PREPARATION AREAS FOR TABLE LEGS, SHELVING, ETC.
EQUIPMENT MUST BE INSTALLED TO FACILITATE THE CLEANING OF EQUIPMENT AND ALL ADJACENT AREAS. EQUIPMENT, INCLUDING ICE MAKERS AND ICE STORAGE EQUIPMENT, SHOULD NOT BE STORED UNDER EXPOSED OR UNPROTECTED SEWER LINES, OPEN STAIRWELLS OR OTHER SOURCES OF CONTAMINATION.

TABLE-MOUNTED EQUIPMENT
UNLESS PORTABLE, TABLE MOUNTED EQUIPMENT SHOULD BE INSTALLED ON 4-INCH LEGS OR SEALED TO THE TABLE USING SILICONE CAULK. PIECES OF TABLE MOUNTED EQUIPMENT SHOULD BE KEPT AT LEAST SIX INCHES APART TO ENSURE ACCESS FOR CLEANING, OR THEY SHOULD BE SEALED TOGETHER.

FIXED EQUIPMENT
FIXED EQUIPMENT SHOULD BE INSTALLED WITH SUFFICIENT SPACE BETWEEN ADJACENT EQUIPMENT, FLOORS, WALLS, CABINETS, AND CEILINGS TO FACILITATE PROPER CLEANING, OR IMMOVABLE EQUIPMENT SHOULD BE SEALED TO ADJACENT FIXED-IN-PLACE EQUIPMENT, FLOORS, WALLS, OR CEILINGS WITH SILICONE CAULK. FLOOR-MOUNTED EQUIPMENT THAT IS NOT EASILY MOVABLE OR MOUNTED ON WHEELS/CASTERS MUST HAVE LEGS THAT PROVIDE AT LEAST SIX INCHES CLEARANCE FROM THE FLOOR. THIS CLEARANCE SHOULD BE MEASURED FROM THE LOWEST OBSTRUCTION UNDER THE PIECE OF EQUIPMENT.
NOTE: IF YOU CAN SLIDE A BUSINESS CARD BETWEEN EQUIPMENT AND A WALL OR OTHER EQUIPMENT, IT MUST BE SEALED.
RECOMMENDED EQUIPMENT SPACING FROM WALLS, PROVIDED ACCESS IS AVAILABLE FROM BOTH ENDS:
EQUIPMENT LENGTH (A) SPACE FROM WALLS AND EQUIPMENT (B)
4 FEET OR LESS 6 INCHES
4 FEET TO 8 FEET 12 INCHES
8 FEET OR MORE 18 INCHES

NOTE: FOR LONG BANKS OF EQUIPMENT, CONSIDER INTEGRATING MOVEABLE EQUIPMENT ON CASTORS WITH STATIONARY EQUIPMENT ON LEGS TO FACILITATE CLEANING AND SERVICE ACCESS. A KEEPER CHAIN SHOULD BE INSTALLED WITH ALL FLEXIBLE UTILITY CONNECTIONS.
IF FIXED EQUIPMENT IS INSTALLED ON A RAISED FLOOR PLATFORM, THE PLATFORM SHOULD BE A MINIMUM OF TWO INCHES HIGH WITH A ¼ INCH RADIUS. EQUIPMENT SHOULD OVERHANGS THE BASE BY ONE TO FOUR INCHES.
EQUIPMENT MUST BE SEALED TO THE FLOOR USING SILICONE CAULK.

CONDUIT/UTILITY LINES
ALL CONDUITS AND EXPOSED UTILITY LINES (PLUMBING, GAS, ELECTRICAL, REFRIGERATION, ETC.) MUST BE KEPT AT LEAST 6 INCHES OFF THE FLOOR AND INSTALLED SO AS TO NOT INTERFERE WITH CLEANING. ANY INSULATION ON UTILITY LINES MUST BE SMOOTH, NON-ABSORBENT, AND EASY TO CLEAN. EQUIPMENT SHOULD BE INSTALLED TO PROVIDE A MINIMUM 36-INCH AISLE WORKING SPACE.

REFRIGERATION
REFRIGERATION AND FREEZER FACILITIES ARE REQUIRED TO MAINTAIN POTENTIALLY HAZARDOUS FOODS DURING STORAGE, TRANSPORTATION, DISPLAY, AND SERVICE. REFRIGERATION EQUIPMENT MUST MEET NSF STANDARD #1 OR BE OF EQUIVALENT CONSTRUCTION. BEVERAGE COOLING CASES ARE NOT ACCEPTABLE FOR THE STORAGE OF POTENTIALLY HAZARDOUS FOODS. IF ICE IS TO BE USED FOR COOLING, THE ICE-MAKING UNIT MUST BE DESIGNED AND SIZED TO MEET THE ANTICIPATED DEMAND.
REFRIGERATION AND FREEZER STORAGE INVOLVES FOUR MAJOR AREAS:
1. UNITS FOR SHORT-TERM HOLDING OF PERISHABLE AND POTENTIALLY HAZARDOUS FOOD ITEMS CONVENIENTLY LOCATED AT POINTS OF FOOD PREPARATION (REACH-IN REFRIGERATORS).
2. REFRIGERATION AND FREEZER UNITS FOR LONG-TERM STORAGE LOCATED NEAR DELIVERY OR RECEIVING AREAS (WALK-IN COOLERS AND WALK-IN FREEZERS).
3. UNITS FOR QUICK CHILLING OF FOODS (BLAST CHILLERS AND RAPID PULL-DOWN UNITS).
4. DISPLAY STORAGE FOR CUSTOMER SERVICE (SALAD BARS AND DISPLAY CASES).

IF POTENTIALLY HAZARDOUS FOODS THAT REQUIRE COOLING ARE PREPARED A DAY OR MORE IN ADVANCE OF INTENDED SERVICE, A RAPID COOLING METHOD CAPABLE OF COOLING THE FOOD FROM 135°F TO 41°F WITHIN 6 HOURS IS REQUIRED (135°F TO 70°F WITHIN 2 HOURS AND 70°F TO 41°F WITHIN 4 HOURS). THIS MAY BE A BLAST CHILLER, ICE BATH, REDUCING THE VOLUME OF FOOD IN AN INDIVIDUAL CONTAINER TO LESS THAN 4½ DEEP, A LOOSE COVERING ON THE CONTAINER TO FACILITATE HEAT TRANSFER, PREPARING SMALLER BATCHES CLOSER TO PERIODS OF SERVICE, OR OTHER APPROVED METHOD.
NOTE: ONLY 30% OF REFRIGERATION RATED COOLING CAPACITY IS AVAILABLE FOR COOLING FOOD.
ALL REFRIGERATION UNITS MUST HAVE A NUMERICALLY-SCALED THERMOMETER ACCURATE TO ± 3°F. THE SENSING UNIT MUST BE LOCATED TO MEASURE THE AIR TEMPERATURE IN THE WARMEST PART OF THE UNIT. REFRIGERATION AND FREEZER UNITS, UNLESS DESIGNED FOR SUCH USE, SHOULD NOT BE LOCATED DIRECTLY ADJACENT TO COOKING OR OTHER HEAT-PRODUCING EQUIPMENT. REFRIGERATION AND FREEZER UNITS SHOULD NOT BE INSTALLED OUTSIDE OF THE BUILDING IF UNPACKAGED FOODS WILL BE TRANSPORTED FROM THE FACILITY TO THE FOOD ESTABLISHMENT.

WHEN ASSESSING THE REFRIGERATION NEEDS, SHELVING SPACE WITHIN REFRIGERATION AND FREEZER UNITS SHOULD BE DESIGNED TO PREVENT CROSS-CONTAMINATION OF FOODS AND PROVIDE MAXIMUM AIR FLOW. CONSIDERATION MUST BE GIVEN TO SEPARATING RAW MEAT, FISH, AND POULTRY FROM READY-TO-EAT FOODS SUCH AS PRODUCE AND PRE-PREPARED ITEMS.
A SUGGESTED FORMULA TO ESTABLISH REQUIRED REFRIGERATION STORAGE CAPACITY IS AS FOLLOWS:

NOTE: ONLY 40% OF ANY WALK-IN PROVIDES USEABLE SPACE.
TOTAL INTERIOR VOLUME NEEDED = VOLUME PER MEAL (FT³) X # OF MEALS/40 X HEIGHT OF UNIT
BELOW ARE TYPICAL MEAL VOLUMES FOR EACH OF THREE TYPES OF REFRIGERATED STORAGE:
1. MEAT AND POULTRY 0.010 TO 0.030 FT³/MEAL
2. DAIRY 0.007 TO 0.015 FT³/MEAL
3. VEGETABLES AND FRUIT 0.020 TO 0.040 FT³/MEA

FOOD PROTECTION
WHILE ON DISPLAY, DURING SERVICE, OR WHILE BEING HELD HOT OR COLD, ALL FOOD MUST BE ADEQUATELY PROTECTED FROM CONTAMINATION BY THEUSE OF PACKAGING, SERVICE LINE, STORAGE OR SALAD BAR PROTECTIVE DEVICES (SNEEZE GUARD); DISPLAY CASES; OR OTHER EFFECTIVE MEANS, INCLUDING DISPENSERS.
SEPARATE AREAS SHOULD BE DESIGNED AND OPERATED TO SEGREGATE FOOD HANDLING OPERATIONS INVOLVING RAW AND FINISHED FOOD PRODUCTS, WHERE FROZEN DESSERTS OR OTHER MOIST FOODS ARE BEING PORTIONED AND DISPENSED, RUNNING WATER DIPPER WELLS OR OTHER APPROVED METHODS SHOULD BE PROVIDED FOR THE IN-USE STORAGE OF DISPENSING UTENSILS.

FOOD GUARDS
FOOD (SNEEZE) GUARDS SHOULD BE DESIGNED AND INSTALLED TO INTERCEPT A DIRECT LINE BETWEEN A CUSTOMER'S MOUTH AND FOODS ON DISPLAY. ON THE AVERAGE, THE VERTICAL DISTANCE FROM THE CUSTOMER'S MOUTH TO THE FLOOR IS 4 FT. 6 INCHES TO 5 FEET. THIS AVERAGE HEIGHT MUST BE ADJUSTED FOR CHILDREN IN EDUCATIONAL FACILITIES OR OTHER SPECIAL INSTALLATIONS.

WASTE LINES
WASTE LINES AND ROOF DRAINS SHOULD NOT BE POSITIONED DIRECTLY ABOVE FOOD PREPARATION AREAS, FOOD SERVICE AREAS, FOOD STORAGE AREAS, AND WAREWASHING AREAS; IF WASTE LINES OR ROOF DRAINS ARE OVER FOOD STORAGE AREAS, SEAMLESS GUTTERS OR OTHER PROTECTIVE DEVICES MUST BE INSTALLED UNDER THE PIPES TO DIVERT LEAKAGE AWAY FROM THE FOOD STORAGE AREA.

HOT HOLDING/REHEATING
IF POTENTIALLY HAZARDOUS FOODS ARE PREPARED AND HELD FOR HOT SERVICE, HOT FOOD HOLDING FACILITIES MUST BE PROVIDED AND MUST MAINTAIN POTENTIALLY HAZARDOUS FOODS AT AN INTERNAL TEMPERATURE OF 135°F OR ABOVE DURING DISPLAY, SERVICE, OR HOT HOLDING PERIODS. HEAT LAMPS HAVE NOT BEEN FOUND TO BE EFFECTIVE FOR THIS PURPOSE.
IF POTENTIALLY HAZARDOUS FOODS THAT REQUIRE RE-HEATING PRIOR TO SERVICE ARE PREPARED IN ADVANCE OF INTENDED SERVICE, RE-HEATING EQUIPMENT CAPABLE OF RAISING THE INTERNAL TEMPERATURE OF POTENTIALLY HAZARDOUS FOODS TO AT LEAST 165°F WITHIN 2 HOURS MUST BE PROVIDED. STEAM TABLES, BAINMARIES, WARMERS, CROCK POTS, AND SIMILAR HOT FOOD HOLDING UNITS ARE NOT EFFECTIVE FOR THE RAPID HEATING OF POTENTIALLY HAZARDOUS FOODS. FOOD PRODUCT THERMOMETERS ACCURATE TO ± 2°F ARE REQUIRED TO MONITOR TEMPERATURES.
NOTE: THERMOCOUPLE THERMOMETERS ARE RECOMMENDED DUE TO INCREASED ACCURACY AND SPEED OF READING, ESPECIALLY WHEN DEALING WITH THIN FOODS AND THE QUICK MONITORING OF COOLING TEMPERATURES.

HANDWASHING
HANDWASHING SINKS MUST BE PROVIDED AND LOCATED CONVENIENT TO ALL FOOD PREPARATION AREAS, UTENSIL WASHING AREAS, TOILET ROOMS, AND CUSTOMER AREAS OF CONVENIENCE STORES. HANDWASHING SINKS MUST BE LOCATED WITHIN A REASONABLE DISTANCE (15 FEET SUGGESTED DISTANCE, AND NO MORE THAN 25 FEET) FROM EACH AREA OF USE AND MUST NOT REQUIRE ENTERING ANOTHER ROOM FOR USE. ADDITIONAL HAND SINKS MAY BE EQUIRED, DEPENDING ON THE CONFIGURATION OF EQUIPMENT AND LOCATION OF WORK AREAS IN THE FOOD SERVICE FACILITY. EACH HANDWASHING SINK MUST BE PROVIDED WITH HOT AND COLD WATER BY MEANS OF A MIXING VALVE. EACH HANDWASHING SINK MUST BE PROVIDED WITH HAND CLEANER, A HAND DRYING DEVICE OR SINGLE USE SANITARY TOWELS IN A PERMANENTLY INSTALLED DISPENSER, AND A WASTE RECEPTACLE.

METERING FAUCETS
IF USED, SELF-CLOSING OR METERING FAUCETS MUST BE ADJUSTED TO REMAIN ON A MINIMUM OF 15 SECONDS WITHOUT THE NEED FOR REACTIVATION.
NOTE: HAND SINKS USED BY FOOD EMPLOYEES SHOULD HAVE KNEE, FOOT, INFRARED SENSOR, OR WRIST OPERATED FAUCETS.
THE HANDWASHING SINK MUST BE ACCESSIBLE AT ALL TIMES. IT SHOULD NOT BE LOCATED WHERE ACCESS MAY BE EASILY BLOCKED BY WASTE CONTAINERS, CARTS, ETC. THE HANDWASHING SINK MAY BE USED FOR NO PURPOSE OTHER THAN HAND WASHING. SINKS USED FOR FOOD PREPARATION OR EQUIPMENT WASHING MAY NOT BE USED FOR HANDWASHING.

SPLASH SHIELDS
SPLASH PROTECTION IS REQUIRED WHEN HANDWASHING SINKS ARE LOCATED WITHIN 18 INCHES OF FOOD CONTACT SURFACES, FOOD STORAGE, SHELVES, FOOD SERVICE AREAS, FOOD PREPARATION SINKS, OR WAREWASHING SINKS. THE SPLASH SHIELD MUST PROTECT FOOD CONTACT SURFACES AND WAREWASHING SURFACES FROM SPLASH. SPLASH SHIELDS SHOULD BE CONSTRUCTED OF STAINLESS STEEL OR OTHER DURABLE WATER RESISTANT MATERIALS.

HAND SANITIZERS
HAND SANITIZERS STATIONS, IF INSTALLED, MUST BE LOCATED ADJACENT TO HAND WASHING SINKS. HAND SANITIZERS MAY NOT BE USED AS A REPLACEMENT FOR ADEQUATE HANDWASHING.

DRY STORAGE
THE DRY STORAGE SPACE REQUIRED DEPENDS UPON THE MENU, NUMBER OF MEALS, QUANTITIES PURCHASED, AND FREQUENCY OF DELIVERY. THE MINIMUM SPACE RECOMMENDED IS 25% OF ALL KITCHEN AREAS, BASED ON ALL-TONALL DIMENSIONS. IT MUST BE SUFFICIENT TO STORE FOOD AND EQUIPMENT SIX INCHES OFF THE FLOOR. THE LOCATION OF THE STORAGE ROOM SHOULD BE ADJACENT TO THE FOOD PREPARATION AREA AND CONVENIENT TO RECEIVING. AN EXTERIOR DOOR SHOULD BE NEAR THE DRY STORAGE AREA TO MINIMIZE DELIVERY TRAFFIC THROUGH FOOD PREPARATION AREAS. STORAGE ROOM TEMPERATURES OF 50°F TO 70°F ARE RECOMMENDED.
SHELVES MAY BE CONSTRUCTED OF SUITABLE FINISHED WOOD, DURABLE PLASTIC OR CORROSION-RESISTANT METAL. THE HIGHEST SHELF FOR PRACTICAL USE SHOULD BE NO MORE THAN 7 FEET OFF THE FLOOR. THE LOWEST SHELF SHOULD BE AT LEAST 6 INCHES FROM THE FLOOR. SPACING BETWEEN SHELVES SHOULD BE 15 INCHES.
A SUGGESTED FORMULA USED IN ESTIMATING REQUIRED DRY STORAGE SPACE IS AS FOLLOWS:
REQUIRED STORAGE ARE (FT²) = VOLUME PER MEAL X # OF MEALS BETWEEN DELIVERIES/AVERAGE HEIGHT X FRACTION OF USEABLE STOREROOM FLOOR OF STOREROOM AREA
1. VOLUME PER MEAL = 0.025 TO 0.050 FT³/MEAL SERVED
2. USEABLE STOREROOM HEIGHT = 4 TO 7 FEET
3. STORAGE TIME BETWEEN DELIVERIES = 3 TO 14 DAYS
4. FRACTION OF USEABLE STOREROOM FLOOR AREA = 0.3 TO 0.6

WAREWASHING
ADEQUATE FACILITIES MUST BE PROVIDED TO STORE DIRTY DISHES AND EQUIPMENT PRIOR TO WASHING AND SANITIZING. STORAGE FACILITIES MUST BE PROVIDED FOR THE STORAGE OF CLEANED AND SANITIZED UTENSILS AND EQUIPMENT AT LEAST 6 INCHES ABOVE THE FLOOR ON FIXED SHELVES OR IN ENCLOSED CABINETS PROTECTED FROM SPLASH, DUST, OR OTHER SOURCES OF CONTAMINATION. WAREWASHING SINKS AND MECHANICAL WAREWASHING MACHINES MAY NOT BE DIRECTLY CONNECTED TO THE SEWER.

MANUAL WAREWASHING
A 3-COMPARTMENT SINK MEETING NSF1 STANDARD #2 MUST BE PROVIDED FOR MANUAL WASHING AND SANITIZING OF UTENSILS AND EQUIPMENT. THE 3-COMPARTMENT SINK MUST BE CONVENIENTLY LOCATED FOR EASY ACCESS BY FOOD EMPLOYEES.
NOTE: THIS IS IN ADDITION TO ANY MECHANICAL WAREWASHER.
EACH COMPARTMENT OF THE 3-COMPARTMENT SINK MUST BE LARGE ENOUGH TO ACCOMMODATE THE LARGEST PIECE OF EQUIPMENT. EACH COMPARTMENT MUST BE PROVIDED WITH AN ADEQUATE SUPPLY OF HOT AND COLD POTABLE WATER. TWO DRAINBOARDS SHOULD BE PROVIDED EQUAL IN SIZE TO THAT OF THE SINK COMPARTMENTS. WORKING SUPPLIES OF CLEANERS AND SANITIZERS MUST BE STORED IN AN APPROVED LOCATION. A RECOMMENDED STORAGE LOCATION IS ON A WIRE SHELF BELOW THE DRAINBOARDS OF THE 3-COMPARTMENT SINK.

MECHANICAL WAREWASHING
FOR MECHANICAL WAREWASHING, A WAREWASHING MACHINE MEETING NSF1 STANDARD #3 SHOULD BE PROVIDED. THE CAPACITY OF THE WAREWASHING MACHINE SHOULD BE BASED ON THE PEAK NUMBER AND TYPE OF DISHES, UTENSIL, FLATWARE, EQUIPMENT, ETC., THAT MUST BE WASHED PER HOUR.
NOTE: ONLY 70% OF THE LISTED NSF1 CAPACITY, IN RACKS PER HOUR, SHOULD BE CONSIDERED AS AN AVERAGE WORKING CAPACITY.

EACH 20 X 20-INCH DISHRACK WILL ACCOMMODATE APPROXIMATELY:
16 NINE-INCH DINNER PLATES
25 WATER GLASSES
16 COFFEE CUPS
100 PIECES OF FLATWARE
THE PLACE SETTINGS FOR FOUR SEATS = 1 DISHRACK.

CHEMICAL SANITIZATION
THE FOLLOWING REQUIREMENTS APPLY TO CHEMICAL SANITIZING WAREWASHERS:
• ADDITIONAL DRAINBOARD/DRYING SPACE MAY BE REQUIRED DUE TO THE INCREASED DRYING TIME OF EQUIPMENT AND DISHES WASHED IN A LOW TEMPERATURE WAREWASHER.
• CHEMICALS MUST BE AUTOMATICALLY FED INTO THE MACHINE;
• THE CHEMICAL SANITIZING FEEDER MUST BE APPROVED FOR THE SPECIFIC MAKE AND MODEL OF MACHINE IN QUESTION;
• AN APPROVED CHEMICAL TEST KIT MUST BE AVAILABLE AND MUST BE USED; AND
• A VISUAL FLOW INDICATOR MUST BE PROVIDED TO MONITOR THE OPERATION OF THE SANITIZING AGENT FEED.

HOT WATER SANITIZATION
THE FOLLOWING REQUIREMENTS APPLY TO HOT WATER SANITIZING WAREWASHERS:
• A BOOSTER HEATER IS REQUIRED TO RAISE THE WATER TEMPERATURE FROM 140°F TO 180°F. THE BOOSTER HEATER SHOULD BE LOCATED AS CLOSE AS POSSIBLE TO THE WAREWASHER TO MINIMIZE HEAT LOSS.
• A MAXIMUM REGISTERING THERMOMETER OR OTHER APPROVED DEVICE IS REQUIRED TO MONITOR WAREWASHER PERFORMANCE.
NOTE: A HIGH TEMPERATURE WAREWASHER MAY NOT BE CONVERTED TO A LOW TEMPERATURE WAREWASHER WITHOUT BEING RE-CERTIFIED BY THE MANUFACTURER.

HOT WATER REQUIREMENTS
THE HOT WATER SUPPLY MUST BE SUFFICIENT TO MEET THE CONTINUOUS AND PEAK HOT WATER DEMANDS OF THE ESTABLISHMENT. FOOD SERVICE FACILITIES WHICH DO NOT CONTAIN CRITICAL PLUMBING FIXTURES (MECHANICAL WAREWASHING MACHINE, GLASS WASHERS, OR OTHER HIGH HOT WATER DEMAND EQUIPMENT) MAY HAVE A WATER HEATER WITH A MINIMUM OF 50 GALLONS STORAGE CAPACITY AND AN INPUT HEATING CAPACITY OF 50,000 BTU OR 11 KW. IF THEY HAVE NO MORE THAN THE FOLLOWING EQUIPMENT:
1. THREE HANDSINKS
2. ONE MOP SINK
3. ONE 3-COMPARTMENT SINK (16 X 20 X 14½ MAXIMUM)
4. ONE VEGETABLE/FOOD PREP SINK

FLOORS, WALLS, CEILING
THE FOLLOWING ARE GENERAL REQUIREMENTS FOR WALLS, FLOORS, AND CEILINGS IN FOOD SERVICE FACILITIES:

- THERE MUST BE COVING AT FLOOR-WALL JUNCTURES WITH A RECOMMENDED ¼ INCH RADIUS AND 4 INCHES IN HEIGHT THAT IS COMPATIBLE WITH BOTH WALL AND FLOOR COVERING.
- STUDS, JOISTS, AND RAFTERS MAY NOT BE EXPOSED IN FOOD PREPARATION AREAS, EQUIPMENT, AND UTENSIL WASHING AREAS, TOILET ROOMS, AND VESTIBULES.
- ANY ACoustICAL CEILING TILE (ACT) USED IN FOOD PREPARATION AREAS, EQUIPMENT AND UTENSIL WASHING AREAS, TOILET ROOMS, AND VESTIBULES MUST BE SMOOTH, NON-ABSORBENT, CLEANABLE, AND NON-POROUS.
- ALL SURFACES IN PREPARATION AREAS, EQUIPMENT AND UTENSIL WASHING AREAS, TOILET ROOMS, AND VESTIBULES MUST BE LIGHT COLORED, SMOOTH, NON-ABSORBENT, AND EASILY CLEANABLE.
- WALLS BEHIND OR ADJACENT TO SINKS, WAREWASHERS, MOP SINKS, URINALS, TOILETS, AND DRINKING FOUNTAINS MUST BE COVERED WITH A DURABLE WATERPROOF MATERIAL, MARLITE, PAINTED GYPSUM BOARD, AND SIMILAR MATERIALS ARE NOT APPROVED FOR THIS PURPOSE.
- CARPETING IS PROHIBITED IN PREPARATION AREAS, EQUIPMENT AND UTENSIL WASHING AREAS, TOILET ROOMS, WAIT STATIONS, STORAGE ROOMS, AND OTHER AREAS EXPOSED TO MOISTURE.
- FLOOR FINISHES MUST BE OF DURABLE, LIGHT-COLORED, WATER-PROOF, GREASE-RESISTANT, AND CLEANABLE MATERIALS EXTENDING AT LEAST 3 FEET FROM THE SERVING SIDE OF BUFFETS, SALAD BARS, AND BEVERAGE STATIONS.
- CONCRETE BLOCK, IF USED, MUST BE RENDERED NON-POROUS AND SMOOTH BY THE APPLICATION OF APPROVED BLOCK FILLER, FOLLOWED BY THE APPLICATION OF EPOXY-TYPE PAINT.
- PROTECTIVE CORNER GUARDS ARE RECOMMENDED IN ALL HIGH TRAFFIC AREAS.
- ALTERNATE MATERIALS MUST BE SUBMITTED TO THE HEALTH DEPARTMENT FOR EVALUATION.

PLUMBING
ALL PLUMBING MUST BE DESIGNED, INSTALLED, AND MAINTAINED ACCORDING TO THE REQUIREMENTS OF THE INTERNATIONAL PLUMBING CODE. AN ADEQUATE SUPPLY AND PRESSURE OF HOT WATER AND COLD WATER MUST BE PROVIDED TO MEET THE NEEDS OF THE FOOD SERVICE FACILITY. WATER MUST COME FROM A PUBLIC WATER SUPPLY OR A HEALTH DEPARTMENT APPROVED PRIVATE WATER SUPPLY. ALL SEWAGE AND LIQUID WASTES MUST BE DISPOSED OF BY MEANS OF A PUBLIC SEWER OR A HEALTH DEPARTMENT APPROVED INDIVIDUAL WASTE WATER TREATMENT SYSTEM.

CROSS-CONNECTIONS
THERE SHALL BE NO CROSS CONNECTIONS BETWEEN THE POTABLE WATER SUPPLY AND ANY NONPOTABLE OR QUESTIONABLE WATER SUPPLY. THE POTABLE WATER SYSTEM MUST BE INSTALLED TO PRECLUDE THE POSSIBILITY OF BACKFLOW.
DEVICES MUST BE INSTALLED TO PROTECT AGAINST BACKFLOW AND BACK-SIPHONAGE AT ALL FIXTURES UNLESS AN AIR GAP IS PROVIDED. THE AIR GAP MUST BE AT LEAST TWICE THE DIAMETER OF THE WATER SUPPLY INLET, BUT NOT LESS THAN ONE INCH BETWEEN THE WATER SUPPLY AND THE FIXTURE'S FLOOD LEVEL RIM. WATER SUPPLIES TO CARBONATORS MUST BE PROTECTED BY A VENTED DUAL-CHECK VALVE MEETING THE REQUIREMENTS OF ASSE 1022.

INDIRECT WASTE CONNECTIONS
INDIRECT WASTE CONNECTIONS MUST BE PROVIDED FOR EQUIPMENT SUCH AS WAREWASHING MACHINES, 3- COMPARTMENT WAREWASHING SINKS, FOOD PREPARATION SINKS, PRE-RINSE SINKS, BAR SINKS, ICE MACHINES, STEAM TABLES, SALAD BARS, DIPPER WELLS, WALK-IN REFRIGERATORS OR FREEZER CONDENSATE.

FLOOR DRAINS
FLOOR DRAINS SHOULD BE LOCATED IN AREAS THAT REQUIRE FREQUENT WATER FLUSHING TO CLEAN THE FLOOR OR EQUIPMENT. FLOOR DRAINS ARE REQUIRED IN TOILET ROOMS. FLOOR DRAINS MAY NOT BE INSTALLED IN WALK-IN REFRIGERATION UNITS.

GREASE TRAPS
GREASE TRAPS AND INTERCEPTORS, WHERE REQUIRED, MUST BE ACCESSIBLE FOR CLEANING. WATER ABOVE 140°F OR FOOD WASTE GRINDERS MAY NOT DISCHARGE INTO A GREASE TRAP.
NOTE: CONTACT YOUR LOCAL SEWER DISTRICT FOR SPECIFIC GREASE TRAP/INTERCEPTOR REQUIREMENTS, I.E., SIZE, LOCATION, TYPE, ETC.

TOILET ROOMS/DRESSING ROOMS
TOILET FACILITIES MUST BE INSTALLED ACCORDING TO THE REQUIREMENTS OF THE INTERNATIONAL PLUMBING CODE. THE NUMBER OF FIXTURES REQUIRED IS DETERMINED BY THE LOCAL BUILDING OFFICIAL BASED ON THE REQUIREMENTS OF THE UNIFORM BUILDING CODE, APPENDIX CHAPTER 29. TOILET ROOMS MUST INCLUDE A HAND SINK IN OR ADJACENT TO THE TOILET ROOM, BE EQUIPPED WITH HOT AND COLD RUNNING WATER, HAND CLEANER, AND A HAND DRYING DEVICE OR SINGLE-USE SANITARY TOWELS. TOILET ROOMS MUST BE COMPLETELY ENCLOSED AND HAVE TIGHT-FITTING, SOLID SELF-CLOSING DOORS. TOILET ROOMS MUST BE MECHANICALLY VENTED TO THE OUTSIDE. MECHANICAL VENTILATION MUST PROVIDE A COMPLETE AIR CHANGE EVERY 15 MINUTES. EACH TOILET ROOM MUST HAVE A WASTE CONTAINER. WOMEN'S TOILET ROOMS MUST HAVE A COVERED WASTE CONTAINER FOR SANITARY HYGIENE PRODUCTS. TOILET ROOMS MUST BE ACCESSIBLE AT ALL TIMES. CUSTOMERS MAY NOT PASS THROUGH FOOD PREPARATION AREAS, STORAGE AREAS, OR DISHWASHING AREAS TO USE THE TOILET FACILITIES. SEPARATE TOILET ROOMS ARE NOT REQUIRED FOR EMPLOYEES AND CUSTOMERS. IF EMPLOYEES CHANGE CLOTHES ON SITE, A DRESSING ROOM SHOULD BE PROVIDED WHERE THEY MAY CHANGE CLOTHES AND STORE PERSONAL POSSESSIONS. THIS AREA CANNOT BE IN AREAS USED FOR STORING, PREPARING, OR SERVING FOOD, OR FOR WASHING OR STORING UTENSILS. IF DRESSING ROOMS ARE NOT REQUIRED, SUITABLE FACILITIES MUST BE PROVIDED FOR STORING EMPLOYEE PERSONAL BELONGINGS.

INSECT CONTROL
OPENINGS TO THE OUTSIDE MUST BE EFFECTIVELY PROTECTED AGAINST THE ENTRANCE OF RODENTS AND INSECTS BY THE INSTALLATION OF TIGHT-FITTING, SELF-CLOSING DOORS; CLOSED WINDOWS; SELF-CLOSING SERVING WINDOWS AT DRIVE-THROUGH COUNTERS; CONTROLLED AIR CURRENTS; VESTIBULES OR OTHER APPROVED METHODS.
SCREENED DOORS MUST BE SELF-CLOSING. SCREENING MATERIAL MUST NOT BE LESS THAN SIXTEEN MESH TO THE INCH.
OPENINGS AROUND PIPES, CONDUITS, OR WIRING ENTERING THE BUILDING MUST BE ADEQUATELY SEALED TO PREVENT RODENT INTRUSION AND PROOF.
LOADING DOCKS AND DELIVERY DOORS MUST BE PROVIDED WITH EFFECTIVE AIR CURTAINS OR VESTIBULES WITH SELF-CLOSING DOORS.
NOTE: IT IS RECOMMENDED THAT OUTSIDE LIGHTING AROUND LOADING AREAS AND ENTRANCES BE SODIUM VAPOR TO DECREASE INSECT ATTRACTION.

SHIELDING
PROTECTIVE SHIELDING FOR LIGHT FIXTURES IS REQUIRED IN ALL FOOD PREPARATION, DISPLAY, SERVICE, STORAGE, AND UTENSIL WASHING AREAS. EXPLOSION TUBES WITH END CAPS OR SHATTERPROOF BULBS MAY BE USED. HEAT LAMPS SHOULD BE PROTECTED AGAINST BREAKAGE BY SURROUNDING AND EXTENDING A SHIELD BEYOND THE BULB, LEAVING ONLY THE FACE OF THE BULB EXPOSED. SHATTERPROOF BULBS MAY BE USED INSTEAD OF SHIELDING.

VENTILATION
VENTILATION IN FOOD SERVICE FACILITIES MUST COMPLY WITH THE REQUIREMENTS OF THE INTERNATIONAL MECHANICAL CODE. A TYPE I HOOD (WITH FILTERS) MUST BE INSTALLED AT OR ABOVE ALL COMMERCIAL FOOD HEAT PROCESSING APPLIANCES THAT PRODUCE GREASE, VAPORS OR SMOKE, A TYPE I OR TYPE II (WITHOUT FILTERS) HOOD MUST BE INSTALLED AT OR ABOVE ALL COMMERCIAL FOOD HEAT PROCESSING EQUIPMENT THAT PRODUCES FUMES, STEAM, ODORS, OR HEAT. HOODS MUST BE DESIGNED AND INSTALLED IN CONFORMANCE WITH NFPA BULLETIN 96.
WHEN VENTED TO THE OUTSIDE, THE VENTILATION SYSTEM MAY NOT CREATE AN UNSANITARY, HARMFUL OR UNLAWFUL DISCHARGE.

REMOVABLE FILTERS MUST BE OF A SIZE THAT ALLOWS FOR CLEANING IN A WAREWASHING MACHINE OR POT SINK.
FILTERS MUST BE INSTALLED AT AN ANGLE OF NOT LESS THAN 45° FROM THE HORIZONTAL. THE INSIDE EDGE OF A CANOPY-TYPE COMMERCIAL COOKING HOOD MUST OVERHANG OR EXTEND A HORIZONTAL DISTANCE OF NOT LESS THAN 6 INCHES BEYOND THE EDGE OF THE COOKING SURFACE. THE VERTICAL DISTANCE BETWEEN THE LIP OF THE HOOD AND THE COOKING SURFACE MUST NOT EXCEED 4 FEET.

WASTE HANDLING
GARBAGE AND REFUSE CONTAINERS, DUMPSTERS, AND COMPACTOR SYSTEMS LOCATED OUTSIDE THE BUILDING MUST BE STORED ON OR ABOVE A SMOOTH SURFACE OF NON-ABSORBENT MATERIAL SUCH AS 4 INCHES OF SEALED CONCRETE OR SEALED ROAD-GRADE ASPHALT. ALL GARBAGE OR REFUSE CONTAINERS MUST BE DURABLE, EASILY CLEANABLE, NON-ABSORBENT, LEAK-PROOF, AND PROVIDED WITH TIGHT-FITTING LIDS. GARBAGE AND REFUSE CONTAINERS MUST BE LOCATED AS FAR AS POSSIBLE FROM THE FOOD SERVICE FACILITY DOORS AND WINDOWS. INSIDE GARBAGE OR REFUSE STORAGE ROOMS MUST BE CONSTRUCTED OF EASILY CLEANABLE, NON-ABSORBENT, WASHABLE MATERIALS AND MUST BE INSECT AND RODENT PROOF. AN ADEQUATE NUMBER OF WASTE CONTAINERS MUST BE PROVIDED TO ACCOMMODATE THE NEEDS OF THE FOOD SERVICE FACILITY. COLLECTION FREQUENCY MUST BE SUFFICIENT TO PREVENT THE ACCUMULATION OF REFUSE.

JANITORIAL
JANITORIAL STATIONS MUST BE PROVIDED FOR GENERAL CLEANUP ACTIVITIES IN ALL FOOD SERVICE FACILITIES. EACH STATION MUST INCLUDE A CURBED CLEANING FACILITY (BUILT ON-SITE OR A LISTED CURBED SINK) OR A WALL-MOUNTED JANITORIAL SINK. ALL THREADED HOSE BIBS MUST BE PROTECTED AGAINST BACKFLOW. NOTE: RESIDENTIAL POLYETHYLENE OR FIBERGLASS LAUNDRY TUBS ARE NOT APPROVED.
JANITORIAL STATIONS SHOULD BE CONVENIENTLY PLACED FOR MAINTAINING FOOD SERVICE AREAS. THEY MUST BE ON THE SAME FLOOR LEVEL AS THE FOOD SERVICE AREA AND WITHIN A REASONABLE DISTANCE OF THE AREA OF USE.
SPACE MUST BE ALLOWED ADJACENT TO THE MOP SINK FOR THE STORAGE OF MOP BUCKETS AND OTHER CLEANING EQUIPMENT. DRYING RACKS MUST BE PROVIDED FOR MOP HEADS.
CHEMICAL DISPENSERS MUST BE PLACED SO THEY WILL NOT INTERFERE WITH MAINTENANCE EQUIPMENT OR USE.
CHEMICAL DISPENSERS MUST COMPLY WITH SECTION 608.16.7 OF THE INTERNATIONAL PLUMBING CODE.

LAUNDRY/LINEN STORAGE
STORAGE AREAS SHOULD BE PROVIDED FOR LINENS AND APRONS. CLEAN LINENS AND APRONS MUST BE PROTECTED FROM CONTAMINATION AND STORED AWAY FROM SOILED LINENS AND APRONS.
IF A LAUNDRY ROOM IS PROVIDED, IT MUST BE SEPARATE FROM FOOD SERVICE OPERATIONS. IF A CLOTHES WASHING MACHINE IS PROVIDED, A DRYER MUST ALSO BE PROVIDED UNLESS LAUNDERED CLOTHES ARE USED NET.

CHEMICALS/TOXICS STORAGE
AREAS MUST BE DESIGNATED FOR TOXIC MATERIAL STORAGE THAT IS AWAY FROM FOOD AND CLEAN UTENSILS. SEPARATE FACILITIES MUST BE PROVIDED FOR STORING PESTICIDES (SECURED CABINET).

AMERICANS WITH DISABILITIES ACT (ADA)
PROVISIONS OF THE AMERICANS WITH DISABILITIES ACT (ADA) SHOULD BE TAKEN INTO ACCOUNT IN ALL FOOD SERVICE FACILITY DESIGN.

UTAH INDOOR CLEAN AIR ACT (UICAA)
UNDER PROVISIONS OF THE UTAH INDOOR CLEAN AIR ACT (UICAA), SMOKING IS PROHIBITED IN ALL PUBLICLY OWNED BUILDINGS AND OFFICES EXCEPT AS PROVIDED IN 26-38-3, SUBSECTION 2 OF UICAA.

WOU

DESIGN PARTNERS


3470 WILSHIRE BLVD, SUITE 930
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• ARCHITECTURE BRANDING

• INTERIOR BRANDING

• PLANNING



• LAND-USE CONSULTATION

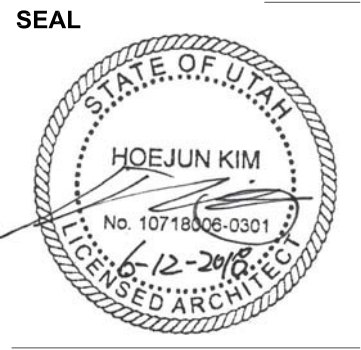

TITLE

Korean BBQ of Utah

7157 S. State Street
Midvale, Utah, 84047

REVISIONS	
 CORRECTION SWMR 4-19-18	
 CORRECTION BLDG. 4-26-18	

NO.	ISSUE	DATE
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PROJECT DATA

PROJECT NUMBER : _____

DATE : _____

DRAWN BY : _____

CHECKED BY : _____

APPROVED BY : _____

SCALE

SHEET NAME

GENERAL NOTES


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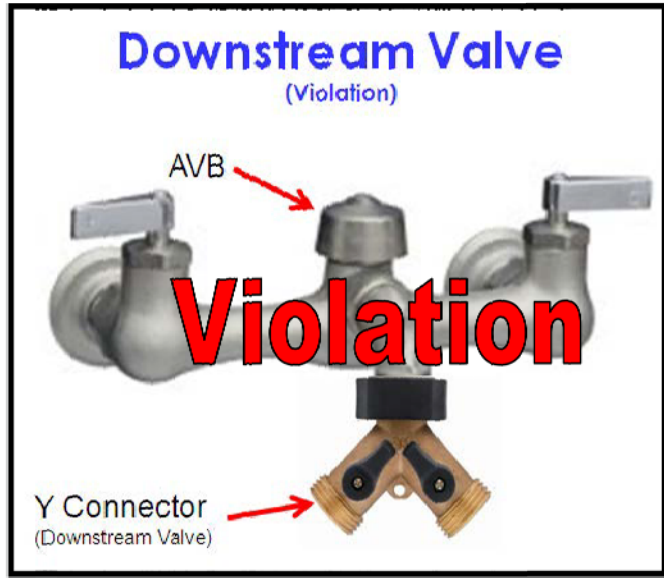
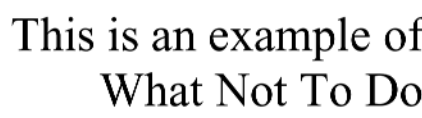
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- INTERIOR BRANDING
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Chemical Dispenser Installation

The water supply hose to a chemical dispenser shall not be connected to a water faucet that is equipped with an atmospheric vacuum breaker (AVB). Doing so creates pressure on the AVB and negates its ability to prevent backflow. AVBs are not rated for pressure applications. Please refer to International Plumbing Code® Section 608. In simple terms, you are not allowed to install a shutoff valve below an AVB.

It is common for chemical supply companies to install a hose bib "Y connector" on a mop sink faucet and then attach their chemical dispenser water supply hose to one of the Y ends. This violates the Plumbing Code.



It is recommended that a separate water tap WITHOUT an AVB be installed for supplying water to chemical dispensers.

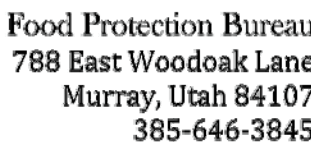Attention Architects and Contractors: Please consider installing a separate water tap in the mop sink area for connecting chemical dispensers. It is easier and more cost effective to do so during the construction phase.

Salt Lake County Health Department promotes and protects community and environmental health
saltlakehealth.org

Notes & Conditions of Approval

Plans approved 4-18-18.

Hand sink at the bar must have splash guards. Any other sink that may splash on a food or equipment must have splash guards.

***Per Utah State amendment to the 2012 IPC, chemical dispensers shall connect to a separate, dedicated water supply, separate from any sink faucet.**

Any changes to approved plans and specifications must be submitted to this Bureau for review and approval. Plan review does not constitute final approval of the finished establishment, nor does it constitute approval by any other agency. A final inspection and payment of a separate food service permit fee is required prior to commencement of operations. 72 hour notice is required for all construction and pre-opening inspections. Plan review is valid for 180 days.

Reviewed By: Rachel Black State Health Permit Officer Date: 4-18-18

Contact Person Notified: Harry Kim Date: 4-18-18 Fax/email: hkim@woupartners.com/tucacenter@twc2@gmail.com

See attached cards for notes and general requirements.

SEAL



TITLE

Korean BBQ of Utah
7157 S. State Street
Midvale, Utah, 84047

REVISIONS

A	CORRECTION SVWRF 4-19-1
B	CORRECTION BLDG. 4-26-18

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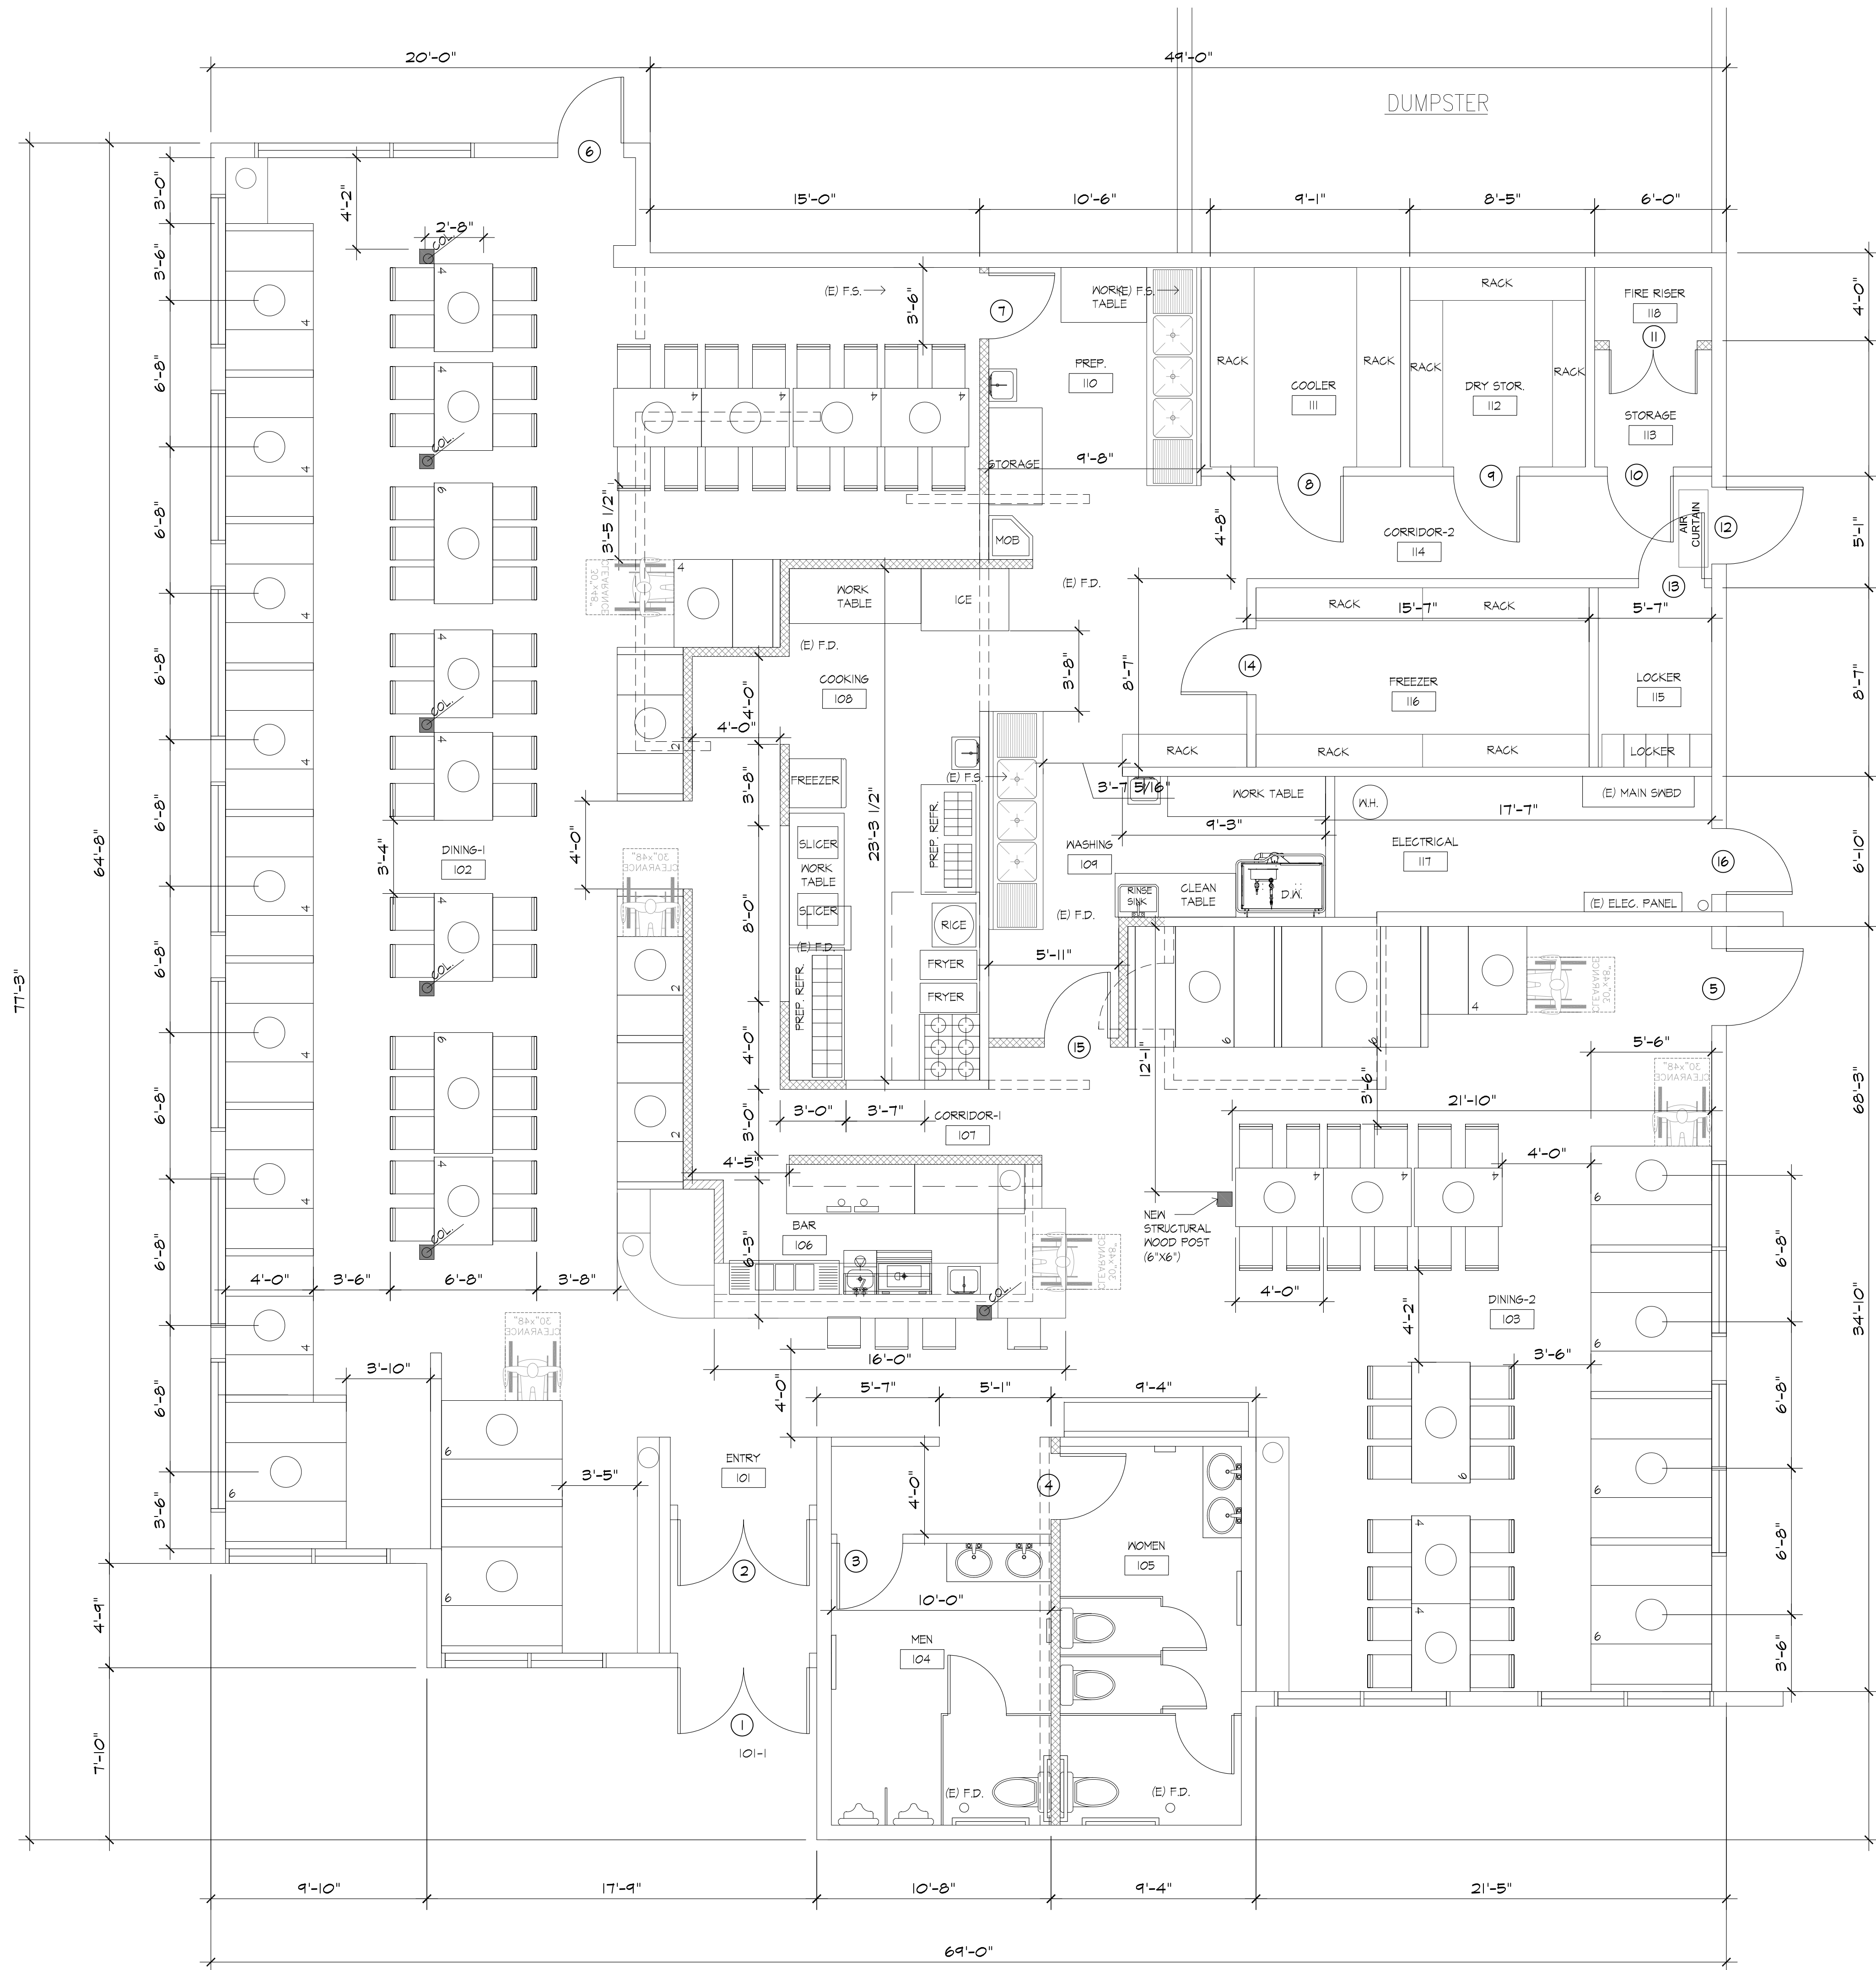
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SHEET NAME

GENERAL NOTES

SHEET NUMBER

A-0.3




ACCESSIBLE SEATING NOTES:

1. WHERE FIXED OR BUILT-IN SEATING, TABLES OR COUNTERS ARE PROVIDED FOR THE PUBLIC AND IN GENERAL EMPLOYEE AREA, 5% BUT NEVER LESS THAN IT MUST BE ACCESSIBLE.
2. THE TOP OF TABLES AND COUNTERS SHALL BE 28" TO 34" FROM THE FLOOR AND GROUND.
3. IF SEATING FOR PEOPLE IN WHEELCHAIRS IS PROVIDED AT FIXED TABLES OR COUNTERS KNEE SPACES AT LEAST 27" HIGH 30" WIDE AND 19" DEEP SHALL BE PROVIDED.


- EXISTING WALL
- REMOVE EXISTING INTERIOR WALL
- NEW PARTITION (FULL HEIGHT)
- NEW PARTITION (LOW HT PARTITION)
- EXISTING STRUCT. COLUMNS TO REMAIN

1 FLOOR PLAN
Scale: 1/4" = 1'-0"

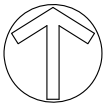

Korean BBQ of Utah
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Midvale, Utah, 84047

REVISIONS		
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PROJECT DATA		
PROJECT NUMBER :		
DATE :		
DRAWN BY :		
CHECKED BY :		
APPROVED BY :		
SCALE		
SHEET NAME		
FLOOR PLAN		
SHEET NUMBER		

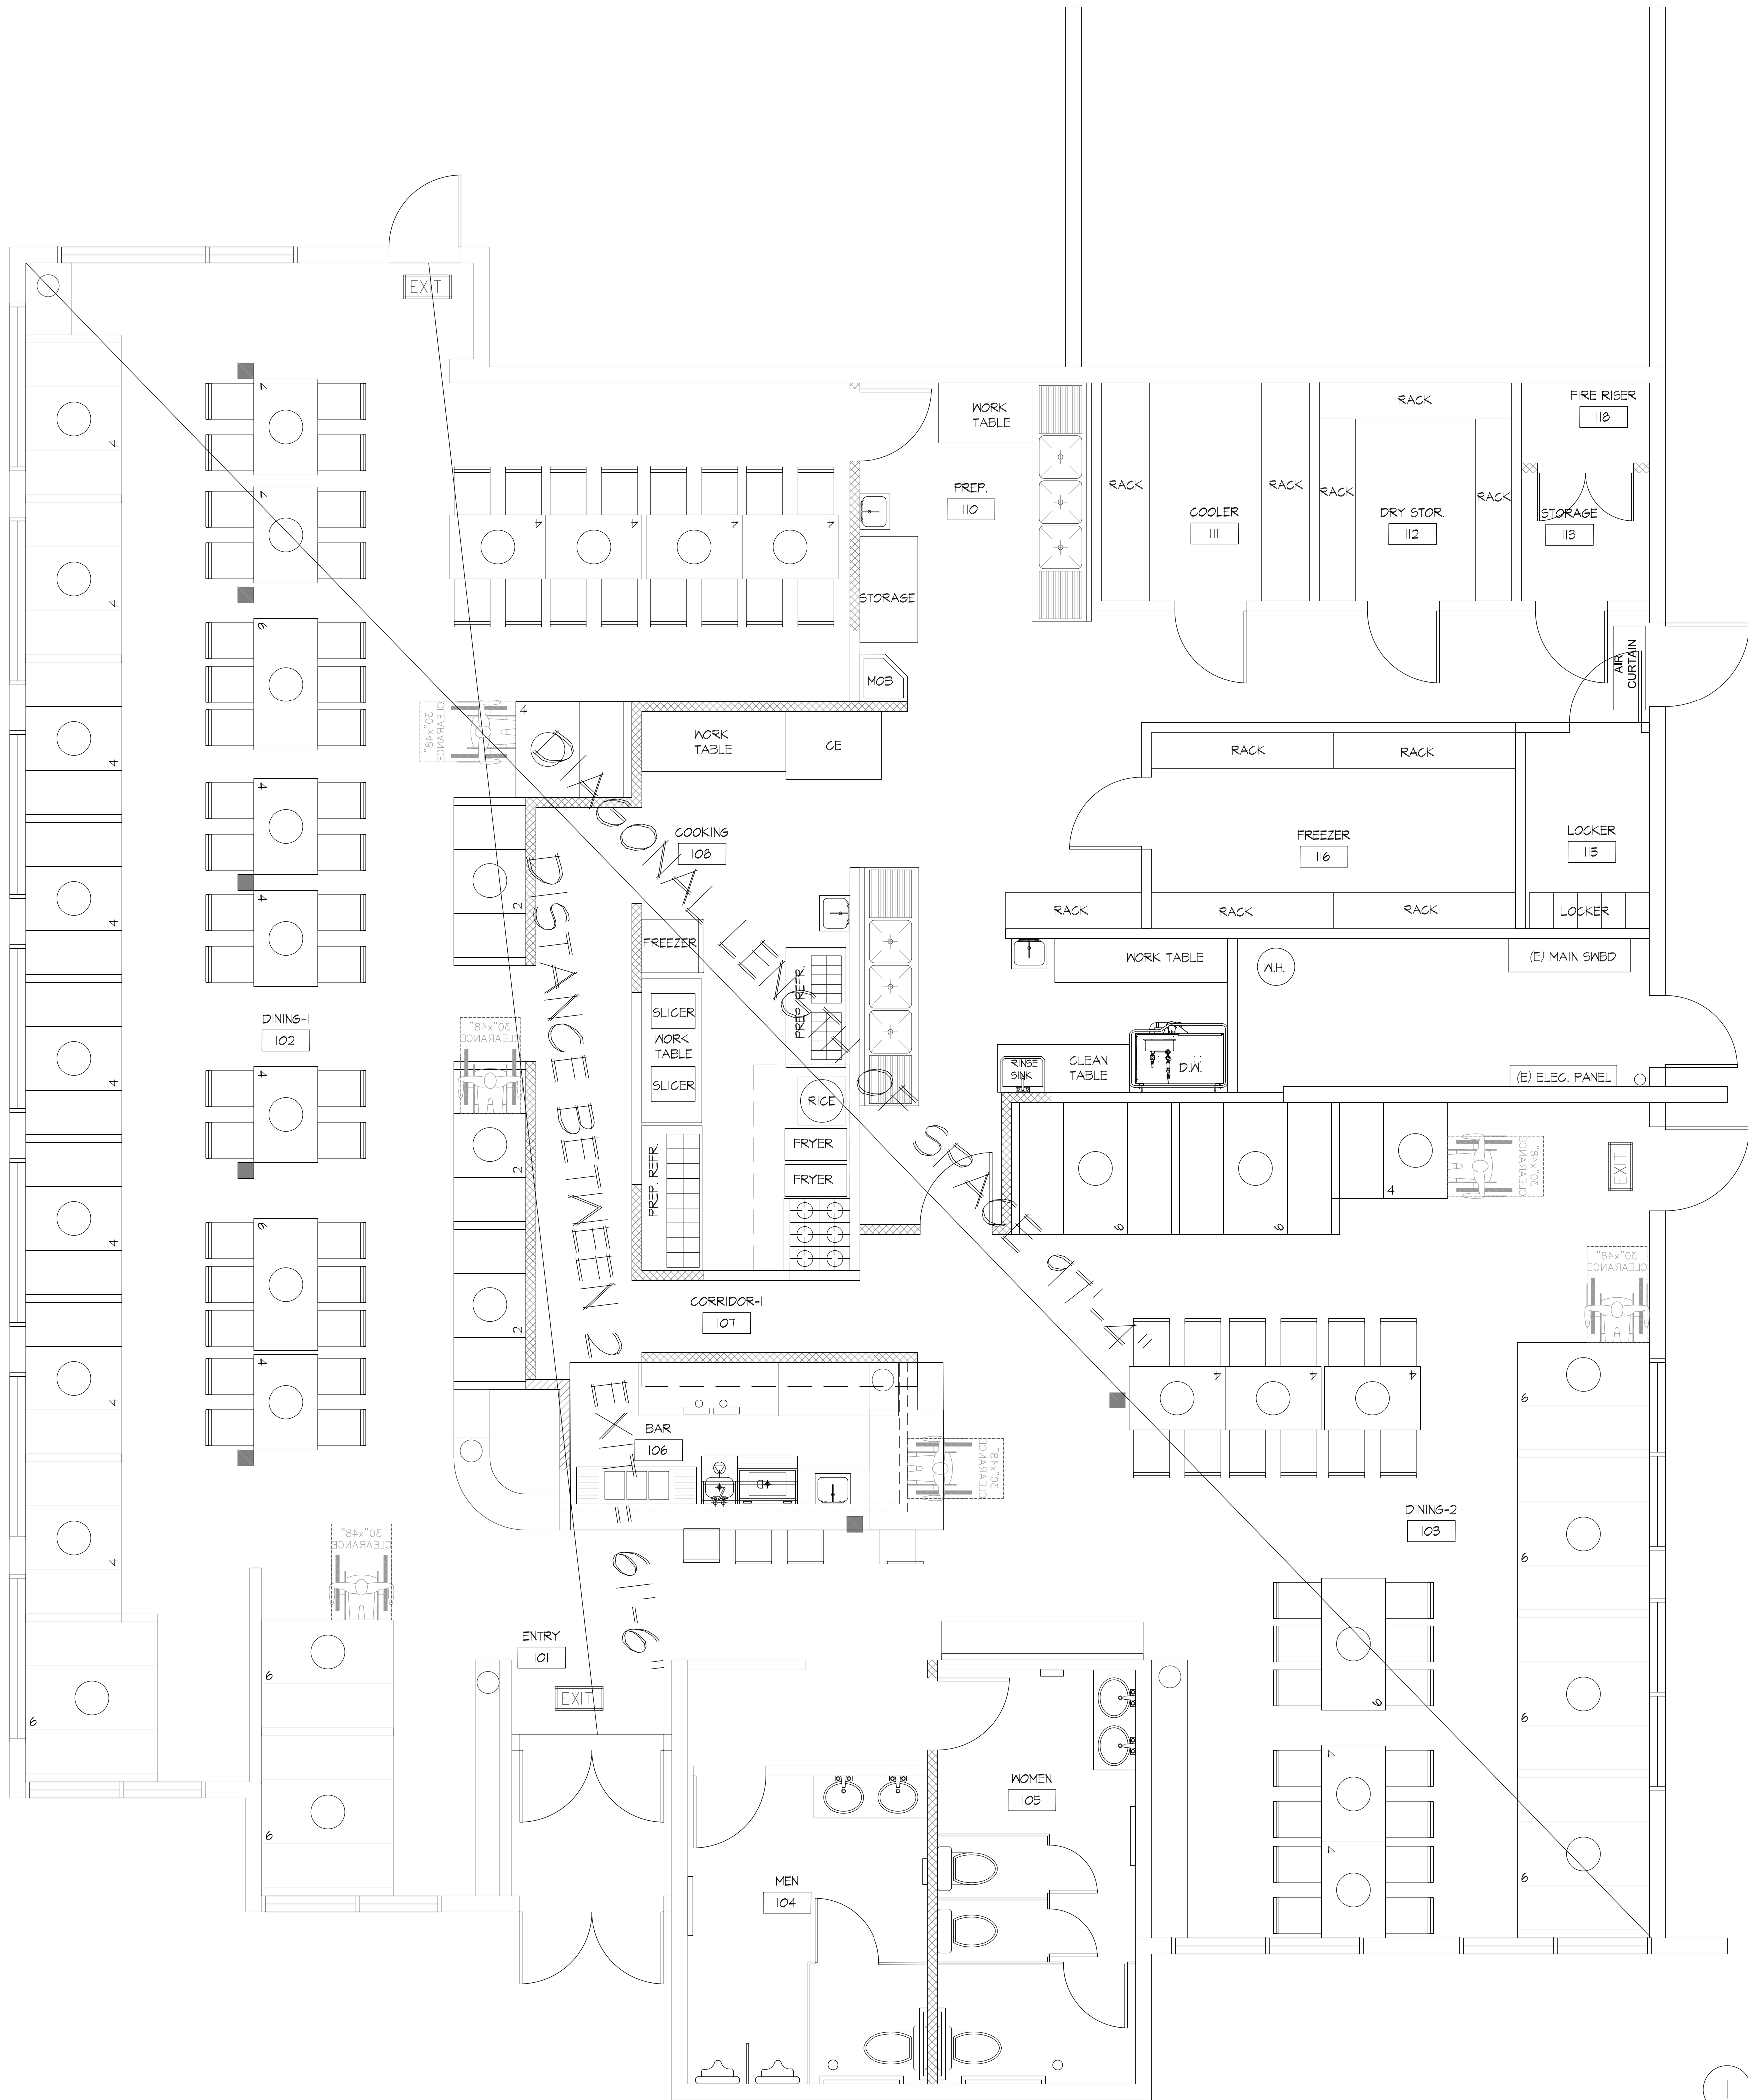

TOTAL AREA IN SCOPE: 4700 SQ. FT.
TOTAL OCCUPANCY: 204 OGS
2 EXIT REQUIRE (3 EXIT PROVIDED)
DISTANCE BETWEEN 2 EXITS: 61'-6"
HALF LENGTH OF DIAGONAL OF
THE AREA = 97'-4 1/2" = 48'-10"
EXIT ACCESS TRAVEL DISTANCE
< 250 MAX. (A-2 W/ SPRINKLER SYSTEM)

PROPOSED OCCUPANT LOAD ANALYSIS			
ROOM	AREA	F.A./OGG	OCCU. LOAD
DINING AREA	2334 SF	FIXED SEAT	179
STORAGE/MECH	459 SF	300	2
KITCHEN	620 SF	200	4
BAR	108 SF	200	1
LOCKER	48 SF	50	1
REST. RM CORRIDOR	1131 SF	0	0
TOTAL	4700 SF		187

- NOTES
- EXIT SIGN SHALL BE INTERNALLY OR EXTERNALLY ILLUMINATED AT ALL TIME.
 - EXIT SIGNS ILLUMINATED BY AN EXTERNAL SOURCE SHALL HAVE AN INTENSITY OR NOT LESS THAN 5 FOOT CANDLES (54 LUX).
 - INTERNALLY ILLUMINATED SIGNS SHALL BE LISTED AND LABELED AND SHALL BE INSTALLED IN ACCORDANCE WITH THE MANUF. INSTRUCTION AND SECTION 2702.
 - EXIT SIGNS SHALL BE CONNECTED TO AN EMERGENCY POWER SYSTEM THAT WILL PROVIDE AN ILLUMINATION OF NOT LESS THAN 90 MIN. IN CASE OF PRIMARY POWER LOSS.
 - EGRESS DOORS SHALL BE READILY OPENABLE FROM THE EGRESS SIDE WITHOUT THE USE OF A KEY SPECIAL KNOWLEDGE OR EFFORT.
 - DOOR HANDLES, LOCK AND OTHER OPERATING DEVICES SHALL BE INSTALLED AT A MIN. 34" AND A MAX 48" ABOVE THE FINISH FLOOR.
 - THE MEANS OF EGRESS, INCLUDING THE EXIT DISCHARGE SHALL BE ILLUMINATE AT ALL TIMES THE BUILDING SPACE SERVED BY THE MEANS OF EGRESS IS OCCUPIED.
 - THE MEANS OF EGRESS ILLUMINATION LEVEL SHALL NOT BE LESS THAN 1 FOOT-CANDLE AT THE WALKING SURFACE.

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• ARCHITECTURE BRANDING
• INTERIOR BRANDING
• PLANNING
• LAND-USE CONSULTATION



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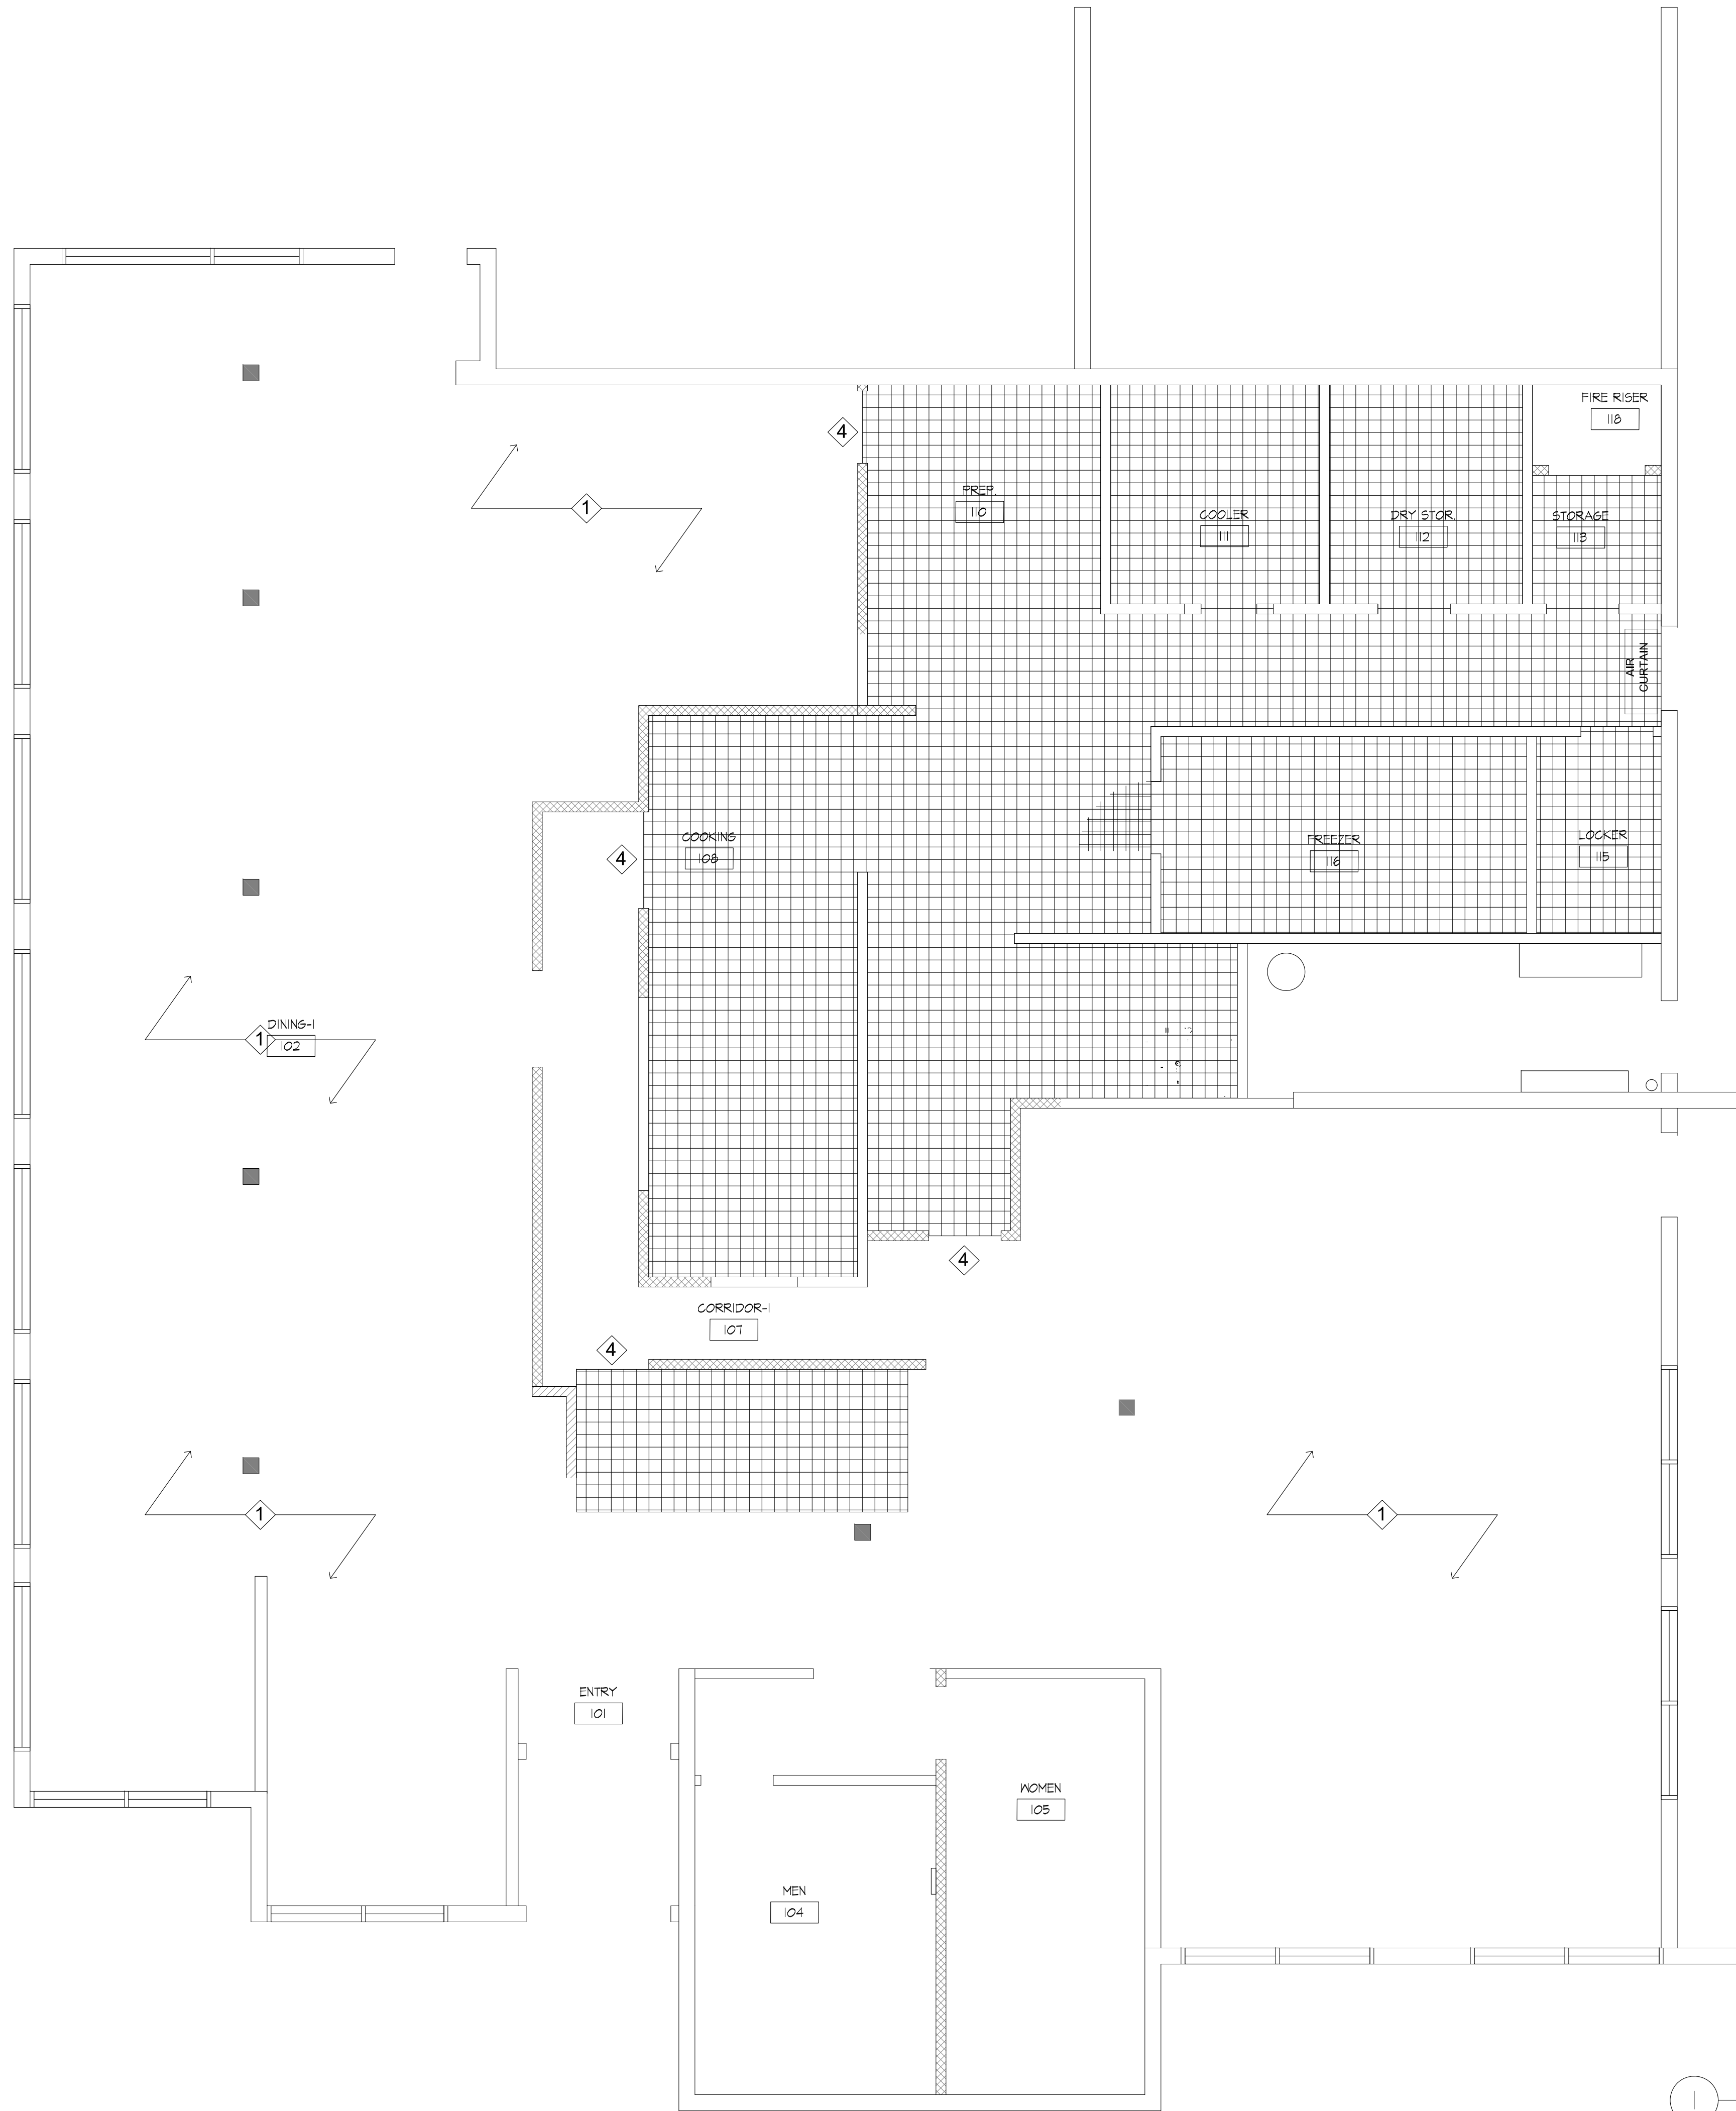
SCALE

SHEET NAME

**EXIT
PLAN**

SHEET NUMBER

A-1.2



1 FLOOR COVERING PLAN
Scale: 1/4" = 1'-0"

KEYED NOTES

- 1 SEALED CONCRETE
SEE SCHEDULE OF FINISHES
AND FINISH NOTES
- 2 INSTALL QUARRY TILE THROUGHOUT INSTALL COOLER &
FREEZER WALLS IN BED OF SEALANT PRIOR TO
INSTALLATION OF QUARRY TILE.
- 3 PLUMBING EQUIPMENT
- 4 INSTALL ALUMINUM TRANSITION FLOOR STRIP AT TILE
EDGE
- 5 PORCELAIN TILE ARE TO BE INSTALLED PER PLAN W/
FULL TILES SHEREVER POSSIBLE. SEE SCHEDULE OF
FINISHES AND FINISH NOTES

LEGEND

- QUARRY TILE
(SMOOTH THROUGHOUT)
- SEALED CONCRETE

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7157 S. State Street
Midvale, Utah, 84047


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Δ	CORRECTION BLDG.	4-26-18
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APPROVED BY : _____		

SCALE

SHEET NAME

FLOOR COVERING PLAN

SHEET NUMBER

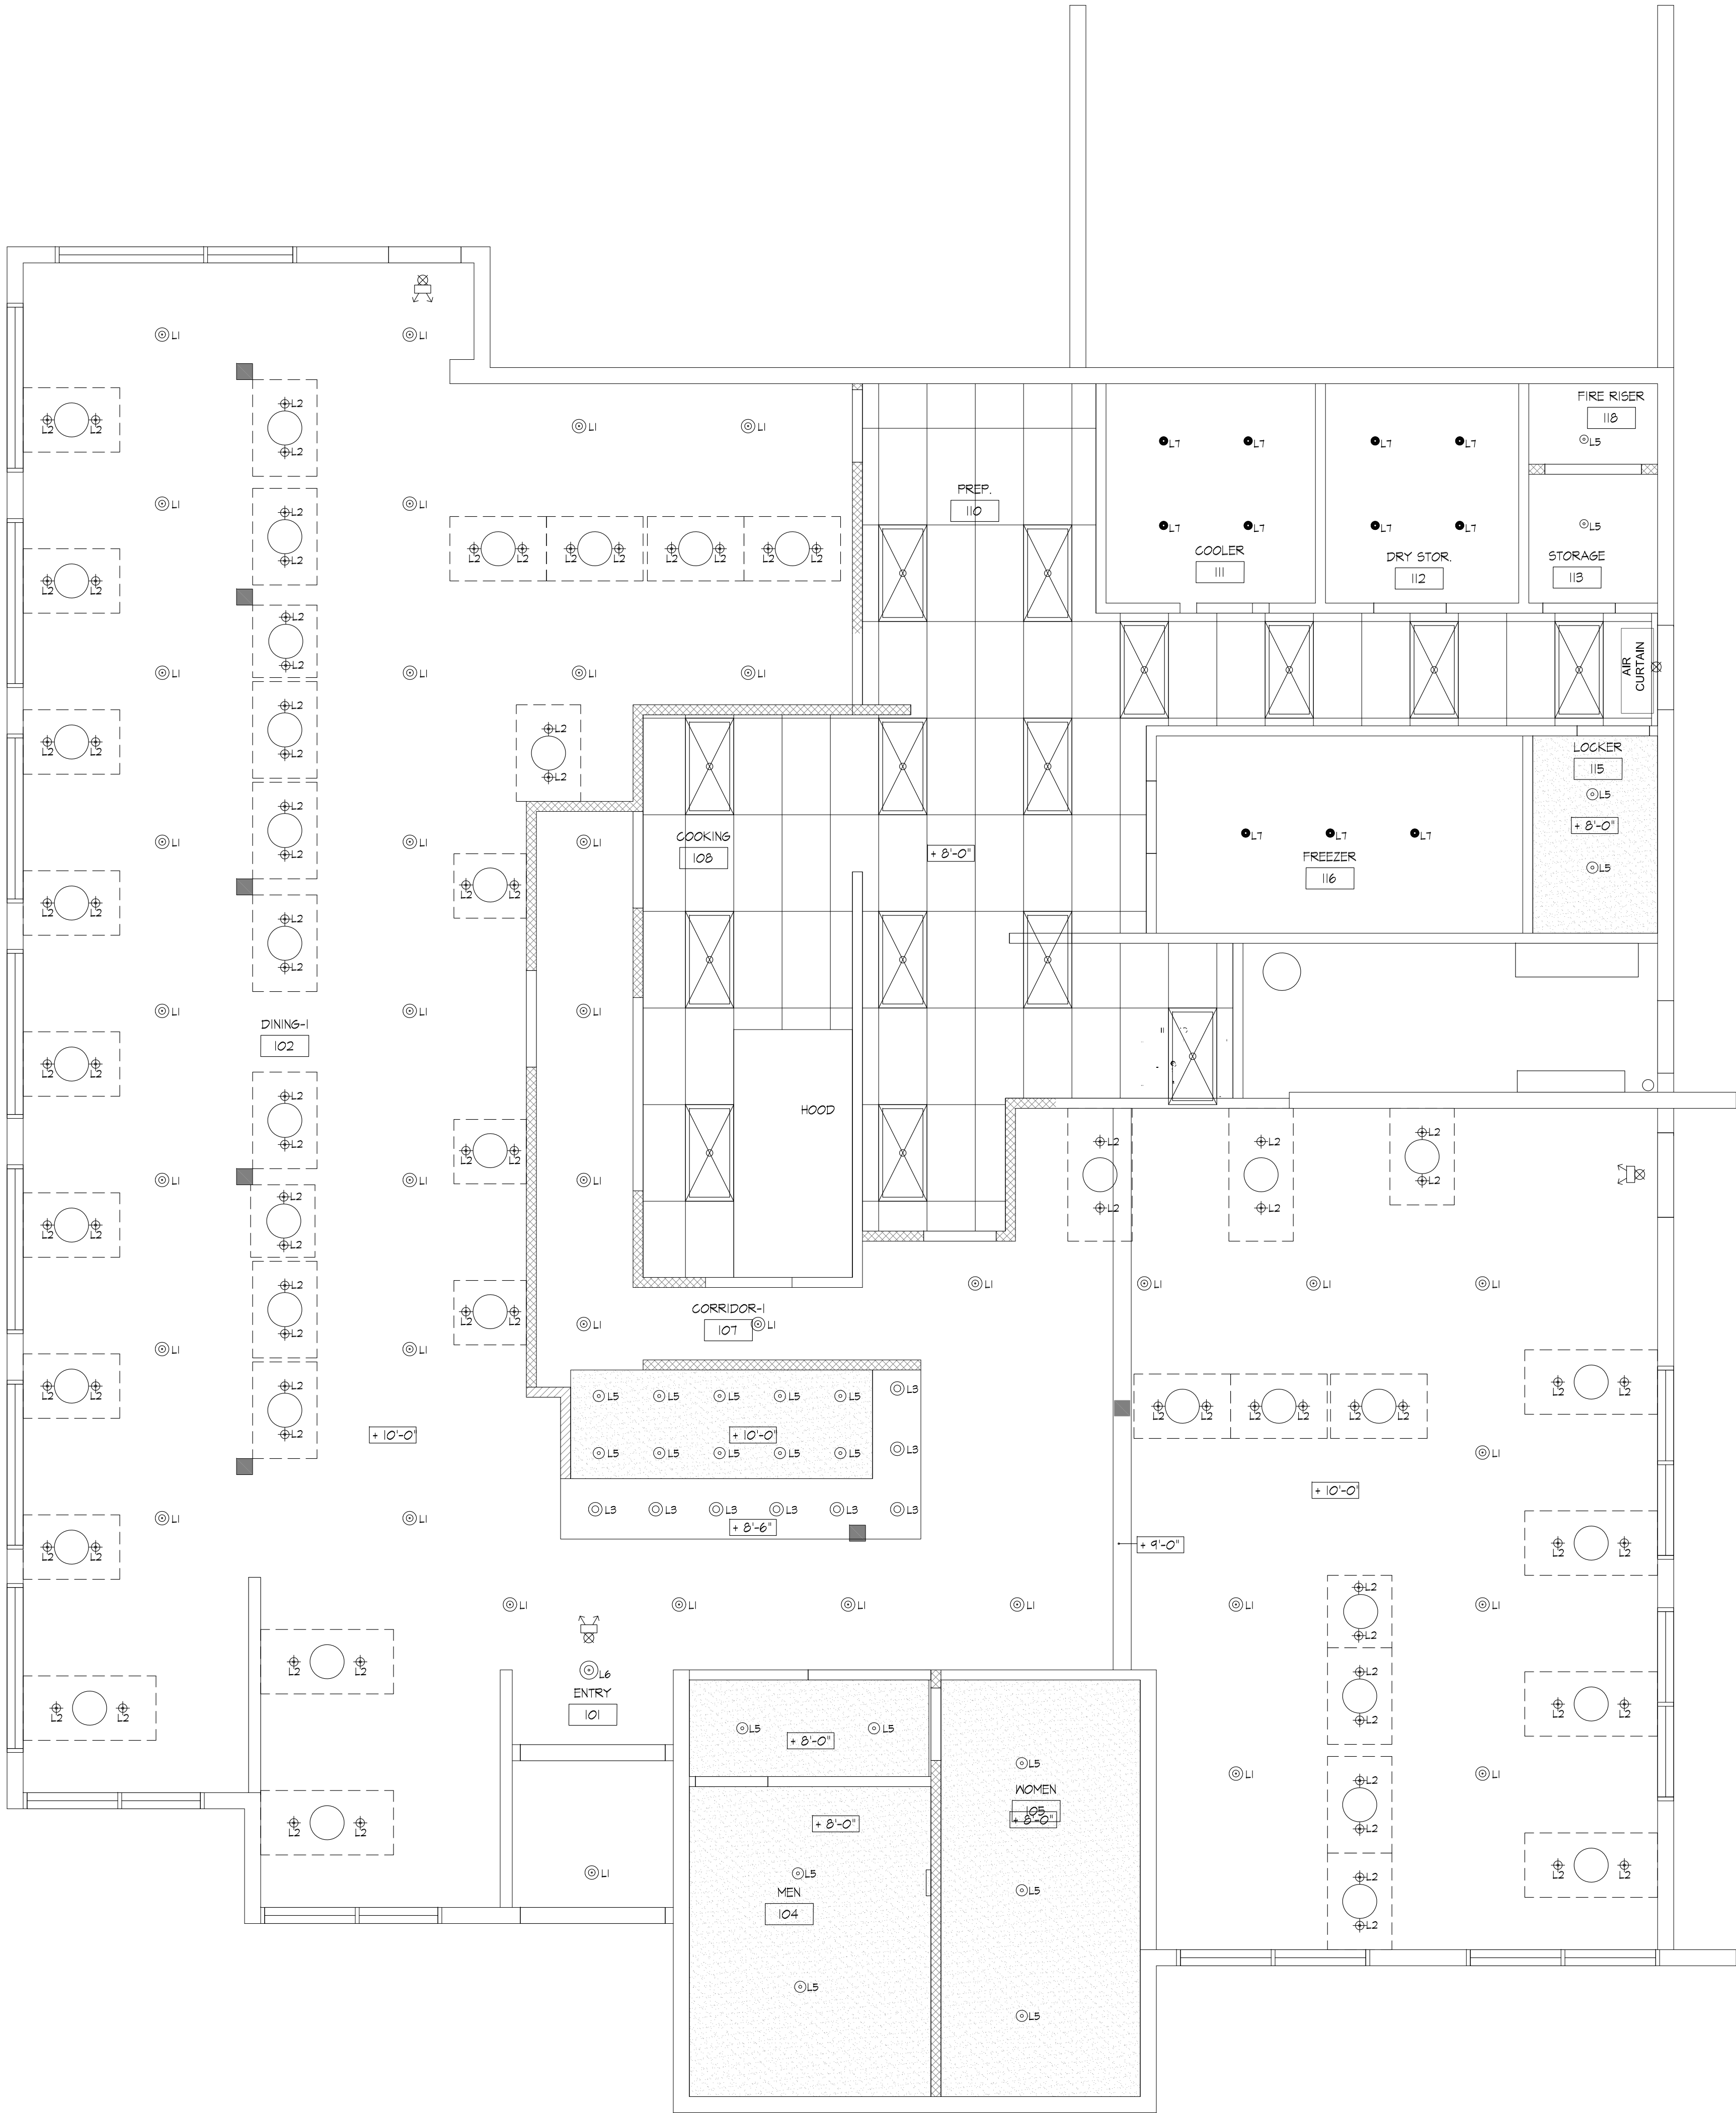

REFLECTED CEILING PLAN
Scale: 1/4" = 1'-0"

CEILING MATERIAL LEGEND :

4'-0"X 2'-0" ACOUSTICAL CEILING TILE
(SEE INTERIOR FINISH SCHEDULE)



GYF. BD. CEILING-1
(SEE INTERIOR FINISH SCHEDULE)



GYF. BD. CEILING-2
(SEE INTERIOR FINISH SCHEDULE)



LIGHTING LEGEND :

LED 21 WATT

PENDANT LIGHTING (BOOTH TABLE)
(W/ ACRYLIC LENSE SHATTER PROOF)

PENDANT LIGHTING (BAR)
(W/ ACRYLIC LENSE SHATTER PROOF)

PENDANT LIGHTING (SPOT LIGHT)

RECESSED DOWN LIGHTING (HARD CEILING)

PENDANT LIGHTING (AT RECEPTION)

VAPER BARRIER LIGHTING (@ WALK-IN BOX)

LED LINEAR LIGHT

EXHAUST HOOD

TABLE TOP BBQ GRILL HOOD

2'-0"X4'-0" RECESSED FLUORESCENT
LIGHTING FIXTURE
(W/ ACRYLIC LENSE SHATTER PROOF)

FLUORESCENT LIGHT FIXTURE

EXHAUST FAN
- AIR CHANGE EVERY 15 MINUTES

EXIT SIGN W/ BATTERY BACK-UP
(4" T-6" ON WALL MOUNT UNITS UCN)

EMERGENCY BATTERY PACK

LED 21 WATT

LED - LITHONIA MINI PENDANT (9.5 WATT)

LED - LITHONIA MINI PENDANT (9.5 WATT)

LED 12 WATT

LED - LITHONIA RECESSED DOWNLIGHT (6", 16.5 WATT)

LED 15 WATT

LED 12 WATT

REVISIONS

△ CORRECTION SWRF 4-19-18
△ CORRECTION BLDG. 4-26-18

NO. ISSUE DATE

PROJECT DATA

PROJECT NUMBER :

DATE :

DRAWN BY :

CHECKED BY :


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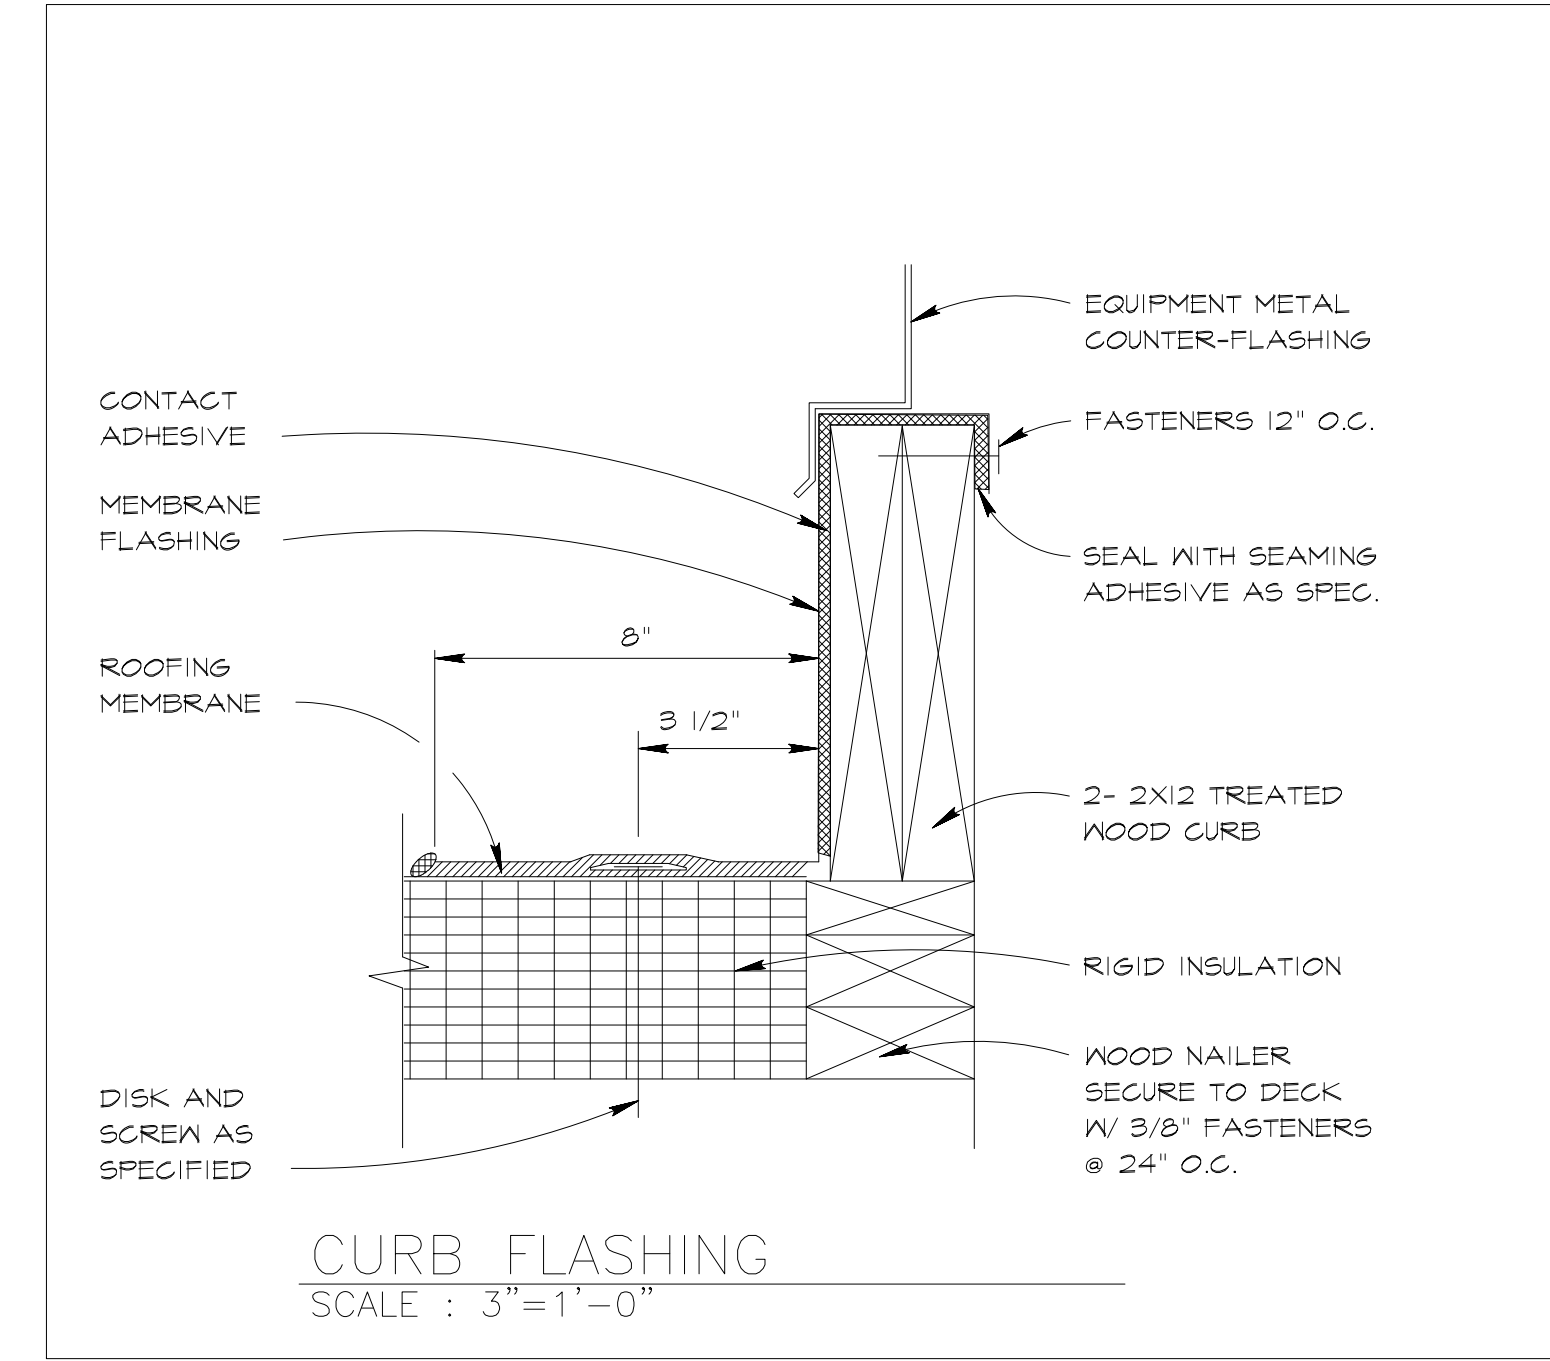
SHEET NAME

REFLECTED
CEILING
PLAN

SHEET NUMBER



1 ROOF PLAN
Scale: 1/4" = 1'-0"

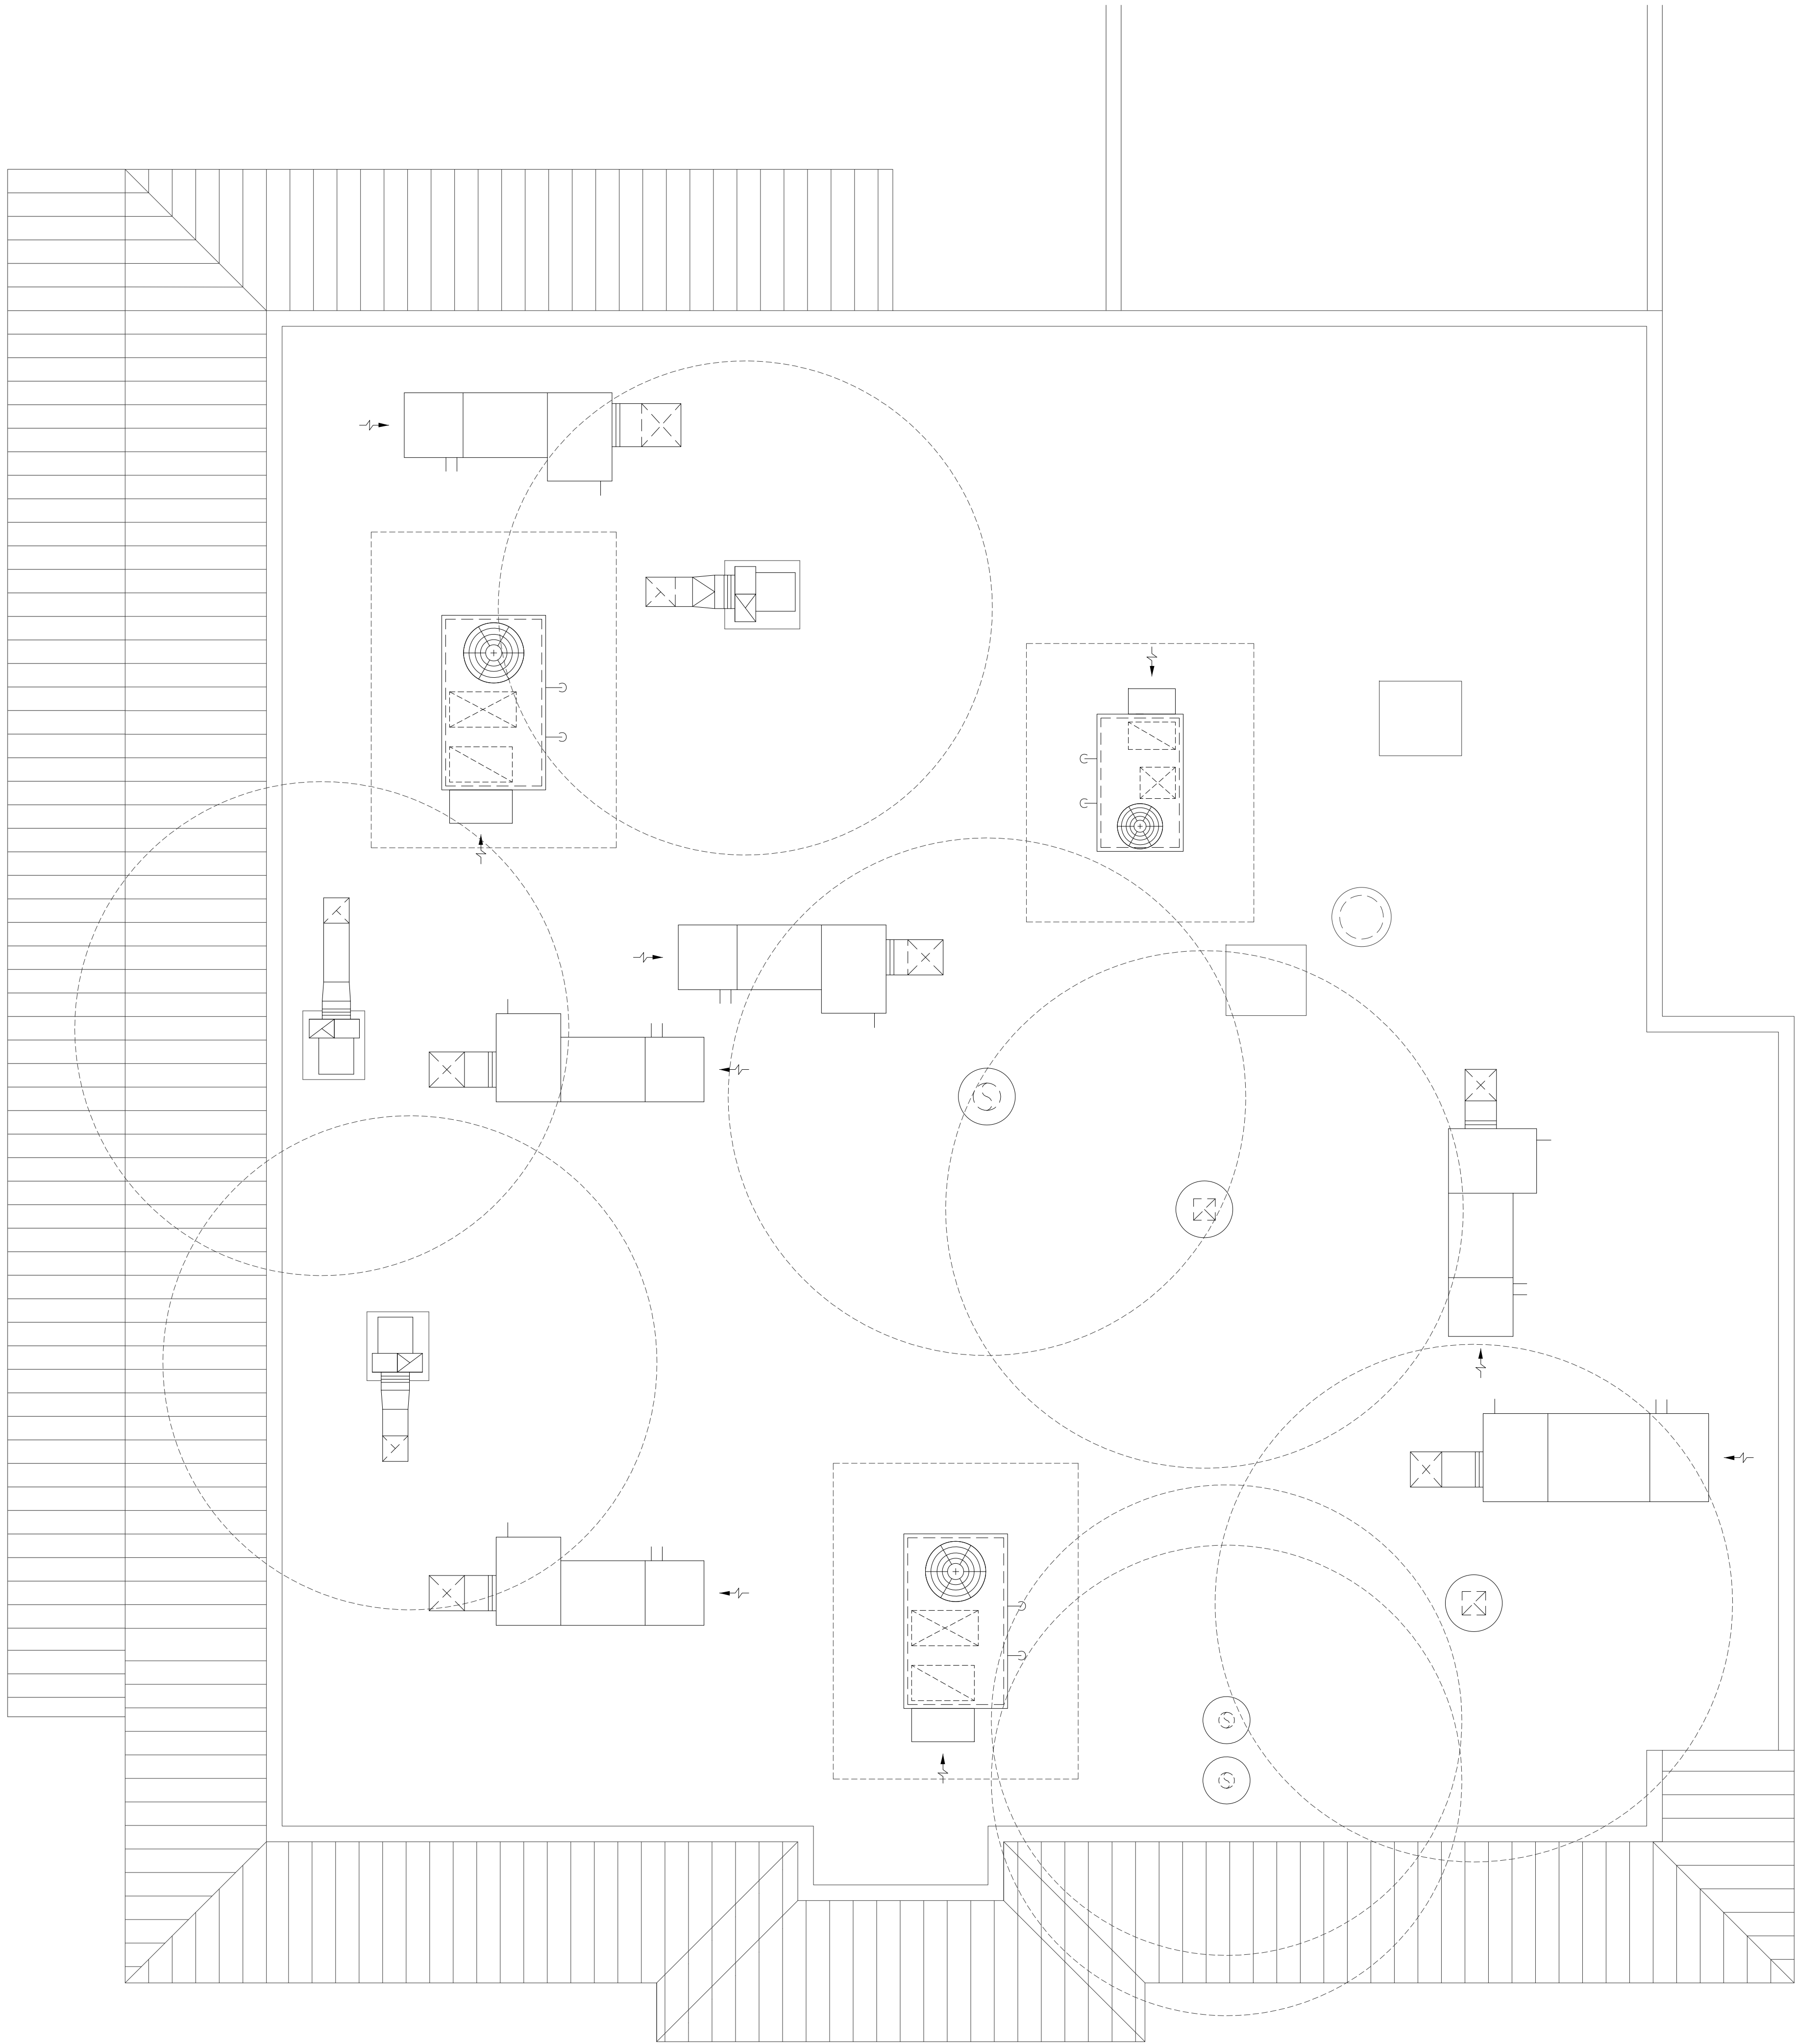

WOU
DESIGN PARTNERS
3470 WILSHIRE BLVD, SUITE 930
LOS ANGELES, CA 90010
• ARCHITECTURE BRANDING
• INTERIOR BRANDING
• PLANNING
• LAND-USE CONSULTATION



TITLE

Korean BBQ of Utah
7157 S. State Street
Midvale, Utah, 84047

REVISIONS		
Δ	CORRECTION SWRF	4-19-18
Δ	CORRECTION BLDG.	4-26-18

NO.	ISSUE	DATE
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APPROVED BY : _____


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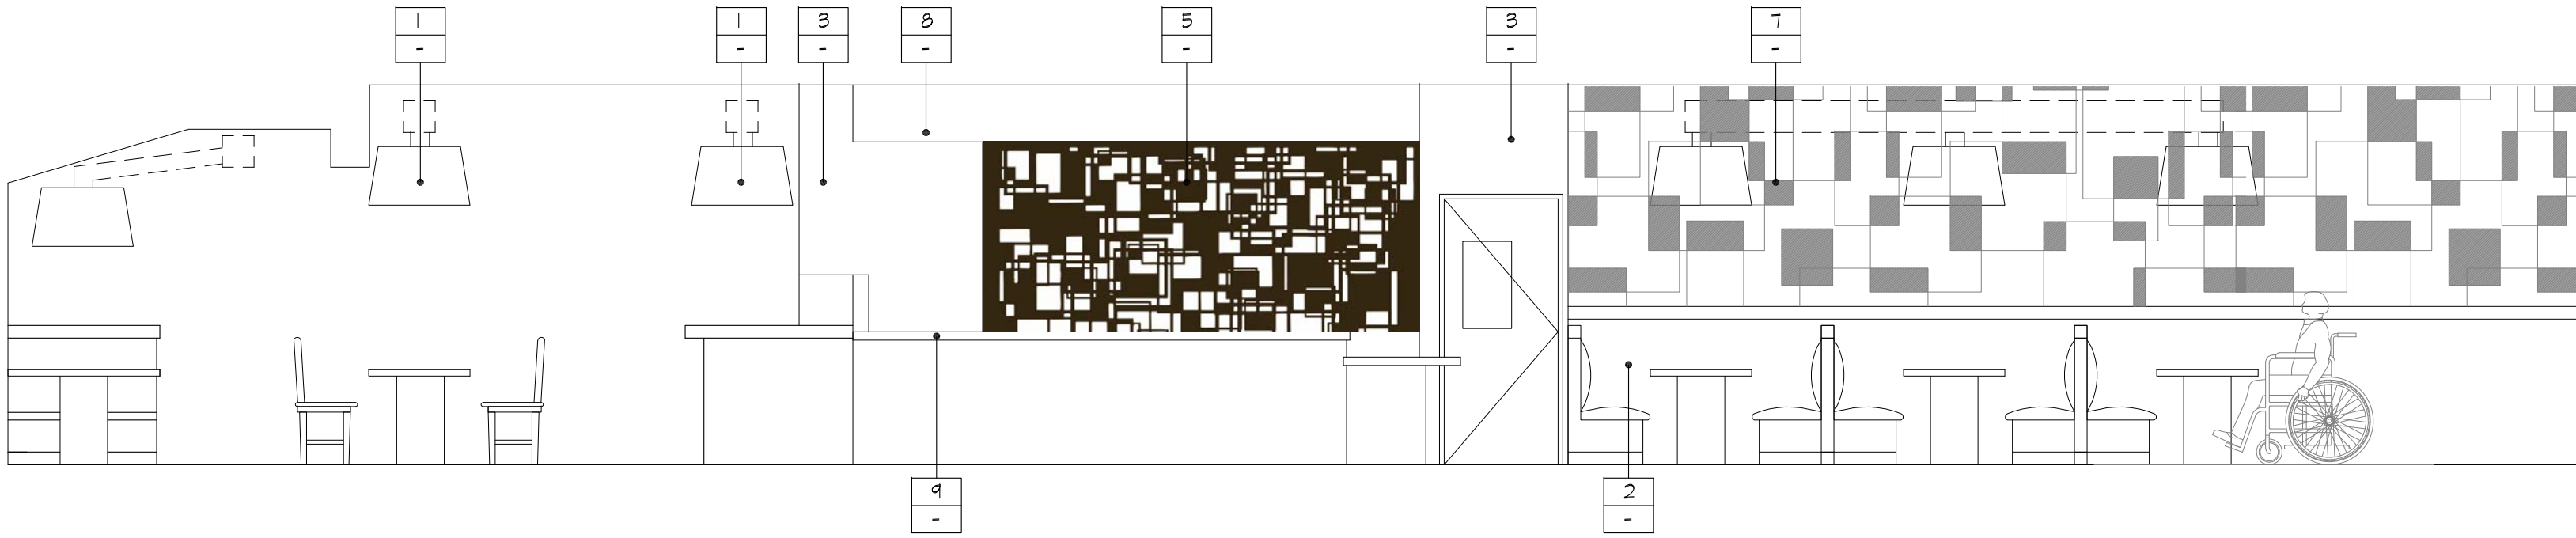
ROOF PLAN

SHEET NUMBER


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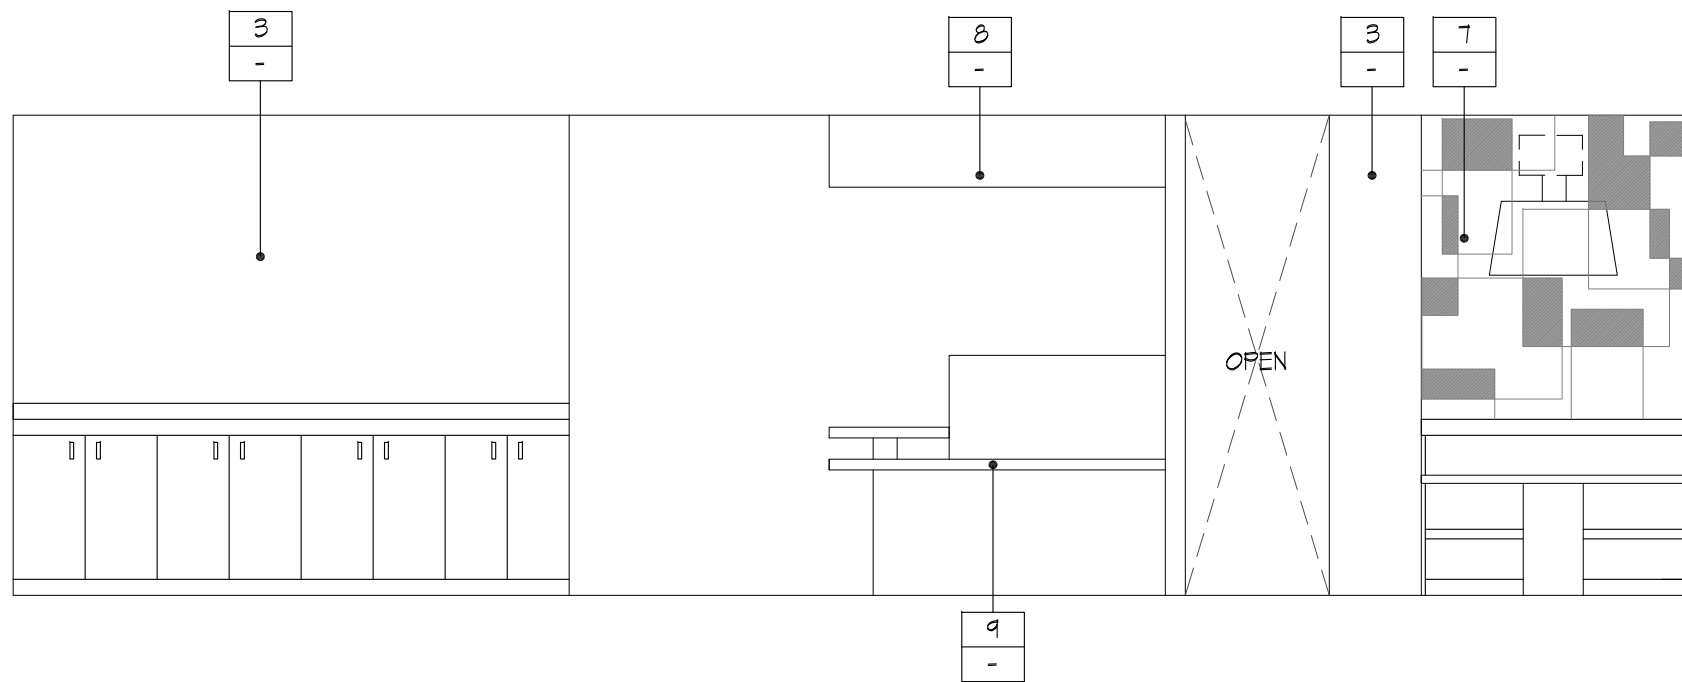
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Scale: 1/4" = 1'-0"




2 INTERIOR ELEVATION
Scale: 1/4" = 1'-0"

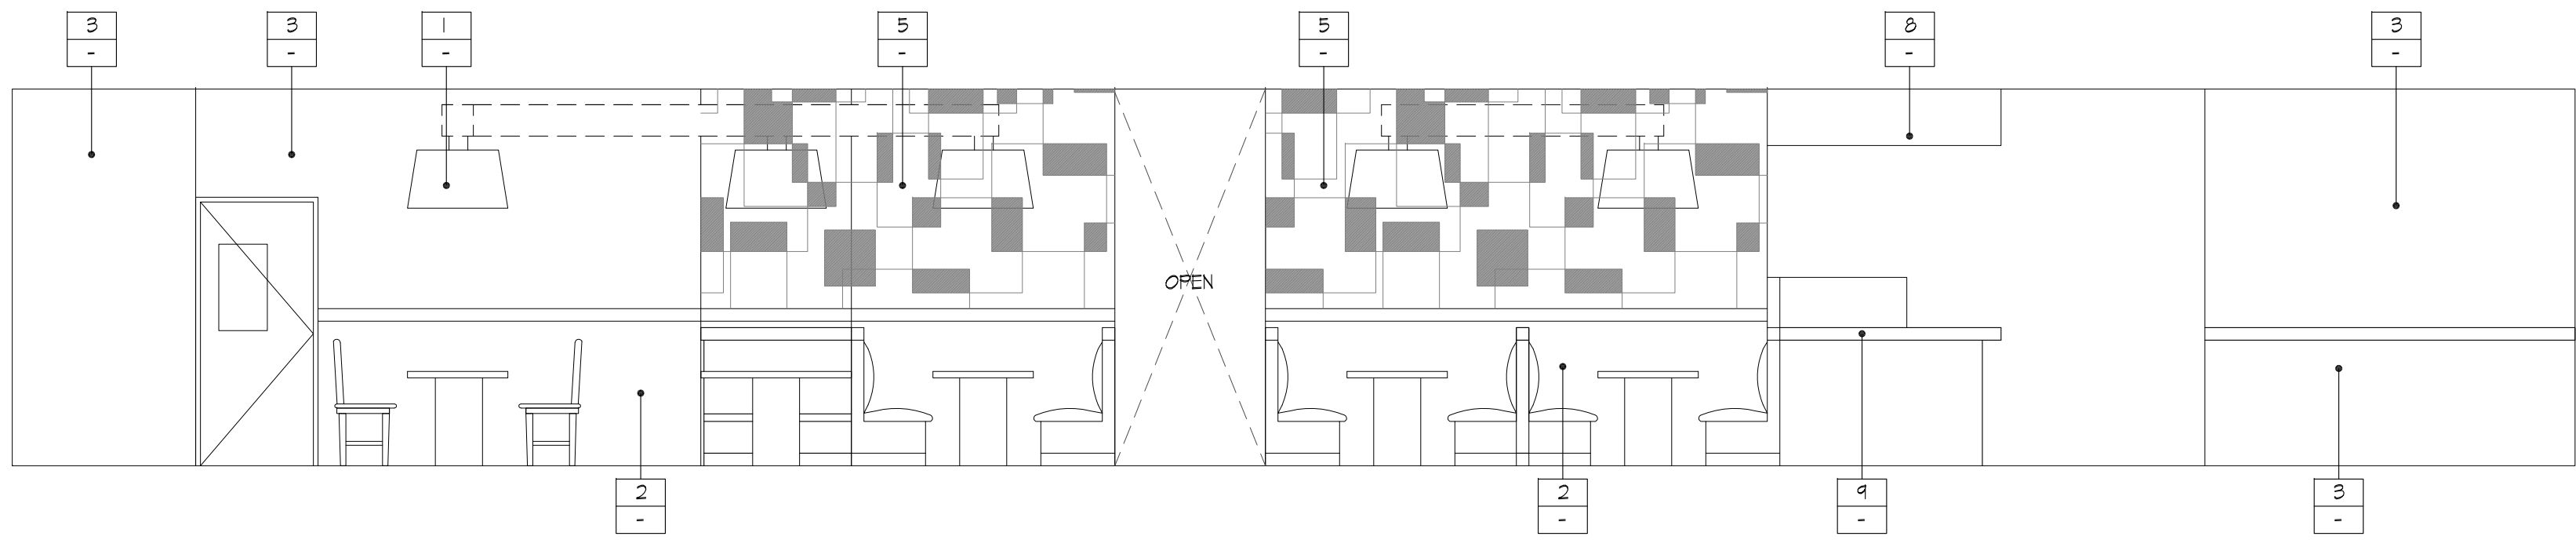


3 INTERIOR ELEVATION
Scale: 1/4" = 1'-0"

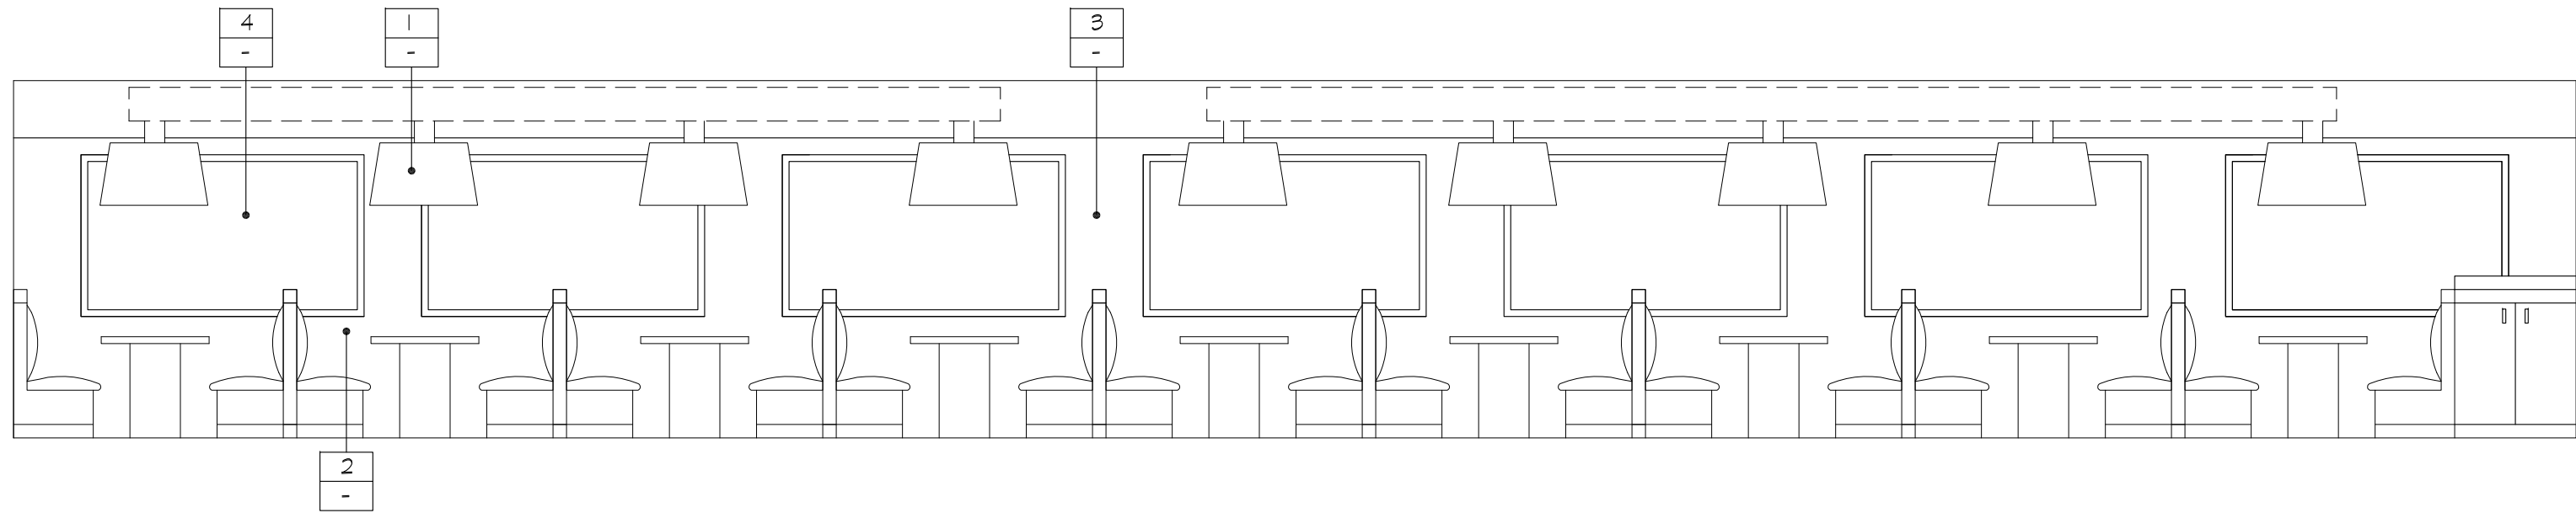

4 INTERIOR ELEVATION
Scale: 1/4" = 1'-0"

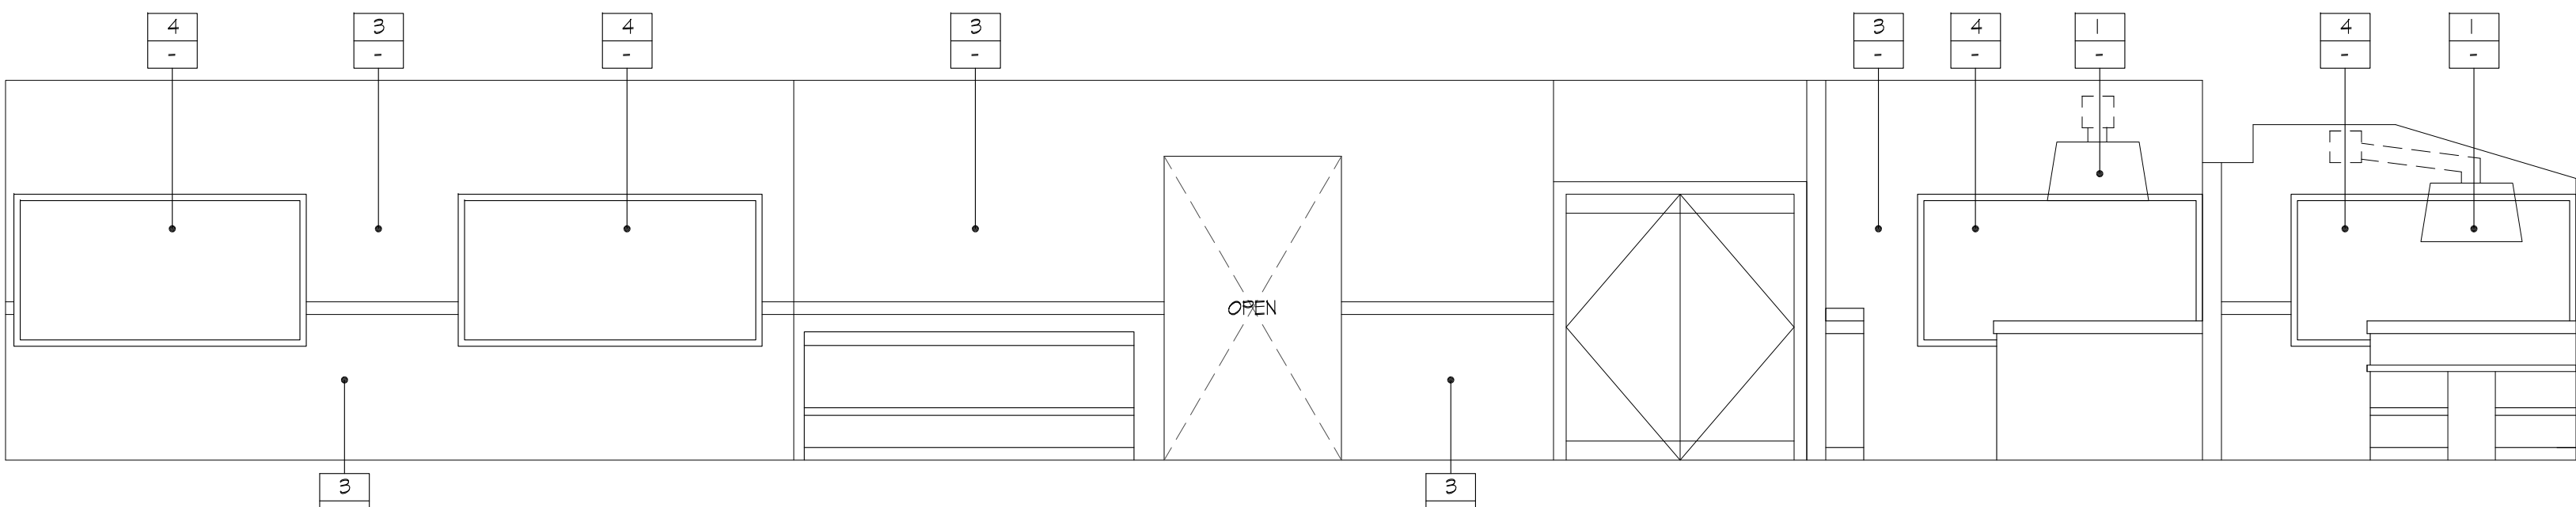

5 INTERIOR ELEVATION
Scale: 1/4" = 1'-0"

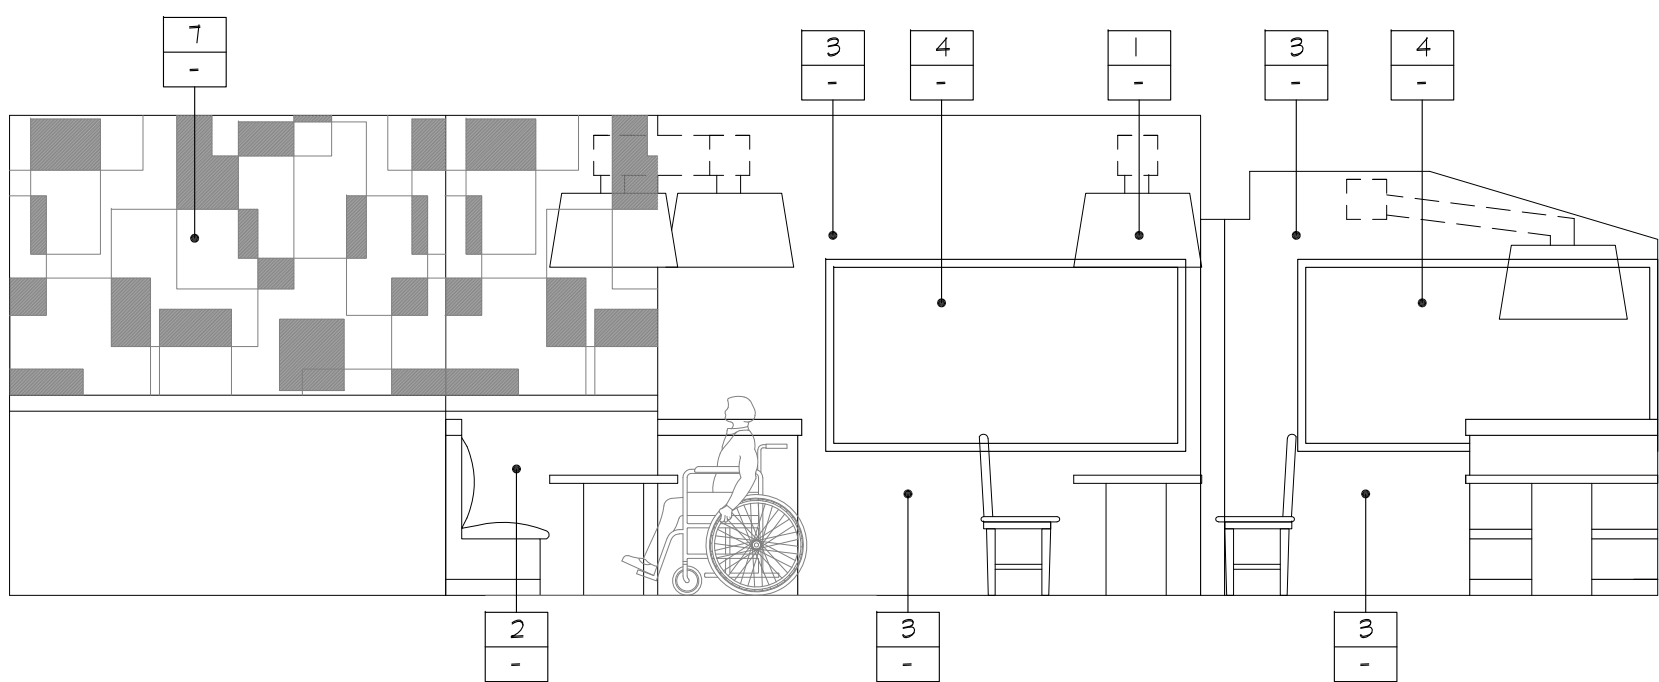

6 INTERIOR ELEVATION
Scale: 1/4" = 1'-0"


KEY NOTES AND MATERIAL

- 1 - EXHAUST HOOD
- 2 - LAMINATED PLASTIC
- 3 - PAINTED GYP. BD.
- 4 - EXISTING WINDOW
- 5 - POLYCARBONATE FILM WITH BACKLIGHT
- 6 - TEMP. CLEAR GLASS
- 7 - FABRIC OVER MDF
- 8 - ACRYLIC PANEL WITH BACKLIGHT
- 9 - QUARZE STONE


COLOR AND FINISH

- A - DUNN EDWARDS
- B - DUNN EDWARDS
- C - DUNN EDWARDS
- D - DUNN EDWARDS
- E - DUNN EDWARDS
- F - DUNN EDWARDS

KEY PLAN

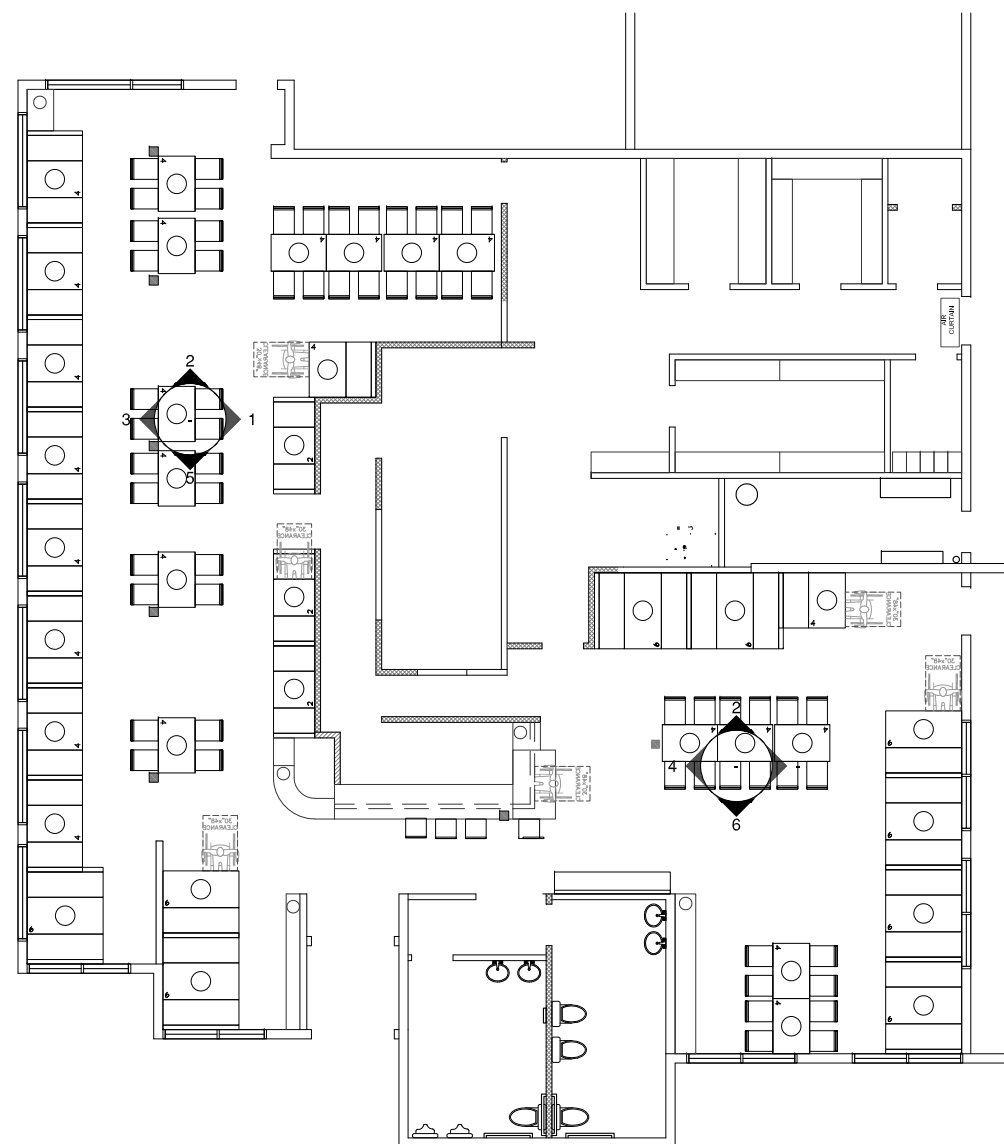

DOOR SCHEDULE											
MARK	LOCATIONS	EXISTING	DOOR				FRAME			HARDWARE	
(NO)			SIZE	TYPE	MAT'L	RATING	MAT'L	JAMB	HEAD	CLOSER	TYPE
1	ENTRY		(2) 3'-0" X 10'-0"	A	AL.		AL.	STL	STL	YES	1
2	ENTRY		(2) 3'-0" X 10'-0"	A	AL.		AL.	-	-	YES	
3	MEN	○	3'-0" X T'-0" X 1 3/4"	B	S.C.		H.M.	J-1	H-1		3
4	WOMEN	○	3'-0" X T'-0" X 1 3/4"	B	S.C.		H.M.	J-1	H-1		3
5	DINING-2	○	3'-0" X T'-0" X 1 3/4"	B	S.C.		H.M.	J-1	H-1		2
6	DINING-1		3'-0" X T'-0" X 1 3/4"	A	AL.		H.M.	J-1	H-1	YES	1
7	PREP.	○	3'-0" X T'-0" X 1 3/4"	D	AL.		AL.	-	-		4
8	COOLER		3'-0" X T'-0"	WALK-IN COOLER/FREEZER DOOR BY MANUFACTURER							
9	DRY STORAGE	○	3'-0" X T'-0" X 1 3/4"	B	S.C.		H.M.	J-1	H-1		2
10	STORAGE	○	3'-0" X T'-0" X 1 3/4"	B	S.C.		H.M.	J-1	H-1		2
11	FIRE RISER		(2) 2'-0" X T'-0" X 1 3/4"	B	S.C.		H.M.	J-1	H-1		
12	CORRIDOR-2	○	3'-0" X T'-0" X 1 3/4"	B	S.C.		H.M.	J-1	H-1		2
13	LOCKER		3'-0" X T'-0" X 1 3/4"	B	S.C.		H.M.	J-1	H-1		2
14	FREEZER	○	3'-0" X T'-0"	WALK-IN COOLER/FREEZER DOOR BY MANUFACTURER							
15	WASHING		(2) 18" X T'-0"	D	AL.		STL	-	-		4

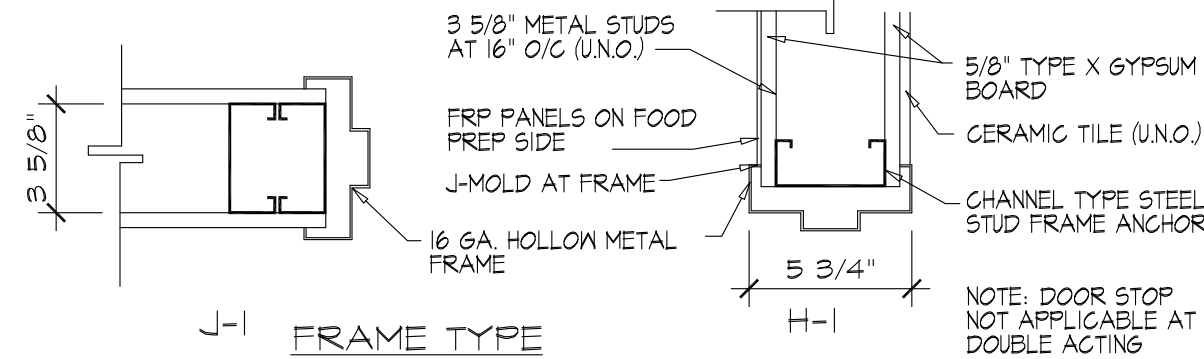

NOTES

- ALL EGRESS DOOR HARDWARE SHALL BE READILY OPENABLE FROM SIDE WHICH EGRESS IS TO BE MADE WITHOUT THE USE OF A KEY OR SPECIAL KNOWLEDGE OR EFFORT
- OPENABLE PARTS SHALL BE 34 INCHES MINIMUM AND 44 INCHES MAXIMUM ABOVE THE FINISH FLOOR OR GROUND.

DOOR HARDWARE TYPES

1 - LOCKING LATCH SET WITH LEVER SUCH THAT DOOR ALWAYS OPENS WHEN INTERIOR LEVER IS TURNED. KEY LOCK ON EXTERIOR, CLOSER, WEATHERSTRIPPING PROVIDE PANIC HARDWARE ON ALL EXIT DOORS EXCEPT MAIN ENTRANCE/EXIT.

2 - LOCKING LATCH SET WITH LEVER SUCH THAT DOOR ALWAYS OPENS WHEN INTERIOR LEVER IS TURNED. KEY LOCK ON EXTERIOR, PEEP HOLE, BUZZER, CLOSER.


3 - RESTROOM FUNCTION, DOOR ALWAYS OPENS FROM INTERIOR (PUSH AND PULL)

4 - PUSH AND PULL, DBL. ACTING DOOR

5 - PRIVATE HARDWARE

6 - OPENABLE PARTS SHALL BE OPENABLE WITH ONE HAND AND SHALL NOT REQUIRED TIGHT GRASPING, PINCHING, OR TWISTING OF THE WRIST, THE FORCE REQUIRED TO ACTIVATE OPERABLE PARTS SHALL BE 5 LB. MAXIMUM.

7. THE BOTTOM 10 INCHES OF ALL DOORS TO HAVE A SMOOTH UNINTERRUPTED SURFACE TO ALLOW THE DOOR TO BE OPENED BY A WHEELCHAIR FOOTREST WITHOUT CREATING A TRAP OR HAZAROUS CONDITION.

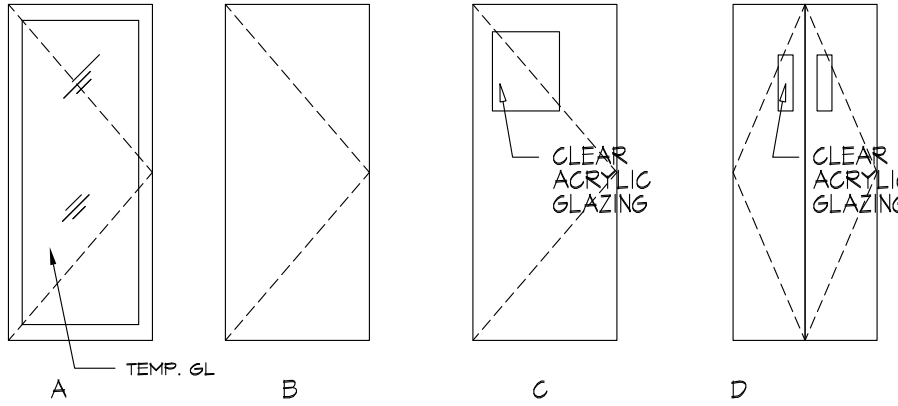

DOOR TYPES

ABREY'S:

HR. = HOUR
SC WOOD = SOLID CORE WOOD
OAK VENEERED PREP FOR STAIN
EX = EXISTING
HM. = HOLLOW METAL
HA. = HARDWOOD
AL. = ALUMINUM

* A READILY VISIBLE DURABLE SIGN IS POSTED ON EGRESS SIDE ON OR ADJACENT TO THE DOOR STATING: "THIS DOOR TO REMAIN UNLOCKED WHEN BUILDING IS OCCUPIED". THE SIGN SHALL BE IN LETTER 1" HIGH ON A CONTRASTING BLACK GROUND.

** PROVIDE PANIC HARDWARE AT REAR EXIT DOOR LISTED IN ACCORDANCE WITH UL 305, FOR FIRE EXIT HARDWARE IN COMPLIANCE WITH UL 10C OR UL 305 AND CBC 100B.1.10.1.

ROOM FINISH SCHEDULE

MARK	NAME	FLOOR	BASE	WALLS	CEILING	CEILING HEIGHT	REMARKS
		SEALED CONCRETE PORCELAIN TILE QUARRY TILE GALV. METAL EXPOSED CONC. PAINTED WOOD 6" HT CERAMIC COVE TILES (S & R) COVE GLASS (S & R) 6" HT GALV. METAL (S & R)	SEALED CONCRETE PORCELAIN TILE QUARRY TILE GALV. METAL EXPOSED CONC. PAINTED WOOD 6" HT CERAMIC COVE TILES (S & R) COVE GLASS (S & R) 6" HT GALV. METAL (S & R)	SEALED CONCRETE PORCELAIN TILE QUARRY TILE GALV. METAL EXPOSED CONC. PAINTED WOOD 6" HT CERAMIC COVE TILES (S & R) COVE GLASS (S & R) 6" HT GALV. METAL (S & R)	SEALED CONCRETE PORCELAIN TILE QUARRY TILE GALV. METAL EXPOSED CONC. PAINTED WOOD 6" HT CERAMIC COVE TILES (S & R) COVE GLASS (S & R) 6" HT GALV. METAL (S & R)	SEALED CONCRETE PORCELAIN TILE QUARRY TILE GALV. METAL EXPOSED CONC. PAINTED WOOD 6" HT CERAMIC COVE TILES (S & R) COVE GLASS (S & R) 6" HT GALV. METAL (S & R)	
101	ENTRY					10'-0"	● PAINT TYPE WILL BE SEMIGLOSS IN ALL AREAS EXCEPT OFFICE AND DINING ● CEILING TILE : WASHABLE, SMOOTH FINISH, WHITE COLOR (SMOOTH VINYL CEILING TILE) ● PROVIDE ALL WALLS (BEHIND AND ADJACENT TO SINKS, DISHWASHERS AND JANITORIAL FACILITIES) ARE FRP OR STAINLESS STEEL - 8FT. HT. FROM THE TOP OF COVE BASE. ●● PROVIDE STAINLESS STEEL FINISH AT KITCHEN HOOD WALL ●H FULL HEIGHT
102	DINING-1					10'-0"	
103	DINING-2					10'-0"	
104	MEN					8'-0"	
105	WOMEN					8'-0"	
106	BAR					10'-0"	
107	CORRIDOR-1					10'-0"	
108	COOKING					8'-0"	
109	WASHING					8'-0"	
110	PREP.					8'-0"	
111	COOLER					8'-0"	
112	DRY STORAGE					8'-0"	
113	STORAGE					8'-0"	
114	CORRIDOR-2					10'-0"	
115	LOCKER					8'-0"	
116	FREEZER					8'-0"	
117	MECH.					8'-0"	
118	FIRE RISER					8'-0"	

FINISH NOTES :

- CORNER GUARDS TO BE INSTALLED AT ALL OUTSIDE CORNERS IN KITCHEN, SERVICE, PREP. (STAINLESS) AND DINING ROOM (CLEAR). SUPPLIED AND INSTALLED BY G.C.
- NOT ALL FINISHES IN SCHEDULE OF FINISHES ARE NECESSARILY INCLUDED IN THIS SCOPE OF WORK. SEE ROOM FINISH SCHEDULE
- KITCHEN DOOR (DOUBLE) : ELIASON SCP-8 MODEL W/ PLAS. LAM. FIN. BOTH SIDES, WITH 9\"/>
- ALL METAL DOOR FRAMES TO BE PAINTED PER INTERIOR ELEVATIONS.
- FLOOR TILE TO BE OBTAINED THROUGH OWNER'S CONTACT.
- G.C. TO LEAVE ON SITE, UPON COMPLETION OF JOB, (1) BOX EACH OF ALL WALL, FLOOR & CEILING TILE USED.



WALK-IN COOLER/FREEZER

ELECTRICAL REQUIRES A SEPARATE PERMIT

PANELS FOR THE COOLERS AND FREEZER CONSIST OF ALUMINUM OR STEEL SKINS AND A CORE OF 4" THICK DOW CHEMICAL COMPANY-DELTA-TERM AF 4500/VORACOR GE 151 FOAMED-IN-PLACE POLYURETHANE HAVING AN AVERAGE IN-PLACE DENSITY OF 2.1 POUNDS PER CUBIC FOOT. THE PANELS ARE HELD TOGETHER BY USE OF POSI-LOC FASTENING DEVICES ALONG THE EDGES. FLAME SPREAD AND SMOKE DENSITY RATINGS PER ASTM E84 ARE 20 AND 130, RESPECTIVELY, FOR THE CORE MATERIAL. THE SELF-IGNITION TEMPERATURE OF THE FOAM PER ASTM D-1261 IS 450 F. SURFACE BURNING CHARACTERISTICS OF THE FINISHED BUILDING UNIT SHALL NOT EXCEED 75 FOR FLAME SPREAD AND 450 FOR SMOKE DEVELOPED, RESPECTIVELY.

- PROVIDE AUTOMATIC DOOR CLOSERS THAT FIRMLY CLOSE ALL WALK-IN DOORS THAT HAVE BEEN CLOSED TO WITHIN ONE INCH OF FULL CLOSURE, EXCEPT THAT THIS SUBPARAGRAPH SHALL NOT APPLY TO DOORS WIDER THAN THREE FEET NINE INCHES OR TALLER THAN SEVEN FEET;
- PROVIDE STRIP DOORS, SPRING HINGED DOORS, OR OTHER METHOD OF MINIMIZING INFILTRATION WHEN DOORS ARE OPEN;
- CONTAIN WALL, CEILING, AND DOOR INSULATION OF AT LEAST R-25 FOR COOLERS AND R-32 FOR FREEZERS, EXCEPT THAT THIS SUBPARAGRAPH SHALL NOT APPLY TO GLAZED PORTIONS OF DOORS NOR TO STRUCTURAL MEMBERS;
- CONTAIN FLOOR INSULATION OF AT LEAST R-28 FOR FREEZERS;
- FOR EVAPORATOR FAN MOTORS OF UNDER ONE HORSEPOWER AND LESS THAN 460 VOLTS, USE:
 - ELECTRONICALLY COMMUTATED MOTORS (BRUSHLESS DIRECT CURRENT MOTORS); OR
 - 3-PHASE MOTORS;
- FOR CONDENSER FAN MOTORS OF UNDER ONE HORSEPOWER, USE:
 - ELECTRONICALLY COMMUTATED MOTORS;
 - PERMANENT SPLIT CAPACITOR-TYPE MOTORS; OR
 - 3-PHASE MOTORS; AND
- FOR ALL INTERIOR LIGHTS, USE LIGHT SOURCES WITH AN EFFICACY OF 40 LUMENS PER WATT (LPW) OR MORE, INCLUDING BALLAST LOSSES (IF ANY), EXCEPT THAT LIGHT SOURCES WITH AN EFFICACY OF 40 LUMENS PER WATT (LPW) OR MORE, INCLUDING BALLAST LOSSES (IF ANY), MAY BE USED IN CONJUNCTION WITH A TIMER OR DEVICE THAT TURNS OFF THE LIGHTS WITHIN 15 MINUTES OF WHEN THE WALK-IN COOLER OR WALK-IN FREEZER IS NOT OCCUPIED BY PEOPLE.


- GRANITE COUNTER/TABEL TOPS : ALL PRODUCT TO BE SLAB W/ SURFACE ROUND EDGE DETAIL AND CONSISTANT / SMALL PARTICULATE AND POLISHED FINISH.
- ALL SURFACES IN KITCHEN, SERVICE, AT BEVERAGE COUNTER AND RESTROOMS SHAL MEET 70% LIGHT REFLECTIVE VALE (LRV) OR GREATER.
- QUARRY TILE : DAL TILE G42 ARID GRAY, SMOOTH FINISH
- BASE TILE : 6" HT. MIN. WITH 3/8" RADIUS
- THE WALK-IN COOLER AND FREEZER'S METAL FLOORS ARE SMOOTH. DIAMOND PLATE FLOOR IS NOT APPROVED IN THE COOLER
- ALL GYPSUMBOARD SHALL BE SMOOTH FINISH AT WALL AND CEILING

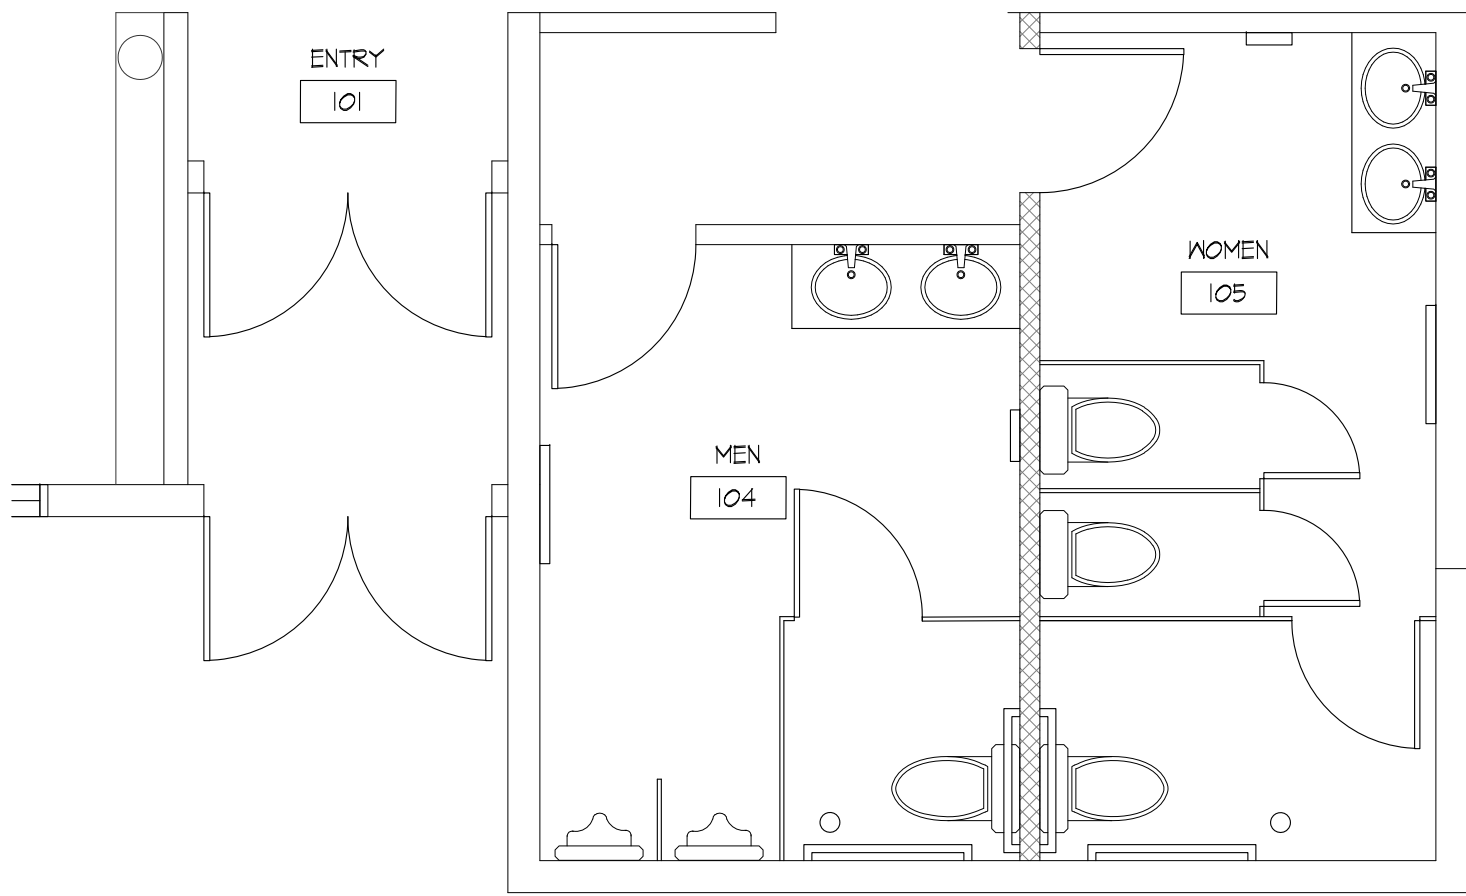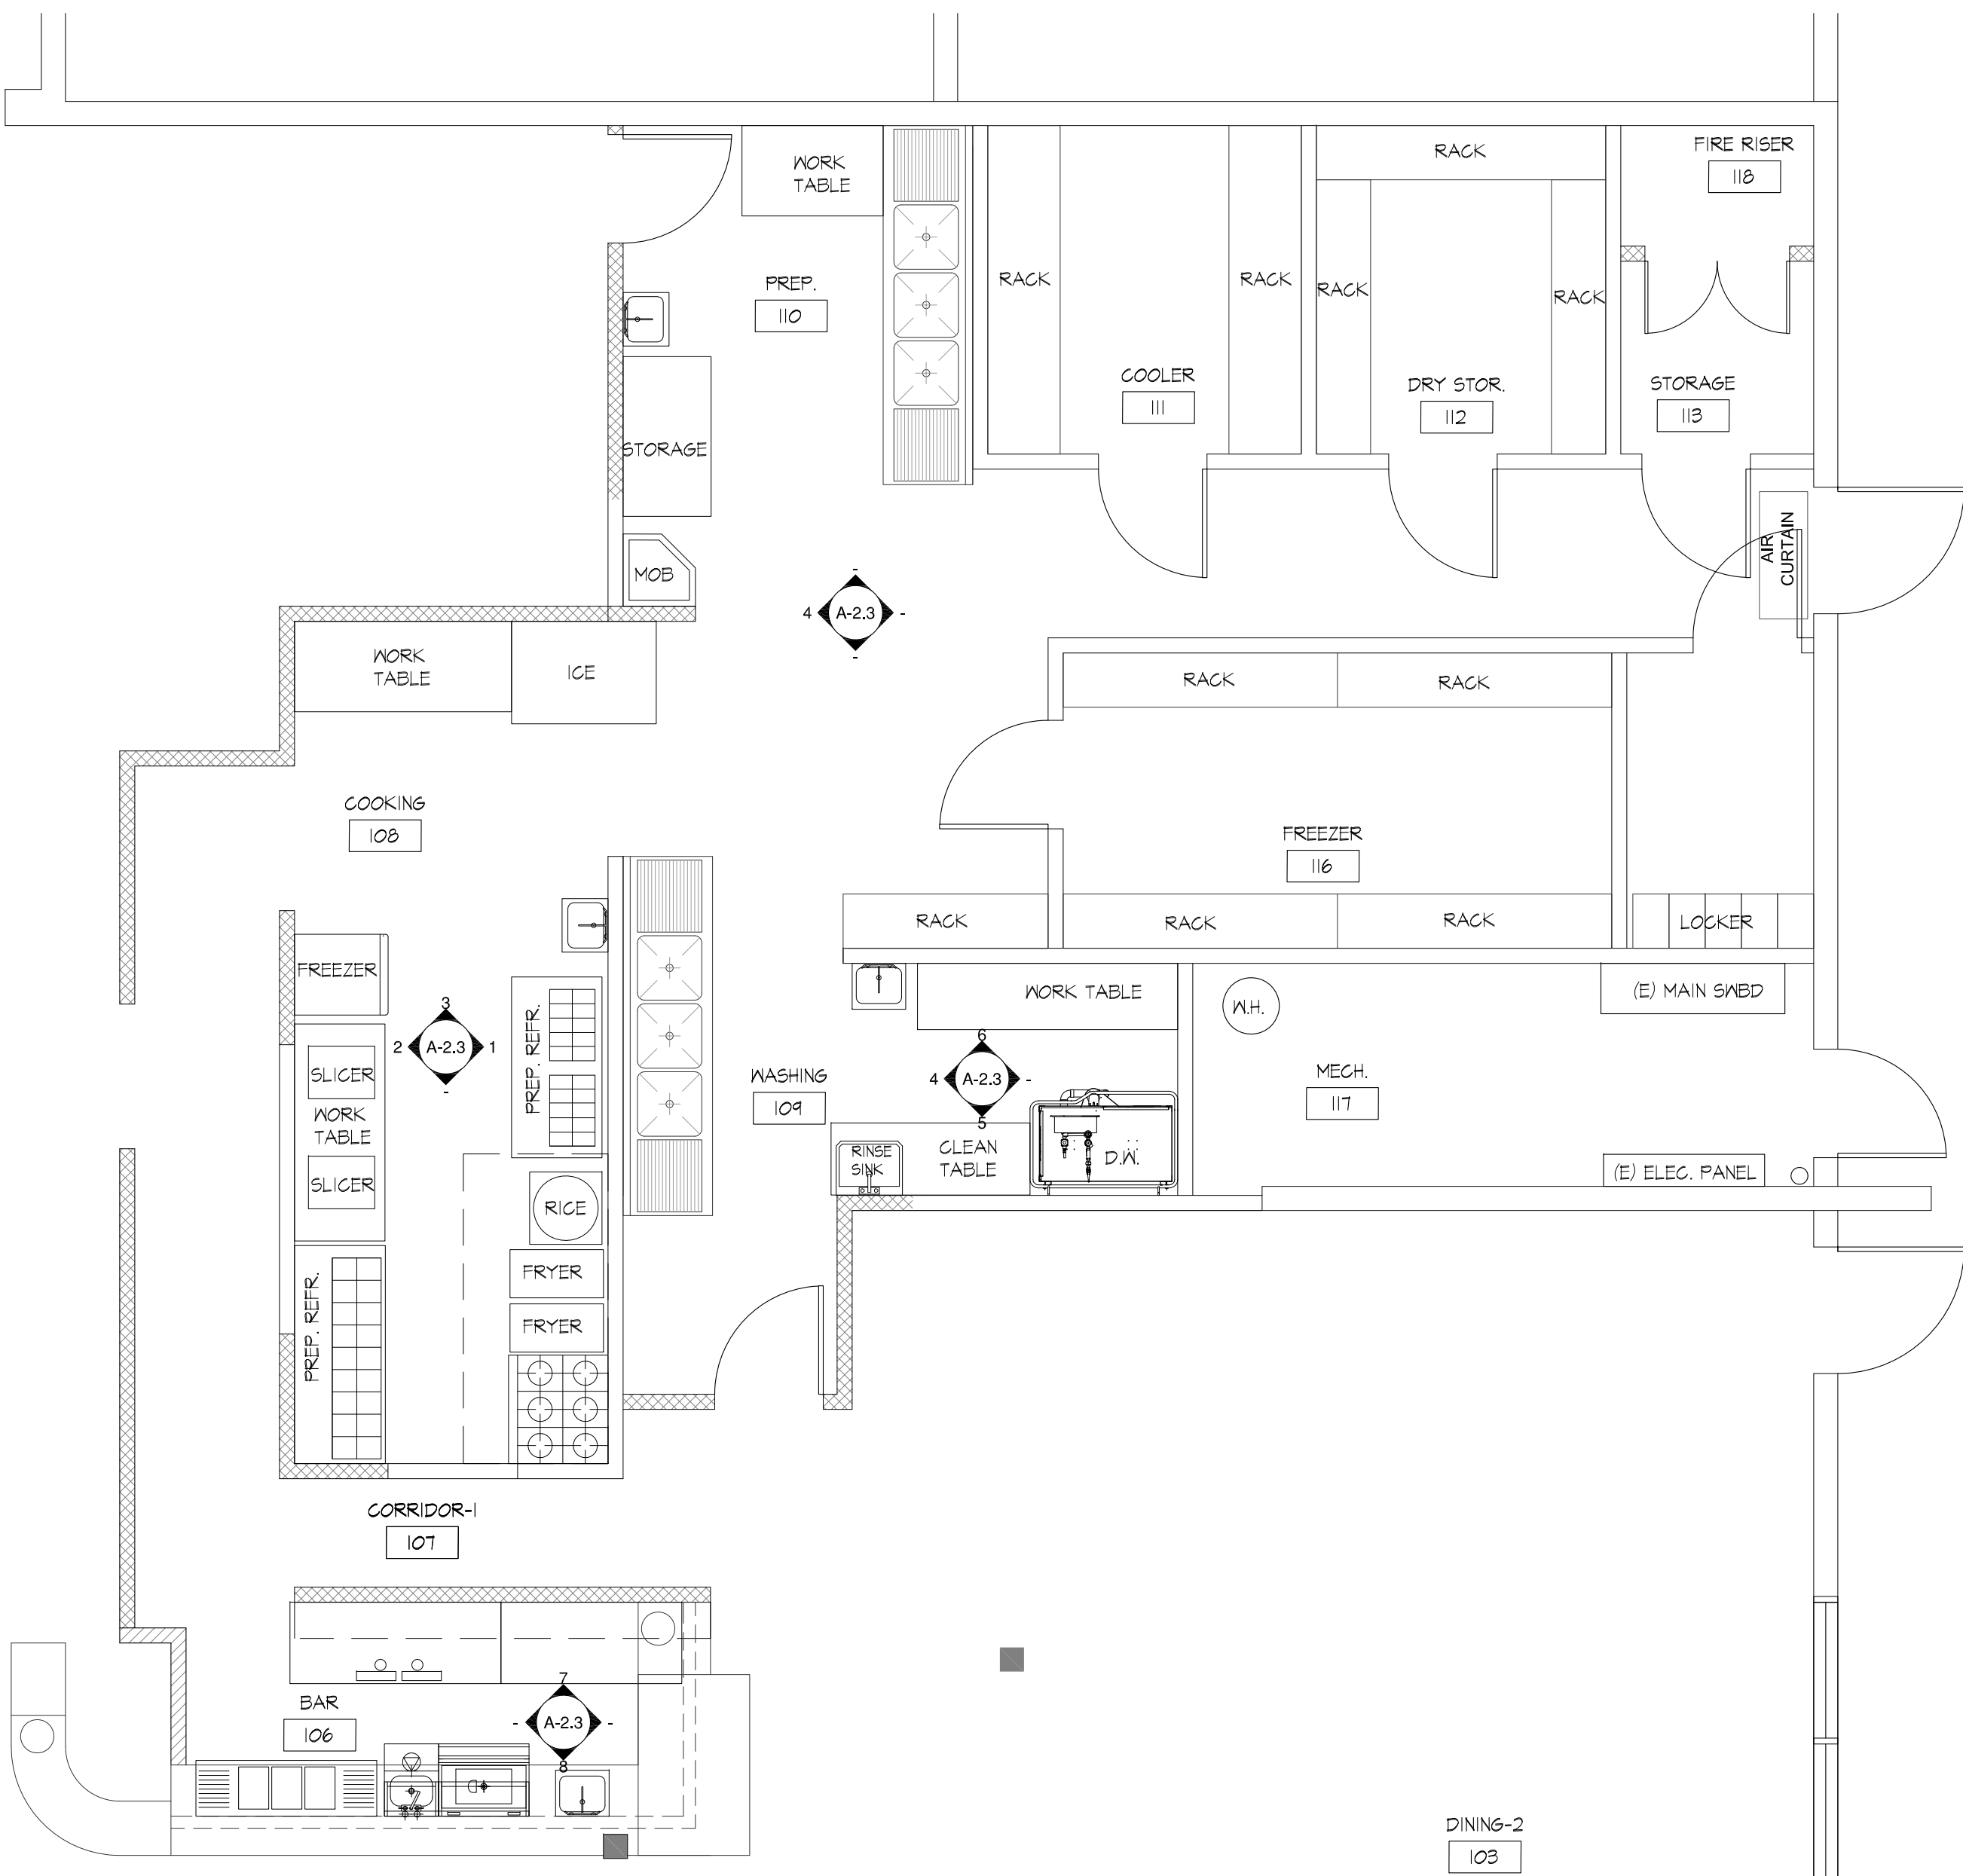

ENLARGED KITCHEN AND BAR FLOOR PLAN

Scale: 1/4" = 1'-0"

WOU
DESIGN PARTNERS
3470 WILSHIRE BLVD, SUITE 930
LOS ANGELES, CA 90010
• ARCHITECTURE BRANDING
• INTERIOR BRANDING
• PLANNING
• LAND-USE CONSULTATION

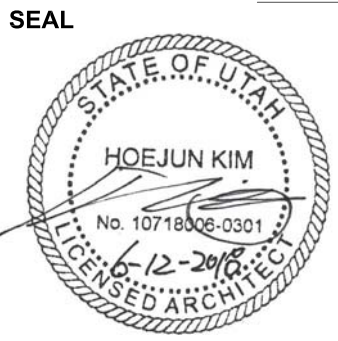

TITLE

Korean BBQ of Utah
7157 S. State Street
Midvale, Utah, 84047

REVISIONS

- △ CORRECTION SWMRF 4-19-18
- △ CORRECTION BLDG. 4-26-18

NO. ISSUE DATE

PROJECT DATA

PROJECT NUMBER :
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SCALE


SHEET NAME

**DOOR/ ROOM
FINISH
SCHEDULE &
KITCHEN FLOOR
PLAN**


SHEET NUMBER

A-2.1

EQUIPMENT SCHEDULE															(B), PLAN DESIGNATION	
	EQUIP. NO.	NEW/ EXIST.	DESCRIPTION	MANUF.R	MODEL NO.	FIN.	ELECTRICAL			WATER		WASTE	GAS	SIZE (IN INCHES) (XHD XH)	NOTES	
							VOLT.	PH.	LOAD	HN	CN	DIR/INDR	AMOUNT			
BAR	B 1	NEW	BEER DISPENSER	BLUEAIR	BDD61-3		115V		6.3 AMPS				F.S.	60x21x31	SELF CONTAINED , INDIRECT TO FLOOR SINK	
	B 2	NEW	BACK BAR COOLER	BLUEAIR	BBB54-256		115V		6.3 AMPS					60X28X31	SELF CONTAINED	
	B 3	NEW	BAR 3 COMP. SINK	KROWNE	18-53C					1/2"	1/2"	1"	F.S.	60X18.5X34	W/ 12" DRAIN BD. BOTH SIDE W/ RIGHT END SIDE SPLASH, INDIRECT TO F.S.	
	B 4	NEW	BAR WORKSTATIONS	KROWNE	18-W48L-10					1/2"	1/2"			48x24x36.5	WITH DUMP SINK, INDIRECT TO FLOOR SINK	
	B 5	NEW	HAND SINK	BLUEAIR	B5H-14					1/2"	1/2"	2"		17X15X14	WITH SOAP AND TOWEL DISP., DROP IN SINK	
KITCHEN	K 1	NEW	HAND SINK	BLUEAIR	B5H-14					1/2"	1/2"	2"		17X15X14	WITH SOAP AND TOWEL DISP., DROP IN SINK	
	K 2	NEW	PREP REFRIGERATOR	BLUEAIR	BLMT 60		115V		5.5 AMPS					60X33X44	SELF CONTAINED	
	K 3	NEW	RICE COOKER	RINNAI	RER-55A5								35K	24x19x17	WITH EQ. STAND, 1/2" NPT FEMALE GAS CONNECTION	
	K 4	NEW	RICE COOKER STAND	GSN	ES-RC3024									24X30X29	W/ SLIDING SHELF	
	K 5	NEW	FRYER	AMERICAN RANGE	AF-35/50								35K	16X30X46		
	K 6	NEW	BURNER	AMERICAN RANGE	ARHP-36-6								56K	36X30X10		
	K 7	NEW	PREP REFRIGERATOR	BLUEAIR	BLMT T2		115V		6 AMPS					12X33X44	SELF CONTAINED	
	K 8	NEW	WORK TABLE	THUNDER GROUP	SLMT43072F4									12X30X35	ST. STL	
	K 9	NEW	MEAT SLICER	HOBART	H56		120V		5.4 AMPS					22X21X25		
	K 10	NEW	FREEZER	BLUEAIR	B5F23T		115V		8 AMPS					21X31X32	SELF CONTAINED	
	K 11	NEW	WORK TABLE	THUNDER GROUP	SLMT43072F4									12X30X35	ST. STL	
	K 12	NEW	ICE MACHINE	MANITOWOC	I-1800		220V		30 AMPS	1/2"	1/2"		F.S.	48X34X30	REMOTE	
	K 13	NEW	3 COMP. SINK	BLUEAIR	B63-24-14/20					1/2"	1/2"	1"	F.S.	120X30X44.5	W/ 2 DRAIN BD. BOTH SIDE W/ RIGHT END SIDE SPLASH, INDIRECT TO F.S.	
	K 14	NEW	DISH WASHER	AUTO-CHLOR	D2C L CORNER		115V		20 AMPS	1/2"	1/2"	2"	F.S.	44X20X16	LEFT CORNER MODEL	
	K 15	NEW	SOILED TABLE							3/4	3/4		F.S.	60X30X44	W/ RINSE SINK AND SPRAY FAUCET	
	K 16	NEW	WORK TABLE	THUNDER GROUP	SLMT42484F4									84X24X35	ST. STL	
	K 17	NEW	WORK TABLE	THUNDER GROUP	SLMT43036F									36X30X35	ST. STL	
	K 18	NEW	18" STORAGE SHELVING	WINGO	VEX-18XX									11X18X91	SEE PLAN FOR LENGTH	
	K 19	NEW	MOB SINK							1/2"	1/2"		F.S.			
	K 20	NEW	LOCKER	KELMAX	EL/5/15									12X15X66	WITH 6" LEGS	
	K 21	NEW	HOOD											8'-6"(W)x4'(D)		
	K 22	NEW	AIR CURTAIN	CURTRON	AIR-PRO 48"		120V								48"	
	K 23	EXIST.	WATER HEATER													
	K 24	NEW	P.O.S.													

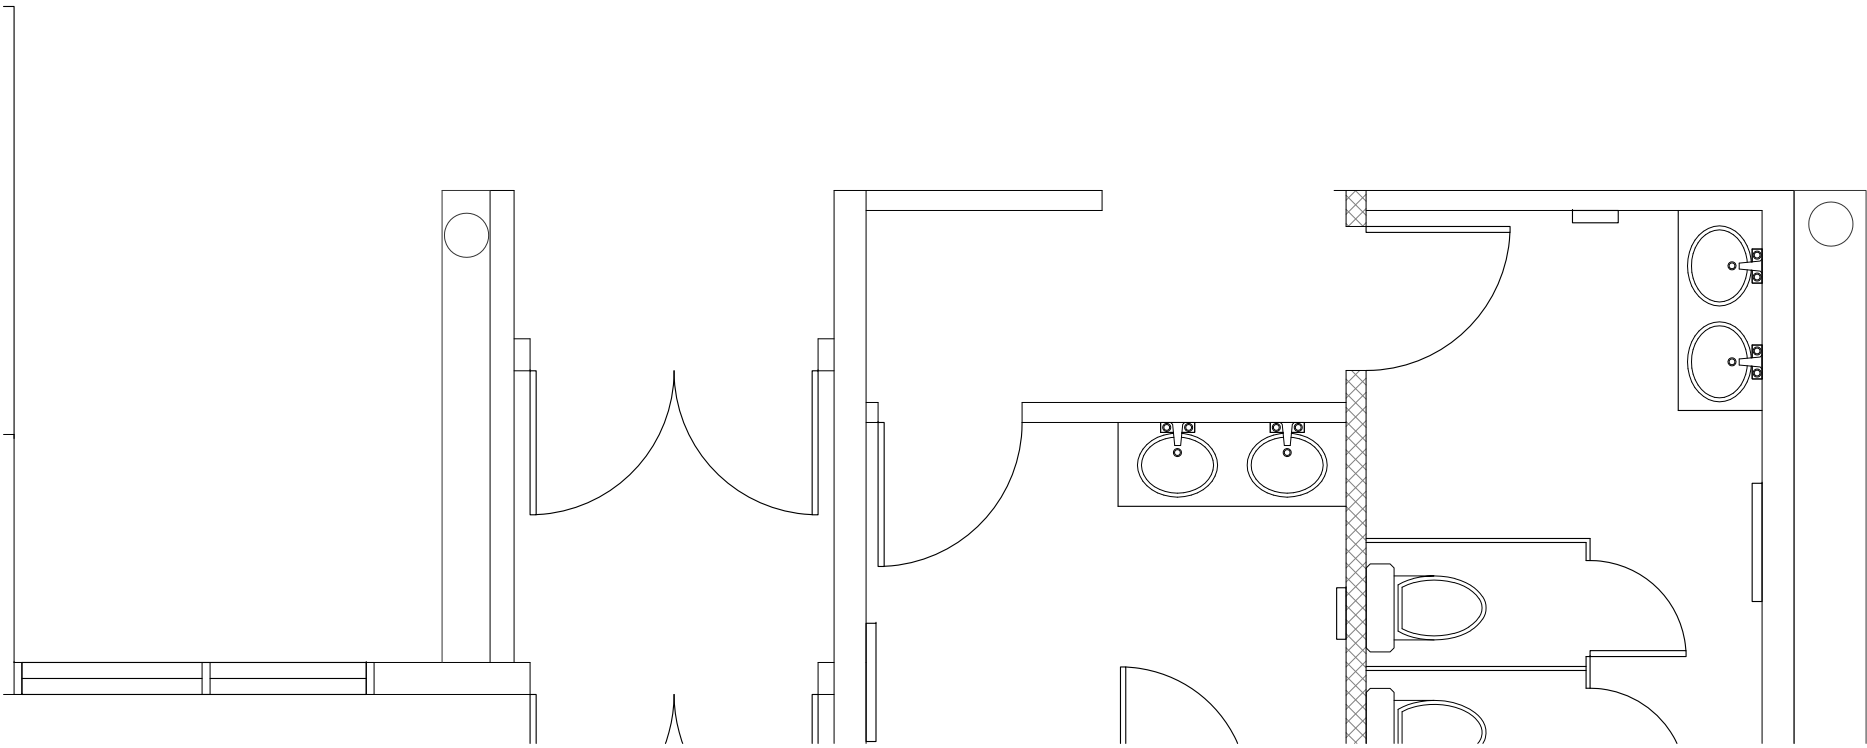


1 KITCHEN AND BAR EQUIPMENT PLAN
Scale: 1/4" = 1'-0"

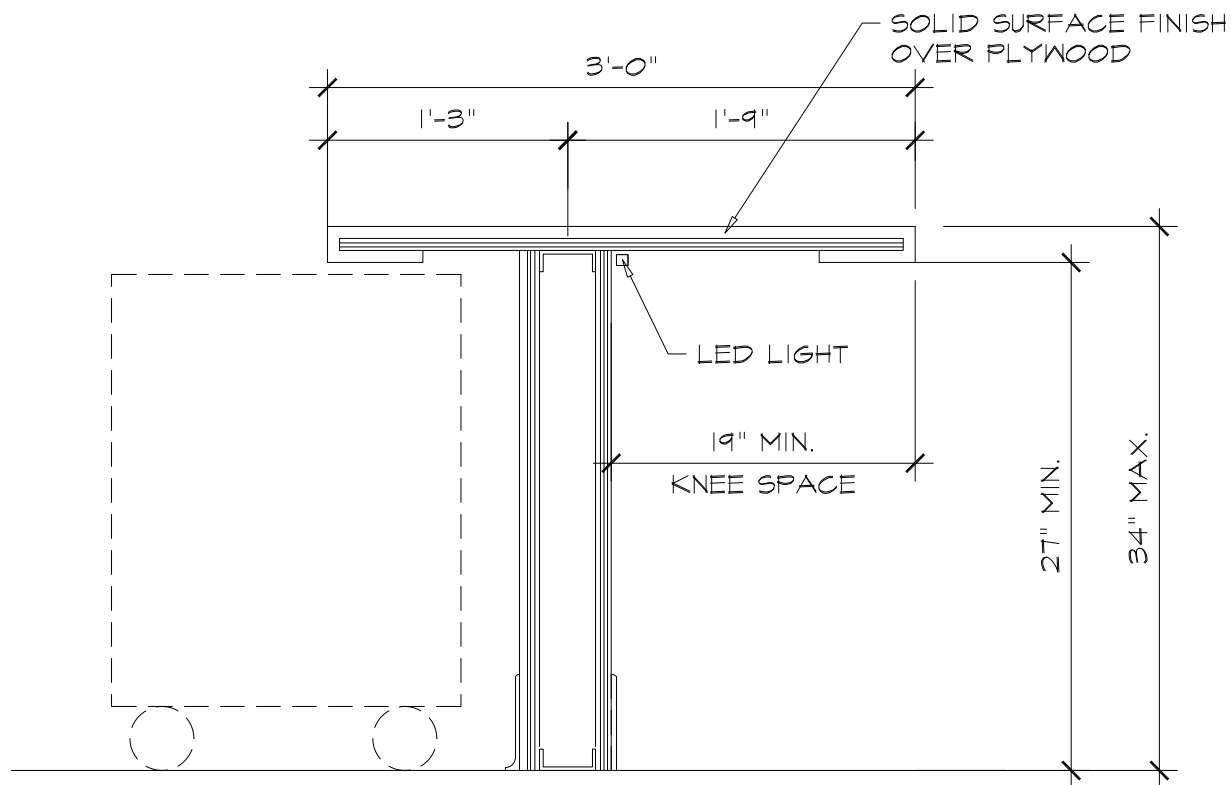

BAR COUNTER SECTION (ACCESSIBLE)

SCALE
1" = 1'-0"


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KITCHEN ELEVATION

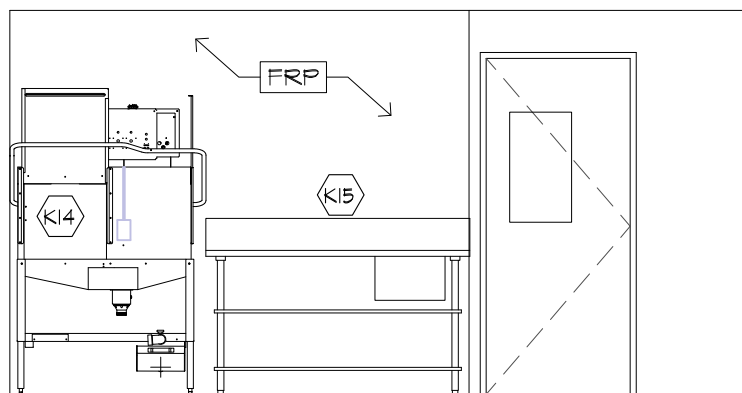SCALE
1/4" = 1'-0"


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KITCHEN ELEVATION

SCALE
1/4" = 1'-0"


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BAR COUNTER SECTION

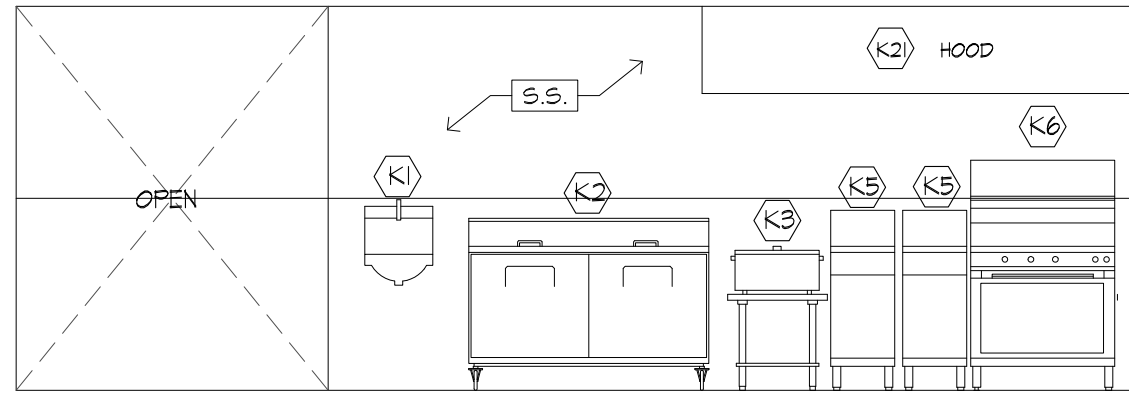SCALE
1" = 1'-0"


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KITCHEN ELEVATION
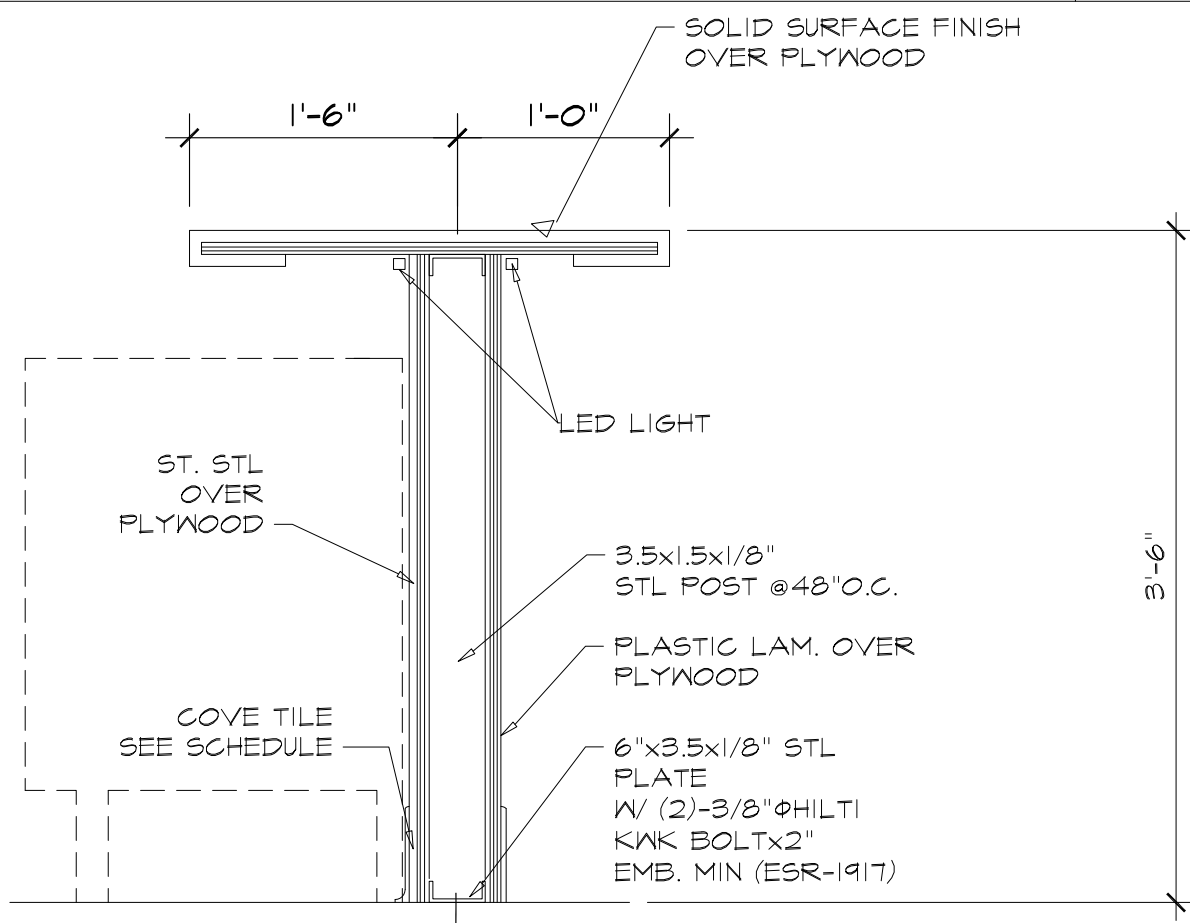
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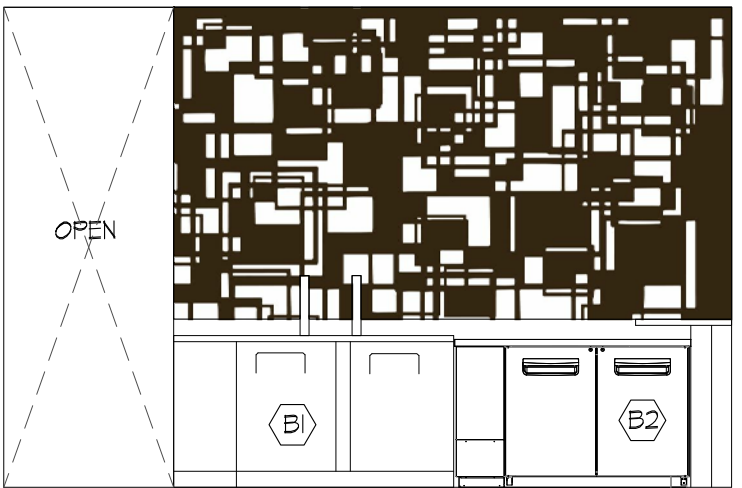
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KITCHEN ELEVATION

SCALE
1/4" = 1'-0"

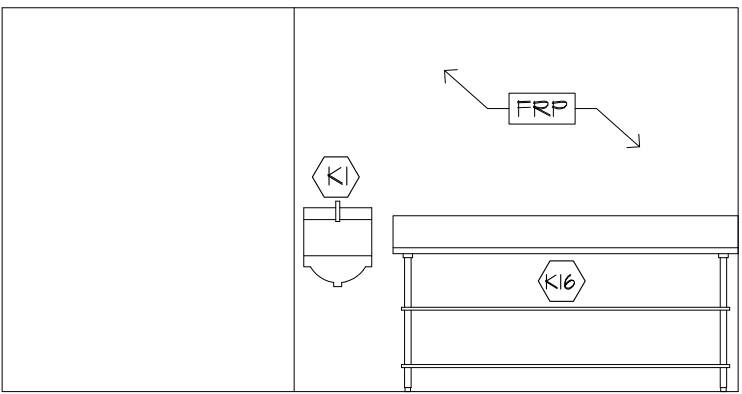
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BAR ELEVATION

SCALE
1/4" = 1'-0"

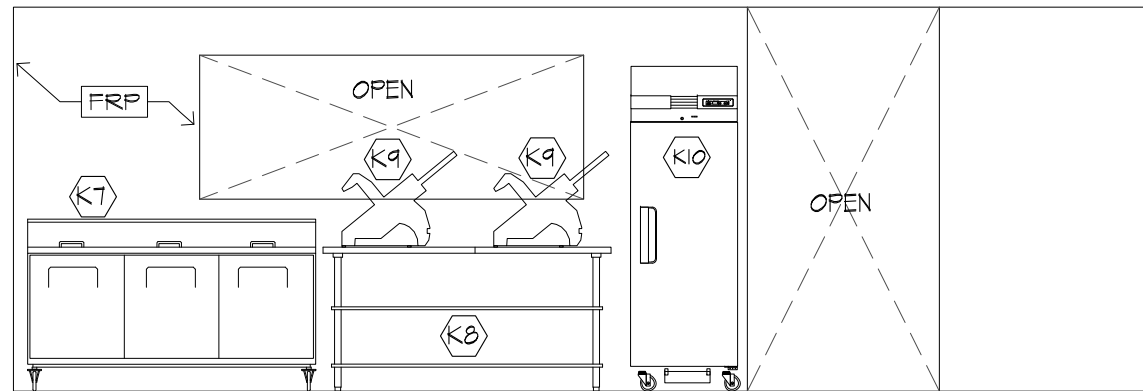
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KITCHEN ELEVATION

SCALE
1/4" = 1'-0"


3

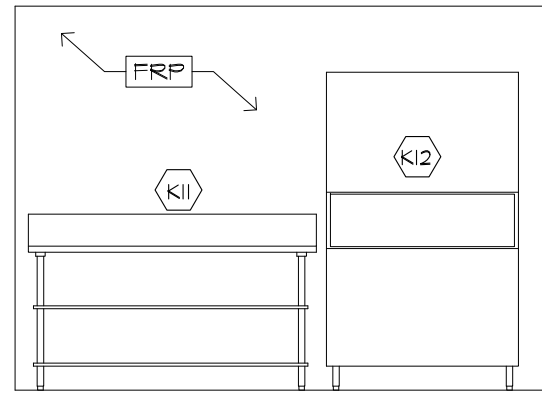

BAR ELEVATION

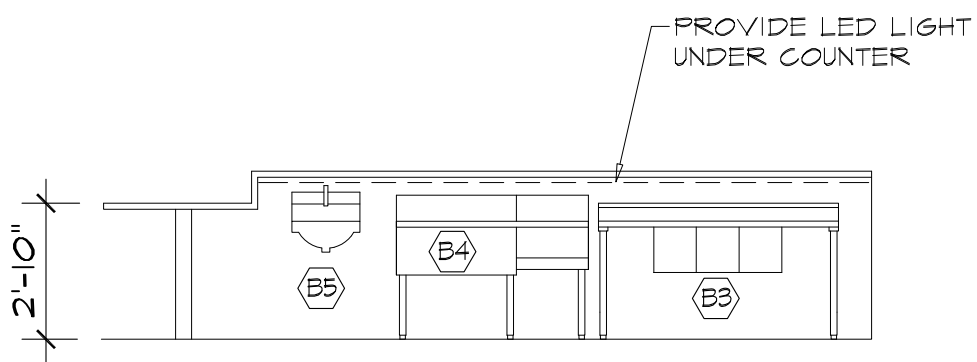SCALE
1/4" = 1'-0"

8

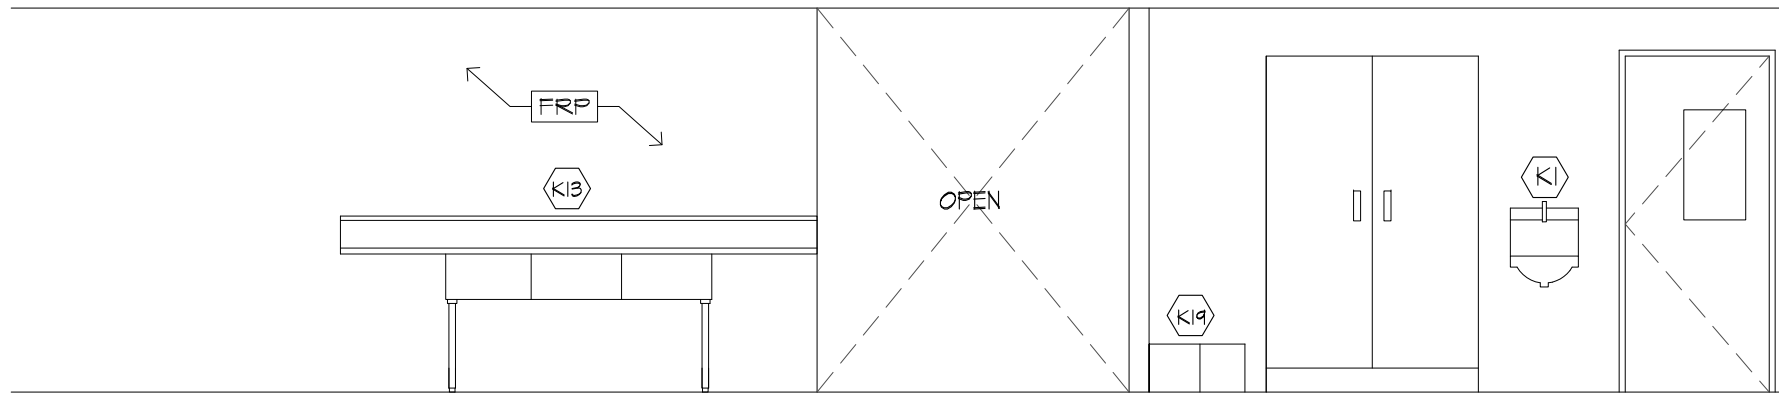

KITCHEN ELEVATION

SCALE
1/4" = 1'-0"

4

SEAL



TITLE

Korean BBQ of Utah
7157 S. State Street
Midvale, Utah, 84047

REVISIONS

- △ CORRECTION SWRF 4-19-18
- △ CORRECTION BLDG. 4-26-18

NO. ISSUE DATE

PROJECT DATA

PROJECT NUMBER :
DATE :
DRAWN BY :
CHECKED BY :
APPROVED BY :













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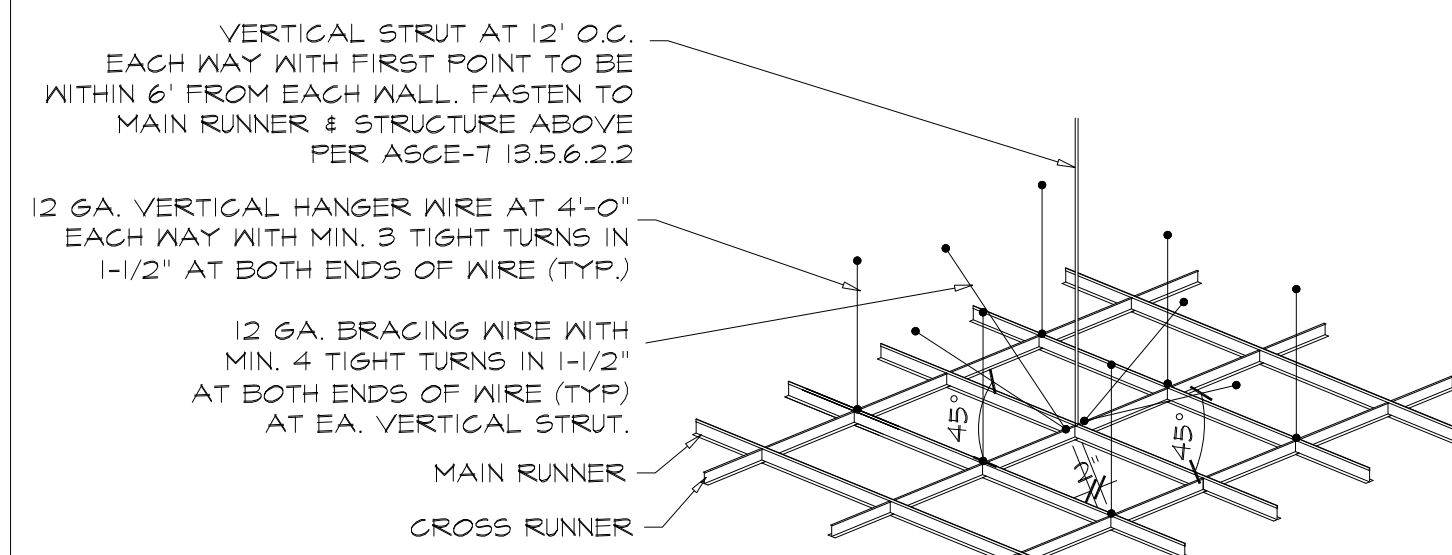
SHEET NAME

**KITCHEN
ELEVATIONS
CNTR. SECTIONS**

SHEET NUMBER

A-2.3



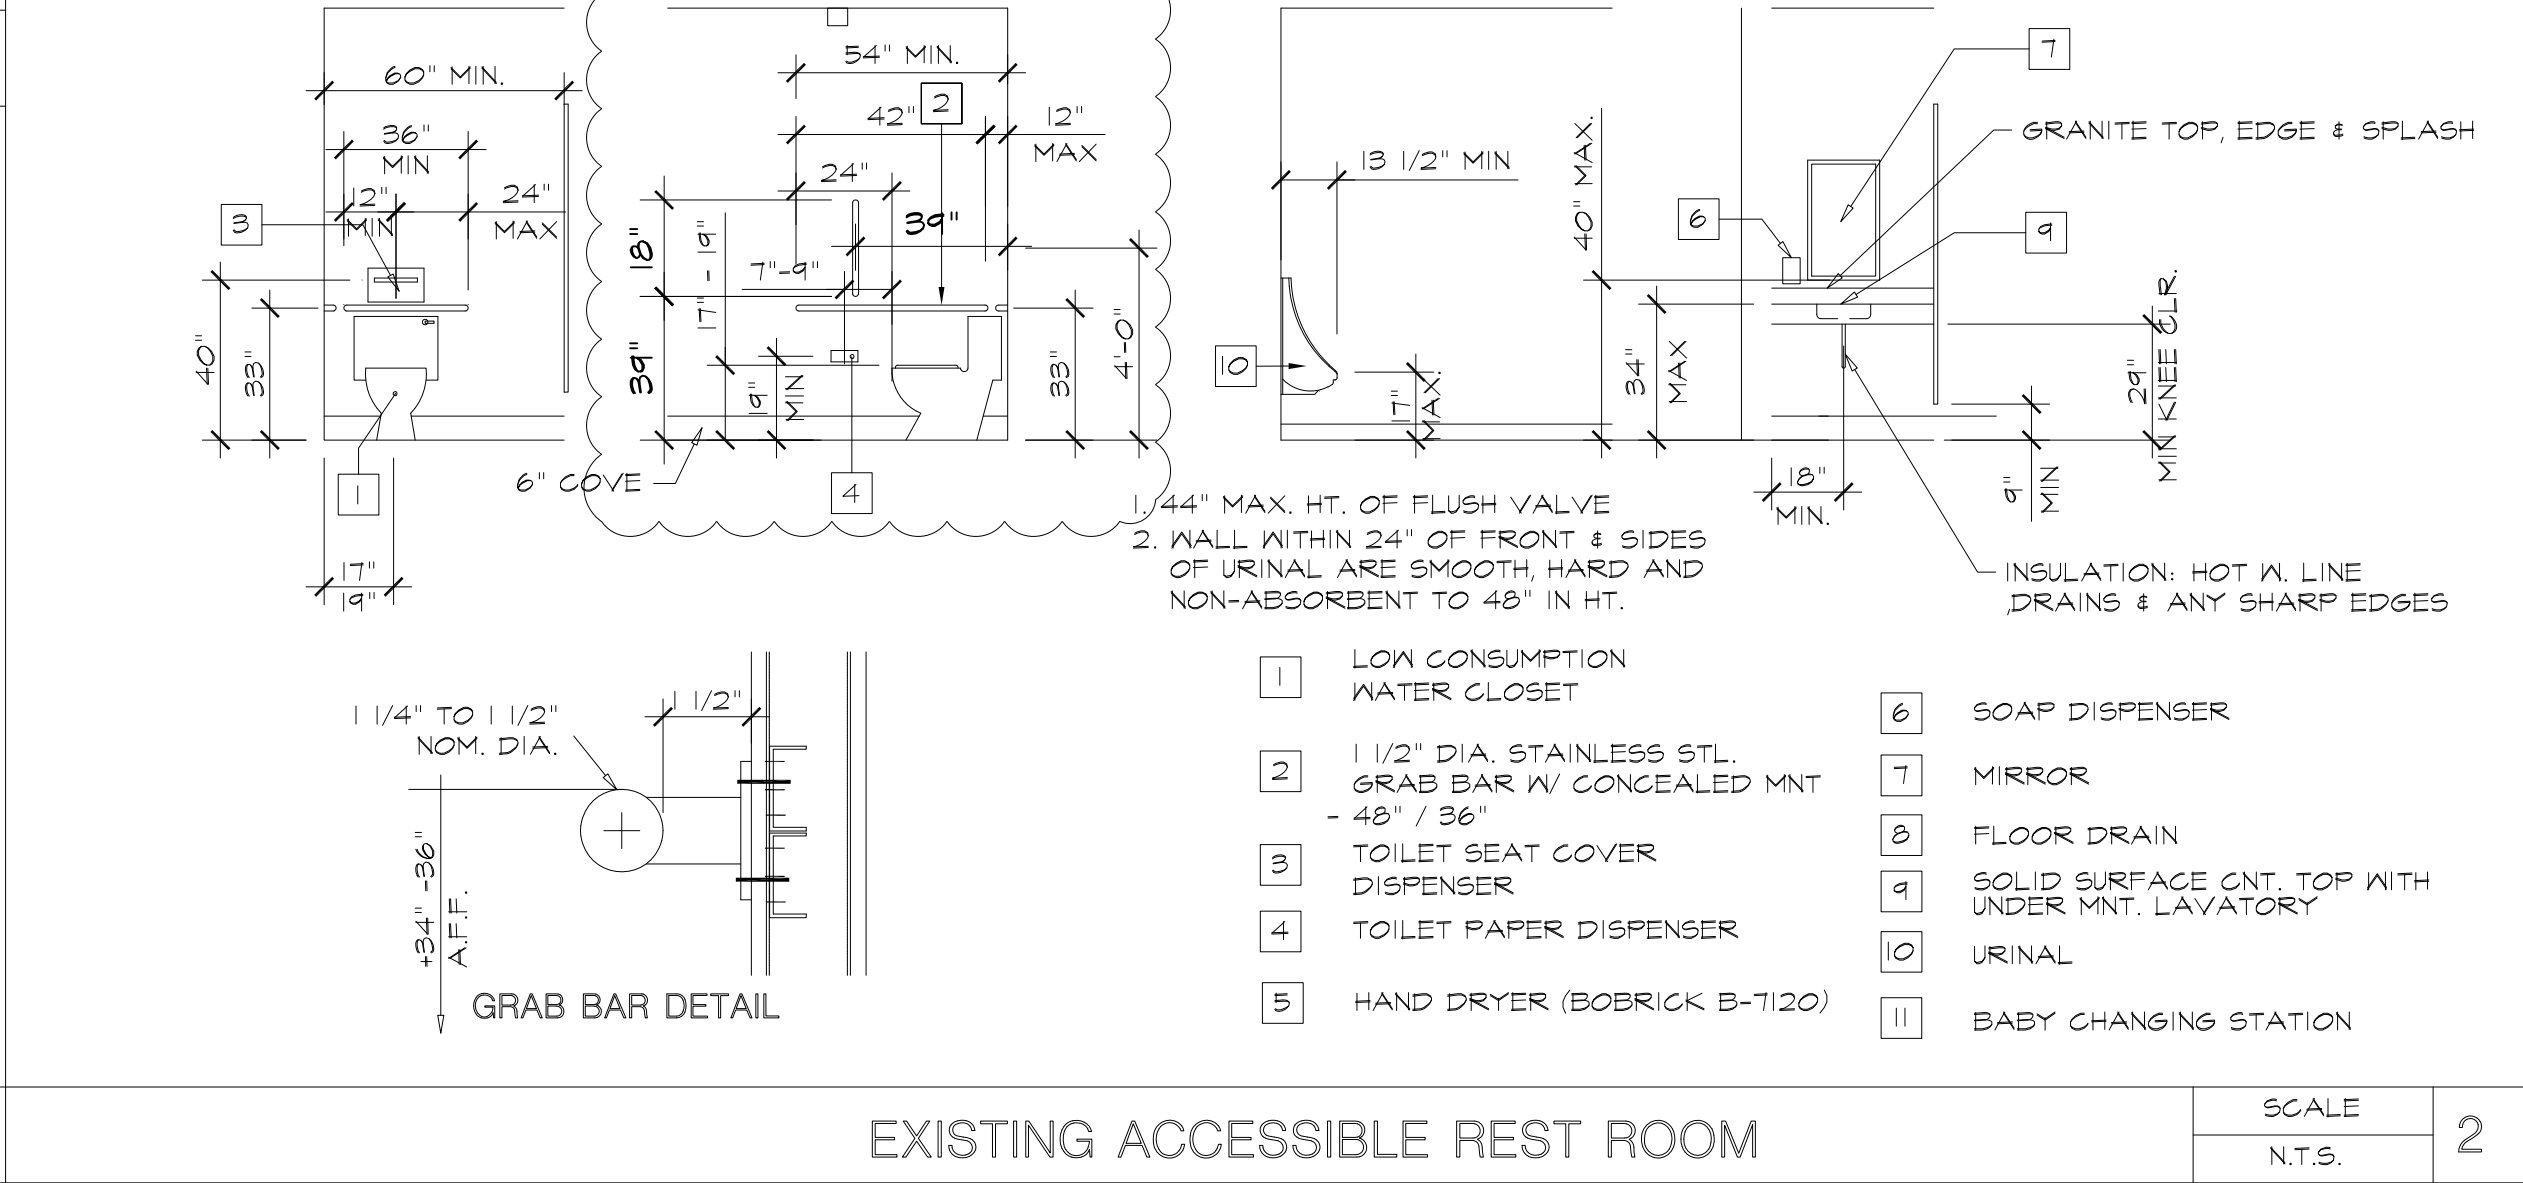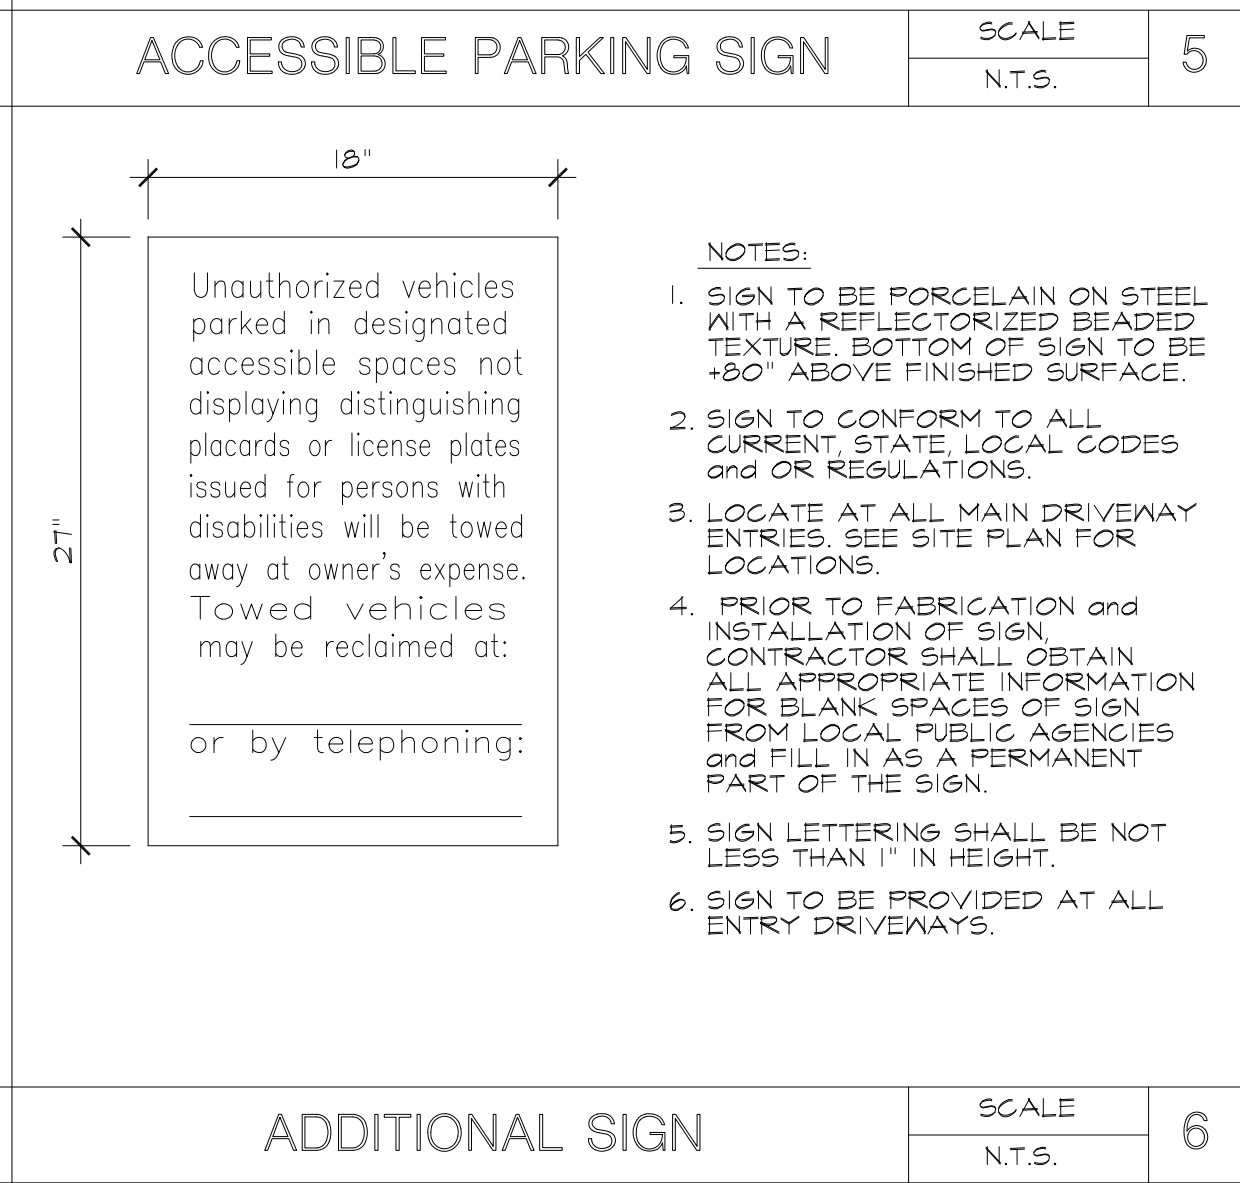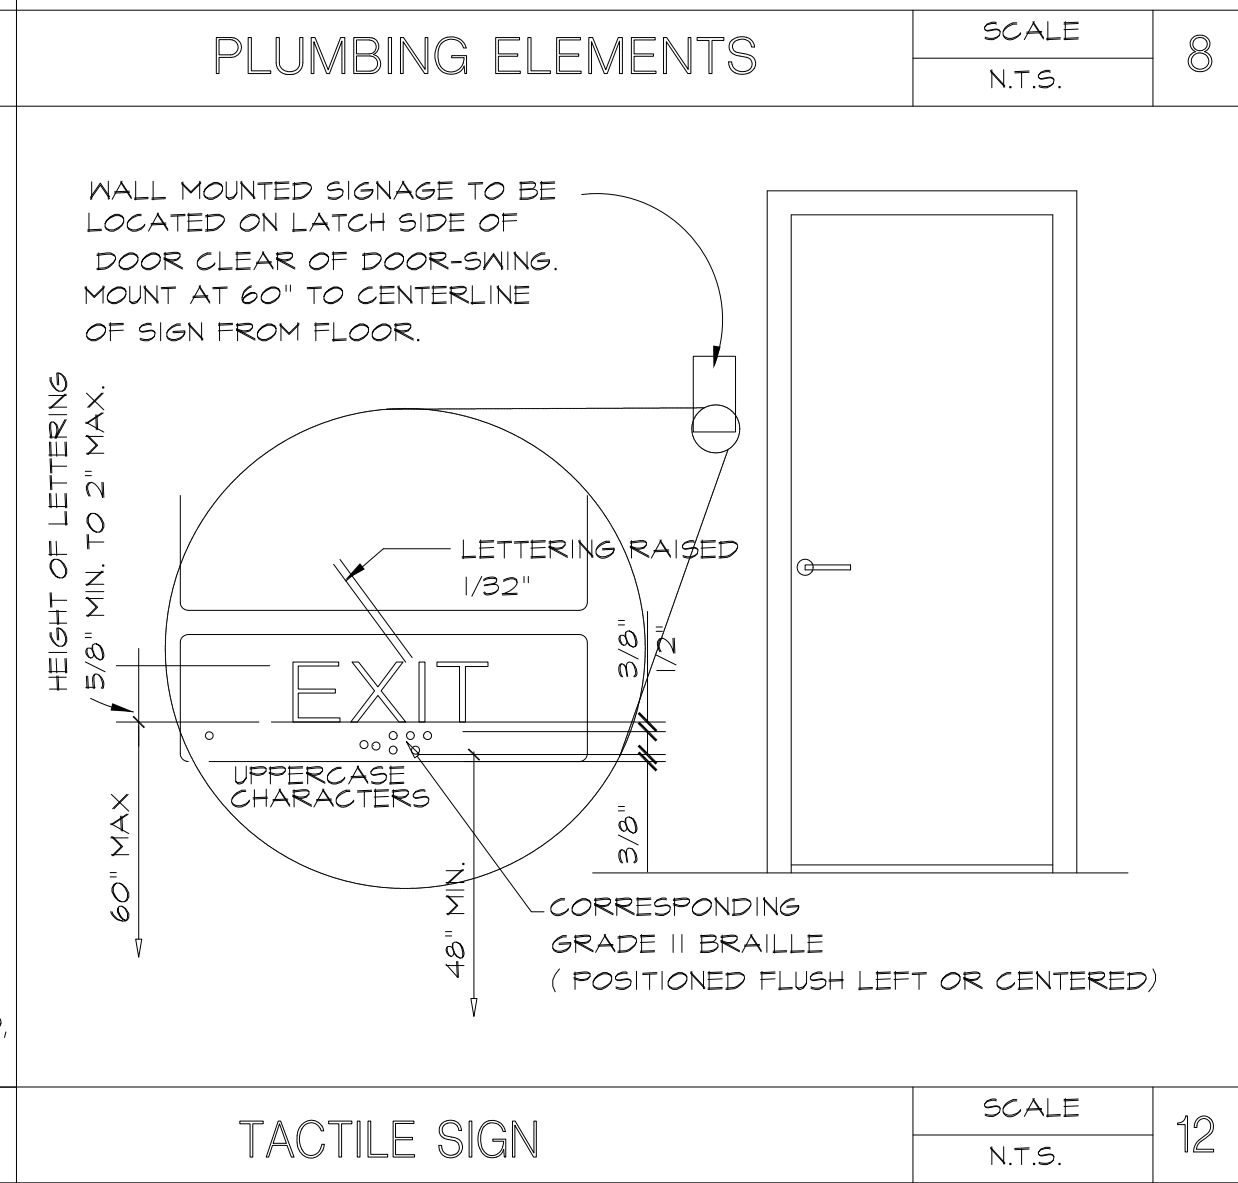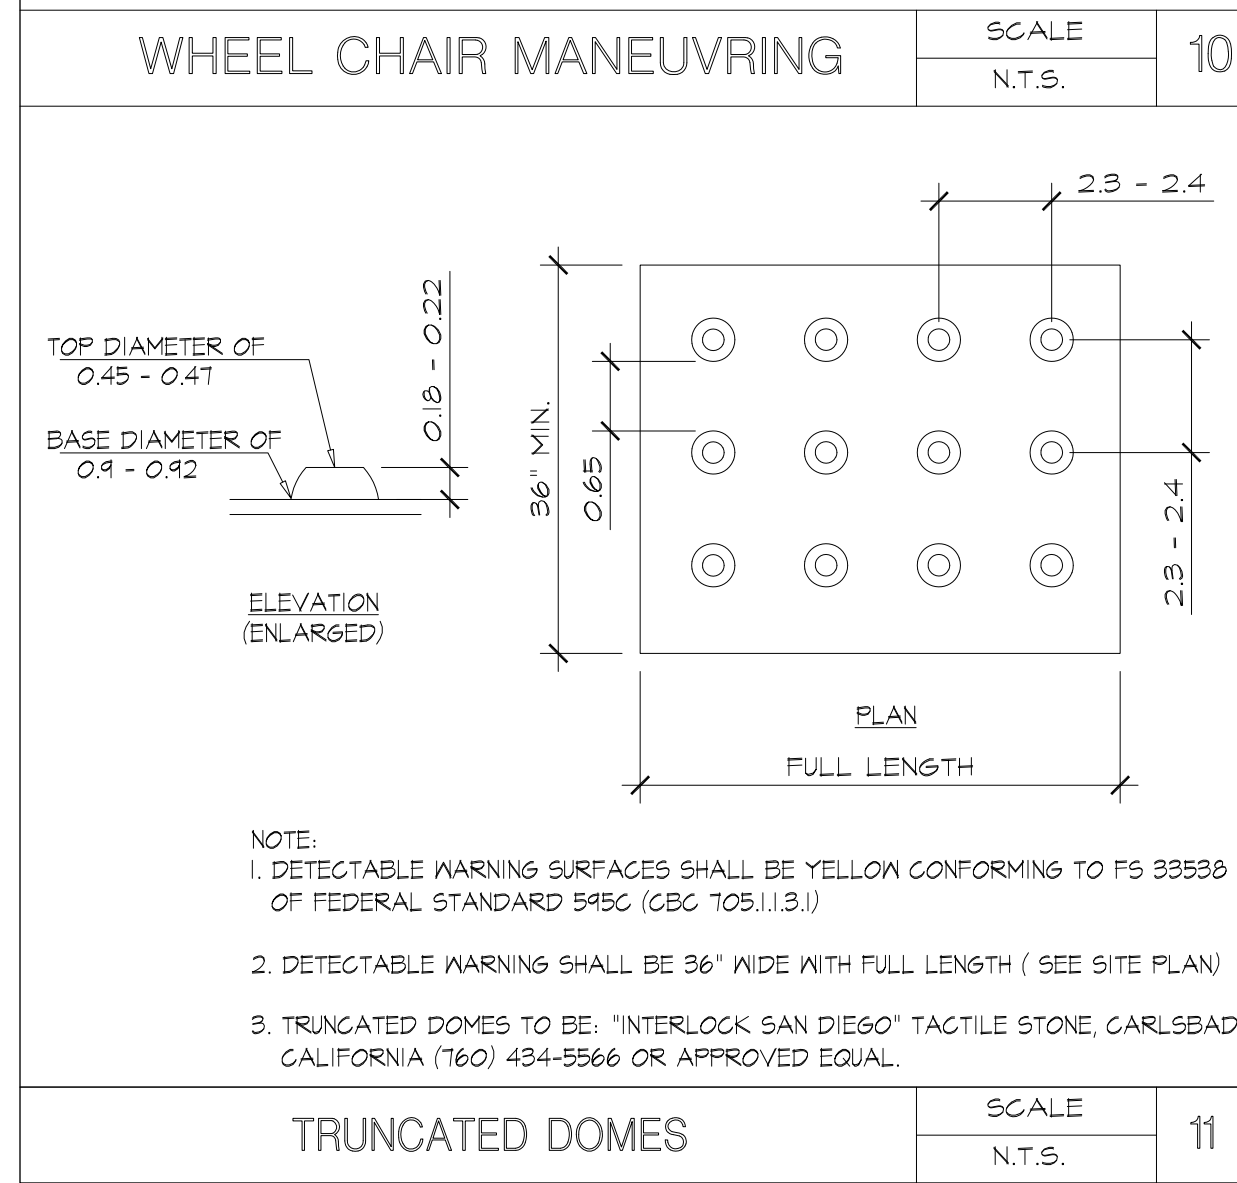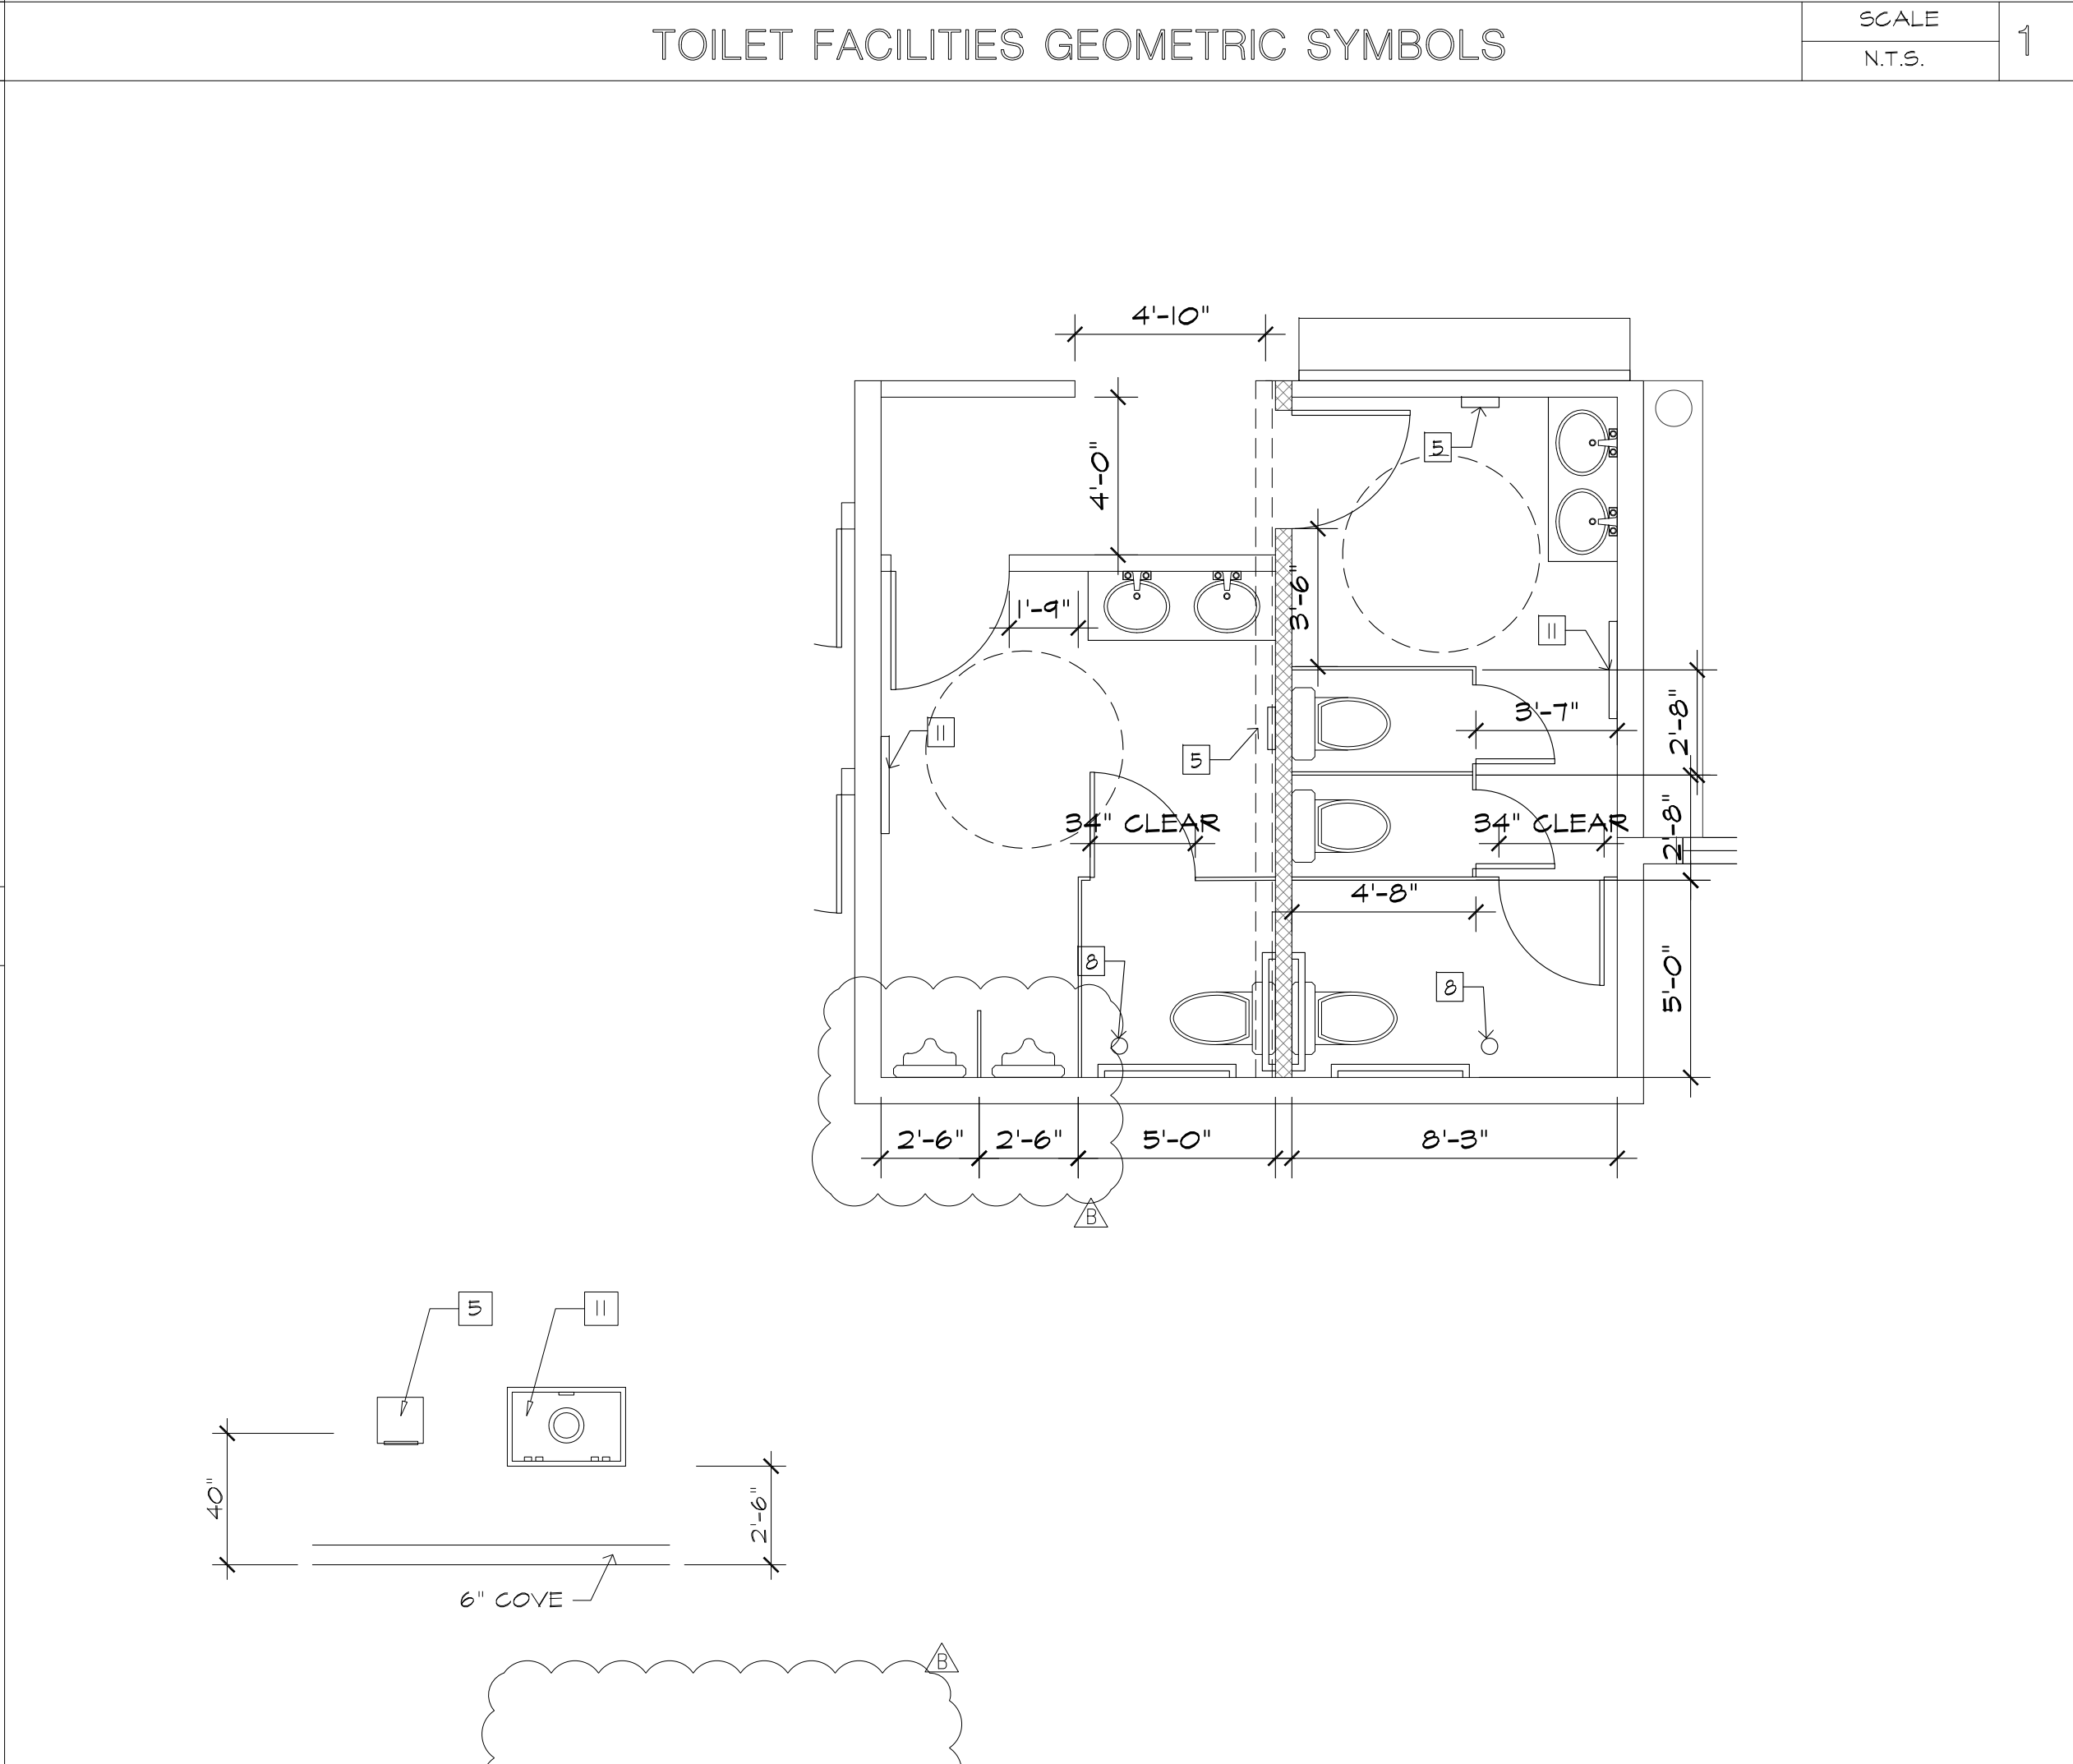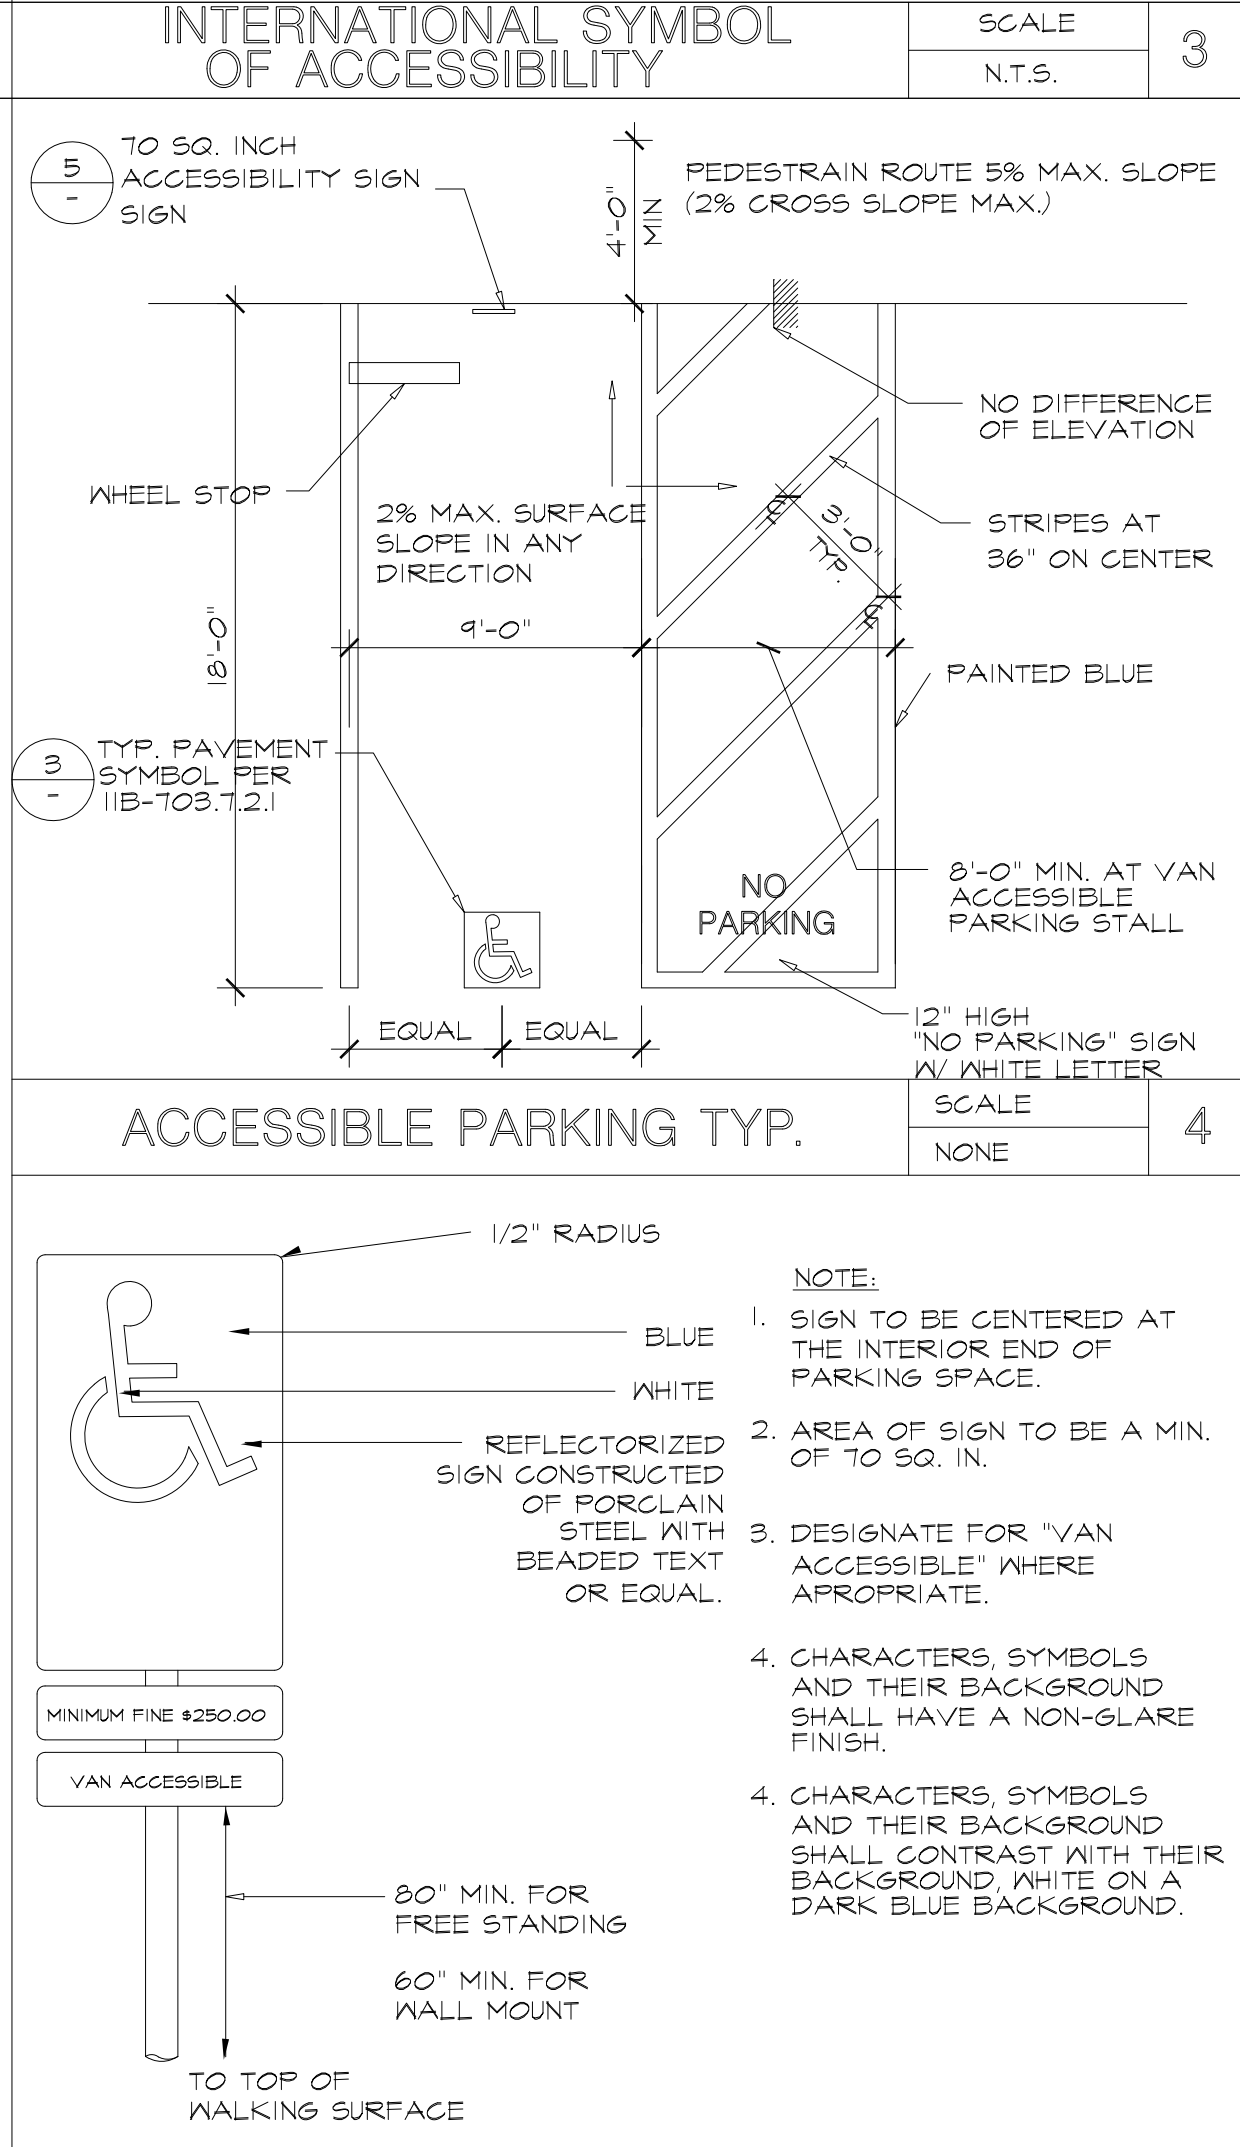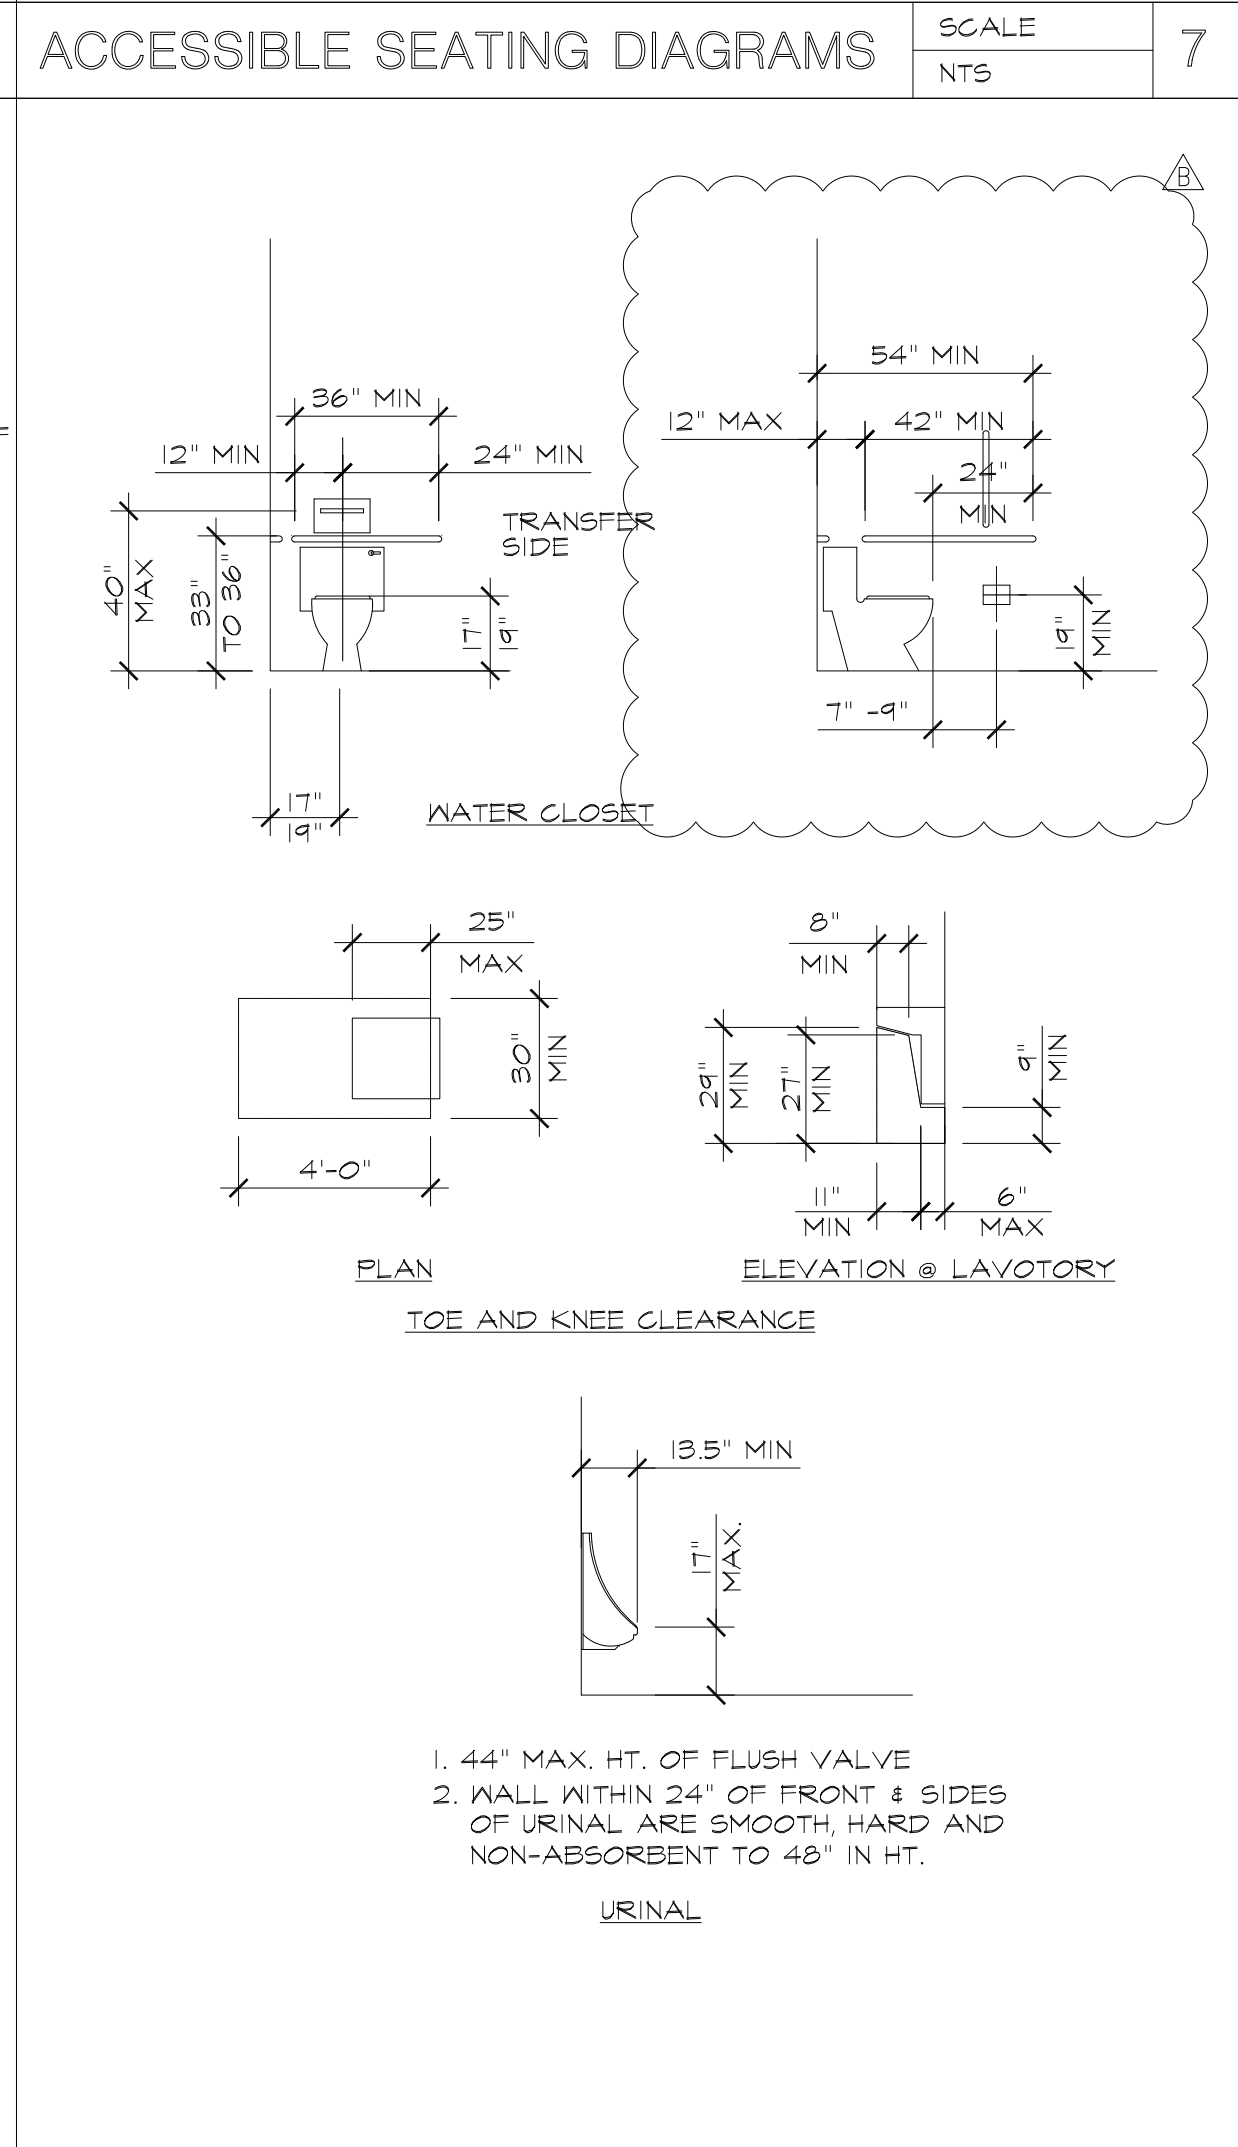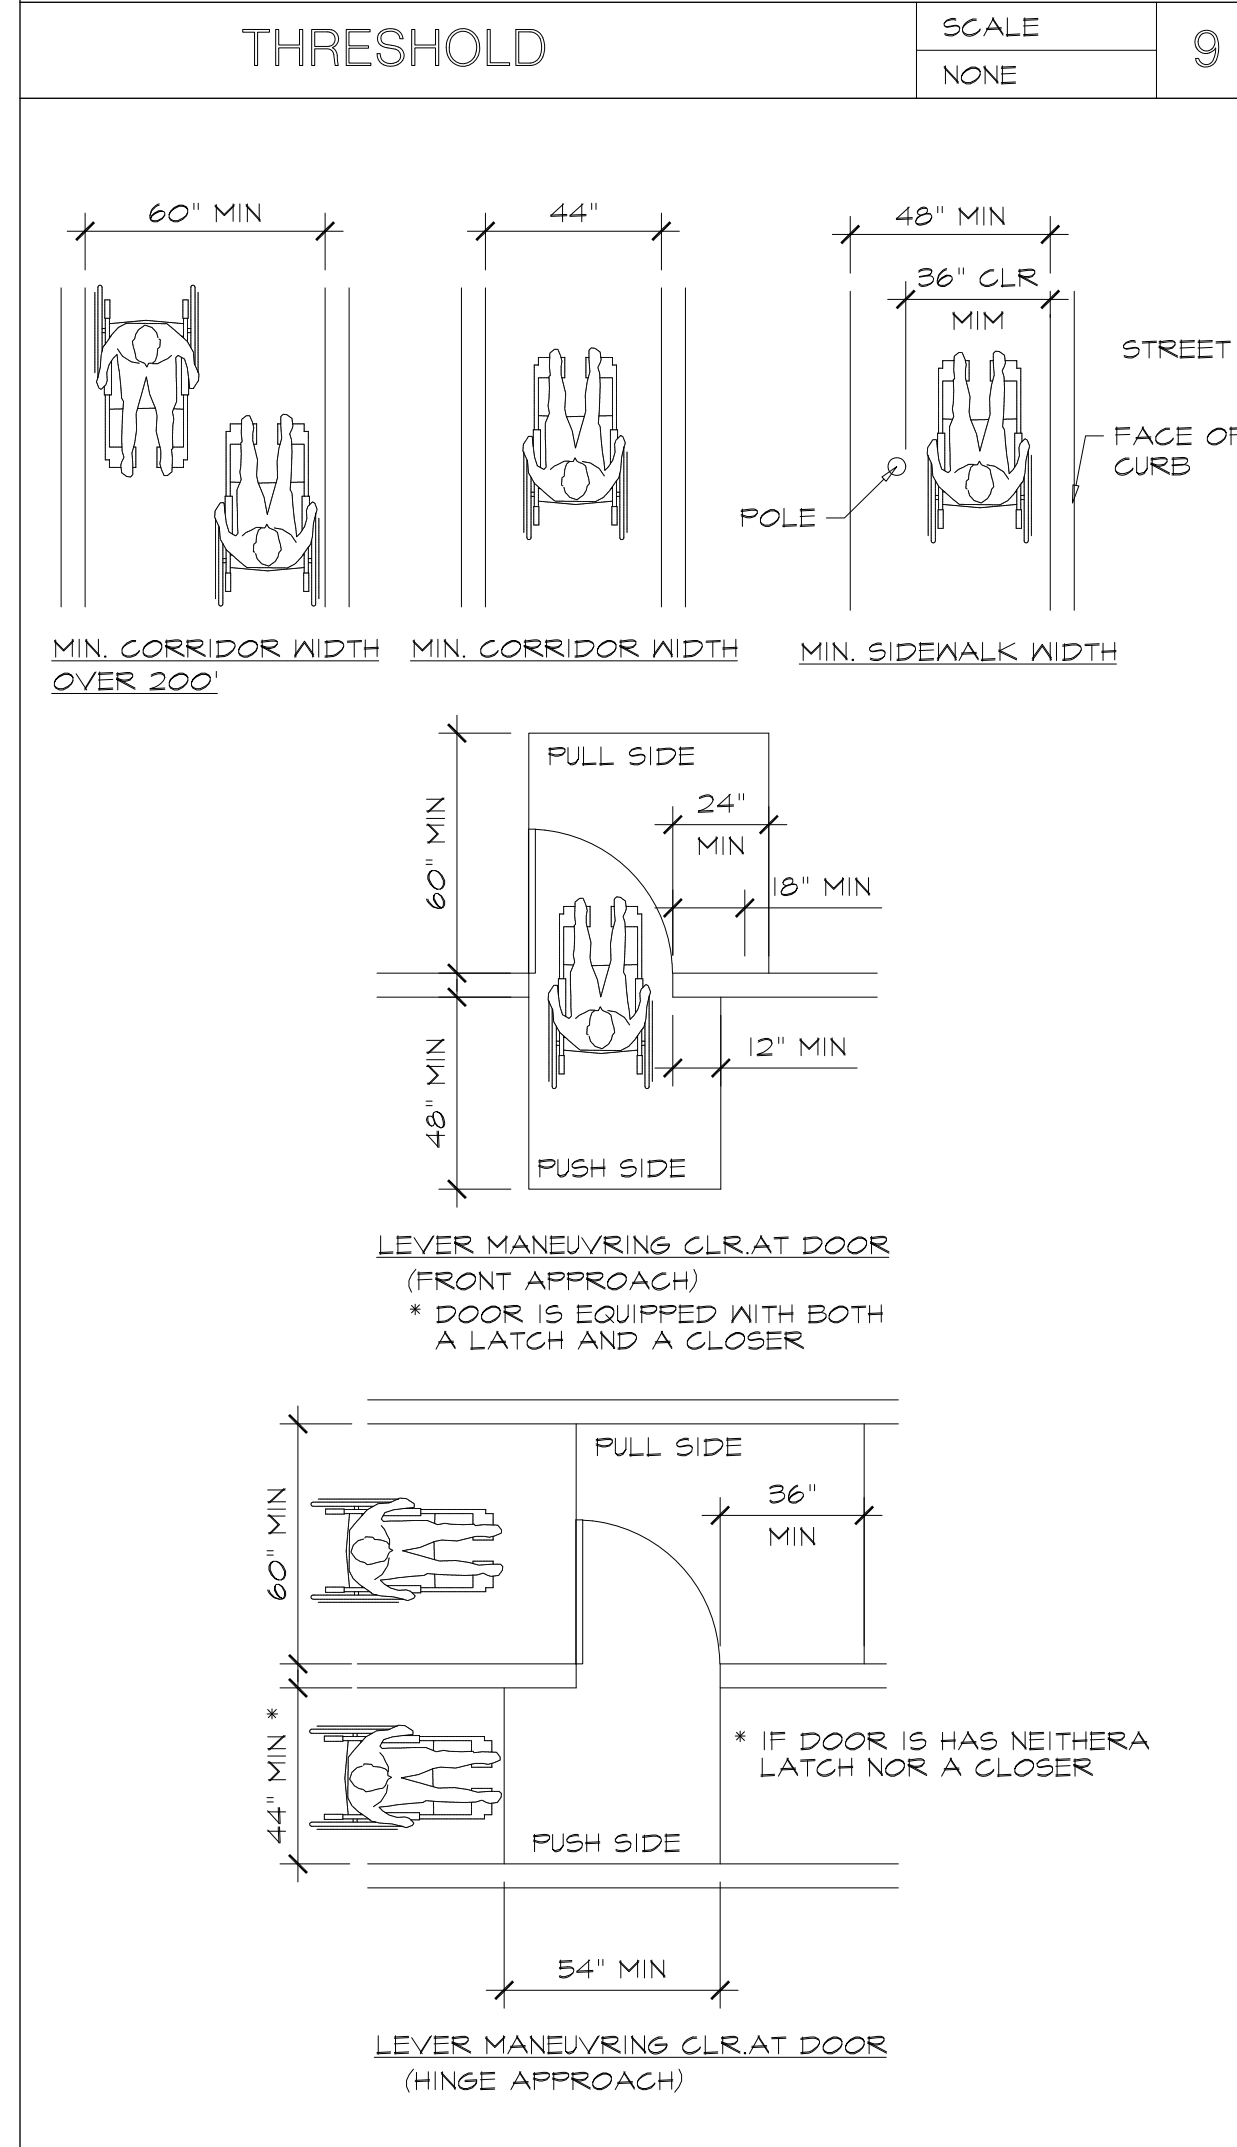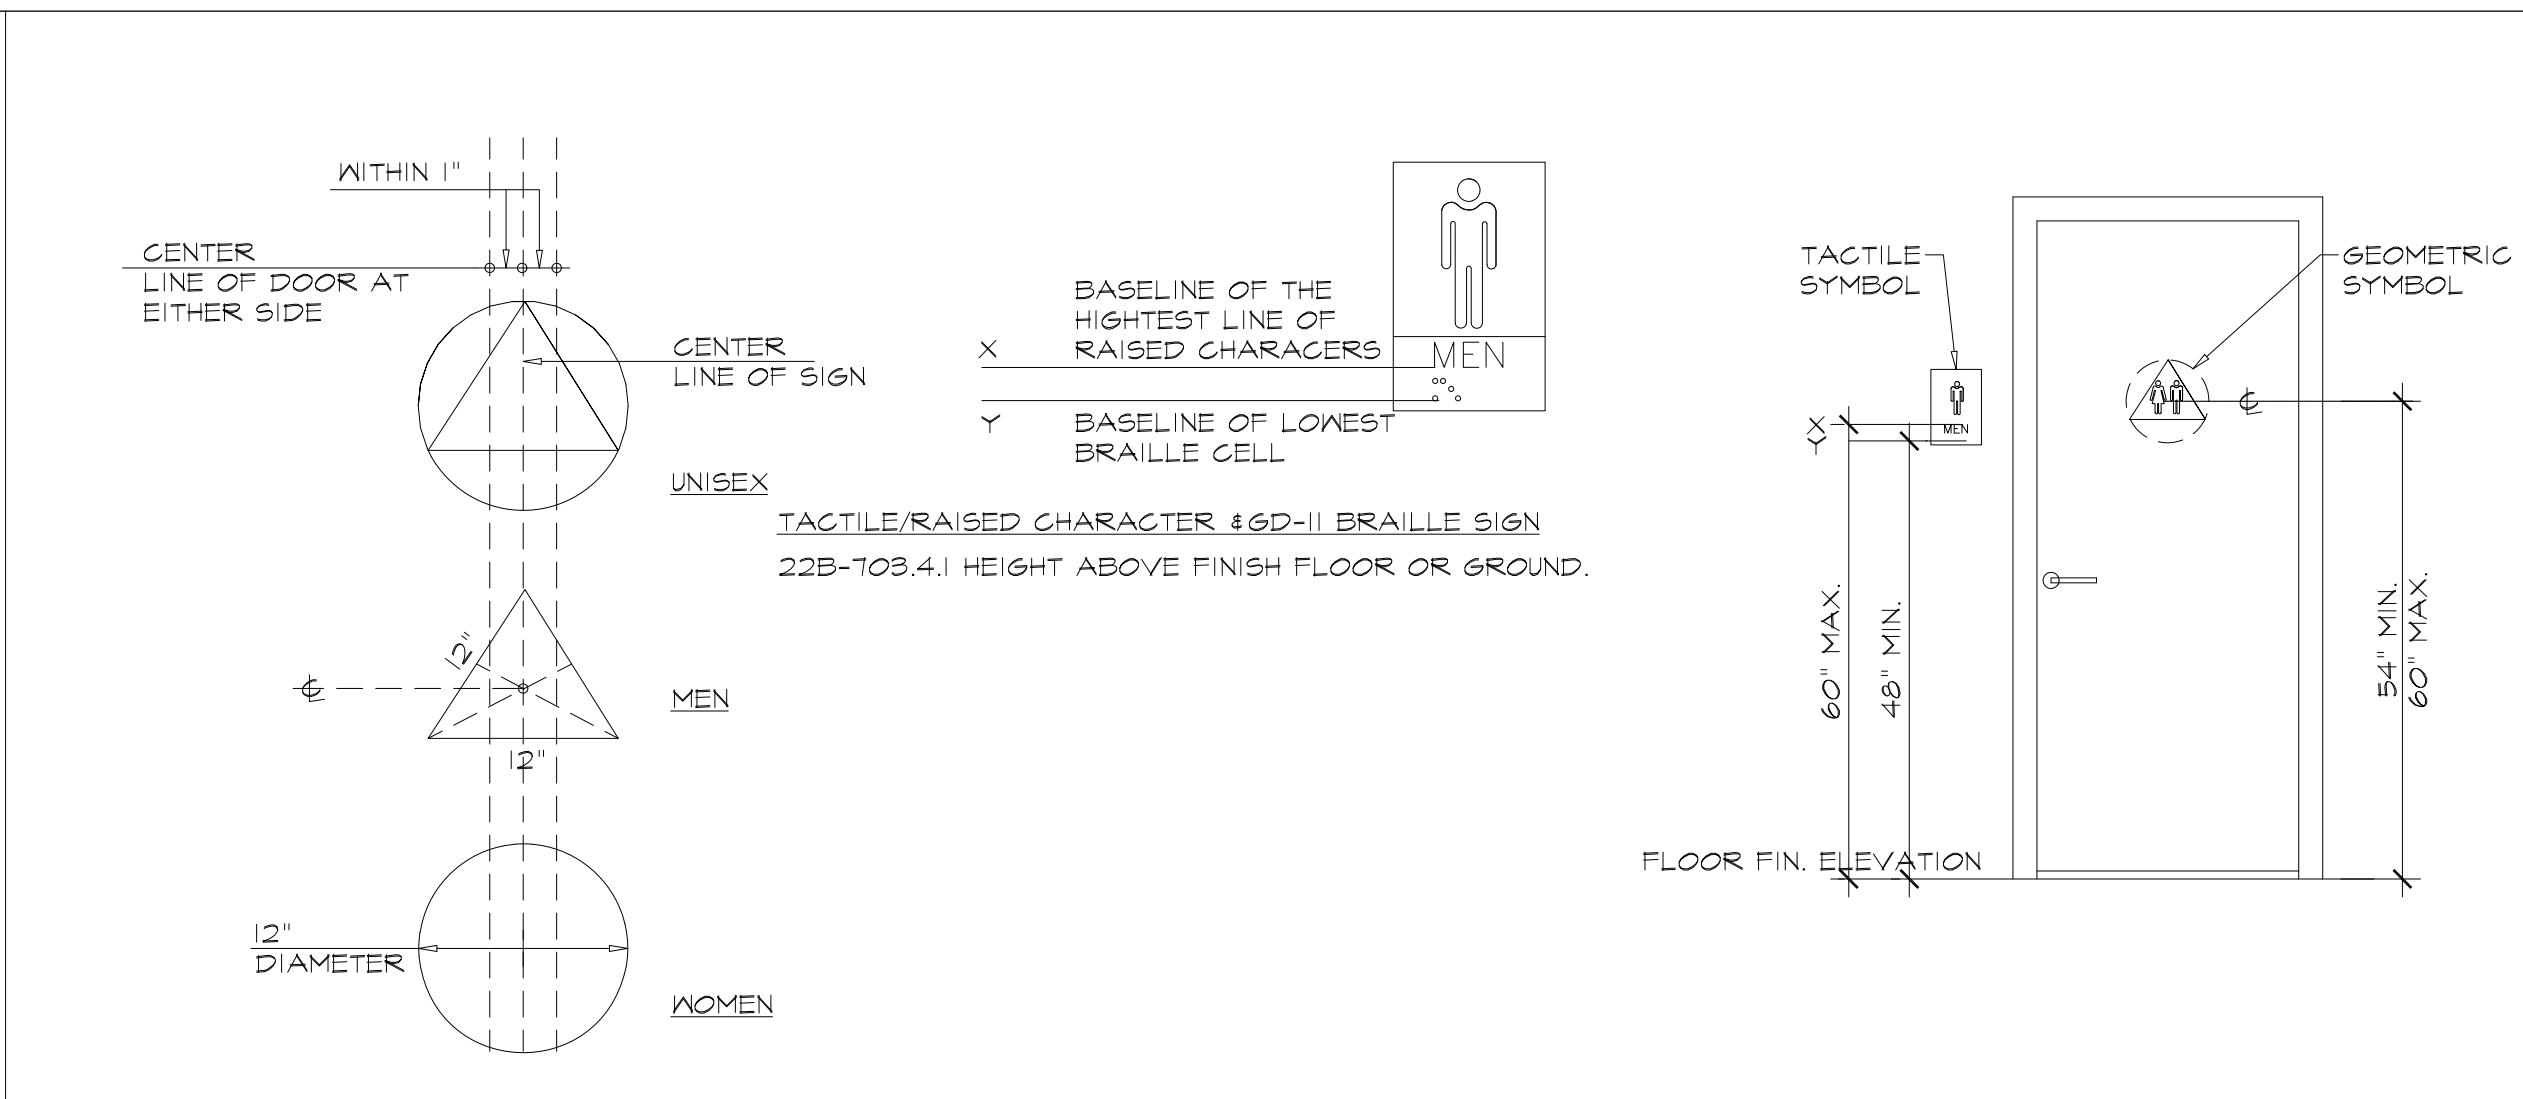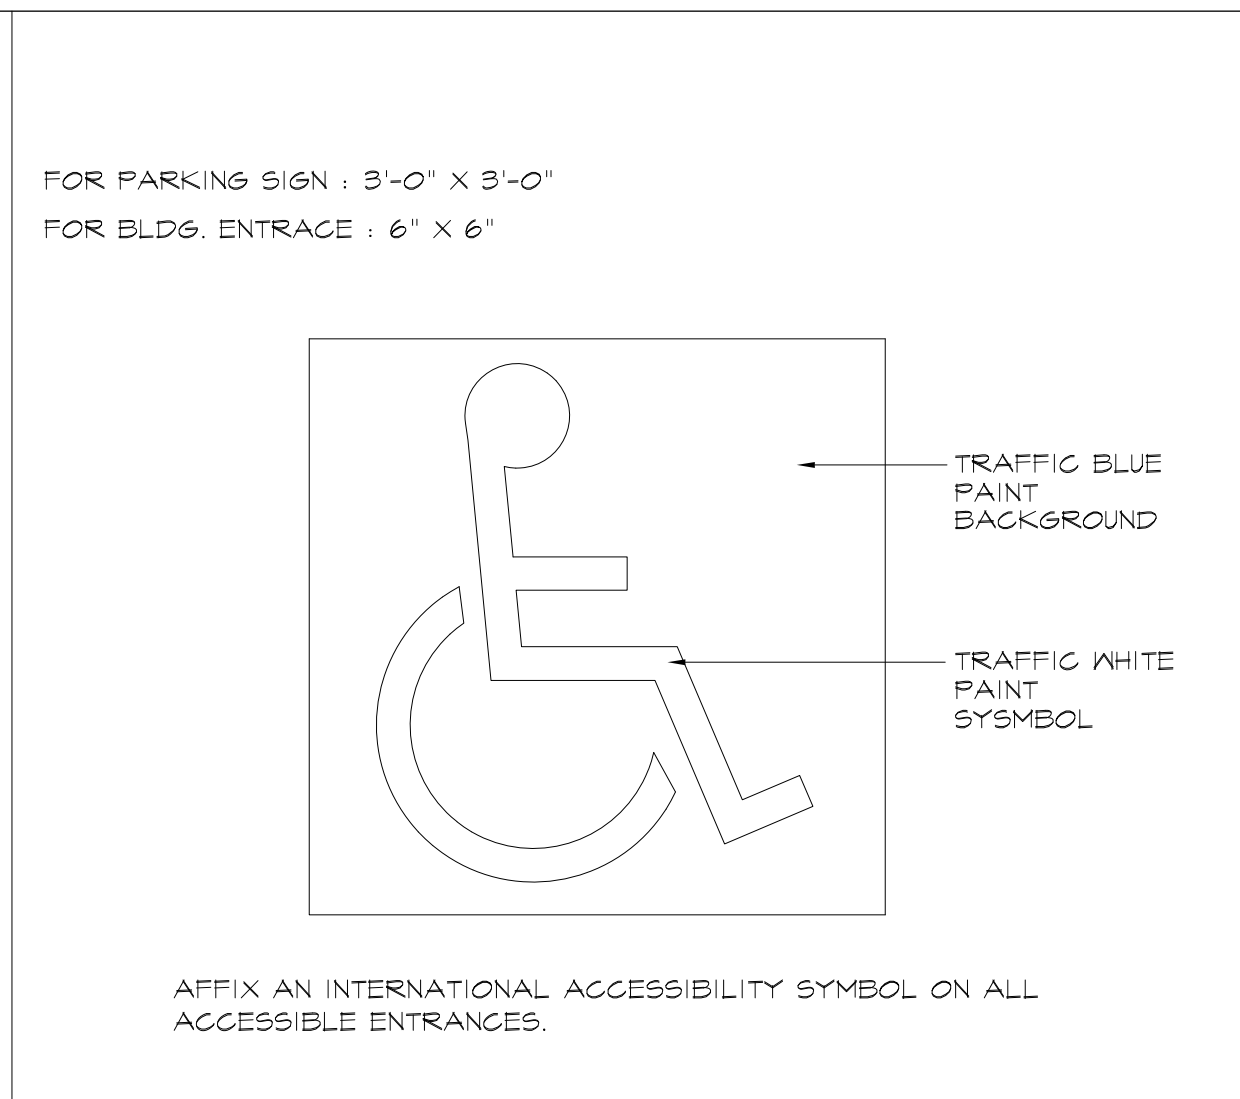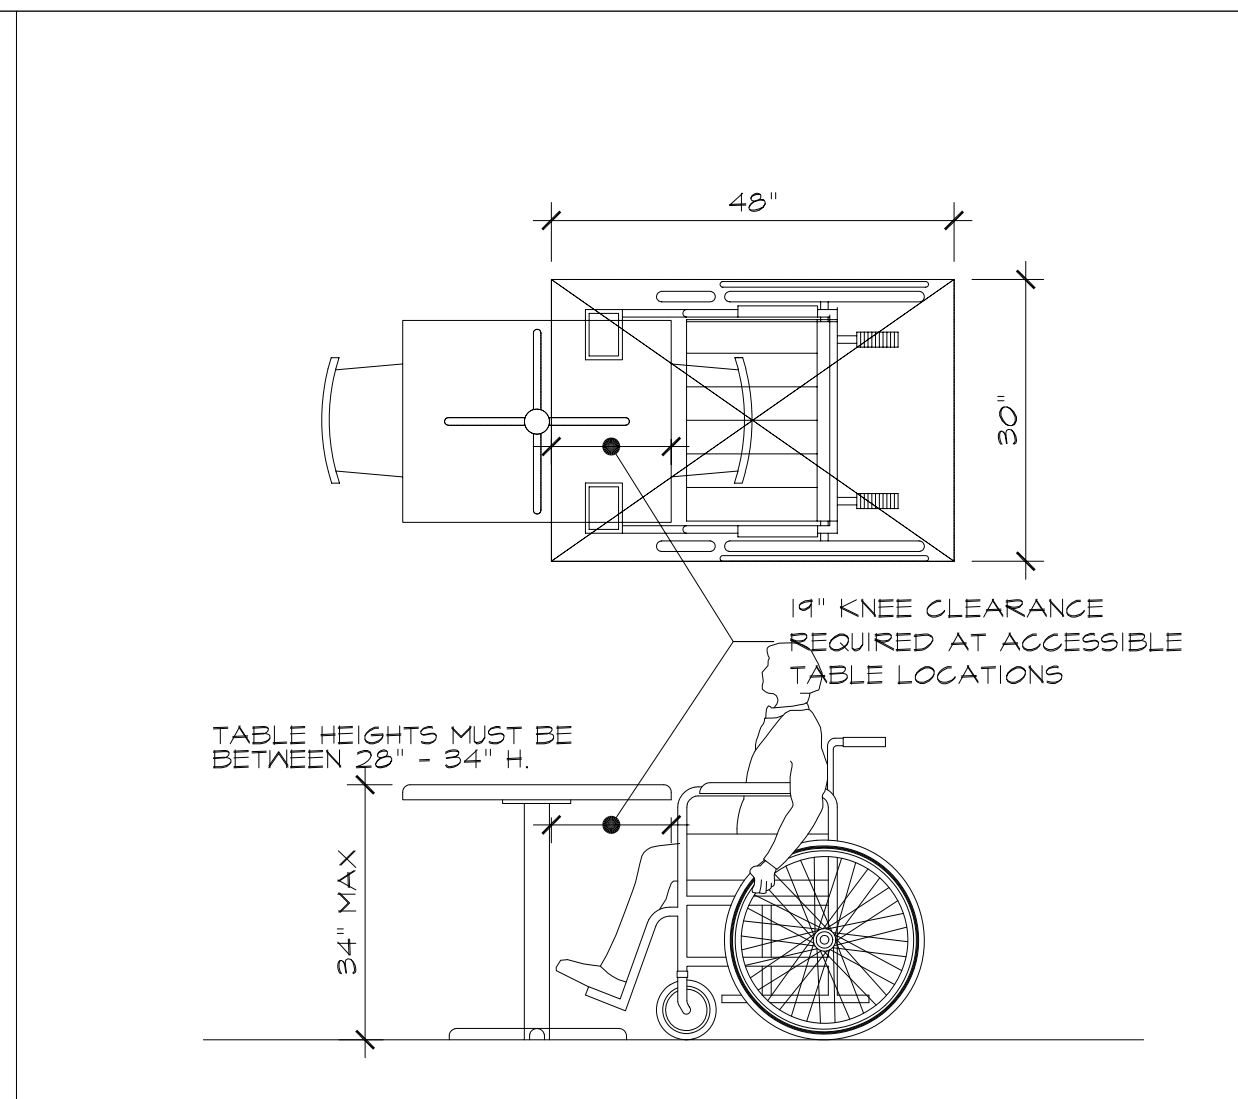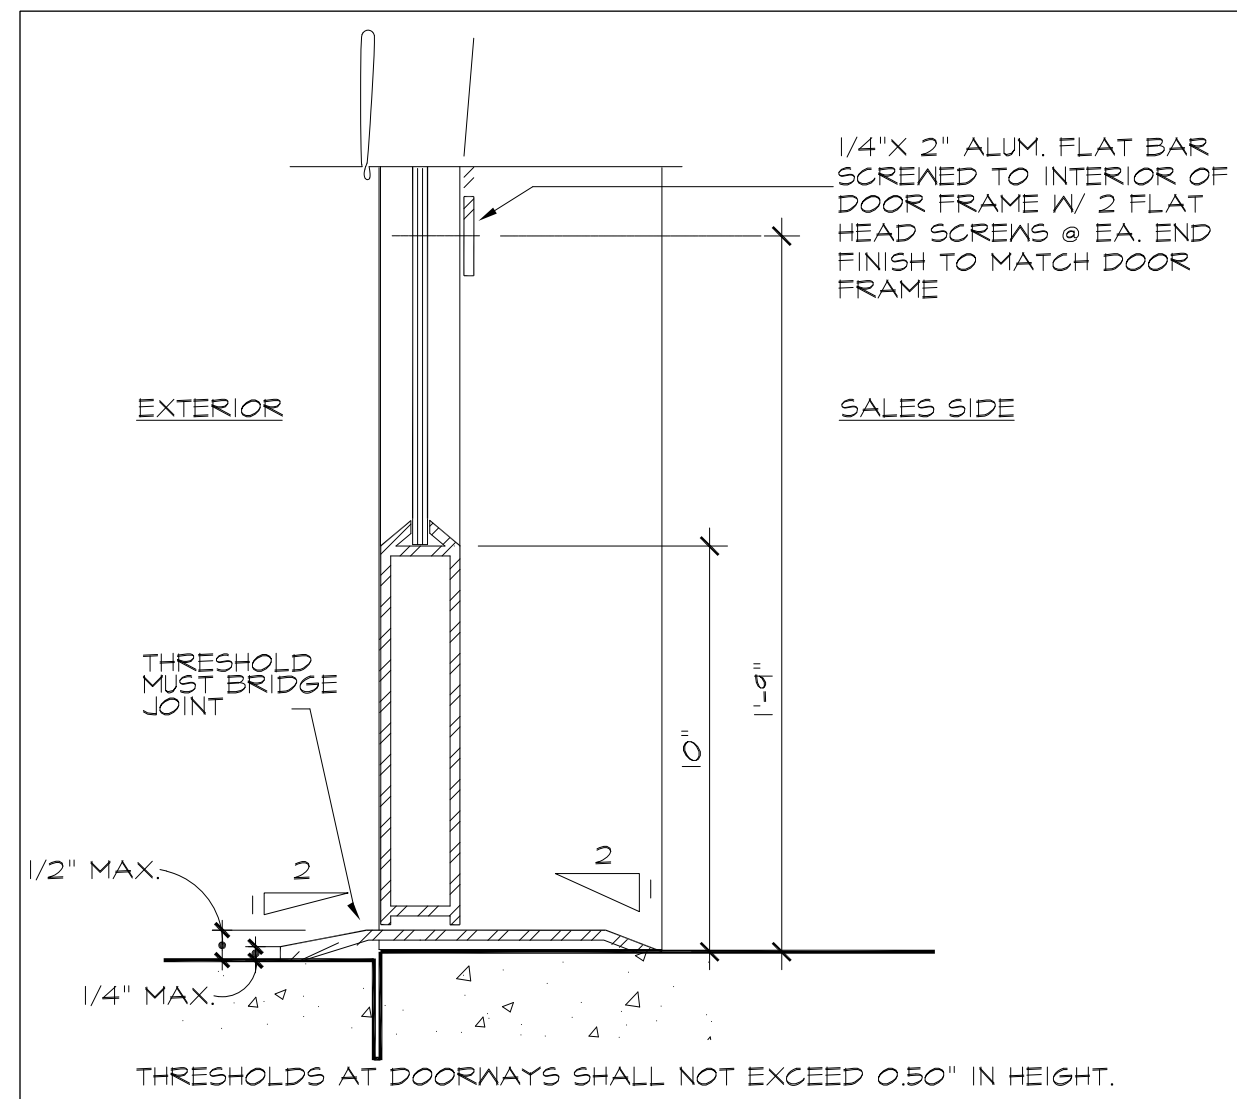

NOTES:

- BRACING WIRES SECURED TO MAIN RUNNERS WITHIN 2' OF THE CROSS RUNNER INTERSECTION AND SPLAYED 90° FROM EACH OTHER AT AN ANGLE NOT EXCEED 45° FROM THE PLANE OF THE CEILING.
- FOR ROOMS WITH SPAN IN EITHER DIRECTION LEA A THAN 25'; MAIN RUNNERS CROSS RUNNERS MAY BE ATTACHED TO THE PERIMETER OF TWO ADJACENT WALLS WITH 3/4" CLEARANCE BETWEEN THE RUNNERS AND THE OTHER TWO WALLS. WHERE SPAN OF THE CEILING SYSTEM BETWEEN PERIMETER WALLS EXCEED 25' IN BOTH DIRECTIONS, A MINIMUM WALL ANGLE SIZE OF AT LEAST 2" HORIZONTAL LEG SHALL BE USED AT PERIMETER WALLS AND INTERIOR FULL HEIGHT PARTITION. THE FIRST TILE SHALL BE 3/4" CLEAR FROM WALL SURFACE.
- WHEN THE DISTANCE BETWEEN THE STRUCTURAL DECK AND THE CEILING EXCEED 4', THE SPACING OF THE VERTICAL HANGERS SHALL NOT EXCEED 2' O.C. ALONG THE ENTIRE LENGTH OF THE MEANS OF EGRESS SERVICING AN OCCUPANT LOAD OF 30 OR MORE, AND AT LOBBIES ACCESSORY TO GROUP A OCCUPANCES.

TYPICAL SUSPENDED CEILING VETRICAL AND LATERAL SUPPORT

A. SUSPENDED CEILING AND LIGHTING SYSTEMS

THE FOLLOWING PRESCRIPTIVE DESIGN MAY USED FOR SUSPENDED CEILING AND LIGHTING SYSTEMS THAT ARE A MAXIMUM 4 FT BELOW THE STRUCTURAL DECK AND WEIGHT NO MORE THAN 4 LBS PER SQ. FT.

B. MINIMUM INSTALLATION REQUIREMENTS

- VERTICAL SUPPORT:
 - HANGER WIRES SUPPORTING A MAXMUM TRIBUTARY CEILING AREA OF 16 S.F. SHALL BE A MINIMUM OF 12 GA. IN DIAMETER. THE SIZE OF WIRES SUPPORTING A TRIBUTARY CEILING AREA OF GREATER THAN 16 S.F. SHALL BE SUBSTANTIATED BY DESIGN CALCULATION.
 - HANGER ATTACHMENT DEVICES USED IN CEILING SYSTEMS NOT EXCEEDING FOUR POUNDS PER SQUARE FEET SHALL BE CAPABLE OF SUPPORTING A MINIMUM ALLOWABLE LOAD OF 100 POUNDS.
 - HANGERS SHALL BE PLUMB AND SHALL NOT ATTACH TO OR BEND AROUND INTERFERING DUCT PIPES OR SIMILAR OBSTRUCTIONS. IF HANGERS MUST BE SPLAYED MORE THAN ONE HORIZONTAL TO SIX VERTICAL THE RESULTING HORIZONTAL FORCE SHALL BE OFFSET BY BRACING, COUNTER-SPLAYING OR OTHER ACCEPTABLE MEANS AND SUBSTANTIATED BY DESIGN CALCULATION.
 - PERIMETER HANGERS:
 - THE TERMINAL END OF EACH CROSSRUNNER OR MAIN RUNNER SHALL BE INDEPENDENTLY SUPPORTED AND WITHIN EIGHT INCHES OF A WALL.
- LATERAL SUPPORT:

ALTERAL SUPPORT FOR THE CEILING SYSTEM MAY BE PROVIDED BY FOUR WIRES OF MIN. 12 GA SPLAYED IN FOUR DIRECTIONS 90 DEGREES APART AND CONNECTED TO THE MAIN RUNNERS WITHIN TWO INCHES OF THE CROSS RUNNER AND TO THE STRUCTURE ABOVE AT AN ANGLE NOT EXCEEDING 45 DEGREES FROM THE PLANE OF THE CEILING. THESE LATERAL SUPPORT POINTS SHALL BE PLACED 12 FT O.C. IN EACH DIRECTION WITH THE FIRST POINT WITHIN 4 FT FROM EACH WALL.
- ATTACHMENT OF MEMBERS TO THE PERIMETR:

ALLOWANCE SHALL BE MADE FOR LATERAL MOVEMENT OF THE SYSTEM. MAIN RUNNERS AND CROSS RUNNERS MAY BE ATTACHED AT TWO WALLS WITH CLEARANCE BETWEEN THE WALL AND RUNNERS MAINTAINED AT THE OTHER TWO WALLS.
- LIGHTING FIXTURE AND AIR DIFFUSER SUPPORTS

LIGHTING FIXTURES AND AIR DIFFUSERS SHALL BE SUPPORTED DIRECTLY BY WIRES TO THE STRUCTURE ABOVE.



EXCEPTIONS:

 - RECESSED LIGHTING FIXTURES NOT OVER 56 LBS IN WEIGHT AND SUSPENDED AND INDEPENDENTLY HUNG FIXTURES NOT OVER 20 LBS IN HEIGHT MAY BE SUPPORTED AND ATTACHED DIRECTLY TO THE CEILING SYSTEM RUNNERS BY A POSITIVE ATTACHMENT SUCH AS SCREWS OR BOLTS.
 - AIR DIFFUSERS NOT OVER 20 LBS AND WHICH RECEIVE NO TRIBUTARY LOADING FROM TH DUCT WORK MAY BE POSITIVELY ATTACHED TO AND SUPPORTED BY THE CEILING RUNNERS.
- PERIMETER MEMBERS


A MINIMUM WALL ANGLE SIZE OF AT LEAST A 2' HORIZONTAL LEG SHALL BE USED AT PERIMETER WALLS AND INTERIOR FULLHEIGHT PARTITIONS. THE FIRST CEILING TILE SHALL MAINTAIN 3/4" CLEAR FROM THE FINISH WALL SURFACE. AN EQUIVALENT ALTERNATIVE DETAIL THAT WILL PROVIDE SUFFICIENT MOVEMENT DUE TO ANTICIPATED LATERAL BUILDING DISPLACEMENT MAY BE USED IN LIEU OF THE LONG LEG ANGLE SUBJECT TO THE APPROVAL OF THE SUPERINTENDENT OF BUILDING.

APPLICATION:


THIS PROVISION SHALL BE REQUIRED ONLY WHEN THE SPAN OF THE PROPOSED SUSPENDED CEILING SYSTEM BETWEEN PERIMETER WALLS EXCEEDS 25 FT IN BOTH DIRECTIONS.

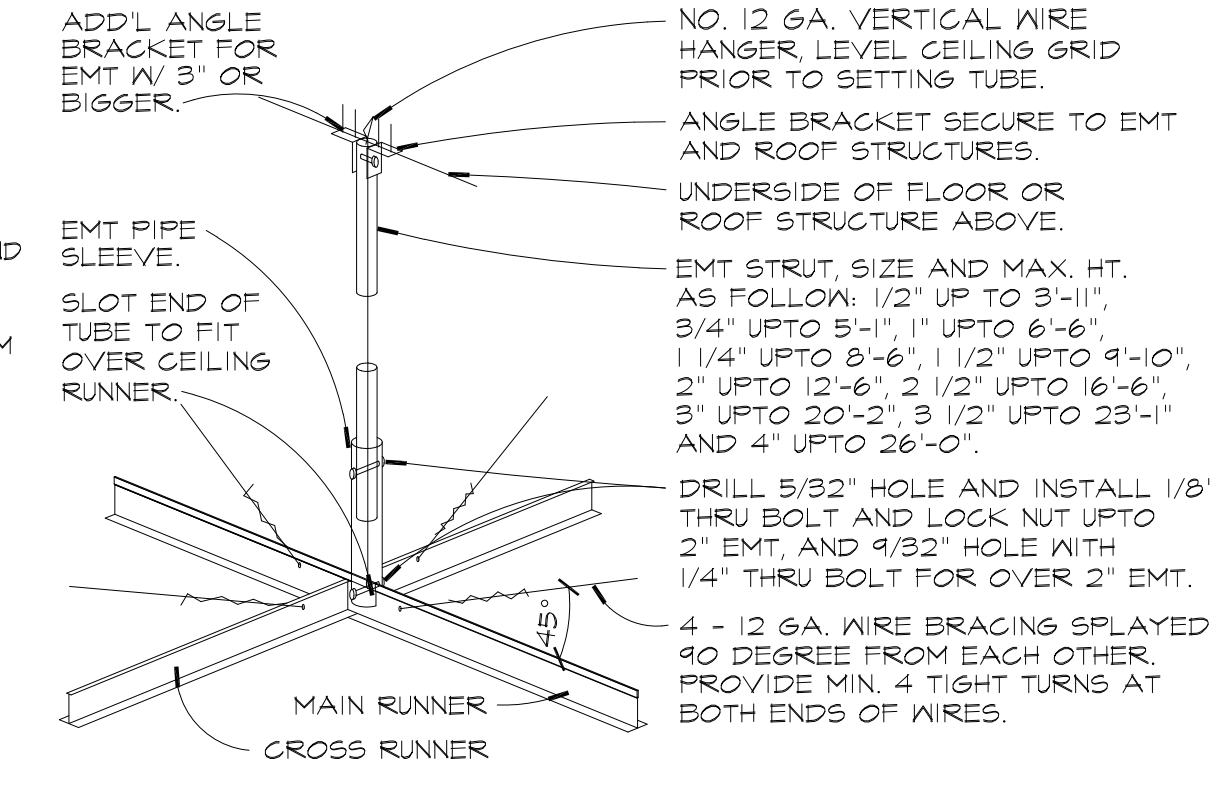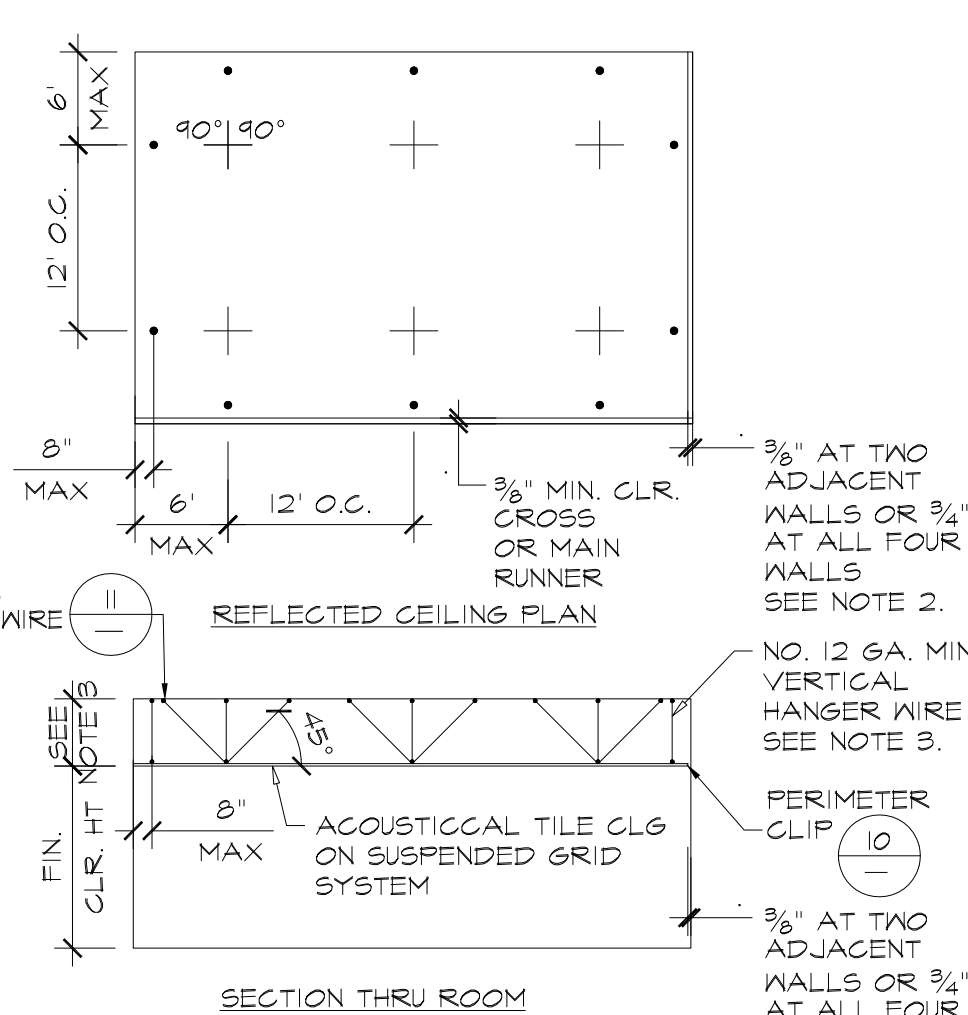

SUSPENDED CEILING SYSTEMS

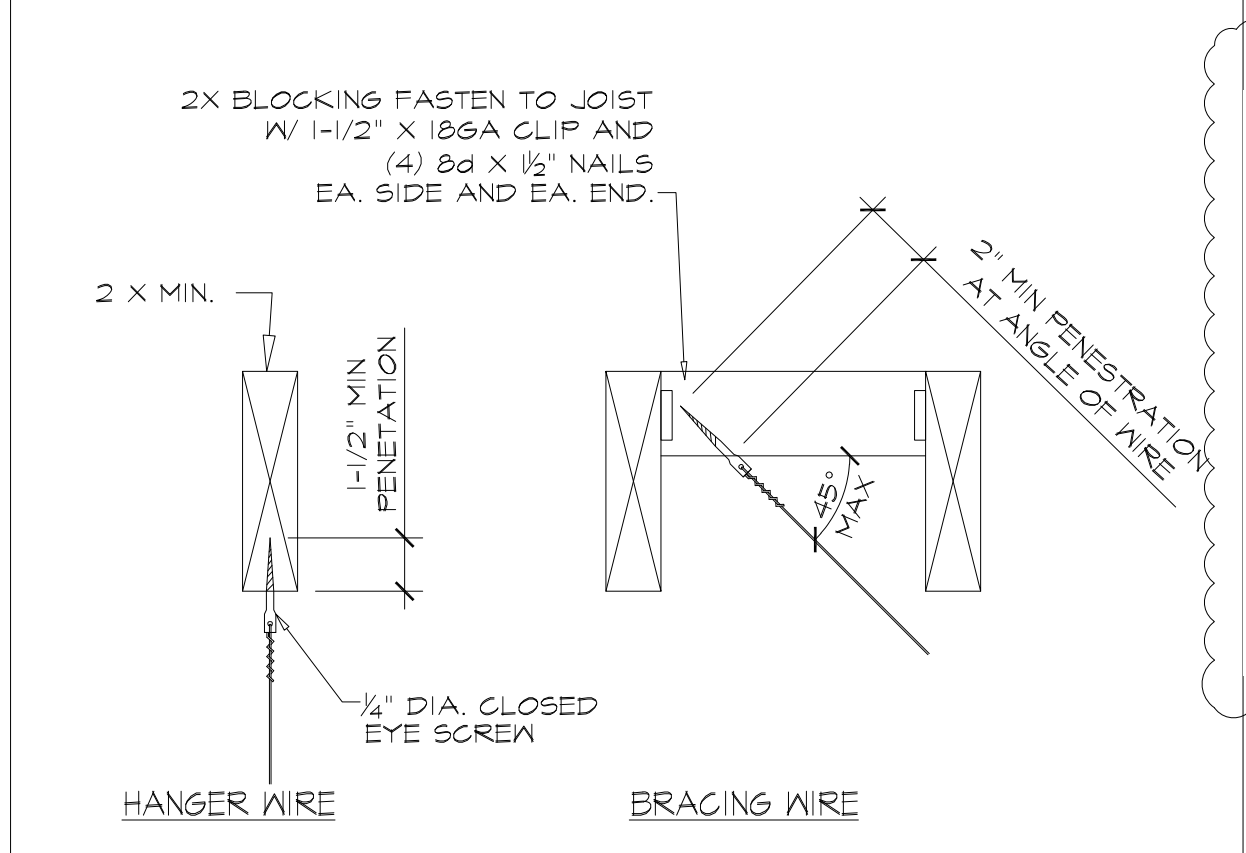

SUSPENDED CEILING SYSTEM: CHICAGO METALLIC (ESR-263)

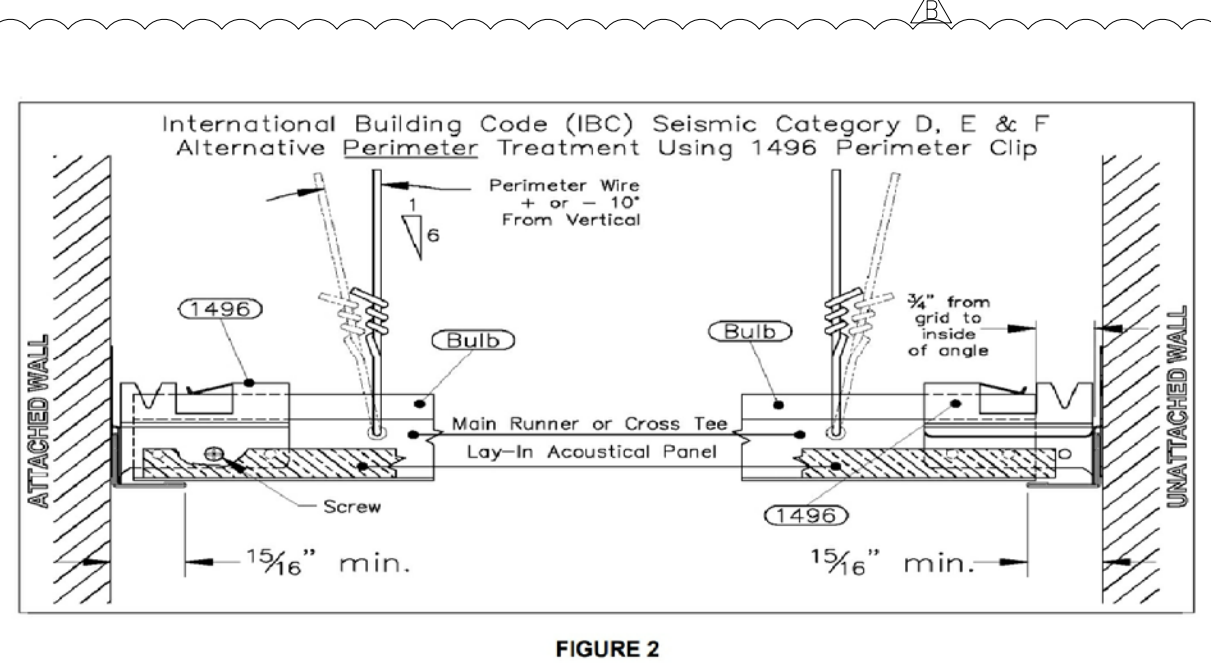


HANGER WIRE

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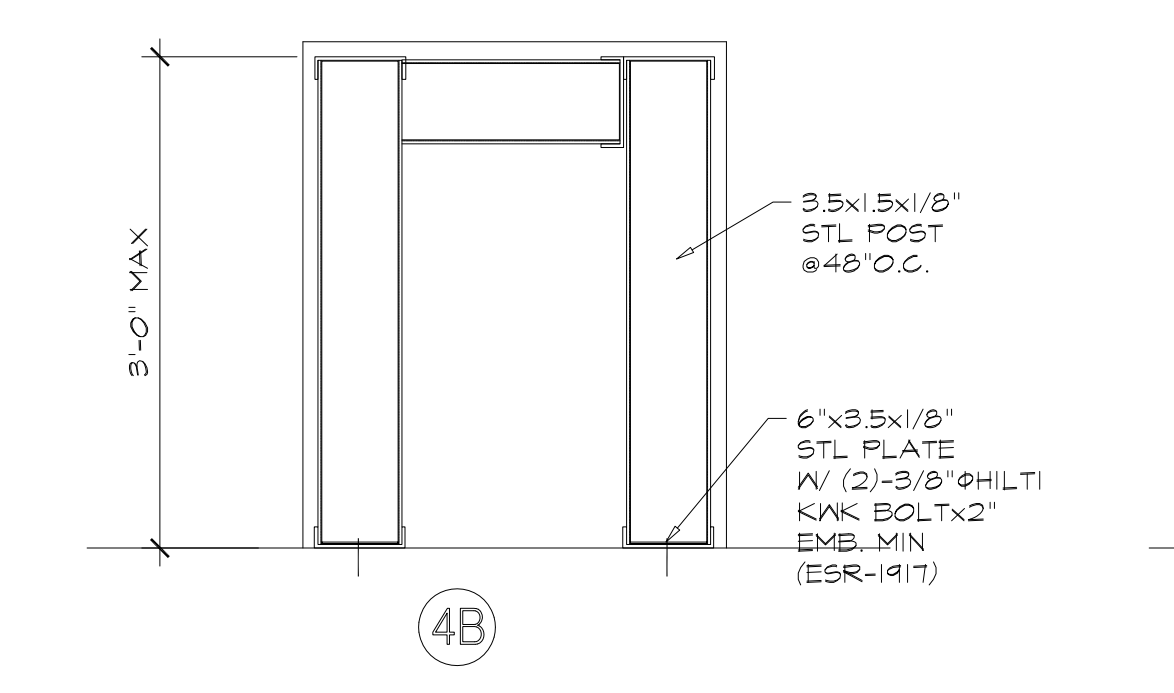
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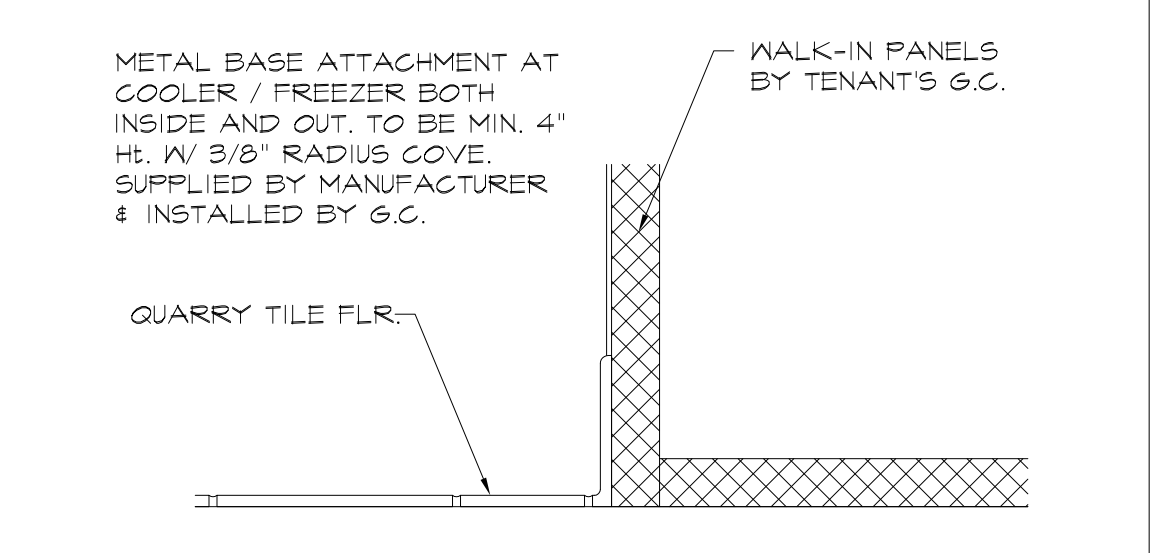
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SCALE
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SECTION @ TILE TRANS.

SCALE
N.T.S.

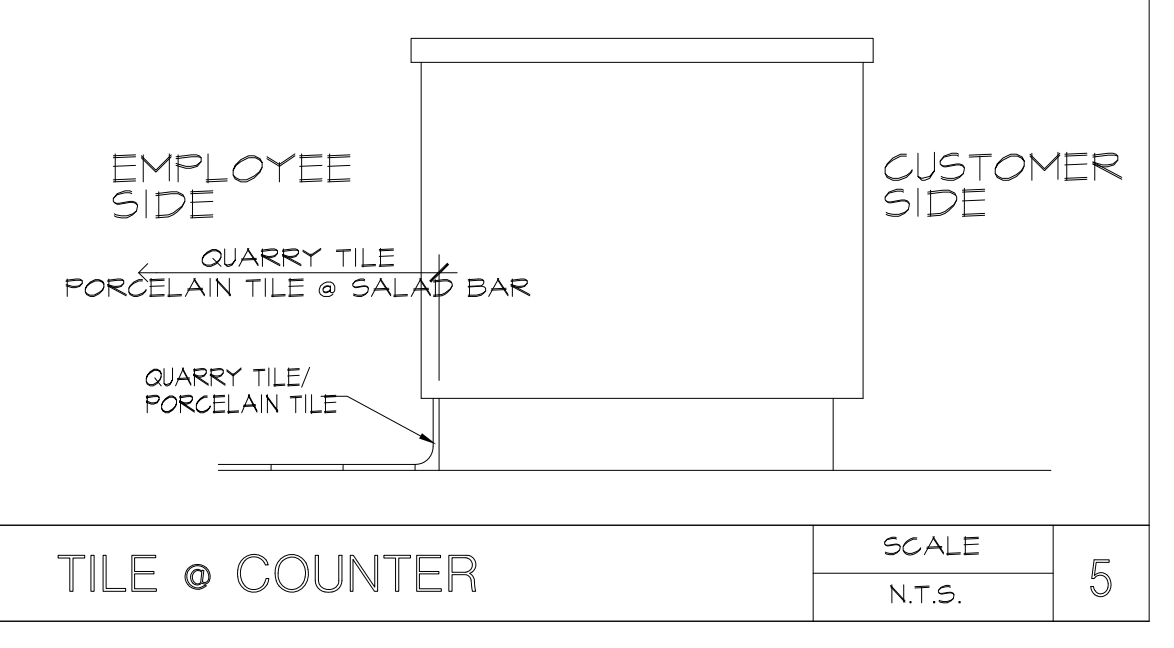


SECTION @ WALK-IN PANELS

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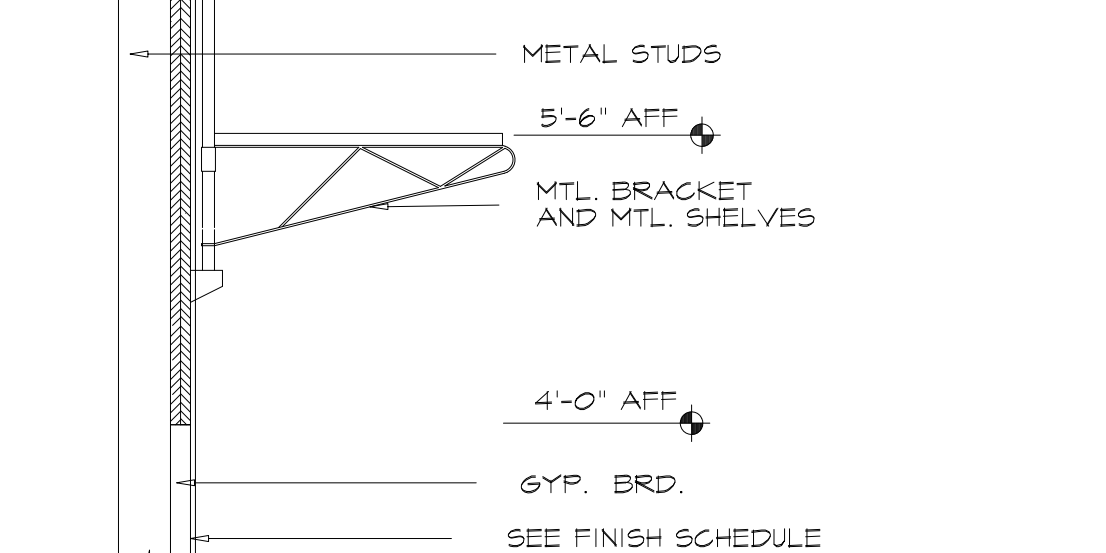
TILE / WATER PROOF @ DEMISING WALL

SCALE
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LOW HEIGHT PARTITION

SCALE
N.T.S.

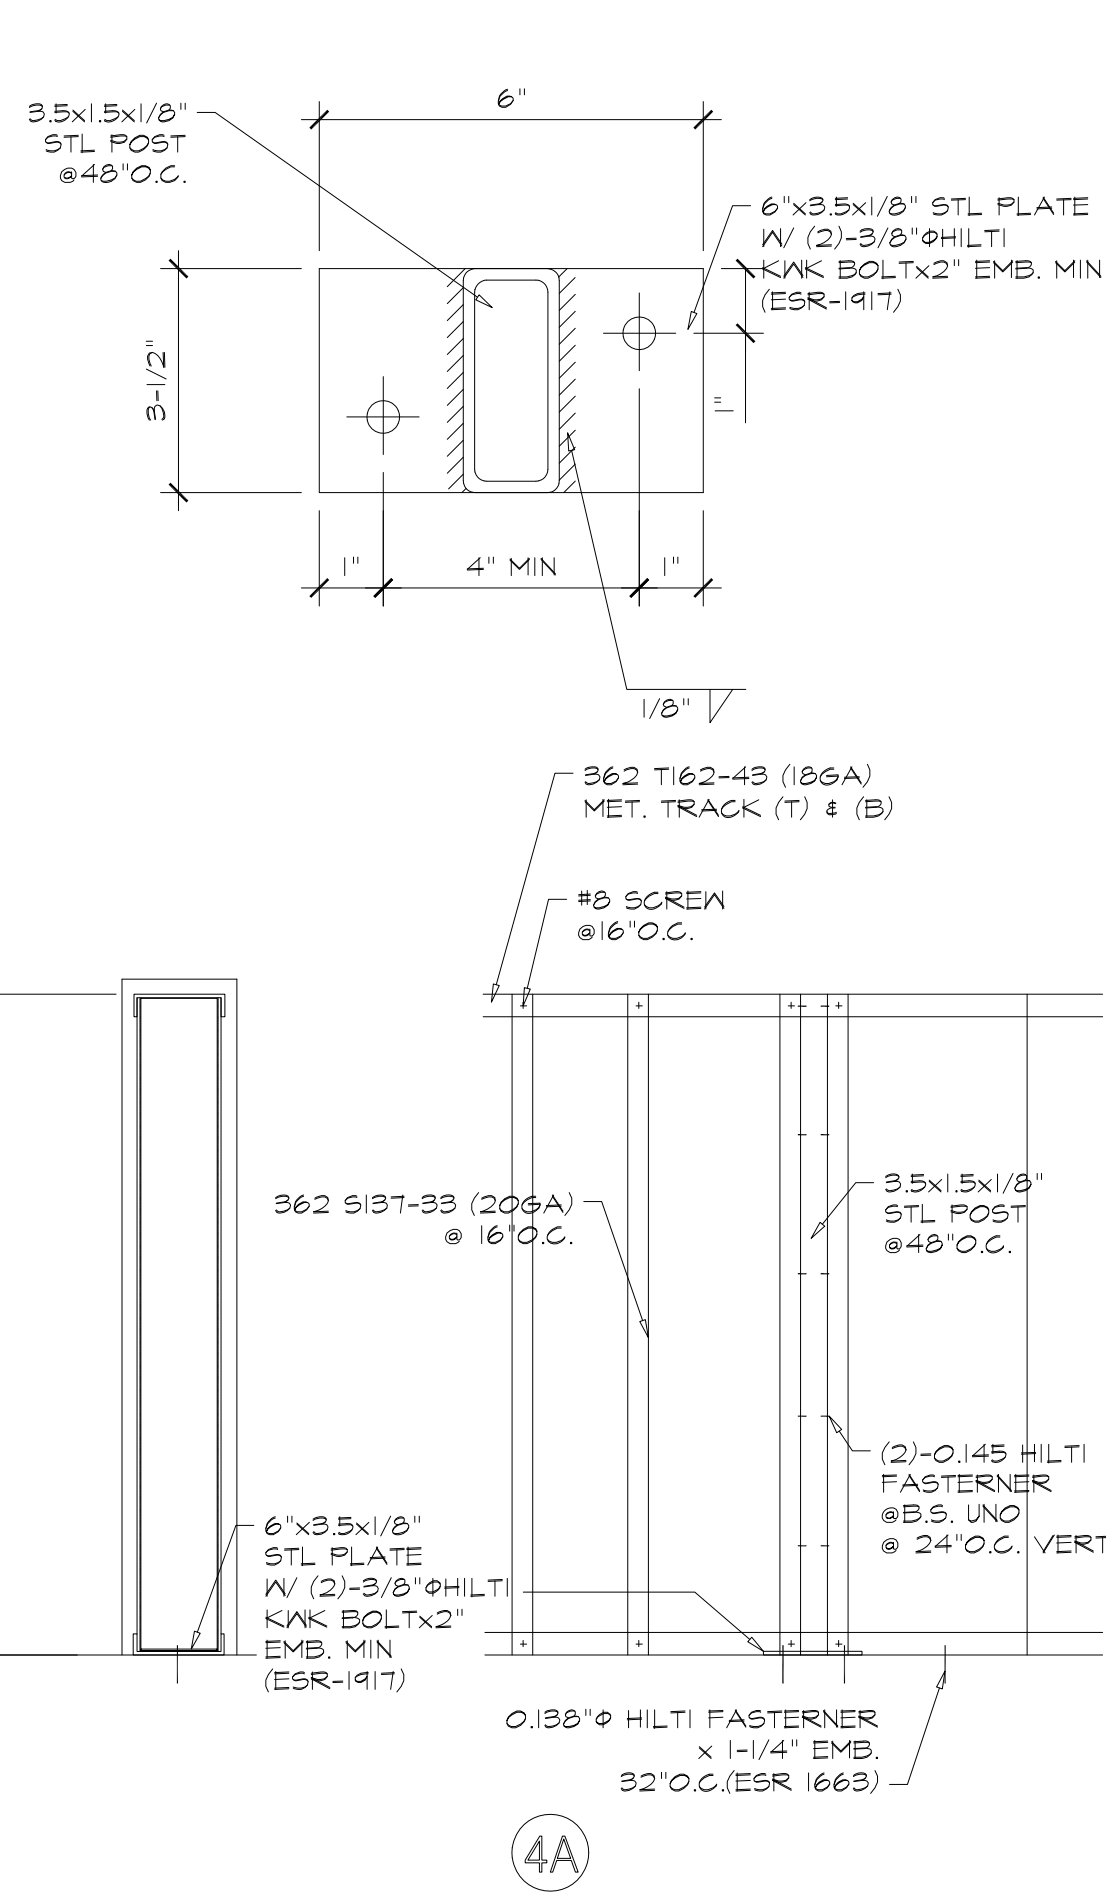


WALL SHELF DETAIL TYP.

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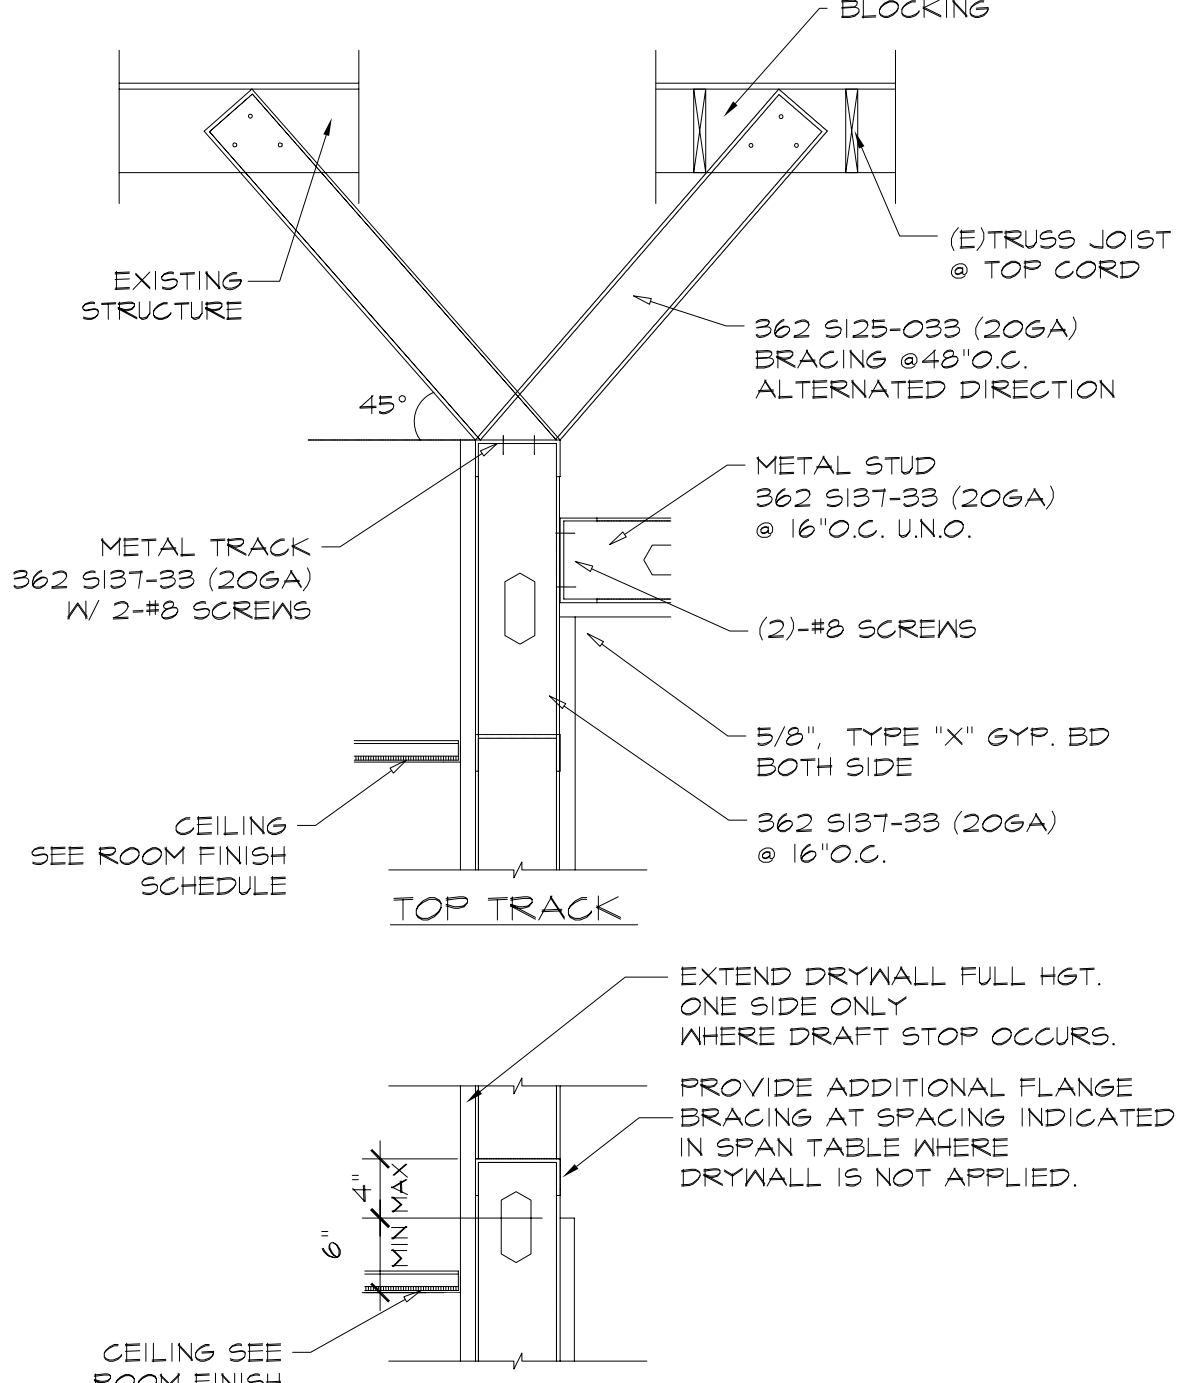
HARD CEILING / SOFFIT DETAIL

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INTERIOR NON BEARING WALL

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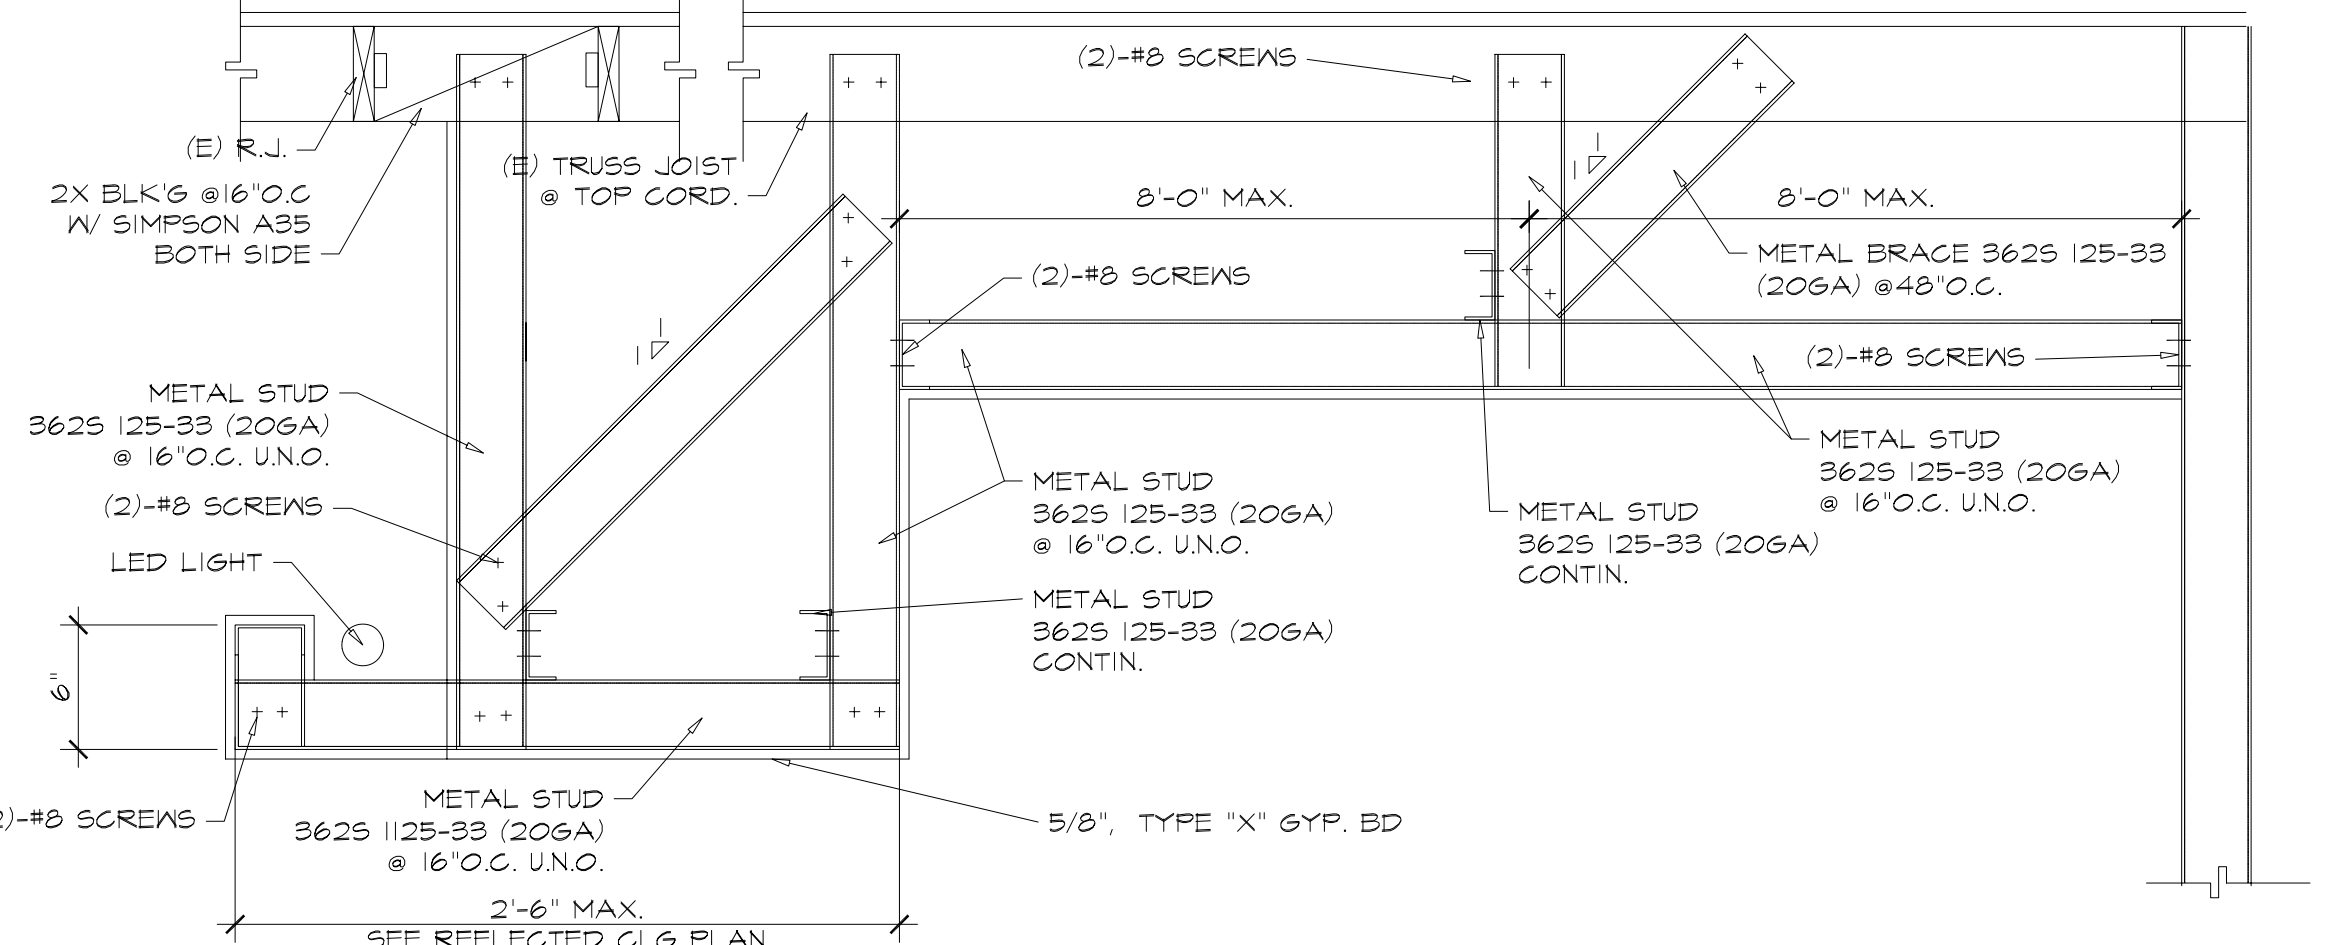


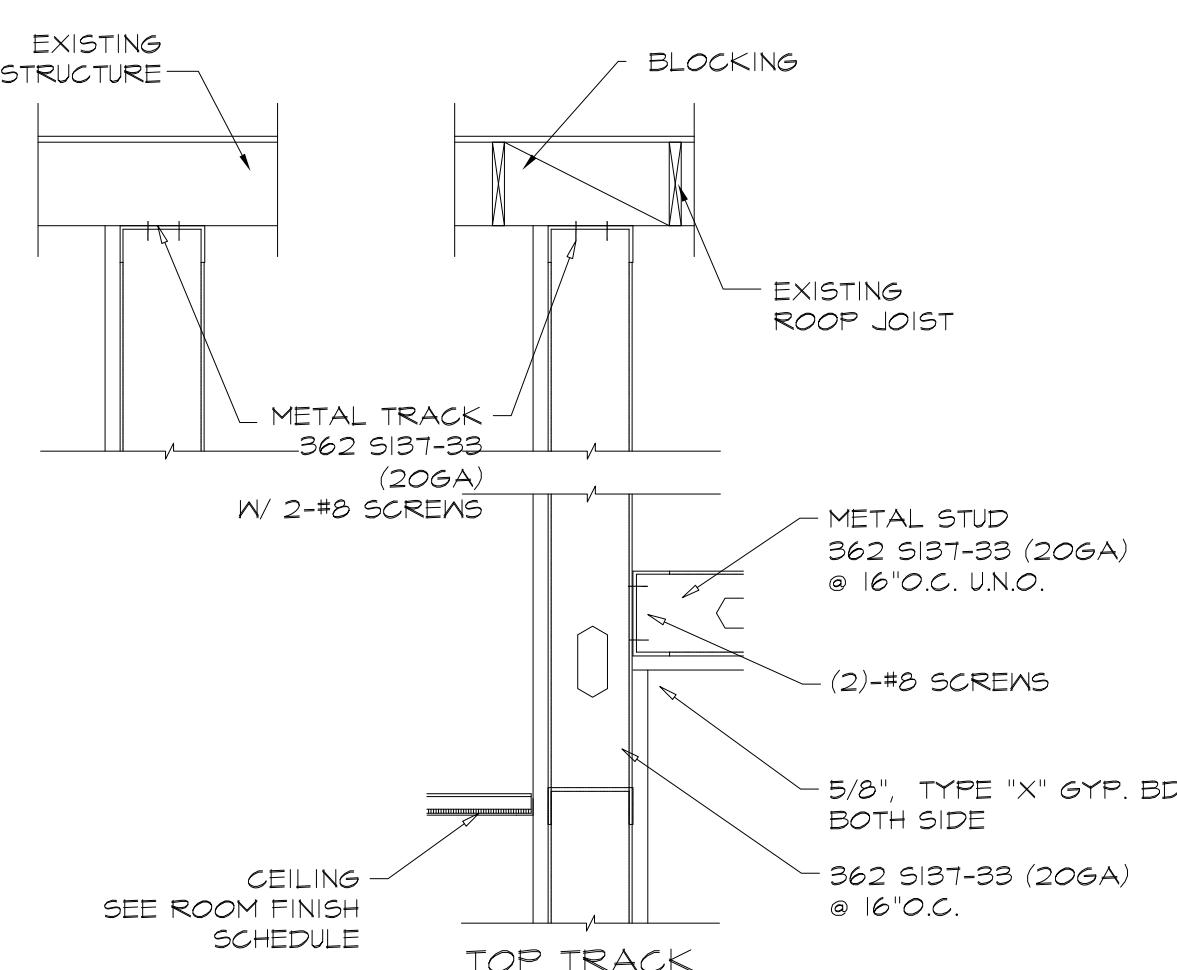INTERIOR NON BEARING WALL

SCALE
N.T.S.

INTERIOR NON BEARING WALL

SCALE
N.T.S.



INTERIOR NON BEARING WALL

SCALE
N.T.S.

SOUTH VALLEY WATER RECLAMATION FACILITY PRETREATMENT PROGRAM

PRETREATMENT DRAWINGS AND SPECIFICATIONS

SAMPLING MANHOLE - 3' TO 7' DEEP

SAMPLING MANHOLE - 7' AND DEEPER

SAMPLING MANHOLE - BOX

GREASE INTERCEPTOR - 800 AND 1000 GALLON


SAND AND OIL SEPARATOR - 800 AND 1000 GALLON

DETAILS

IMPORTANT NOTICE: South Valley Water Reclamation Facility must be notified prior to backfilling interceptor and sampling manhole installations. Inspection of these installations by South Valley Water Reclamation Facility is a requirement!

DRAWN BY: SHEET 1 OF 6

REV. A

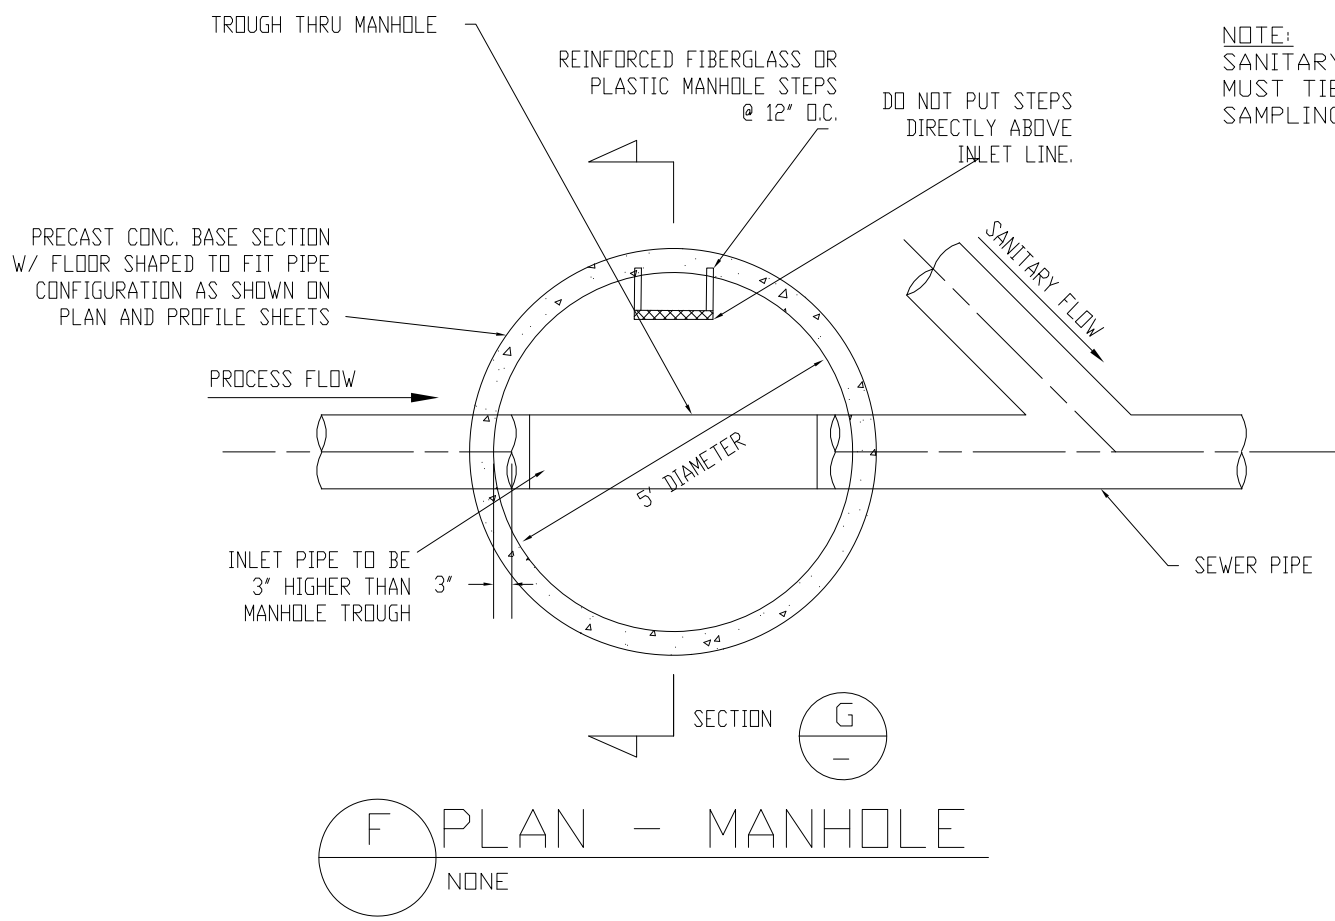

- NOTES:
1. PIPING, CLEANOUT CONFIGURATION, SIZE AND TYPE OF PIPING MATERIAL AS PER CITY OR SANITARY DISTRICT. INSPECTION BY SVWRF PRIOR TO BACKFILLING IS REQUIRED.
 2. WIDTH OF TROUGH IN THE MANHOLE MUST BE THE SAME SIZE AS THE INLET PIPE INTO MANHOLE. DEPTH OF TROUGH MUST BE THE SAME AS 1/2 OF INLET PIPE DIAMETER.
 3. CONCRETE SHALL HAVE A MINIMUM 28 DAY COMPRESSIVE STRENGTH OF 4000 PSI.
 4. REINFORCEMENT STEEL SHALL BE ASTM A615 GRADE 60.
 5. THE CONCRETE COVER OVER REINFORCEMENT STEEL SHALL BE A MINIMUM OF 1 1/2 INCHES.
 6. THE STRUCTURE SHALL BE DESIGNED BY A REGISTERED PROFESSIONAL ENGINEER LICENSED IN THE STATE OF UTAH.
 7. THE STRUCTURE SHALL BE DESIGNED FOR THE FOLLOWING LOADING CRITERIA:
A) WALLS DESIGNED FOR A SATURATED EQUIVALENT FLUID AT-REST SOIL PRESSURE OF 90 PCF PLUS TRUCK SURCHARGES.
B) TRUCK LOADING USING AN AASHTO H-20 TRUCK LOAD.
 8. MANHOLES OVER 4 FEET IN DEPTH WILL HAVE FIBERGLASS OR PLASTIC STEPS.
 9. ALL MANHOLES MUST HAVE ROUND NOTCHED COVERS WITH PICK HOLE FOR REMOVAL.
 10. FOR NEW CONSTRUCTION, BOTTOM OF INLET PIPE INTO MANHOLE MUST BE AT LEAST 3 INCHES ABOVE THE BOTTOM OF THE TROUGH THRU THE MANHOLE.
 11. 12\"/>
 12. GROUT ALL PIPES IN/OUT FLUSH WITH OUT/IN SIDE OF BOX.
 13. DO NOT LOCATE SAMPLING MANHOLE IN PARKING SPOTS.
 14. MINIMUM DEPTH OF SAMPLING MANHOLE IS 4'. IF YOU CAN'T GET 4', CONTACT SVWRF.

DESIGNED BY:	12/9/08 (D.S.)	NOTES 11 & 12, BEDDING NOTE.	DRAWN BY:	N. PALMER	CHECKED BY:	N. PALMER
DESIGNED BY:	J. MCDUGALL		DRAWN BY:	J. MCDUGALL	CHECKED BY:	N. PALMER
REV.	DATE	BY	DESCRIPTION	*****	2001	

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SV South Valley
WATER RECLAMATION FACILITY
7495 South 1300 West
West Jordan, Utah 84084
801.566.7711 F 801.566.7734

SOUTH VALLEY WATER RECLAMATION FACILITY
PRETREATMENT PROGRAM
SAMPLING MANHOLE, 3' TO 7' DEEP
DRAWN BY: SHEET 2 OF 6

SEAL



TITLE

Korean BBQ of Utah
7157 S. State Street
Midvale, Utah, 84047

REVISIONS

- CORRECTION SVWRF 4-19-18
CORRECTION BLDG. 4-26-18

NO. ISSUE DATE

PROJECT DATA

PROJECT NUMBER :
DATE :
DRAWN BY :
CHECKED BY :
APPROVED BY :


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SHEET NAME

SOUTH VALLEY
MANHOLE
SPECIFICATIONS

SHEET NUMBER

A-4.3

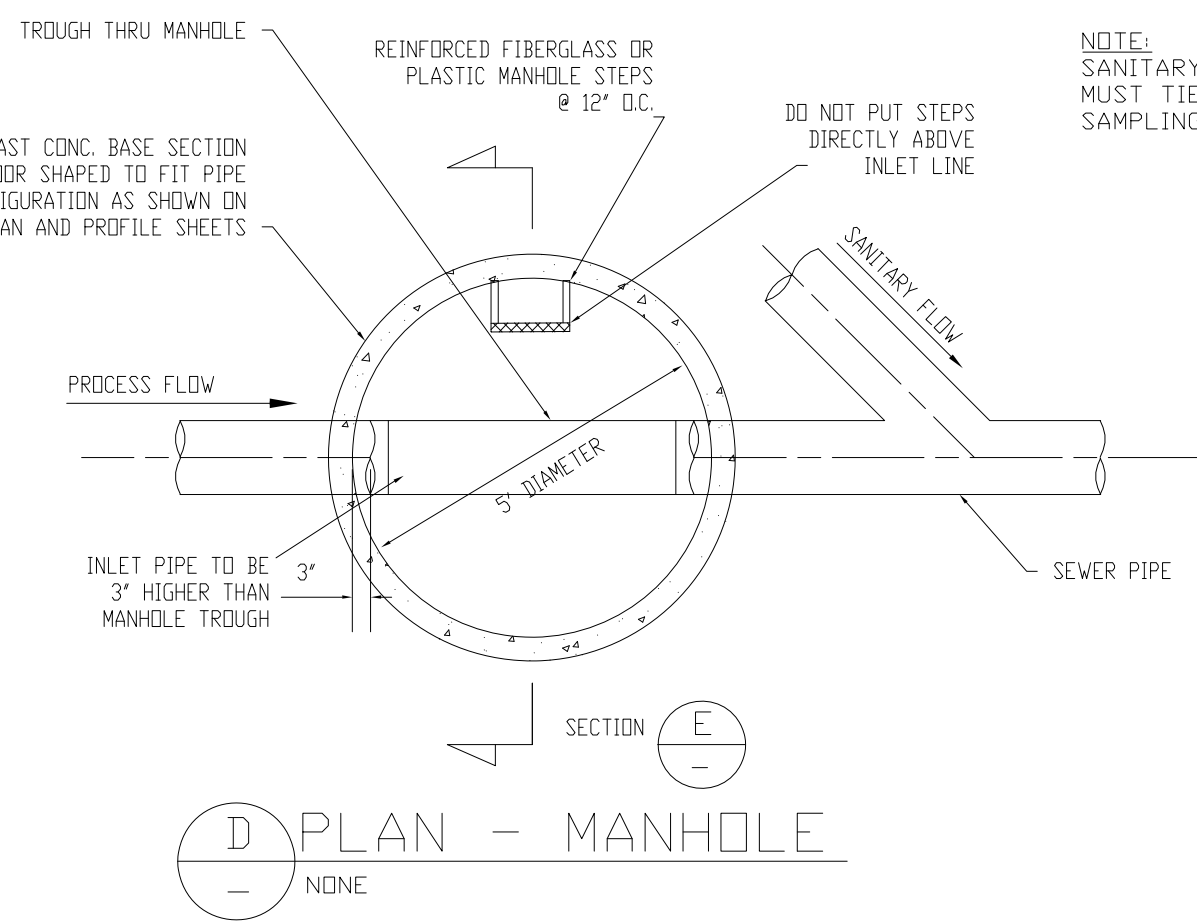



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B) TRUCK LOADING USING AN AASHTO H-20 TRUCK LOAD.
 8. MANHOLES OVER 4 FEET IN DEPTH WILL HAVE FIBERGLASS OR PLASTIC STEPS.
 9. ALL MANHOLES MUST HAVE ROUND NOTCHED COVERS WITH PICK HOLE FOR REMOVAL.
 10. BOTTOM OF INLET PIPE INTO MANHOLE MUST BE AT LEAST 3 INCHES ABOVE THE BOTTOM OF THE TROUGH THRU THE MANHOLE.
 11. NO CONE SECTION BY ITSELF.
 12. GROUT ALL PIPES IN OR OUT WITH FLUSH INSIDE/OUTSIDE OF BOX.
 13. INLET PIPE 2\"/>
 14. DO NOT LOCATE SAMPLING MANHOLE IN PARKING SPOTS.

DESIGNED BY:	12/9/08 (D.S.)	NOTES 11, 12 & 13, BEDDING NOTE.	DRAWN BY:	N. PALMER	CHECKED BY:	N. PALMER
DESIGNED BY:	J. MCDUGALL		DRAWN BY:	J. MCDUGALL	CHECKED BY:	N. PALMER
REV.	DATE	BY	DESCRIPTION			


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SV South Valley
WATER RECLAMATION FACILITY
7495 South 1300 West
West Jordan, Utah 84084
801.566.7711 F 801.566.7734

SOUTH VALLEY WATER RECLAMATION FACILITY
PRETREATMENT PROGRAM
SAMPLING MANHOLE, 7' AND DEEPER
DRAWN BY: SHEET 3 OF 6

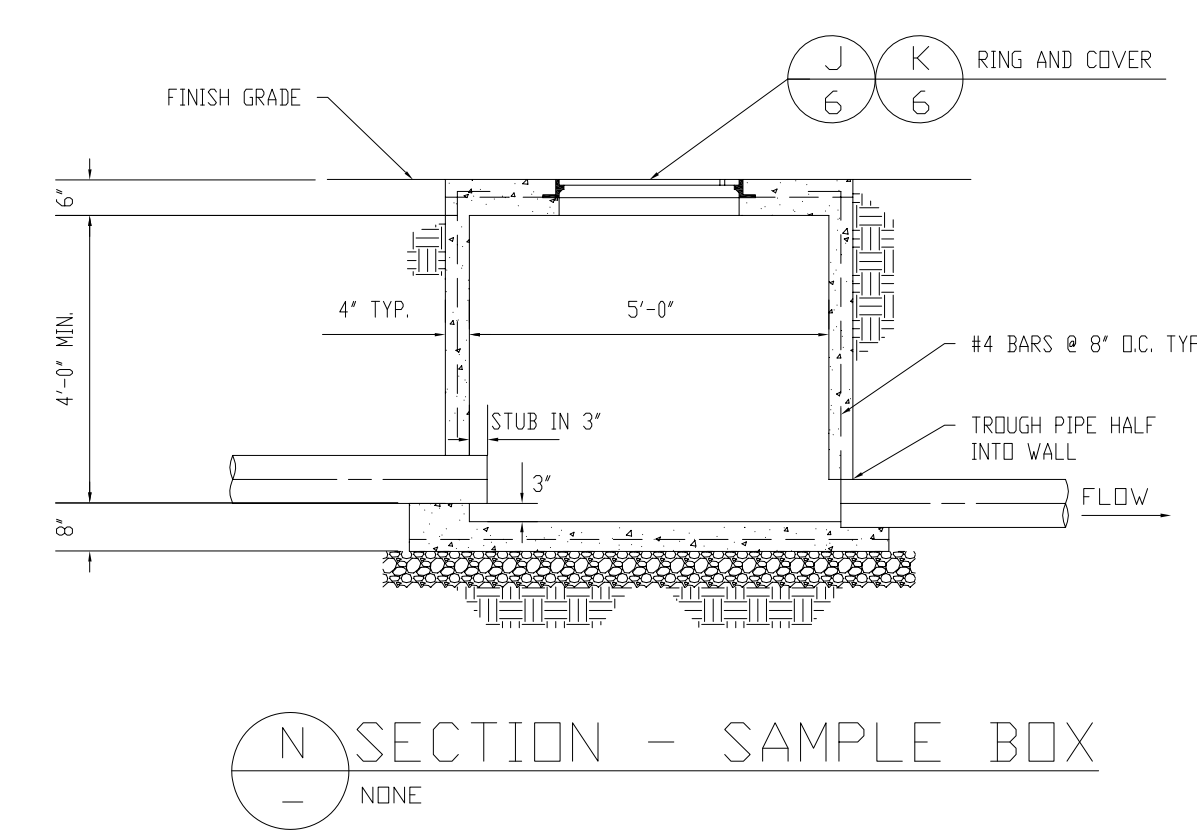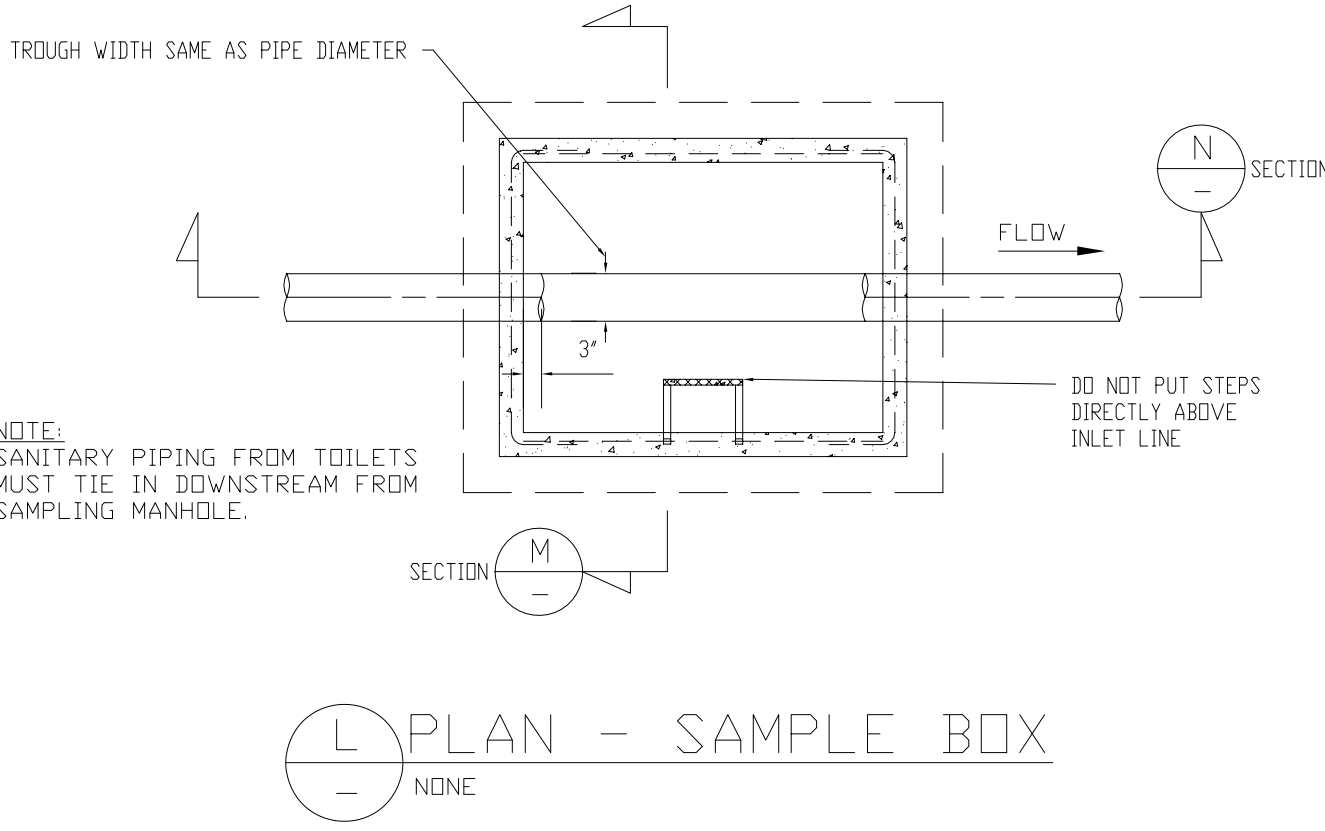

- NOTES:
1. PIPING, CLEANOUT CONFIGURATION, SIZE AND TYPE OF PIPING MATERIAL AS PER CITY OR SANITARY DISTRICT. INSPECTION BY SVWRF PRIOR TO BACKFILLING IS REQUIRED.
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B) TRUCK LOADING USING AN AASHTO H-20 TRUCK LOAD.
 8. MANHOLES OVER 4 FEET IN DEPTH WILL HAVE FIBERGLASS OR PLASTIC STEPS.
 9. ALL MANHOLES MUST HAVE ROUND NOTCHED COVERS WITH PICK HOLE FOR REMOVAL.
 10. BOTTOM OF INLET PIPE INTO MANHOLE MUST BE AT LEAST 3 INCHES ABOVE THE BOTTOM OF THE TROUGH THRU THE MANHOLE.
 11. 12\"/>
 12. ANY WATER THAT ENTERS SMH MUST LEAVE, NO PUDDLING.
 13. GROUT ALL PIPES IN/OUT FLUSH WITH SIDE OF BOX.
 14. INLET PIPE 2\"/>

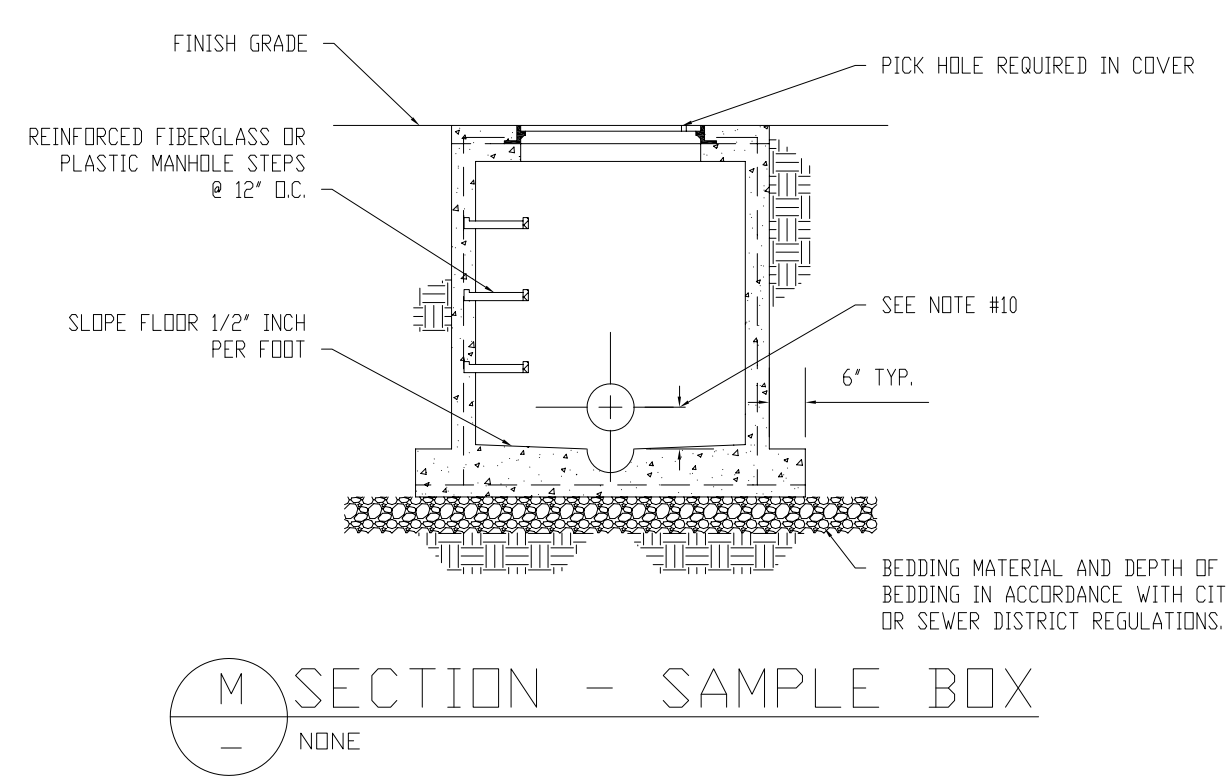


DESIGNED BY:	12/9/08 (D.S.)	NOTES 11, 12, 13 & 14, OUTLET PIPE IN (N) SECTION.	DRAWN BY:	N. PALMER	CHECKED BY:	N. PALMER
DESIGNED BY:	J. MCDUGALL		DRAWN BY:	J. MCDUGALL	CHECKED BY:	N. PALMER
REV.	DATE	BY	DESCRIPTION	*****	2001	

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SV South Valley
WATER RECLAMATION FACILITY
7495 South 1300 West
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801.566.7711 F 801.566.7734

SOUTH VALLEY WATER RECLAMATION FACILITY
PRETREATMENT PROGRAM
SAMPLING MANHOLE, BOX
DRAWN BY: SHEET 4 OF 6

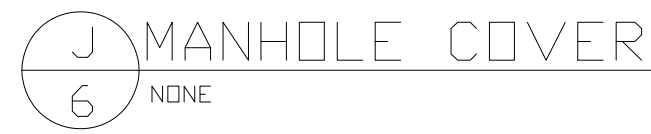

NOU
DESIGN PARTNERS

70 WILSHIRE BLVD. SUITE 930
S ANGELES, CA 90010

ARCHITECTURE BRANDING
INTERIOR BRANDING
PLANNING
LAND-USE CONSULTATION



Korean BBQ of Utah
7157 S. State Street
Midvale, Utah, 84047

SOUTH VALLEY WATER RECLAMATION FACILITY PRETREATMENT PROGRAM DETAILS		
DRAWING NO.:	SHEET 6 OF 6	REV.

ISSUE	DATE
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PROJECT DATA

PROJECT NUMBER : _____

DATE : _____

DRAWN BY : _____

CHECKED BY : _____

APPROVED BY : _____

SALE

EET NAME

SOUTH VALLEY MANHOLE SPECIFICATIONS

EET NUMBER

A-4.4

SEAL



TITLE

Korean BBQ of Utah
7157 S. State Street
Midvale, Utah, 84047

REVISIONS

NO. ISSUE DATE

PROJECT DATA

PROJECT NUMBER: 20180010
DATE: April 11, 2018
DRAWN BY: Jun Wen Wang
CHECKED BY: Jun Wen Wang
APPROVED BY:

SCALE

SHEET NAME


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SHEET NUMBER

S-1.1


NOTES:

1. SAW CUT WALL THROUGH VERTICALLY.
2. SAW CUT WALL ONE SIDE 6" DEEP HORIZONTALLY.
3. INSTALL ONE ANGLE.
4. SAW CUT THE OTHER SIDE HORIZONTALLY THROUGH.
5. INSTALL THE OTHER ANGLE.
6. BOLT BOTH ANGLE TOGETHER AS NOTED AND ALLOW EPOXY IN CMU TO SET.
7. REMOVING CMU TO CREATE OPENING.

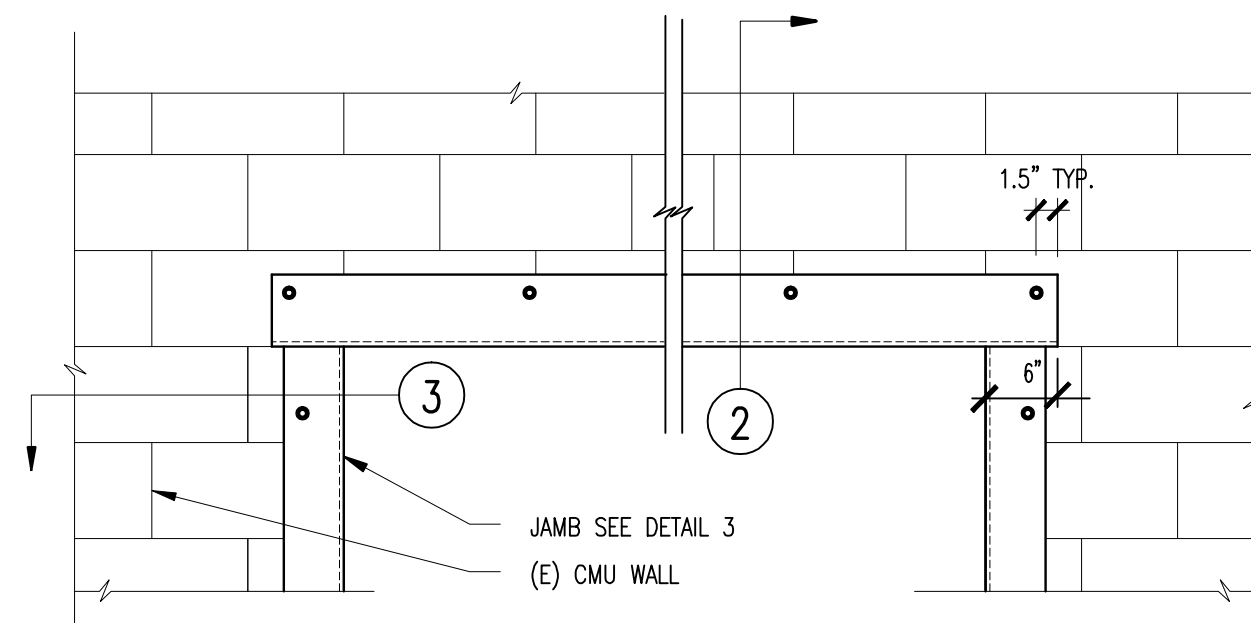

1 MAX. 7FT LINTEL ELEVATION

SCALE: 3/4" = 1'-0"

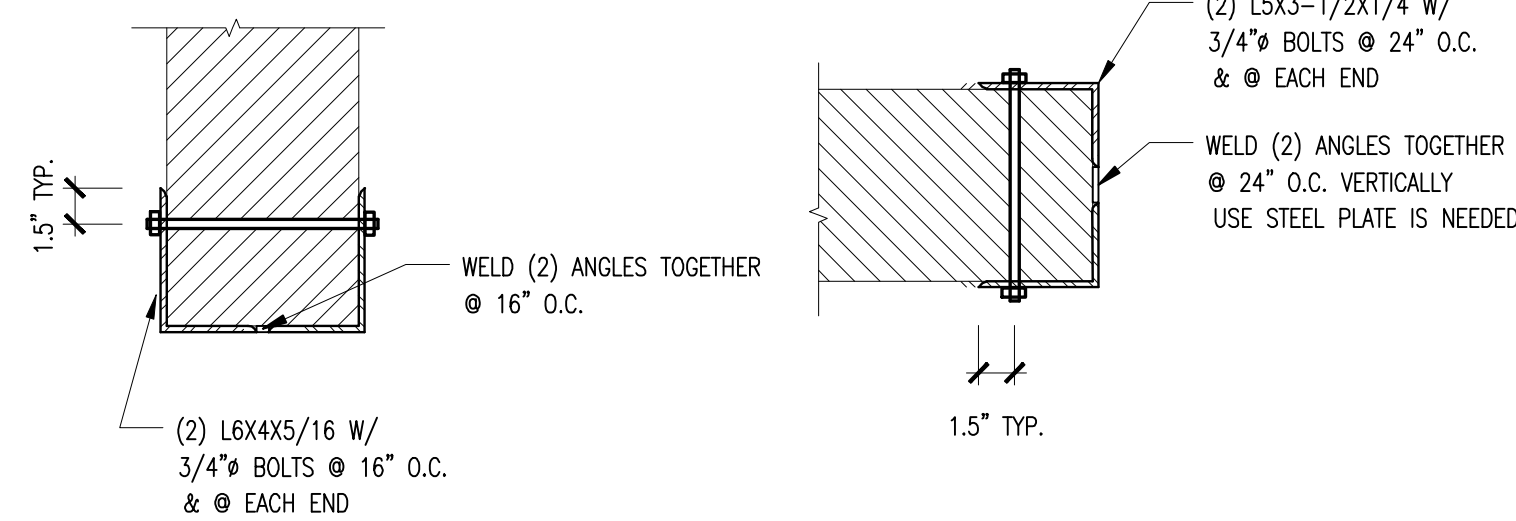


2 LINTEL DETAIL


SCALE: 1-1/2" = 1'-0"

3 JAMB DETAIL


SCALE: 1-1/2" = 1'-0"

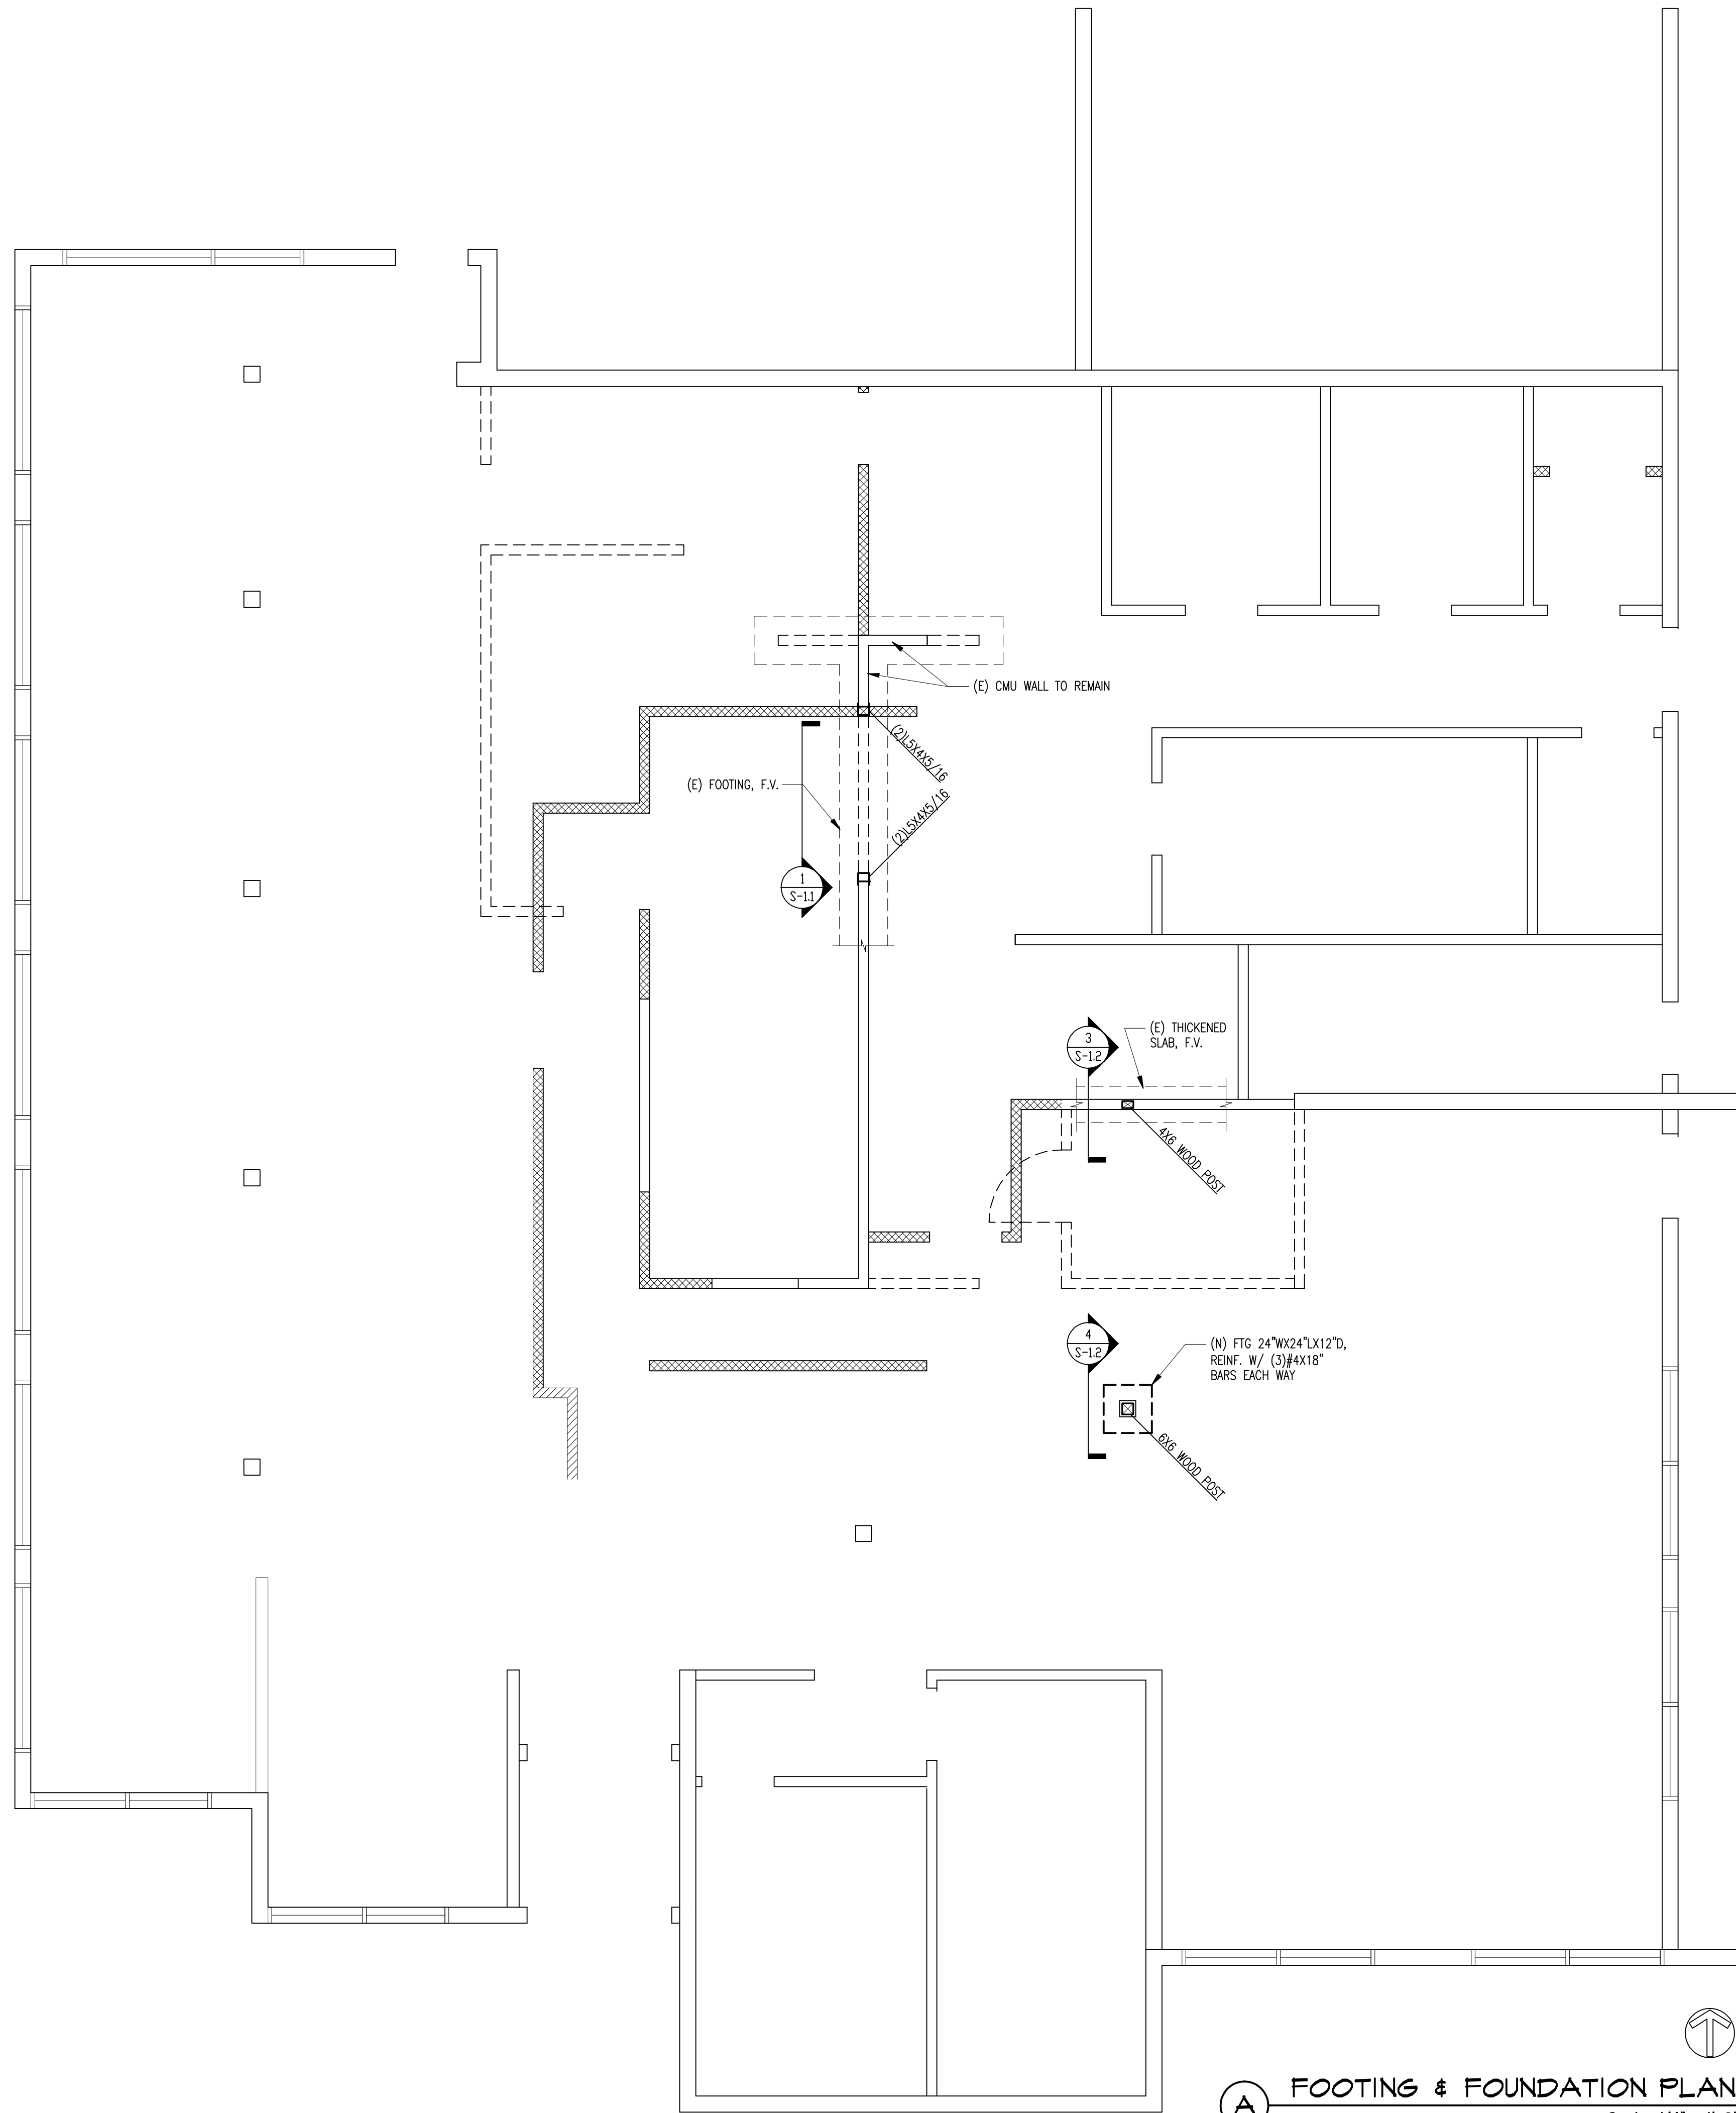


A FOOTING & FOUNDATION PLAN
Scale: 1/4" = 1'-0"

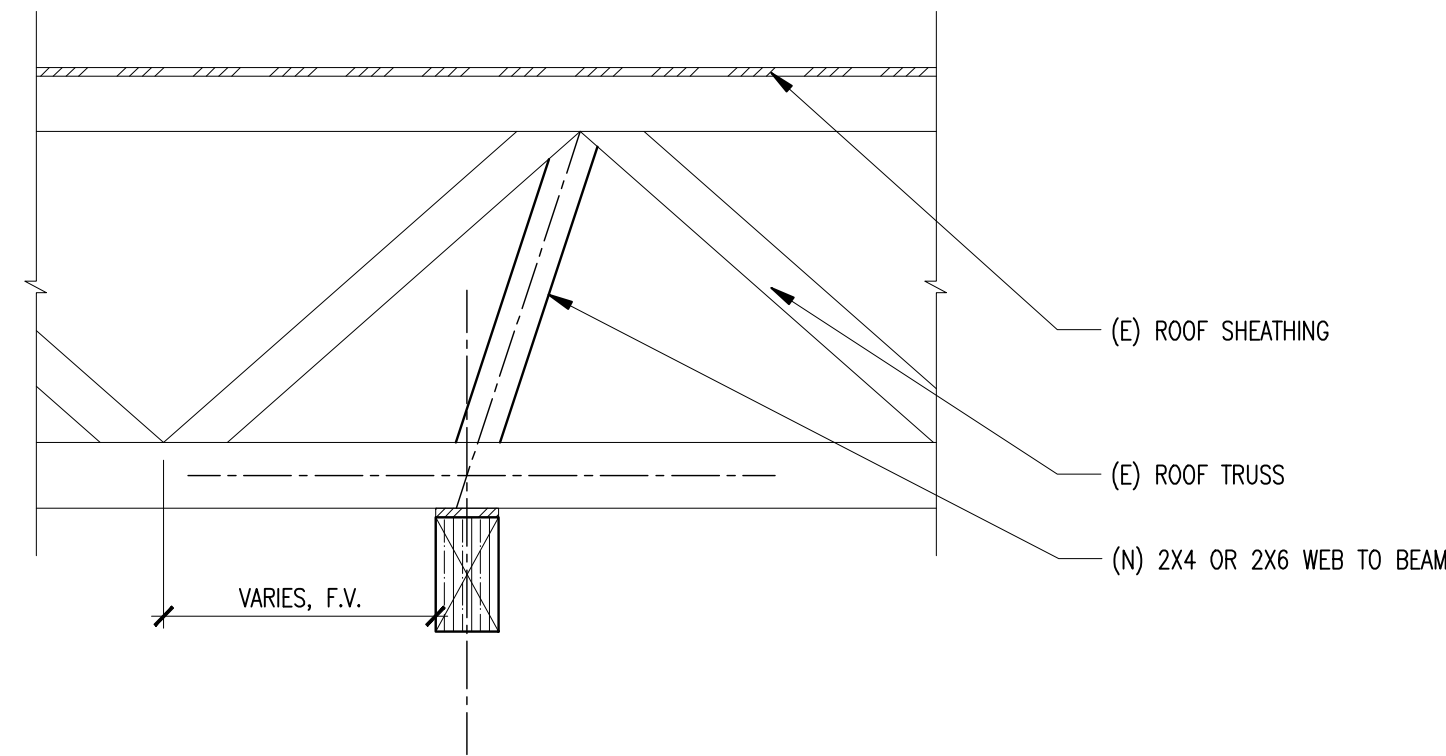


1 TRUSS BEARING DETAIL
SCALE: 3/4" = 1'-0"

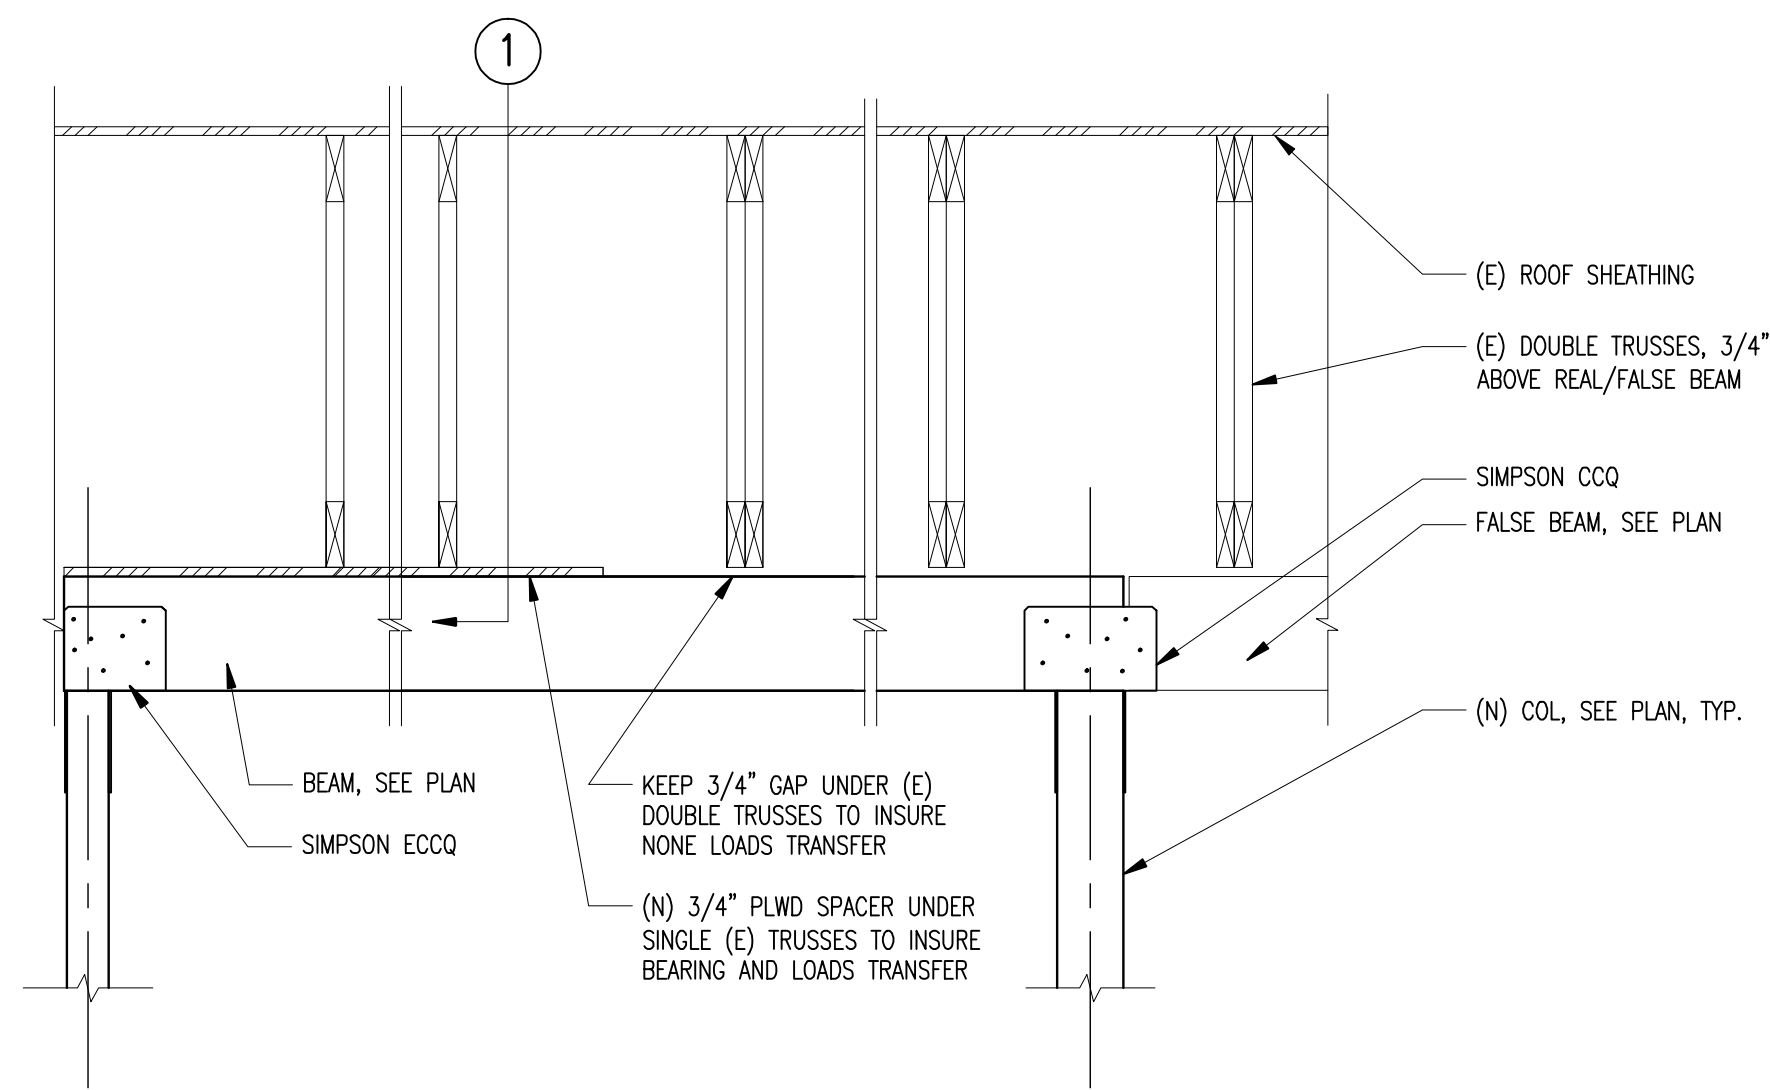


2 BEAM BEARING DETAIL
SCALE: 3/4" = 1'-0"

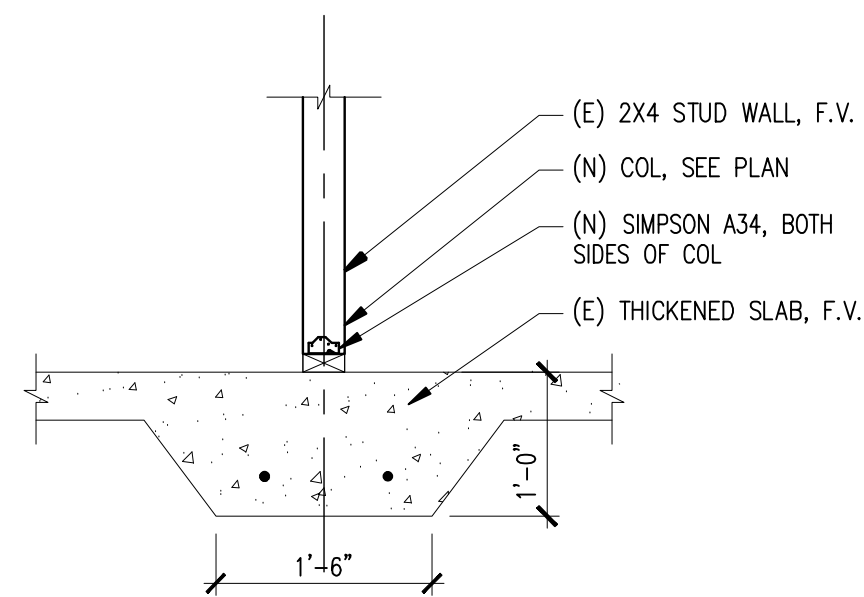

3 COLUMN BEARING DETAIL
SCALE: 3/4" = 1'-0"

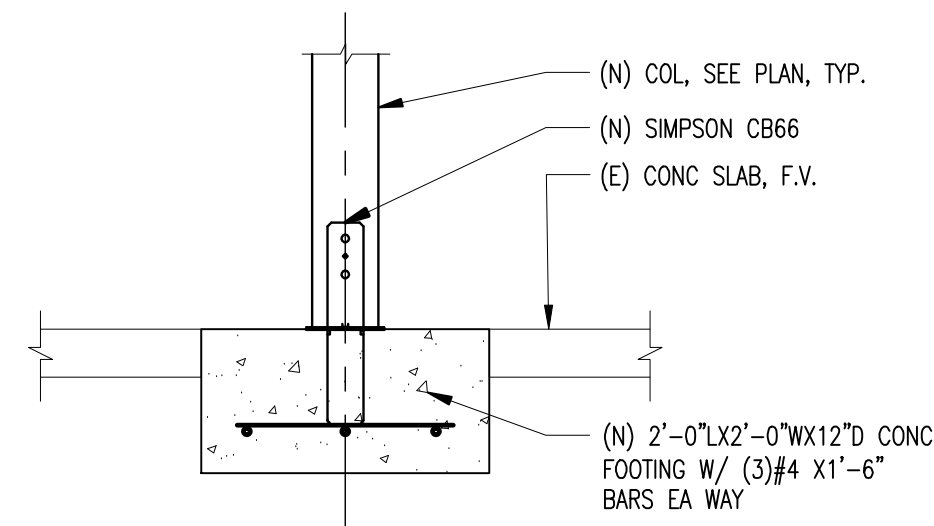

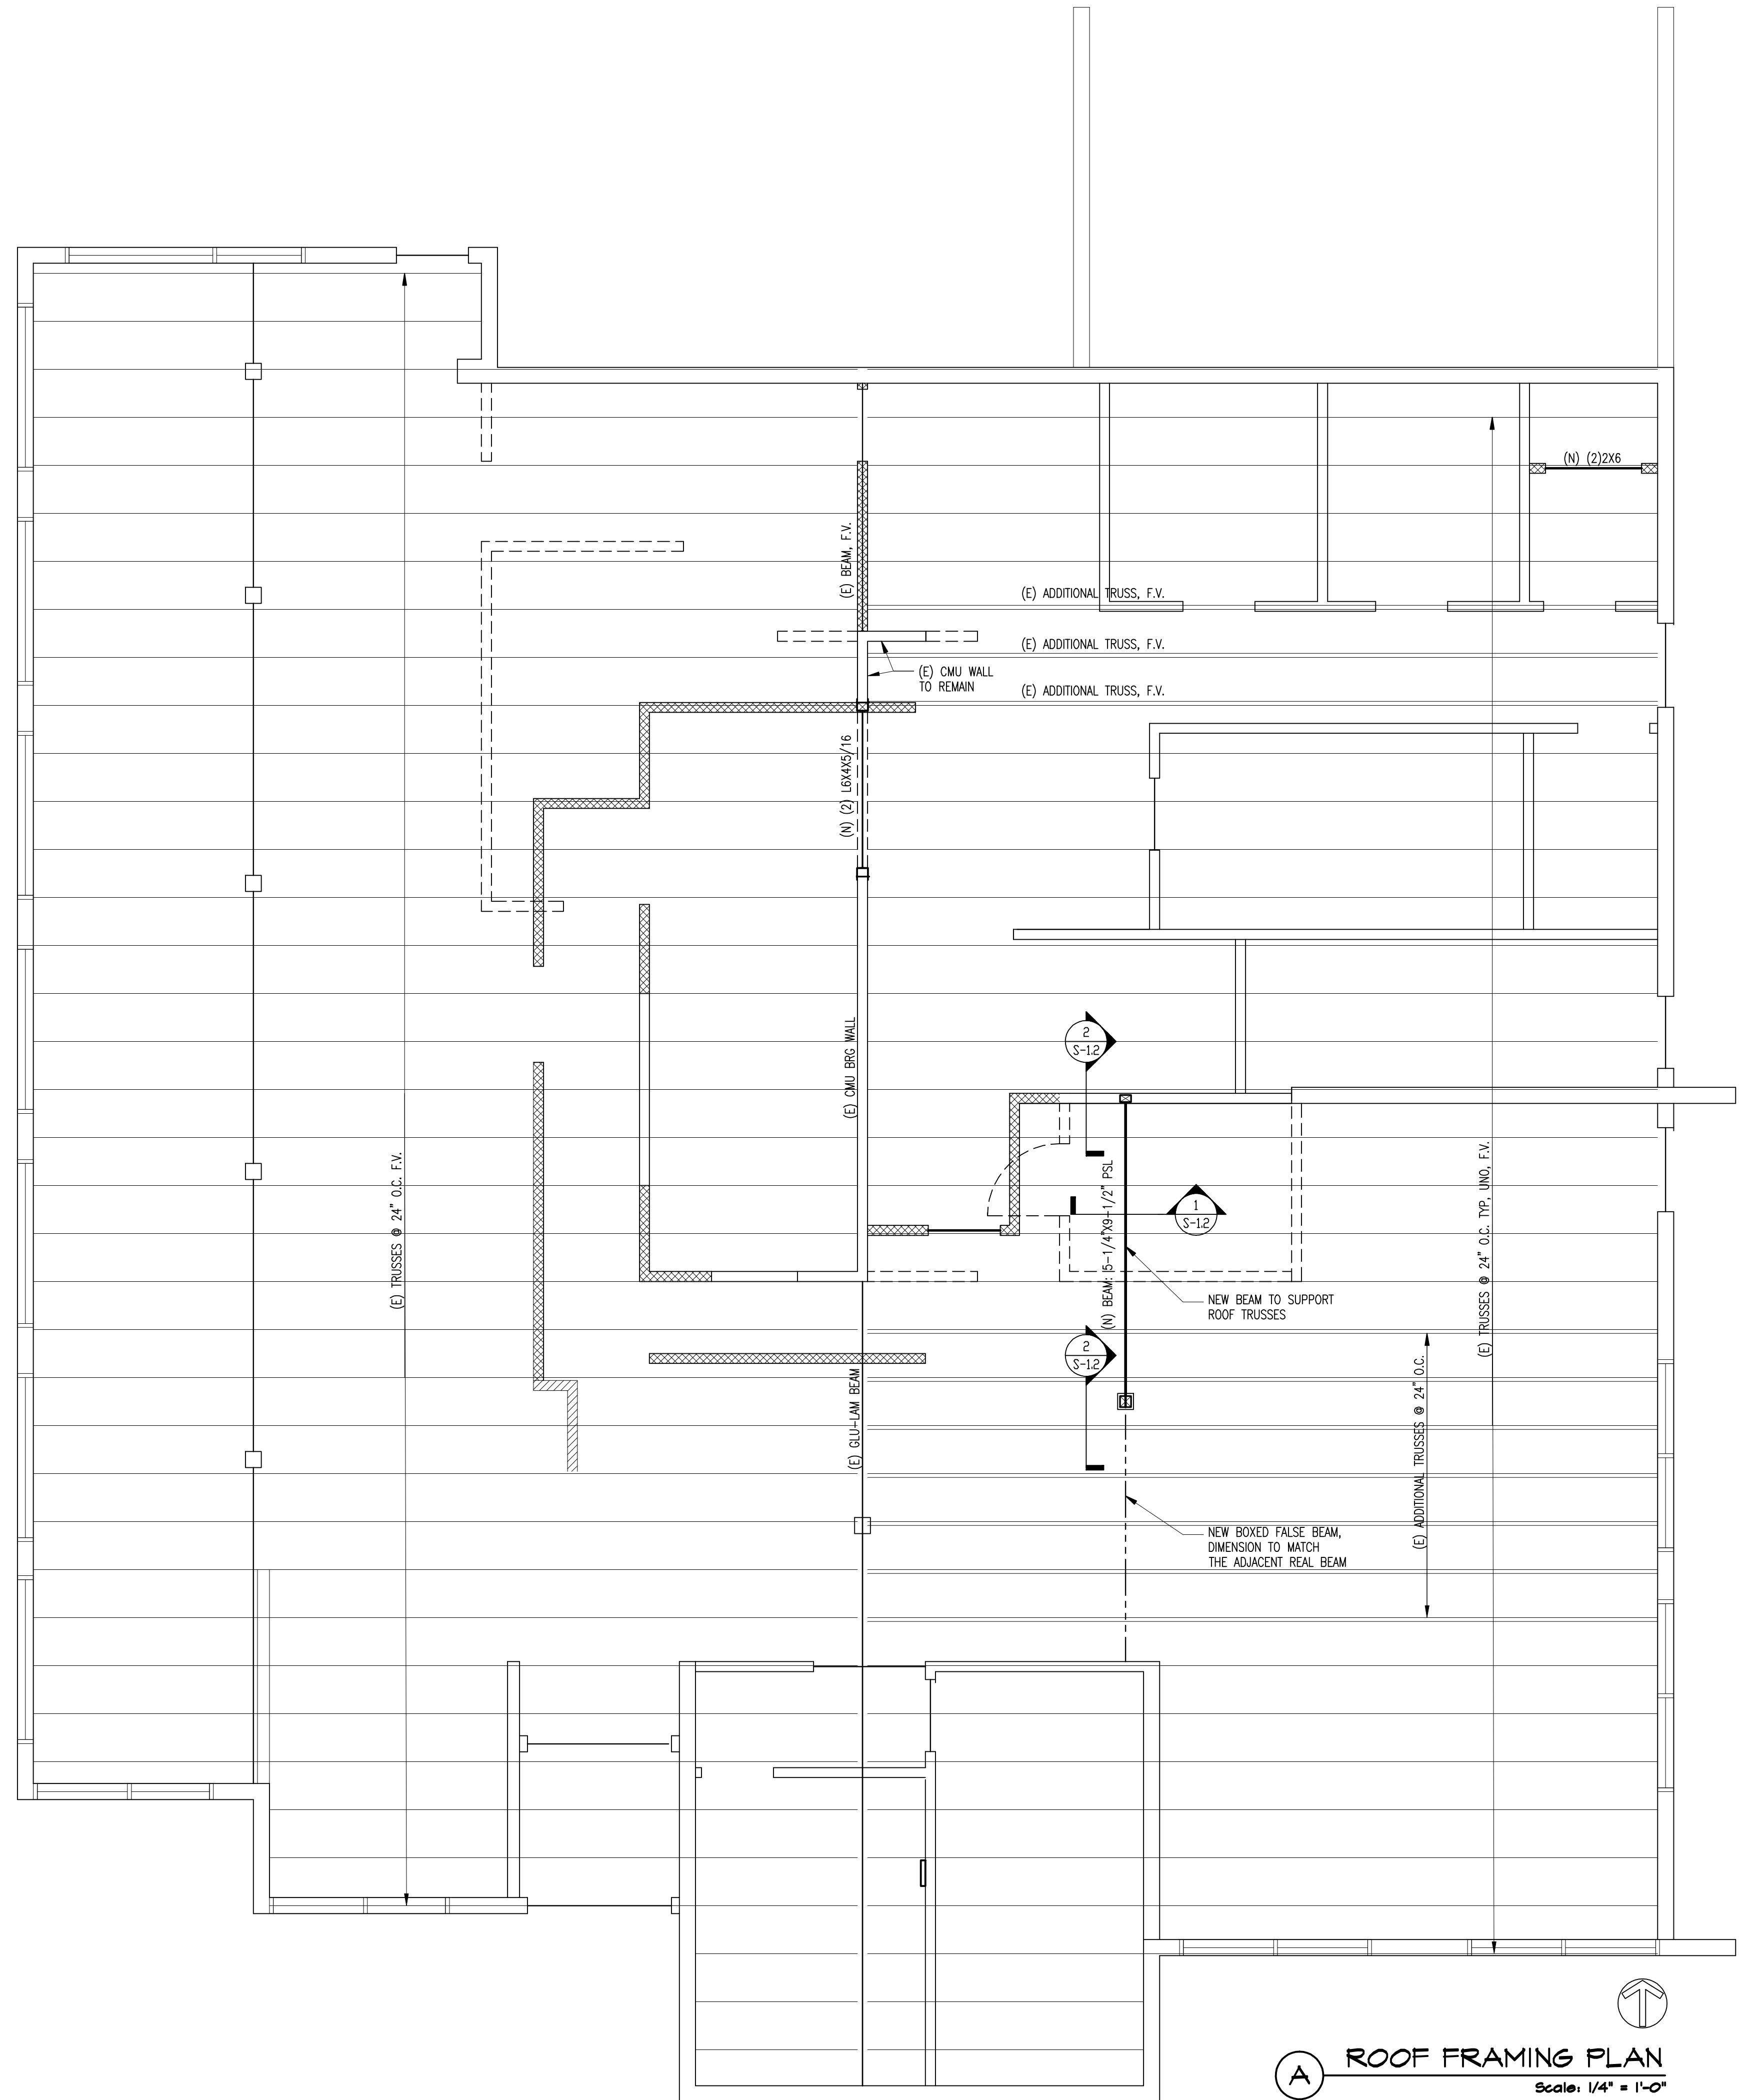


4 COLUMN BEARING DETAIL
SCALE: 3/4" = 1'-0"









A ROOF FRAMING PLAN
Scale: 1/4" = 1'-0"

PACKAGED ROOF TOP AIR CONDITIONING UNIT SCHEDULE

SYMBOL	* MANUFACTURER & MODEL NO.	NOMINAL CAPACITY (TONS)	LOCATION	AREA SERVED	CFM	COOLING CAPACITY BTUH			GAS HEATING CAPACITY, MBH					SUPPLY FAN				ELECTRICAL ELECTRICAL							RA FILTER (NO) & DIM. (IN.)	MIN. OSA (CFM)	UNIT SIZE (LxWxH) (IN)	OPERATING WEIGHT (LBS)	REMARKS	
						TOTAL	SENSIBLE	EER	STAGE 1		STAGE 2		EFF(%)	DRIVE	E.S.P.	RPM	BHP	VOLT/ø/Hz	COMPRESSOR			SUPPLY FAN FLA	COND. FAN FLA	MCA						MOCP
									IN	OUT	IN	OUT							QTY	RLA	LRA									
	TRANE YSC090F3EH	7.5	ROOF	DINING	3000	92,500	74,000	11.2	140	112	200	160	80	BELT	0.8	1077	1.67	208/3/60	1	25	164	9.4	3.3	44	60	(2)16x25x2	400	88x53x41	710	①②③④⑤
	TRANE YSC090F3EH	7.5	ROOF	DINING & RESTROOMS	3000	92,500	74,000	11.2	140	112	200	160	80	BELT	0.8	1077	1.67	208/3/60	1	25	164	9.4	3.3	44	60	(2)16x25x2	400	88x53x41	710	①②③④⑤
	TRANE YSC060G3EH	5	ROOF	KITCHEN	1900	60,000	48,000	12.0	150	121.5	—	—	81	DIRECT	0.62	1052	0.8	208/3/60	1	15.9	110	5.0	1.4	31	45	(4)16x16x2	200	70x44x41	520	①②③④

REMARKS: ① PROVIDE 14" HIGH PRE-FABRICATED ROOF CURB WITH BOTTOM SHAPED PER ROOF SLOPE. ② PROVIDE PROGRAMMABLE THERMOSTAT. ③ PROVIDE MANUAL DAMPER FOR UP TO 20% OSA INTAKE. ④ PROVIDE DUCT SMOKE DETECTOR TO SHUT OFF UNIT ON DETECTION OF SMOKE IN RETURN AIR DUCT. ⑤ PROVIDE OVERSIZED MOTOR AND DRIVE FOR SUPPLY FAN.
* OR APPROVED EQUAL

MAKE-UP AIR UNIT SCHEDULE

SYMBOL	*MANUFACTURER & MODEL NO.	LOCATION	AREA SERVED	AIR FLOW (CFM)	INDIRECT GAS HEATING						EVAPORATIVE COOLING					SUPPLY FAN					ELECTRICAL			UNIT SIZE (WxLxH) (IN)	OPERATING WEIGHT (LBS)	INTERLOCKED WITH	REMARKS
					INPUT (MBH)	OUTPUT (MBH)	EFF(%)	STAGE	EAT(°F)	LAT(°F)	EDB(°F)	LDB(°F)	COOLING MEDIA	WATER	DRAIN	QTY.	ESP	TSP	RPM	HP	VOLT/ø/Hz	MCA	MOCP				
	GREENHECK IGX-109-H12	ROOF	DINING AREA	1600	150	120	80	4	20.0	90	95	72	GLASDEK	1/2"	3/4"	1	0.6	0.76	1097	1	208/3/60	7.7	15	45x106x39	1070	EF-1	①②③④
	GREENHECK IGX-109-H12	ROOF	DINING AREA	1600	150	120	80	4	20.0	90	95	72	GLASDEK	1/2"	3/4"	1	0.6	0.76	1097	1	208/3/60	7.7	15	45x106x39	1070	EF-2	①②③④
	GREENHECK IGX-109-H12	ROOF	DINING AREA	2200	200	160	80	4	20.0	90	95	72	GLASDEK	1/2"	3/4"	1	0.6	0.88	1271	1.5	208/3/60	10.2	15	45x106x39	1100	EF-3	①②③④
	GREENHECK IGX-109-H12	ROOF	DINING AREA	1200	120	96	80	4	20.0	90	95	72	GLASDEK	1/2"	3/4"	1	0.6	0.69	1390	1	208/3/60	7.7	15	45x106x39	1070	EF-4	①②③④
	GREENHECK IGX-109-H12	ROOF	DINING AREA	1400	140	112	80	4	20.0	90	95	72	GLASDEK	1/2"	3/4"	1	0.6	0.72	1507	1	208/3/60	7.7	15	45x106x39	1070	EF-5	①②③④
	GREENHECK IGX-109-H12	ROOF	KITCHEN	1600	150	120	80	4	20.0	90	95	72	GLASDEK	1/2"	3/4"	1	0.6	0.76	1097	1	208/3/60	7.7	15	45x106x39	1070	EF-6	①②③④

REMARKS: ① PROVIDE ROOF CURB WITH BOTTOM SHAPED PER ROOF SLOPE. ② AUTO DRAIN AND FLUSH. ③ TEMPERATURE CONTROLS. ④ 100% OUTSIDE AIR, CONSTANT VOLUME

EXHAUST FAN SCHEDULE

SYMBOL	* MANUF'R & MODEL NO.	SERVING AREA	TYPE	DRIVE	CFM	FAN RPM	E.S.P. IN. WC	MOTOR HP	VOLT/PH/Hz	OPERATING WEIGHT LBS	** CONTROLLED BY	REMARKS
	GREENHECK USF-312-BI	DINING TABLE GROUP A	UPBLAST CENTRIFUGAL	BELT	1600	2548	2.5	1½	208/3ø/60	140	TEMPERATURE SENSOR	WITH EXTERNAL DISCONNECT SWITCH, GREASE COLLECTION BOX, VENTED FACTORY CURB, HINGED BASE, UL705 & UL 762 LISTED. ** PROVIDE ON/OFF CONTROL SWITCH TO OVERRIDE AUTOMATIC CONTROL SENSOR TO BE USED IN CASE OF TEMPERATURE SENSOR MALFUNCTION.
	GREENHECK USF-312-BI	DINING TABLE GROUP B	UPBLAST CENTRIFUGAL	BELT	1600	2548	2.5	1½	208/3ø/60	140	TEMPERATURE SENSOR	
	GREENHECK USF-313-BI	DINING TABLE GROUP C	UPBLAST CENTRIFUGAL	BELT	2200	2416	2.5	2	208/3ø/60	160	TEMPERATURE SENSOR	
	GREENHECK CUBE-161XP	DINING TABLE GROUP D	UPBLAST CENTRIFUGAL	BELT	1200	2380	2.25	1	208/3ø/60	85	TEMPERATURE SENSOR	
	GREENHECK CUBE-161XP	DINING TABLE GROUP E	UPBLAST CENTRIFUGAL	BELT	1400	2450	2.25	1½	208/3ø/60	90	TEMPERATURE SENSOR	
	GREENHECK CUBE-161HP	KITCHEN	UPBLAST CENTRIFUGAL	BELT	1800	1590	1.5	1	208/3ø/60	85	TEMPERATURE SENSOR	
	GREENHECK GB-071	WOMEN'S RESTROOM	DOWNBLAST CENTRIFUGAL	BELT	160	1285	0.5	1/6	120/1ø/60	55	LIGHTING SWITCH	WITH BACKDRAFT DAMPER, ROOF CURB CAP, BIRD SCREEN.
	GREENHECK GB-071	MEN'S RESTROOM	DOWNBLAST CENTRIFUGAL	BELT	130	1212	0.5	1/6	120/1ø/60	55	LIGHTING SWITCH	

REMARKS: * OR APPROVED EQUAL.

HOOD EXHAUST & MAKE-UP AIR CALCULATION

HOOD #	HOOD #1	HOOD #2	HOOD #2	HOOD #2	HOOD #2	HOOD #2
HOOD TYPE & NO. OF OPEN SIDE	TYPE-I, 2	TYPE-I, 4 (ISLAND)	TYPE-I, 4 (ISLAND)	TYPE-I, 4 (ISLAND)	TYPE-I, 4 (ISLAND)	TYPE-I, 4 (ISLAND)
QUANTITY	1	8	8	11	6	7
SERVING EXHAUST FAN/ AIR VOLUME	EF-6 (1800 CFM)	EF-1 (1600 CFM)	EF-2 (1600 CFM)	EF-3 (2200 CFM)	EF-4 (1200 CFM)	EF-5 (1400 CFM)
HOOD SIZE	8'-6" WIDE x 4'-0" DEEP	12'ø	12'ø	12'ø	12'ø	12'ø
FORMULA	Q=200 x LIN. FT.	Q=200 x AREA	Q=200 x AREA	Q=200 x AREA	Q=200 x AREA	Q=200 x AREA
EXHAUST AIR VOLUME PER HOOD	1800 CFM	200 CFM	200 CFM	200 CFM	200 CFM	200 CFM
EXHAUST DUCT SIZE	14'ø	6"x6"	6"x6"	6"x6"	6"x6"	6"x6"
AIR VELOCITY IN DUCT	1684 FPM	800 FPM	800 FPM	800 FPM	800 FPM	800 FPM
FILTER, NUMBER & SIZE	(6) 16"x16"	CUSTOM MADE	CUSTOM MADE	CUSTOM MADE	CUSTOM MADE	CUSTOM MADE
FILTER TYPE	BAFFLE	BAFFLE	BAFFLE	BAFFLE	BAFFLE	BAFFLE
HOOD STATIC PRESSURE	0.47" W.C	0.5" W.C	0.5" W.C	0.5" W.C	0.5" W.C	0.5" W.C
SERVING MAKE-UP AIR UNIT	MAU-6	MAU-1	MAU-2	MAU-3	MAU-4	MAU-5
MAKE-UP AIR VOLUME	1600 CFM (89%)	1600 CFM (100%)	1600 CFM (100%)	2200 CFM (100%)	1200 CFM (100%)	1400 CFM (100%)
SERVING EQUIPMENT	GAS BURNER, FRYER	TABLE BURNER	TABLE BURNER	TABLE BURNER	TABLE BURNER	TABLE BURNER

AIR BALANCE SCHEDULE

INTERLOCKED EQUIPMENT	EXHAUST AIR (CFM)	MAKE-UP AIR (CFM)	OSA (CFM)	BALANCE
EF-1, EF-2, EF-3, EF-4, EF-5	-8,000			0
MAU-1, MAU-2, MAU-3, MAU-4, MAU-5		+8,000		
DINING TOTAL	-8,000	+8,000		
EF-6	-1800			
MAU-6		+1600		0
AC-3			+200	
KITCHEN TOTAL	-1800	+1600	+200	

FIRE EXTINGUISHING SYSTEM NOTES

- FIRE EXTINGUISHING SYSTEM SHALL BE DESIGNED TO PROVIDE FIRE PROTECTION FOR TYPE-I HOODS, COOKING APPLIANCES AND GREASE DUCTS.
- FIRE EXTINGUISHING SYSTEM SHALL BE INSTALLED IN ACCORDANCE WITH 2015 INTERNATIONAL MECHANICAL CODE, UL 300, NFPA 17A AND NFPA 96.
- UPON FIRE EXTINGUISHING SYSTEM ACTIVATION: ALL ELECTRICAL UNDER THE HOOD SHALL SHUT OFF, GAS SUPPLY SHALL SHUT OFF, MAKE-UP AIR INTERNAL TO HOOD SHALL SHUT OFF EXHAUST AIR SHALL REMAIN ON AND FIRE SYSTEM SHALL BE INTERCONNECTED TO FIRE ALARM.
- FIRE EXTINGUISHING SYSTEM PLANS SUBMITTAL IS SEPARATE, NOT PART OF MECHANICAL SUBMITTAL AND SHALL BE SUBMITTED UNDER SEPARATE PERMIT APPLICATION.

AIR DIFFUSER/GRILLE SCHEDULE

SYMBOL & DESCRIPTION	* MANUF'R & MODEL NUMBER	NECK SIZE (INCHES)	CFM	MAX. NECK VELOCITY	MAX. NC	PRESS. DROP IN. W.C.	REMARKS
SIDEWALL SUPPLY AIR DIFFUSER	TITUS 300RL	20 x 6	0 - 440	600	20	0.06	¾" BLADE SPACING, INDIVIDUALLY ADJUSTABLE DOUBLE BLADES, FRONT BLADES PARALLEL TO LONG DIMENSION, OPPOSED BLADE DAMPER
CEILING SUPPLY AIR DIFFUSER	TITUS MCD	8 x 8 12 x 12 14 x 14 16 x 16 20 x 20	0 - 220 350 - 500 500 - 680 680 - 850 1000 - 1150	600	20	0.06	MODULAR CORE DIFFUSER, TYPE 3 FOR LAY-IN T-BAR CEILINGS, TYPE 1 FOR GYPSBOARD CEILINGS.
SIDEWALL RETURN AIR GRILLE	TITUS 350RL	30 x 12	0 - 1300	600	20	0.06	¾" BLADE SPACING, 35° DEFLECTION, BLADE PARALLEL TO LONG DIMENSION
CEILING RETURN/ EXHAUST AIR GRILLE	TITUS 50F	6 x 6 8 x 8 18 x 18	0 - 120 120 - 200 1000 - 1600	700	20	0.06	T-BAR CEILINGS OR HARD CEILINGS.

REMARKS: * OR APPROVED EQUAL. 1. MOUNTING FRAME TO BE COMPATIBLE WITH CEILING/WALL TYPE.

LEGEND & ABBREVIATIONS

SYMBOL	ABB.	DESCRIPTION	ABB.	DESCRIPTION
	SAD	SUPPLY AIR DUCT SECTION	AC	AIR CONDITIONING
	RAD	RETURN AIR DUCT SECTION	AP	ACCESS PANEL
	EAD	EXHAUST AIR DUCT SECTION	BAS	BUILDING AUTOMATION SYSTEM
	CAD	COMBUSTION AIR DUCT SECTION	B.D.D.	BACK DRAFT DAMPER
	(L)	LINED DUCTWORK	BHP	BRAKE HORSEPOWER
	CD	CEILING SUPPLY AIR DIFFUSER	CFM	CUBIC FEET PER MINUTE
	RAR	CEILING RETURN AIR REGISTER	COND.	CONDENSATE
	EAR	CEILING EXHAUST AIR REGISTER	D.B.	DRY BULB
	SWS	SIDEWALL SUPPLY REGISTER	DTR	DOWN THRU ROOF
	SWR	SIDEWALL RETURN REGISTER	EF	EXHAUST FAN
	SWE	SIDEWALL EXHAUST REGISTER	E.S.P.	EXTERNAL STATIC PRESSURE
	FCD	FLEXIBLE DUCT CONNECTION	F.P.I.	FINS PER INCH
	MVD	MANUAL VOLUME DAMPER	FIN. FLR.	FINISH FLOOR
	DL	DOOR LOUVER	FLA	FULL LOAD AMPS
	UC	UNDERCUT DOOR	HP	HORSEPOWER, HEAT PUMP
	T-STAT	THERMOSTAT	HWS	HEATING HOT WATER SUPPLY
	SA	SUPPLY AIR	KW	KILOWATTS
	RA	RETURN AIR	LRA	LOCKED ROTOR AMPS
	EA	EXHAUST AIR	MCA	MINIMUM CIRCUIT AMPS
	TA	TRANSFER AIR	MFS	MAXIMUM FUSE SIZE
	OSA	OUTSIDE AIR	MIN.	MINIMUM
	TYP.	TYPICAL	MOCP	MAXIMUM OVERCURRENT PROTECTION
	SF	SQUARE FOOT	NC	NOISE CRITERIA
	SFD	COMBINATION SMOKE AND FIRE DAMPER	OPD	OPPOSED BLADE DAMPER
	FD	FUSIBLE LINK FIRE DAMPER	PH	PHASE
	SD	DUCT MOUNTED SMOKE DETECTOR	PSI	POUNDS PER INCH
	(E)	EXISTING	PSIG	POUNDS PER SQUARE INCH GAGE
	(N)	NEW	PSIG	POUNDS PER SQUARE INCH GAGE
	POC	POINT OF CONNECTION	RLA	RATED LOAD AMPS
			UTR	UP THRU ROOF
			W.C.	WATER COLUMN

GENERAL NOTES

- COORDINATE ALL WORK WITH OTHER TRADES.
- ALL WORK AND MATERIAL SHALL BE PERFORMED AND INSTALLED IN COMPLIANCE WITH THE FOLLOWING CODES AS ADOPTED AND AMENDED BY THE INSPECTING AUTHORITY: 2015 INTERNATIONAL BUILDING CODE, 2015 INTERNATIONAL MECHANICAL CODE, 2015 INTERNATIONAL PLUMBING CODE, 2015 INTERNATIONAL FUEL GAS CODE, 2015 INTERNATIONAL ENERGY CONSERVATION CODE.
- CONTRACTOR SHALL FURNISH ALL LABOR, NEW MATERIALS, AND EQUIPMENT, TOOLS, TRANSPORTATION AND ANY OTHER SERVICES REQUIRED TO COMPLETE THE PROJECT PER DRAWINGS.
- BEFORE BEGINNING ANY WORK, CONTRACTOR SHALL THOROUGHLY EXAMINE AND VERIFY ALL EXISTING CONDITIONS, POINTS OF CONNECTION, SIZES, LOCATIONS, ELEVATIONS, ETC. CONTRACTOR SHALL NOTIFY TO PROJECT MANAGER OF ANY DISCREPANCIES BEFORE BEGINNING WORK.
- ALL SUPPLY AND RETURN DUCTWORK SHALL BE INSULATED IN CEILING SPACE UNLESS OTHERWISE NOTED ON PLAN.
- ALL DUCTWORK INSULATION SHALL BE PROVIDED WITH MINIMUM REQUIREMENTS AS FOLLOWS: EXPOSED ON ROOF R=8, IN ATTIC R=8, ABOVE T-BAR CEILING R=4.2
- AIR CONDITIONING UNIT SHALL BE INSTALLED IN ACCESSIBLE LOCATION FOR AIR BALANCE AND MAINTENANCE.
- ALL DUCTWORK SHALL BE CONSTRUCTED, ERECTED AND TESTED IN ACCORDANCE WITH THE APPLICABLE STANDARDS ADOPTED BY THE SHEET METAL AND AIR CONDITIONING CONTRACTORS NATIONAL ASSOCIATION (SMACNA).
- ALL PIPES PENETRATING WALLS & FLOOR SHALL BE SEALED AIRTIGHT WITH RESILIENT CAULKING AND PACKING.
- PROVIDE ACCESS PANELS FOR ALL SMOKE DETECTORS, MANUAL VOLUME DAMPERS ABOVE CONCEALED CEILING PANELS. COORDINATE ALL CEILING AND WALL ACCESS REQUIREMENTS WITH ARCHITECT. LOCATE VALVES IN EASILY ACCESSIBLE LOCATIONS.
- AIR BALANCING DAMPERS SHALL BE PROVIDED FOR BRANCH DUCT TAKE OFF AND EVERY AIR INLET, OUTLETS AND SHALL BE LOCATED AS FAR AWAY AS POSSIBLE FROM AIR OUTLET.
- LENGTH OF FLEXIBLE DUCT SHALL BE MAXIMUM 5 FEET IN LENGTH AT DIFFUSERS.
- ALL DUCT AND PIPE INSULATION AND AIR CONDITIONING EQUIPMENT SHALL BE CERTIFIED BY THE CALIFORNIA ENERGY COMMISSION.
- PROVIDE SMOKE/FIRE DAMPERS AT ALL DUCT PENETRATIONS THRU FIRE RATED WALLS AND THRU OCCUPANCY SEPARATION WALLS.
- DUCTWORK SHALL BE INSULATED OR LINED (L) AS NOTED ON DRAWINGS. ALL DUCTWORK EXPOSED ON ROOF SHALL BE INTERNALLY LINED UNLESS OTHERWISE INDICATED OR SPECIFIED. ALL DUCT SIZES ARE FREE AIR FLOW SIZES. ALL DUCT JOINTS SHALL BE SEALED. INSULATION SHALL HAVE A FLAME-SPREAD INDEX NOT EXCEEDING 25 AND A SMOKE DEVELOPED INDEX NOT EXCEEDING 50.
- ALL EQUIPMENTS DESIGNED TO BE FIXED IN POSITION SHALL BE SECURELY FASTENED IN PLACE PER BUILDING CODE REQUIREMENT.
- ROOF MOUNTED EQUIPMENT SHALL BE LABELED AS TO THE SPACE IT SERVES.
- ALL APPLIANCES AND PLUMBING VENTS AND DISCHARGE OUTLET OF EXHAUST FANS SHALL BE AT LEAST TEN (10) FEET IN A HORIZONTAL DIRECTION, OR THREE (3) FEET ABOVE THE OUTSIDE AIR INTAKES FOR HVAC UNITS.
- AIR DISTRIBUTION SYSTEMS SHALL BE EQUIPPED WITH SMOKE DETECTORS LISTED AND LABELED FOR INSTALLATION IN AIR DISTRIBUTION SYSTEMS. DUCT SMOKE DETECTORS SHALL COMPLY WITH UL 268A SMOKE DETECTORS SHALL BE INSTALLED IN RETURN AIR SYSTEMS WITH A DESIGN CAPACITY GREATER THAN 2000 CFM PER 2015 IMC SECTION 606.
- THE EXHAUST FAN SERVING A TYPE-I HOOD SHALL HAVE AUTOMATIC CONTROLS THAT WILL ACTIVATE THE FAN WHEN ANY APPLIANCE THAT REQUIRES SUCH TYPE-I HOOD IS TURNED ON, OR A MEANS OF INTERLOCK SHALL BE PROVIDED THAT WILL PREVENT OPERATION OF SUCH APPLIANCES WHEN THE EXHAUST FAN IS NOT TURNED ON PER IMC SECTION 507.1.1.

TYPE 1 EXHAUST HOOD & DUCT NOTES

- ALL PHASES OF INSTALLATION SHALL COMPLY WITH NFPA 96.
- PROVIDE OPENINGS WITH ACCESS PANEL IN EXHAUST AIR DUCTS TO ALLOW CLEANING AT ALL BENDS AND HORIZONTAL RUNS PER CMC 510.3
- EXHAUST DUCT SHALL BE CONSTRUCTED OF MIN. 16 GAUGE GALVANIZED STEEL OR 18 GAUGE STAINLESS STEEL.
- ALL SEAMS AND JOINTS OF EXHAUST DUCT SHALL HAVE LIQUID TIGHT CONTINUOUS EXTERNAL WELD OR EQUAL.
- EXHAUST FAN DISCHARGE OUTLET SHALL HAVE A MINIMUM OF 10 FT. OF CLEARANCE FROM THE OUTLET TO ADJACENT BUILDINGS, PROPERTY LINES, AIR INTAKES OR 3 FT. VERTICAL CLEARANCE PER NFPA 96.
- HORIZONTAL EXHAUST DUCT SHALL HAVE SLOPE NOT LESS THAN 1/4" PER FOOT TOWARD HOOD FOR DUCT LESS THAN 75 FEET LONG AND 1" PER FOOT SLOPE FOR DUCT LONGER THAN 75 FOOT LONG.
- EXHAUST DUCT TO BE PROTECTED FROM COMBUSTIBLES PER NFPA 96 AND LOCAL CODE.
- BUILDING PRESSURE SHALL NOT EXCEED 0.02" WATER COLUMN AT EXTERIOR DOORS.
- KITCHEN SHALL BE AIR BALANCED TO BE NEGATIVE WITH RESPECT TO THE REST OF AREAS.
- EXHAUST FAN AND MAKE-UP AIR UNIT SHALL BE INTERCONNECTED BY ELECTRICAL INTERLOCK.
- EXHAUST HOOD SHALL BE CONSTRUCTED OF MIN. 18 GAUGE GALVANIZED STEEL OR MIN. 20 GAUGE STAINLESS STEEL.
- EXHAUST HOOD SHALL OVERHANG COOKING EQUIPMENT 6" ON ALL OPEN SIDES.

MECHANICAL DRAWING LIST

DWG. NO.	TITLE
M-1	MECHANICAL LEGEND, NOTES AND SCHEDULES
M-2	MECHANICAL FLOOR PLAN - CONDITIONED AIR
M-3	MECHANICAL FLOOR PLAN - EXHAUST & MAKEUP AIR
M-4	MECHANICAL ROOF PLAN
M-5	MECHANICAL DETAILS
M-6	KITCHEN HOOD DETAILS
M-7	TABLE TOP HOOD DETAILS

WOU
DESIGN PARTNERS

3470 WILSHIRE BLVD., SUITE 930
LOS ANGELES, CA 90010

- ARCHITECTURE BRANDING
- INTERIOR BRANDING

Korean BBQ of Utah
7157 S. State Street
Midvale, Utah, 84047

REVISIONS

△ CORRECTION SWRF 4-19-18
△ CORRECTION BLDG. 4-28-18

NO. ISSUE DATE

PROJECT DATA

PROJECT NUMBER:
DATE: 4-9-18
DRAWN BY: JK
CHECKED BY: ML
APPROVED BY:


SCALE

SHEET NAME

**MECHANICAL FLOOR PLAN -
CONDITIONED AIR**

SHEET NUMBER

M-2

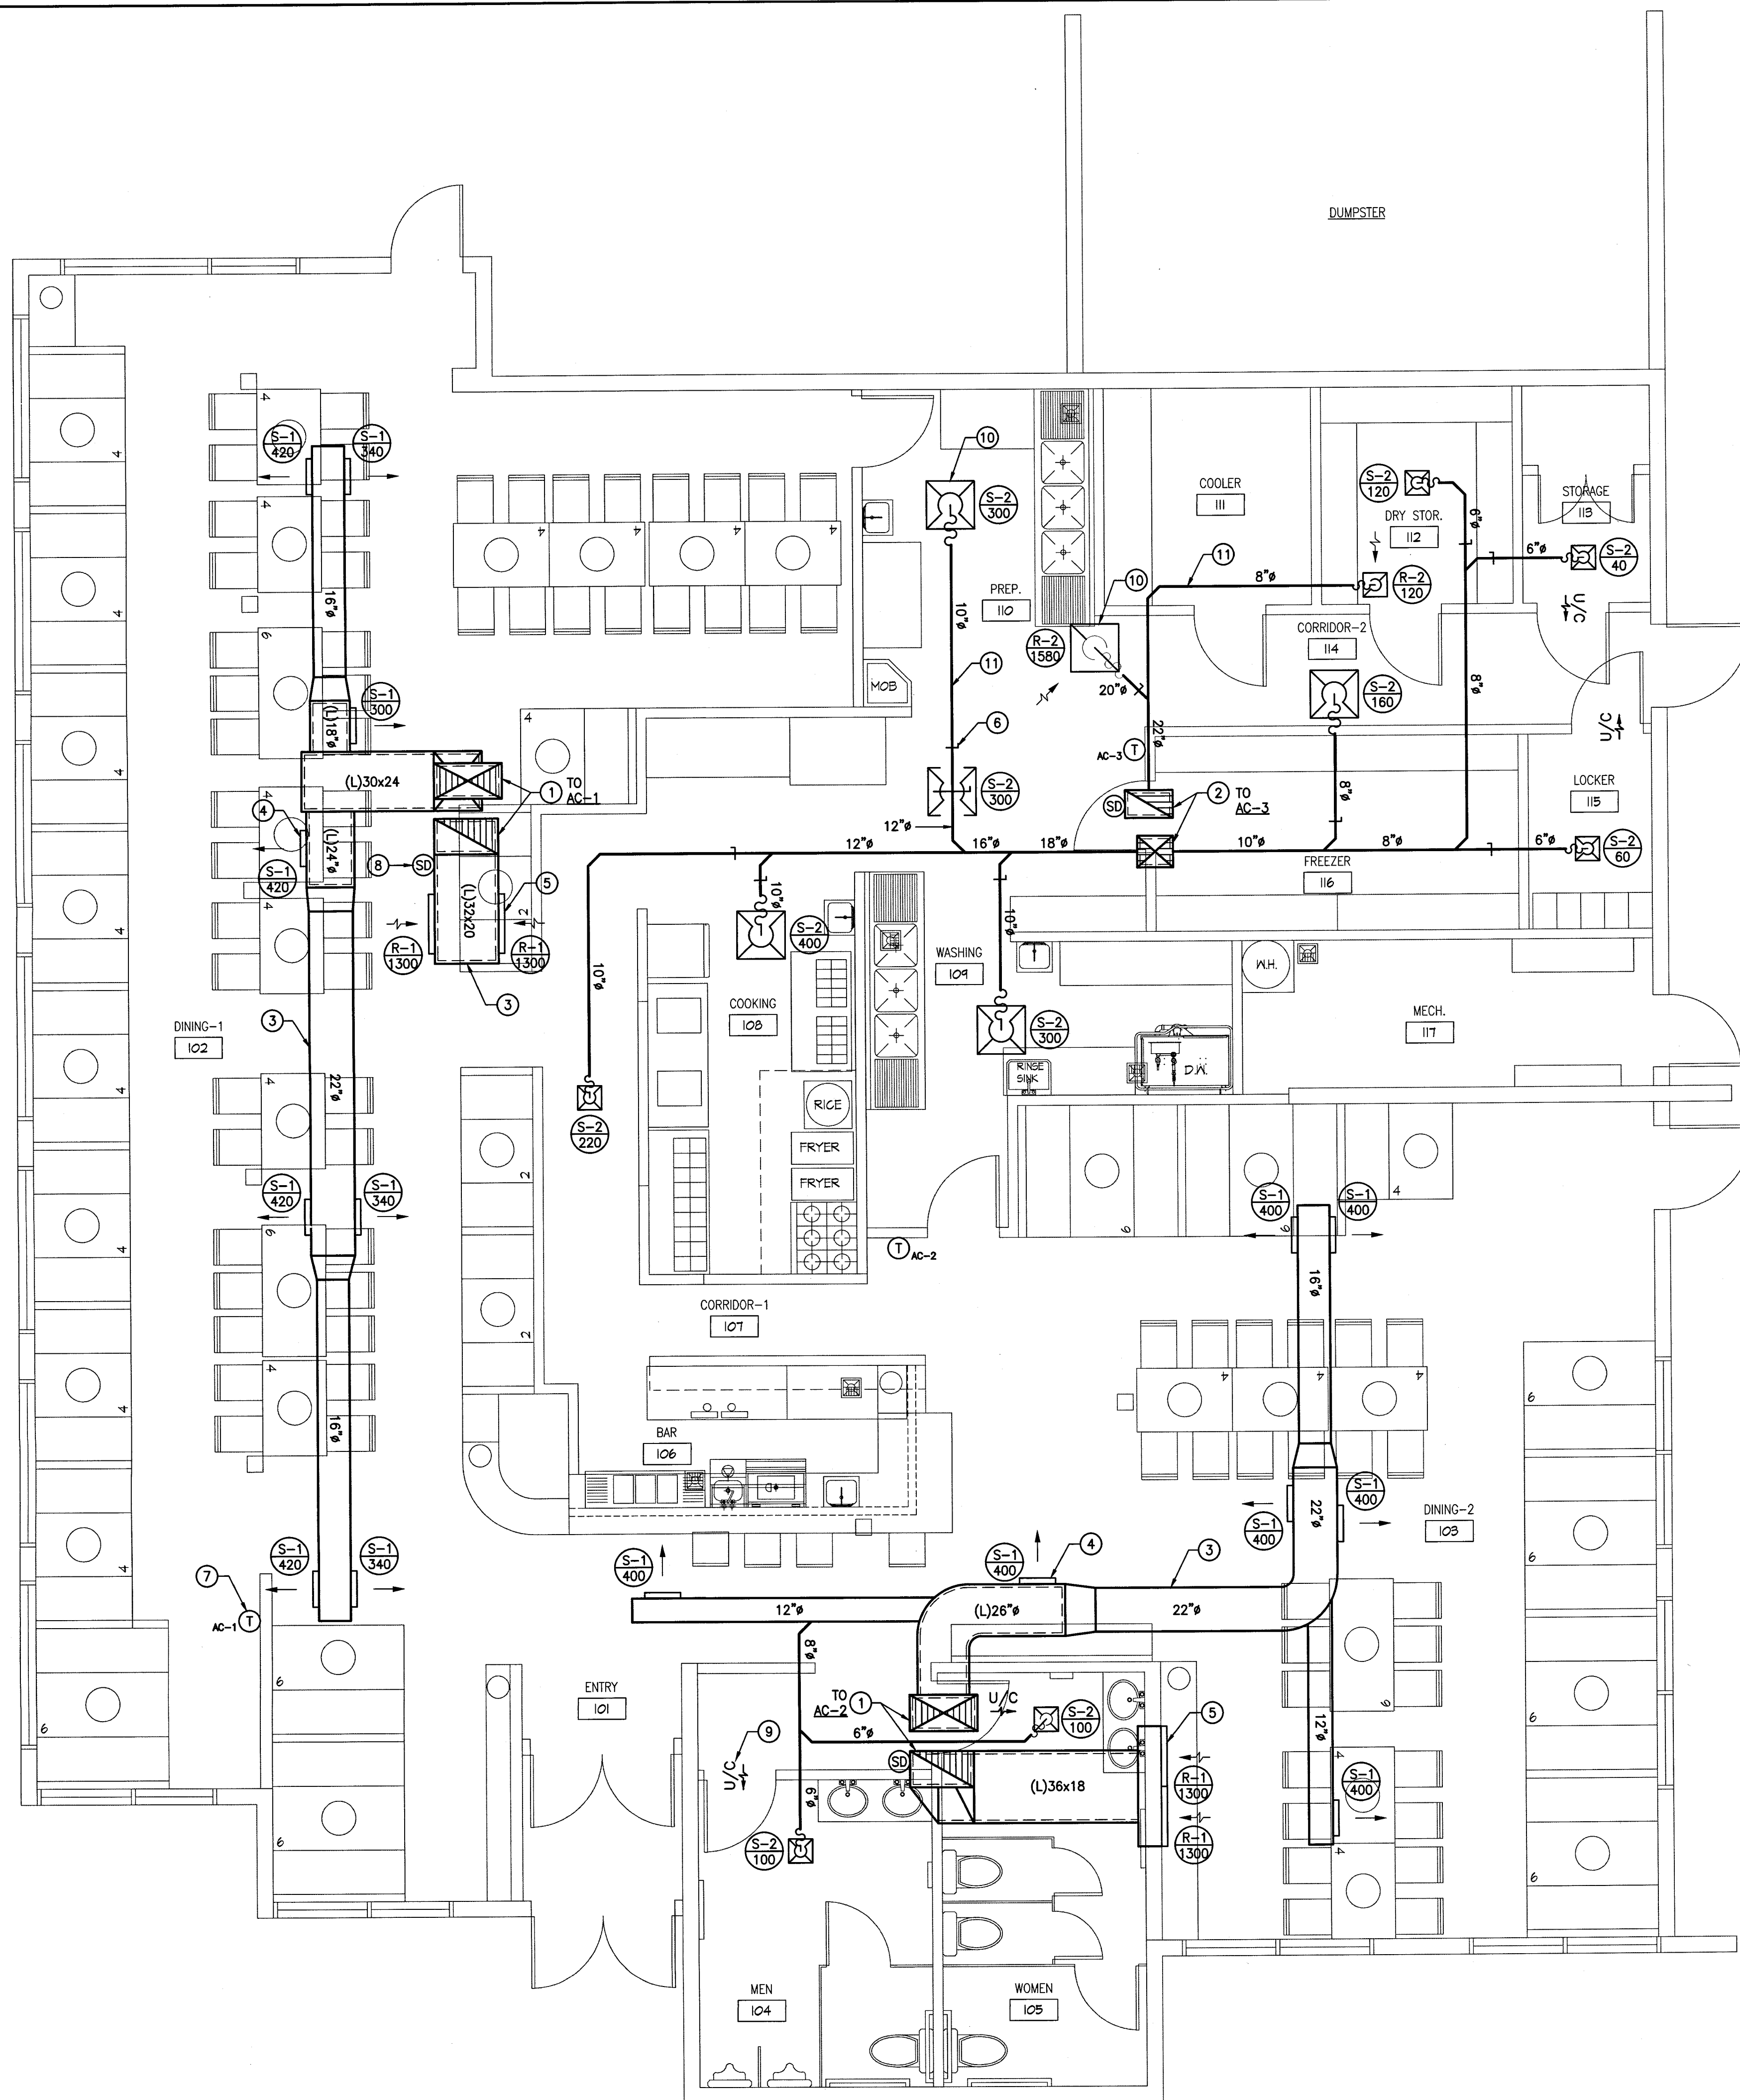

KEYNOTES:

- 1 LINED 33x18 SUPPLY & 32x18 RETURN MAIN DUCTS UP THRU ROOF TO AC UNIT.
- 2 LINED 18x16 SUPPLY & 24x14 RETURN MAIN DUCTS UP THRU ROOF TO AC UNIT.
- 3 EXPOSED RIGID SUPPLY/RETURN DUCT (TYP.)
- 4 DUCT MOUNTED SUPPLY AIR DIFFUSER (TYP.)
- 5 DUCT/WALL MOUNTED RETURN AIR GRILLE (TYP.)
- 6 MANUAL VOLUME DAMPER (TYP.)
- 7 THERMOSTAT ON WALL (TYP. 3)
- 8 SMOKE DETECTOR ON RETURN AIR DUCT TO SHUT OFF AC UNIT ON DETECTION OF SMOKE (TYP. 3)
- 9 MINIMUM 3" DOOR UNDERCUT FOR AIR TRANSFER (TYP. 4)
- 10 CEILING SUPPLY/ RETURN AIR GRILLE (TYP.)
- 11 SUPPLY/ RETURN AIR DUCT ABOVE CEILING (TYP.)

**MECHANICAL FLOOR PLAN -
CONDITIONED AIR**

SCALE: 1/4" = 1'-0"



Korean BBQ of Utah
7157 S. State Street
Midvale, Utah, 84047

REVISIONS	
Δ	CORRECTION SWRF 4-19-18
Δ	CORRECTION BLDG. 4-28-18
Δ	CORRECTION BLDG. 5-17-18

NO. ISSUE DATE

PROJECT DATA

PROJECT NUMBER:
DATE: 4-9-18
DRAWN BY: JK
CHECKED BY: ML
APPROVED BY:

SCALE

SHEET NAME

**MECHANICAL FLOOR PLAN -
EXHAUST & MAKE-UP AIR**

SHEET NUMBER


M-3

KEYNOTES:

- GREASE AIR EXHAUST MAIN DUCT UP THRU ROOF TO EXHAUST FAN ON ROOF.
- EXHAUST AIR MAIN DUCT UP THRU ROOF TO EXHAUST FAN ON ROOF.
- MAKE-UP AIR MAIN DUCT UP THRU ROOF TO MAKE-UP AIR UNIT ON ROOF.
- CEILING MAKE-UP AIR DIFFUSER (TYP.)
- MAKE-UP AIR DUCT ABOVE CEILING (TYP.)
- MANUAL VOLUME DAMPER (TYP.)
- ON/OFF SWITCH ON WALL WITH CONTROL WIRING TO CORRESPONDING EXHAUST FAN AND MAKE-UP AIR UNIT TO MANUALLY OVERRIDE AUTOMATIC CONTROL (TYP.6)
- ACCESS PANEL ON GREASE DUCT FOR DUCT CLEANING PER IMC SECTION 506.3.8 (TYP.)
- EXHAUST HOOD ABOVE TABLE GRILL (TYP.40)
- EXHAUST HOOD ABOVE KITCHEN COOKING EQUIPMENT.
- TEMPERATURE SENSOR W/ADJUSTABLE SETTING ON EXHAUST AIR DUCT FOR AUTOMATIC CONTROL OF EXHAUST FAN FOR TABLE-TOP BURNERS. PROVIDE AT ACCESSIBLE LOCATION (TYP.40)
- TEMPERATURE SENSOR W/ADJUSTABLE SETTING UNDER KITCHEN HOOD FOR AUTOMATIC CONTROL OF EXHAUST FAN. PROVIDE AT ACCESSIBLE LOCATION.

KITCHEN EQUIPMENT SCHEDULE

EQUIP NO.	DESCRIPTION	MANUF.	MODEL NO.	QTY.	GAS BTUH
K 3	RICE COOKER	RINNAI	RER-55A5	1	95K
K 5	FRYER	AMERICAN RANGE	AF-95/50	2	95K
K 6	BURNER	AMERICAN RANGE	ARHP-36-6	1	56K
K 23	WATER HEATER	AMERICAN WATER HEATERS	BC68-100T194-6N	1	149K
K 24	TABLE BURNER	BUHNS SAFE INC	BH-5000	40	8K
-	HOOD #1, TYPE-1	ECON-AIR	4824 EX-2	1	-
-	HOOD #2, TYPE-1	JC ENTERPRISES	DKBHS	40	-

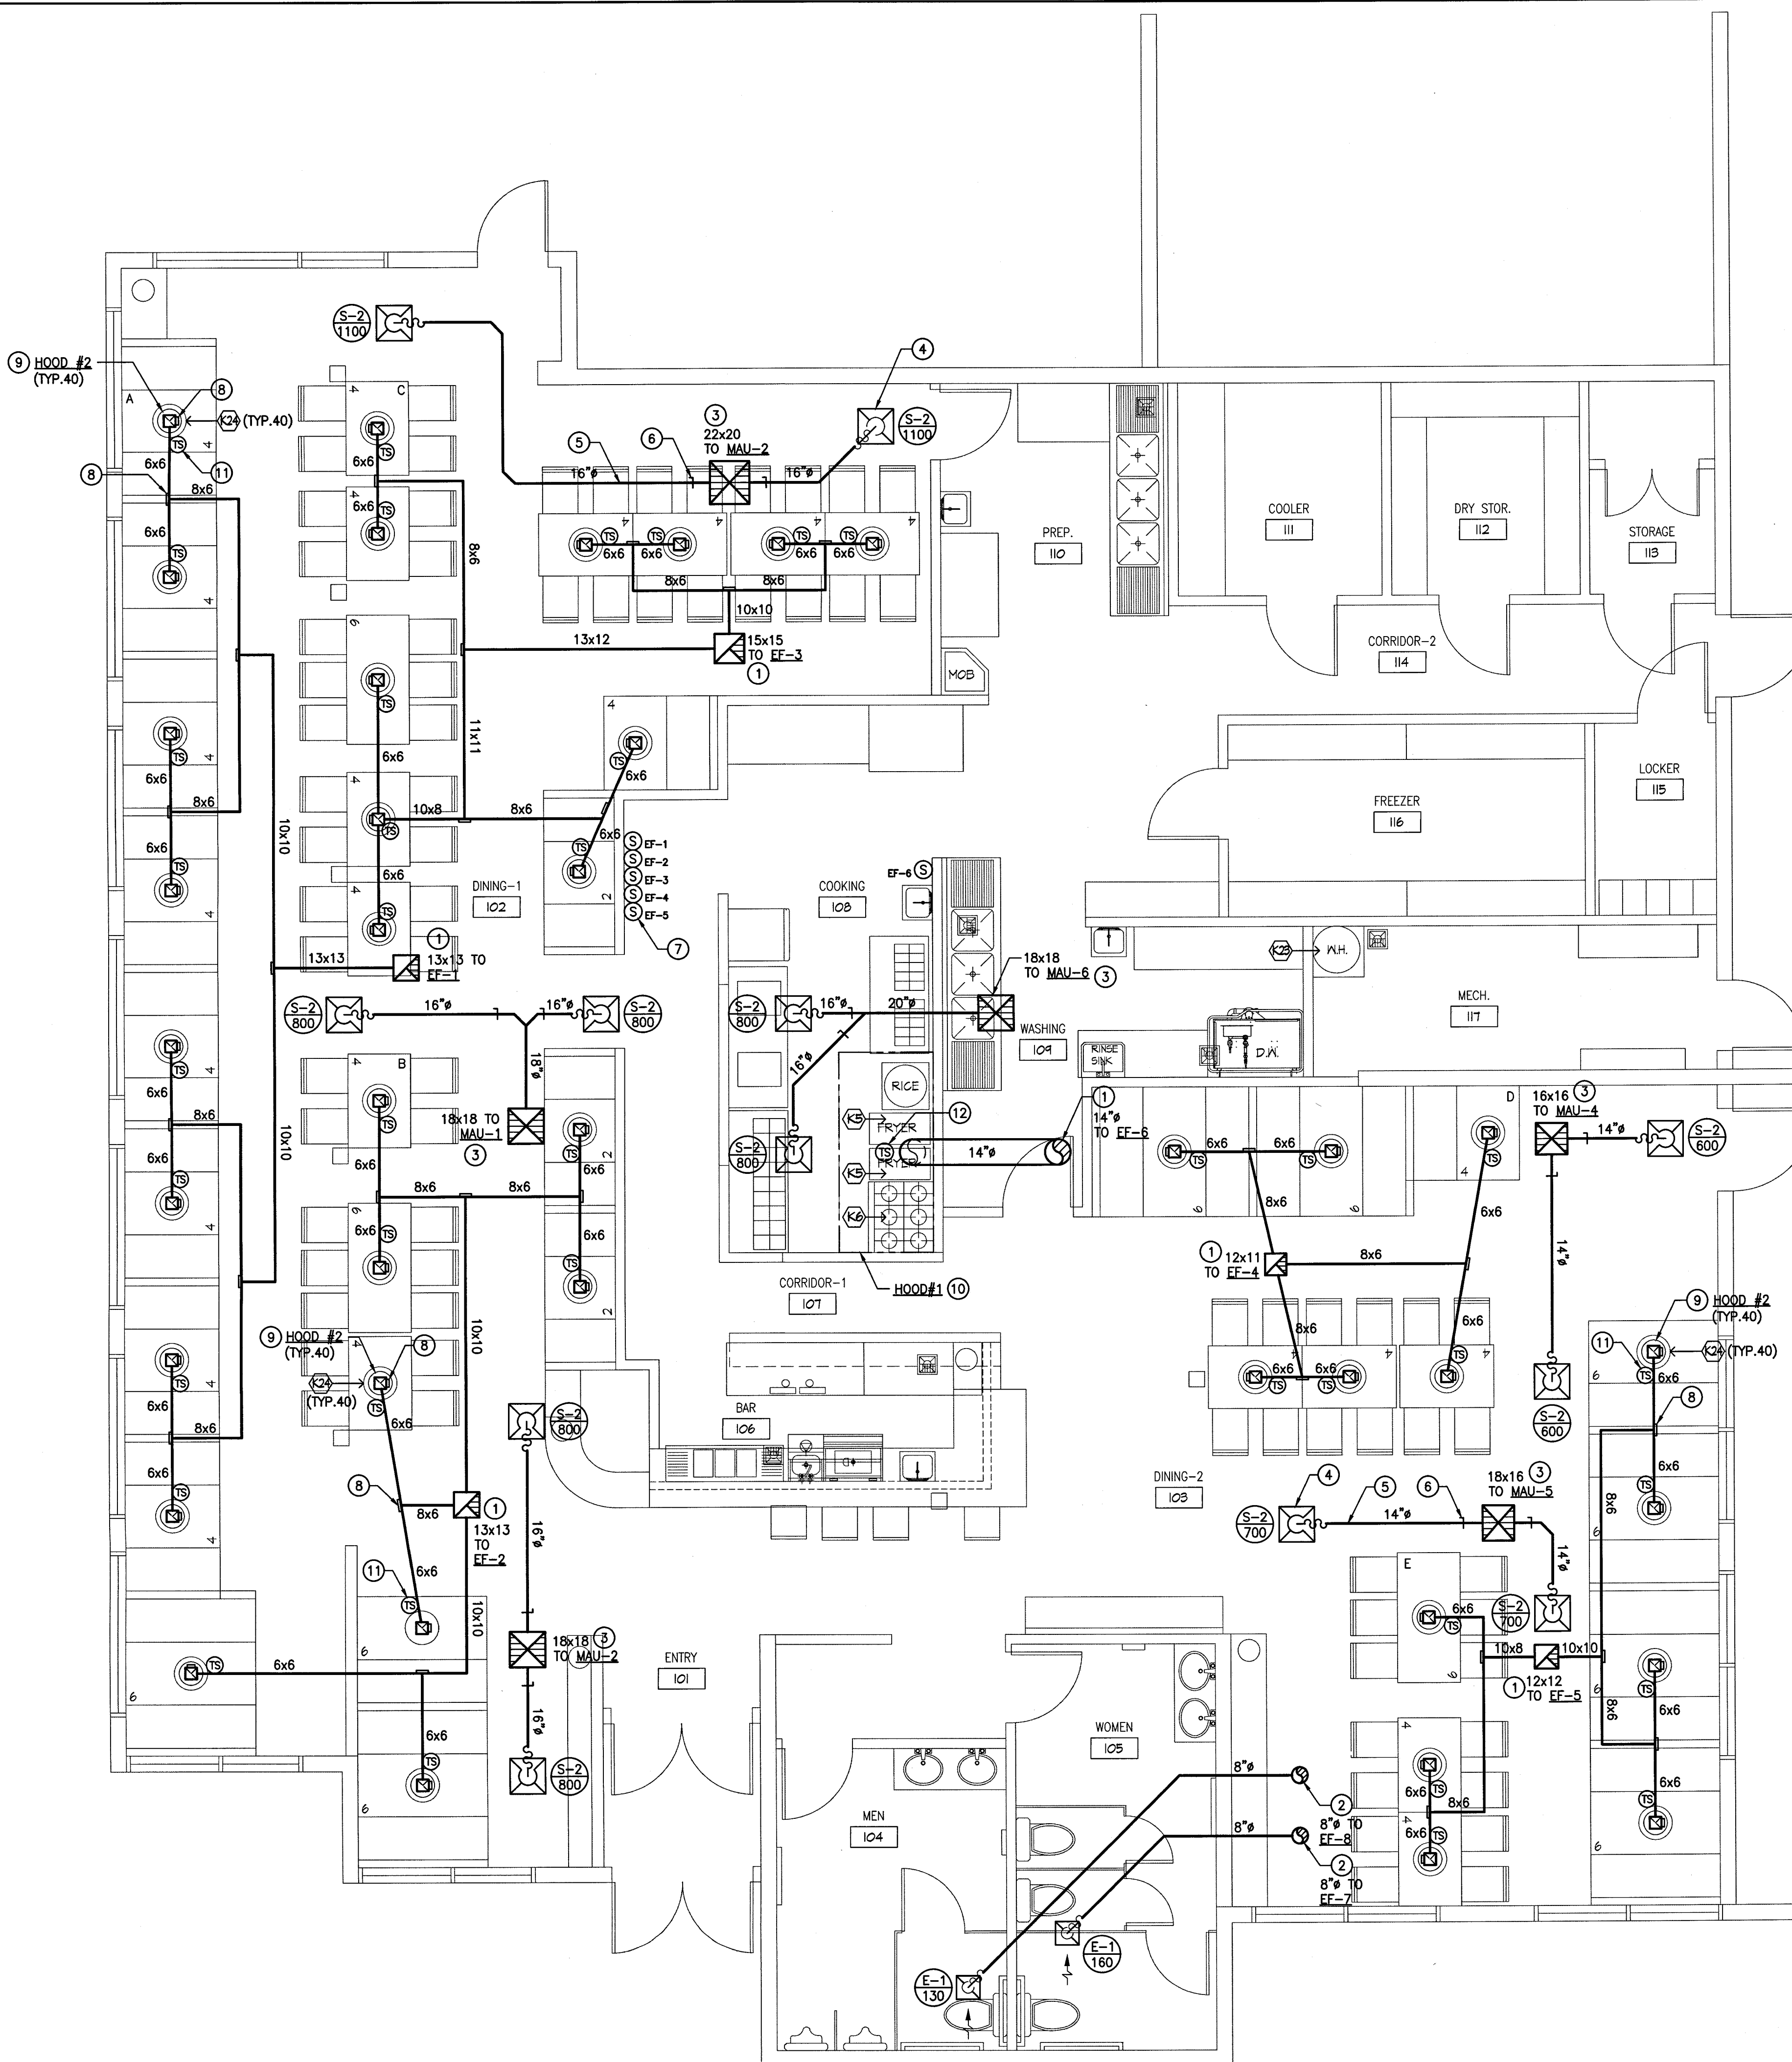

**MECHANICAL FLOOR PLAN -
EXHAUST & MAKE-UP AIR**

SCALE: 1/4" = 1'-0"



Korean BBQ of Utah
7157 S. State Street
Midvale, Utah, 84047

REVISIONS	
Δ CORRECTION SWIRP	4-19-18
Δ CORRECTION BLDG.	4-26-18

NO.	ISSUE	DATE
PROJECT DATA		
PROJECT NUMBER:		
DATE:		
DRAWN BY:		
CHECKED BY:		
APPROVED BY:		

SCALE

SHEET NAME
**MECHANICAL
ROOF PLAN**

SHEET NUMBER


M-4

KEYNOTES:


- 1 PACKAGED AIR CONDITIONING UNIT. PROVIDE ROOF CURB FOR AC-3. AC-1 & AC-2 TO USE (E) ROOF CURBS.
- 2 MAKE-UP AIR UNIT ON ROOF CURB.
- 3 EXHAUST FAN ON ROOF CURB.
- 4 1/2" WATER AND 3/8" AUTO DRAIN PIPES. FOR CONTINUATION, REFER TO PLUMBING PLAN P-3 (TYP. 6)
- 5 3/8" CONDENSATE DRAIN PIPE. FOR CONTINUATION, REFER TO PLUMBING PLAN P-2 (TYP. 3)
- 6 MIN. 10 FT DISTANCE FROM EXHAUST FAN DISCHARGE TO ANY OUTSIDE AIR INTAKE OPENING (TYP. 8)
- 7 OUTSIDE AIR INTAKE HOOD WITH BIRD SCREEN AND VOLUME DAMPER (TYP.3)
- 8 LINED SUPPLY AND RETURN AIR DUCTS OF AC UNIT DOWN THRU ROOF (TYP.3)
- 9 GAS PIPE FOR AC UNIT & MAKE-UP AIR UNIT. FOR SIZE AND ROUTING, REFER TO PLUMBING PLAN P-4 (TYP.9)
- 10 AC UNIT SERVICE CLEARANCE (TYP.3)
- 11 LINED MAKE-UP AIR DUCT DOWN THRU ROOF (TYP.6)
- 12 EXHAUST AIR DUCT DOWN THRU ROOF (TYP.8)
- 13 (E) FLUE FROM WATER HEATER, TO REAMIN.

MECHANICAL ROOF PLAN

SCALE: 1/4" = 1'-0"

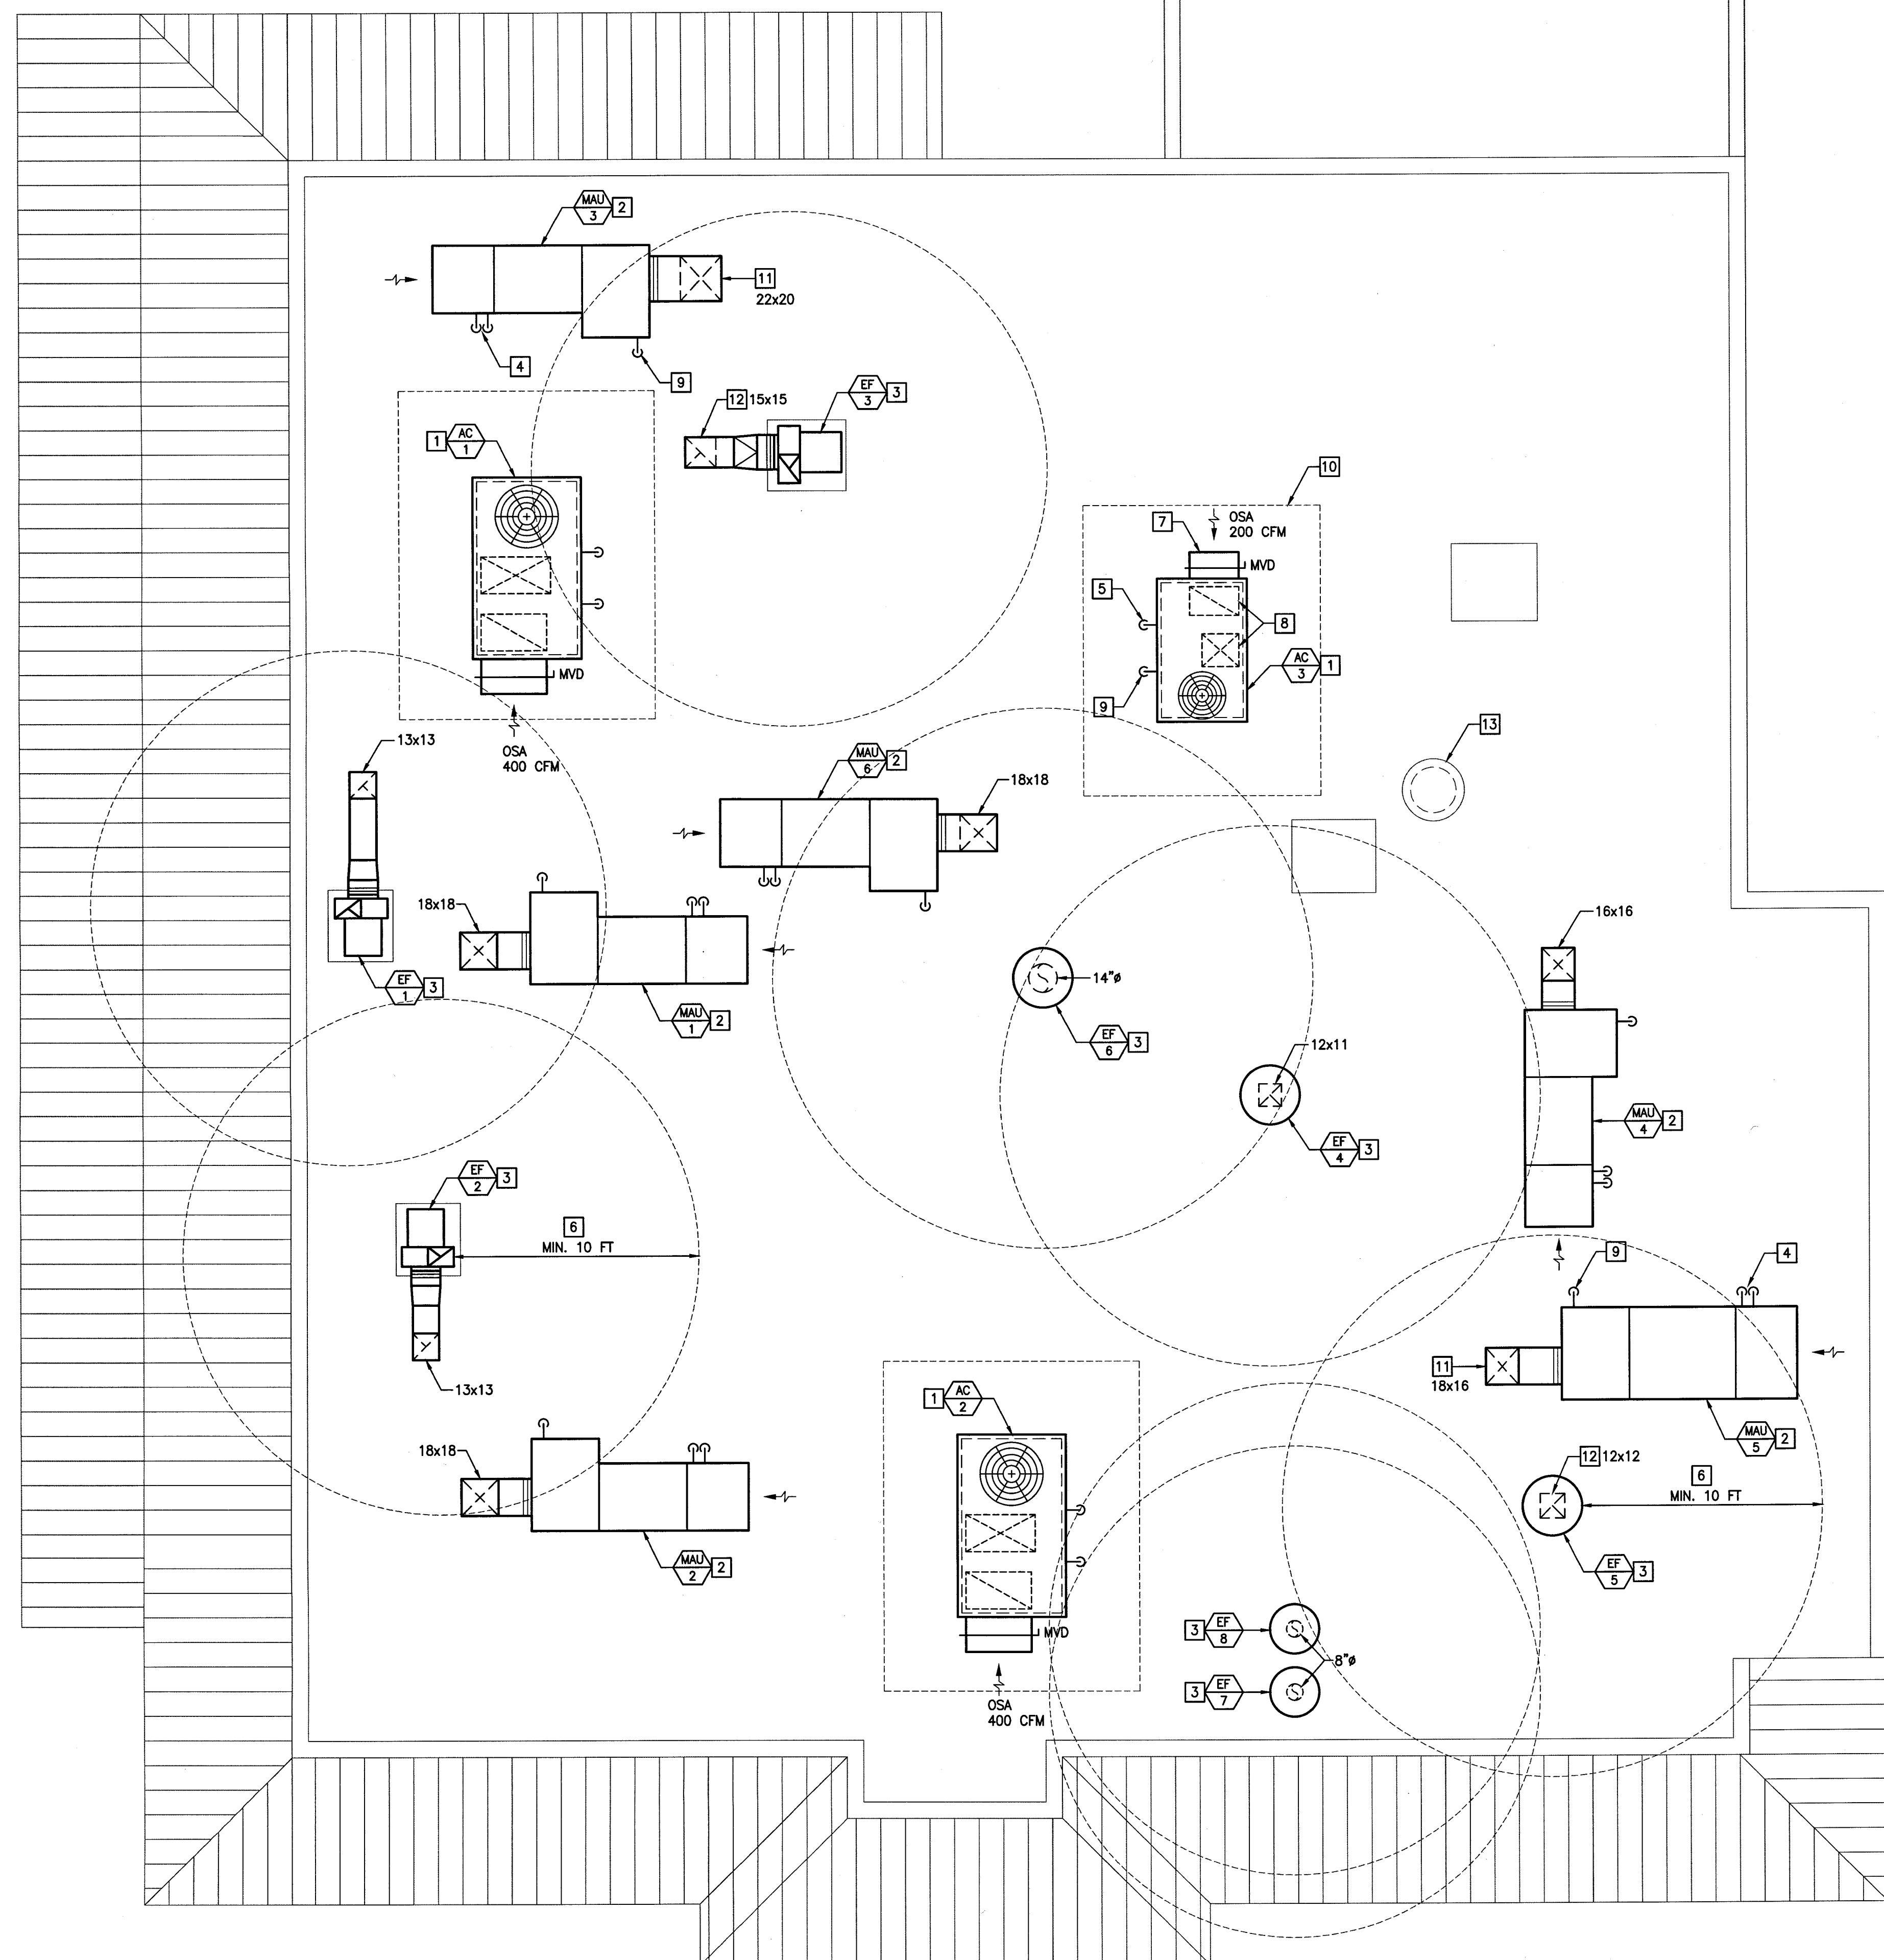


NOTE: 1. EXTEND DISCHARGE TO BE HIGHER THAN 40" ABOVE ADJACENT ROOF SURFACE.

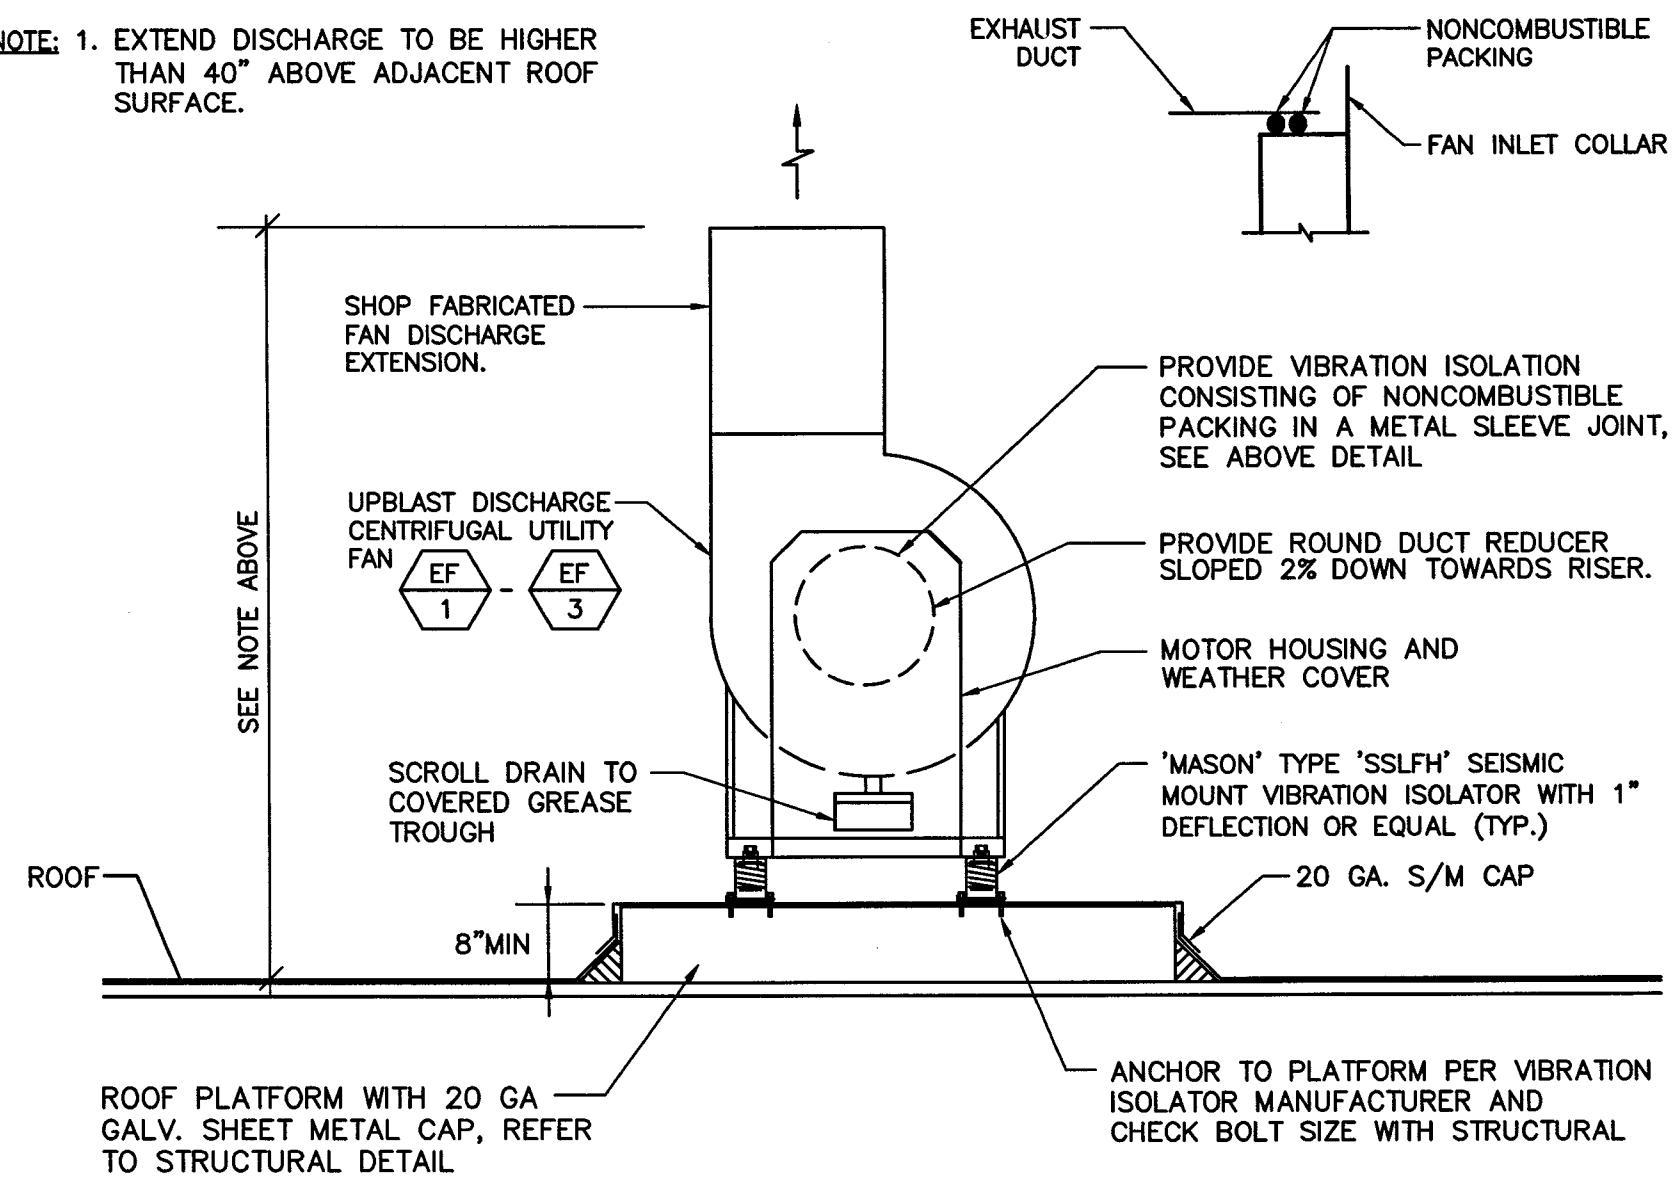

UTILITY EXHAUST FAN INSTALLATION

SCALE
NONE

3

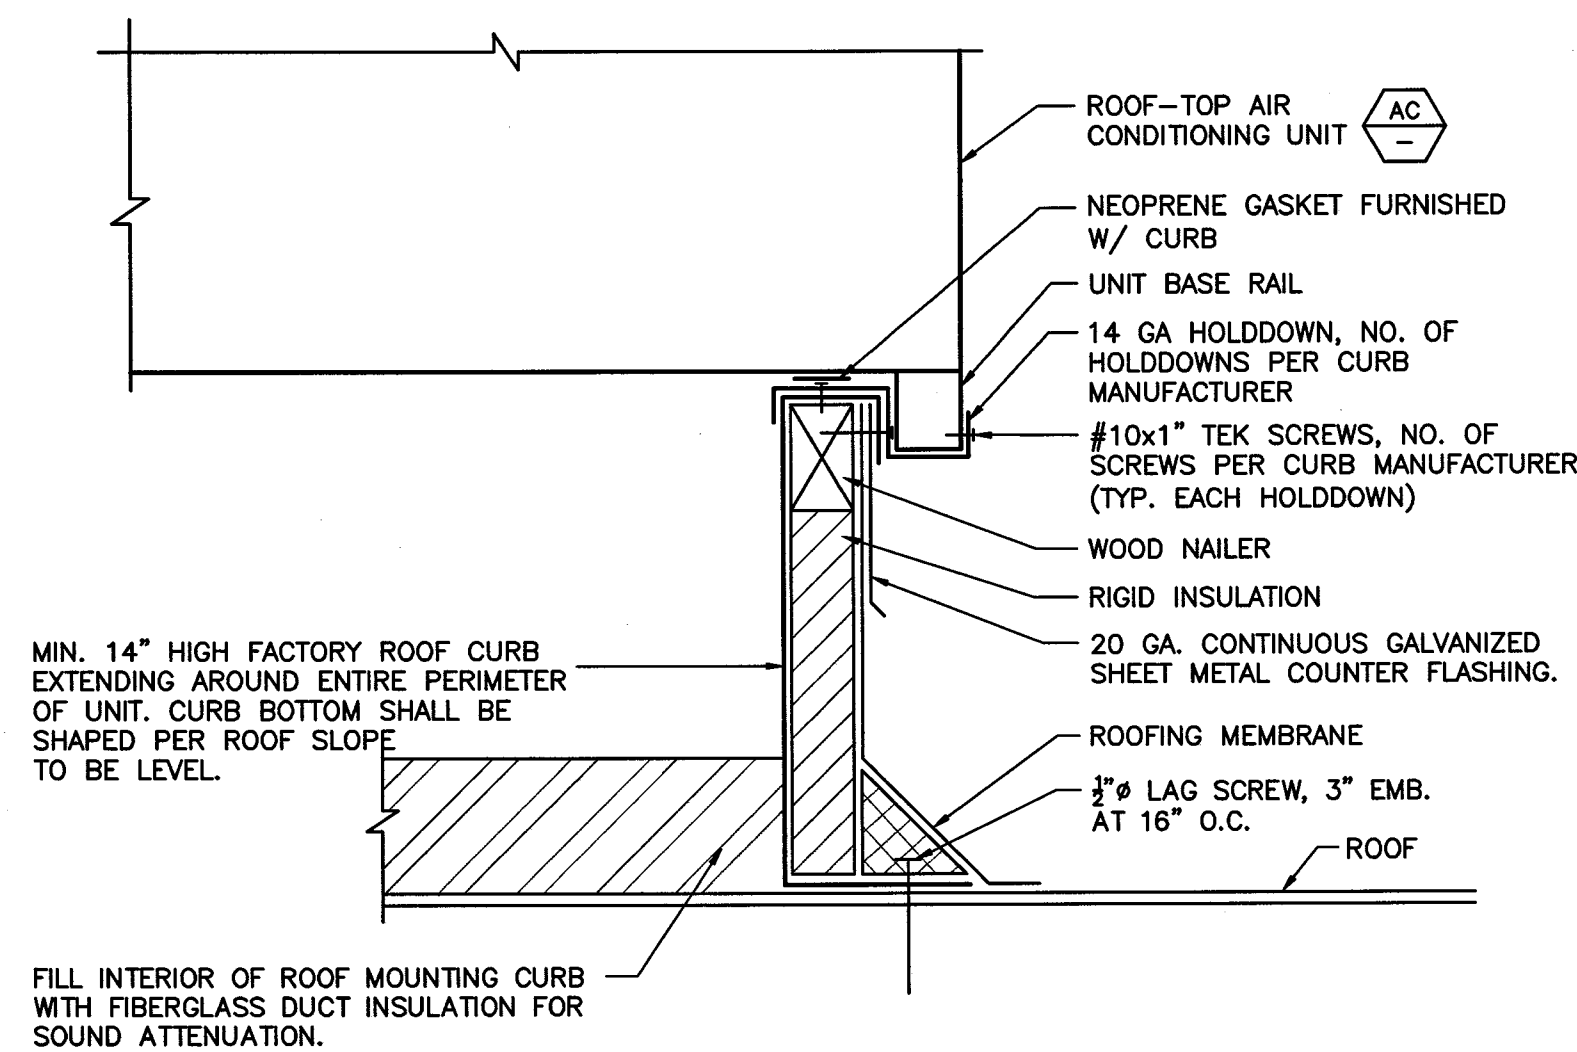


NOTE: 1. FOR STRUCTURAL FRAMING AND DETAIL, REFER TO STRUCTURAL PLAN.

PACKAGED HP UNIT ON NEW ROOF CURB

SCALE
NONE

2

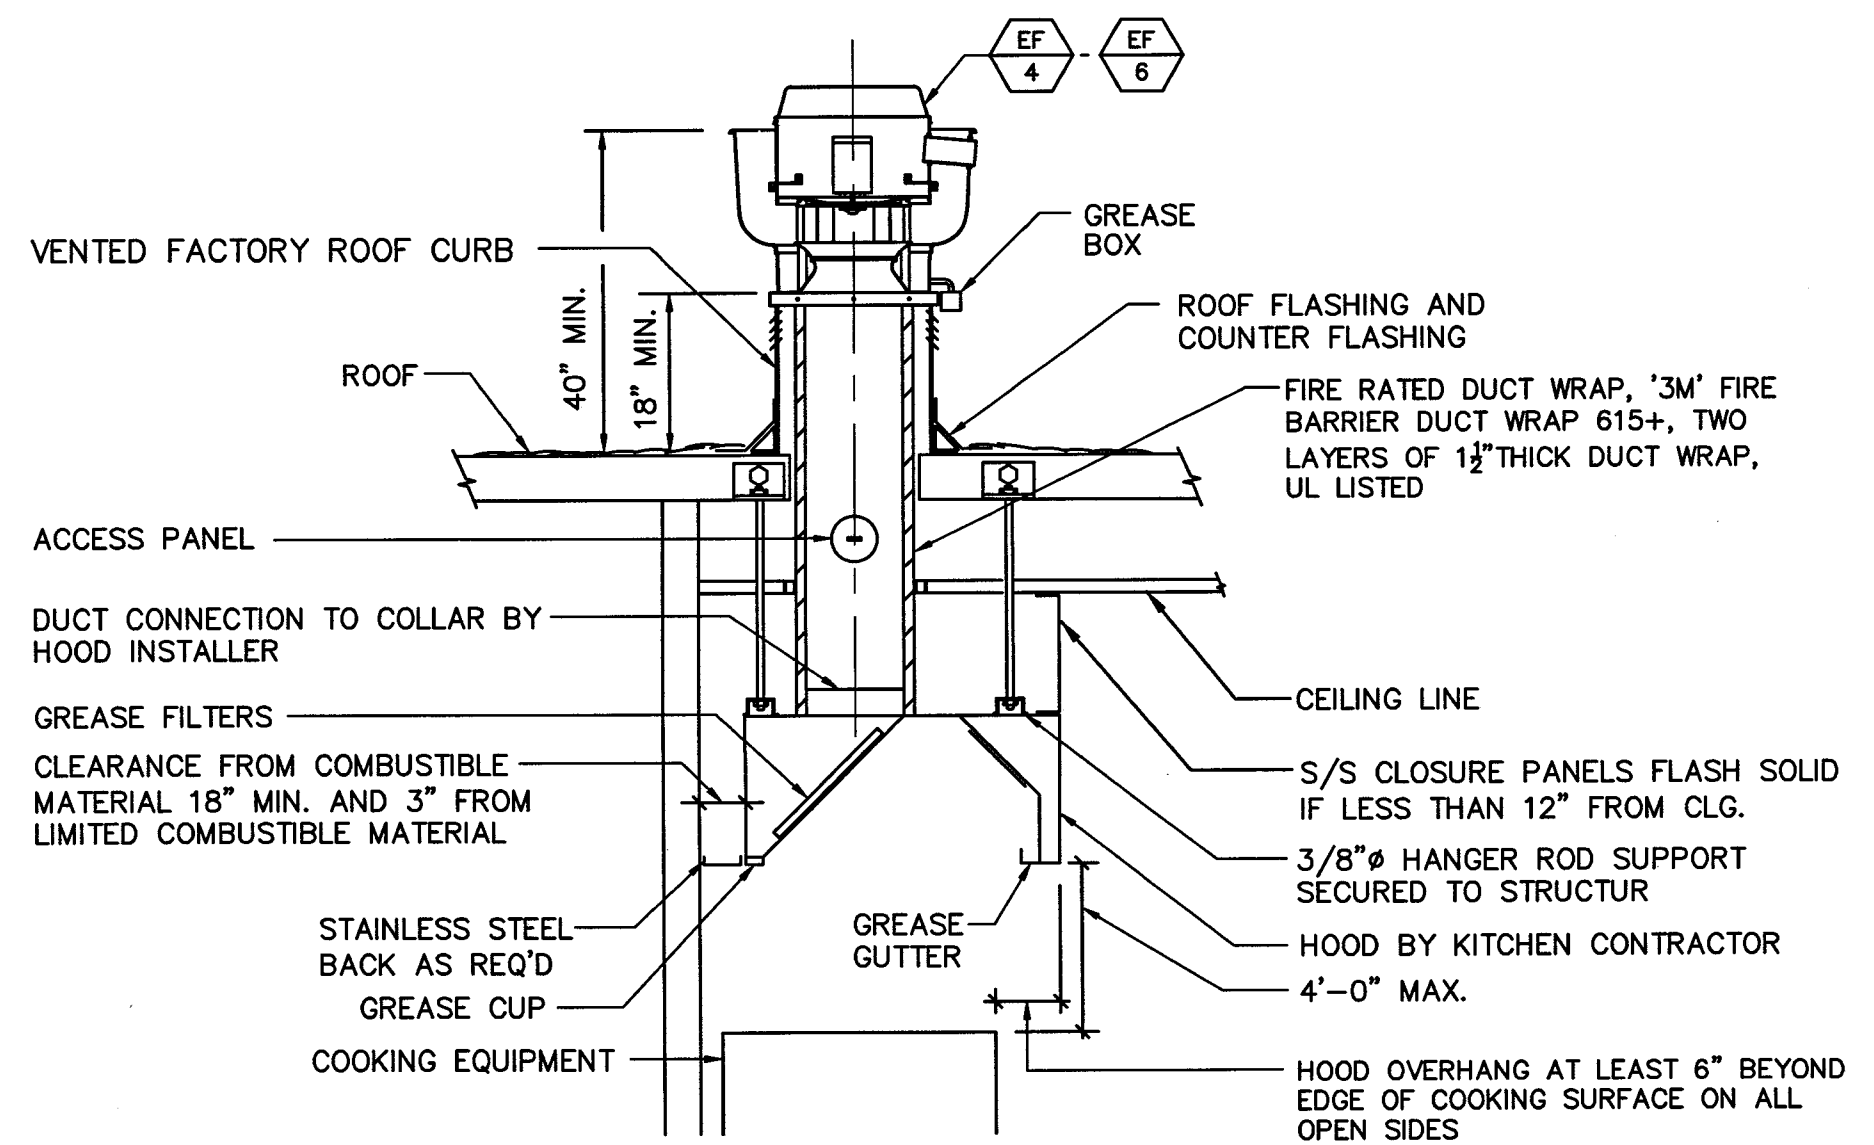

NOTES:

1. EXHAUST OUTLET TO BE 10'-0" MIN. FROM ADJACENT PROPERTY LINE OR AIR INTAKE.
2. REFER TO KITCHEN FOOD, GREASE DUCT AND EXHAUST FAN MANUFACTURER'S INSTRUCTIONS.

TYPICAL TYPE I HOOD, DUCT, EXHAUST FAN

SCALE
NONE

1


3M™ Fire Barrier Duct Wrap 615+

Product Data Sheet and Installation Guide

1. Product Description

3M™ Fire Barrier Duct Wrap 615+ is a flexible fire-resistant wrap consisting of an inorganic fiber blanket encapsulated with a scrim-reinforced foil. The product is 1-1/2" thick, 6 pcf density.¹ It is used to fire rate commercial kitchen grease ducts as well as ventilation ducts. 3M™ Fire Barrier Duct Wrap 615+ is a proven alternative to 1- or 2-hour fire-resistant rated shaft enclosures for grease ducts (ICC-ES ESR-1255). With its excellent insulating capabilities, low weight and thin profile, it is an ideal choice for a duct enclosure system. This non-asbestos² wrap installs easily due to its high flexibility and strength.

¹ In accordance with the tolerances in ASTM C 892 Standard Specification for High-Temperature Fiber Blanket Thermal Insulation.
² These fibers are not biopersistent and are therefore non-carcinogenic per Note Q of EU Directive 67/548/EEC (guideline 97/69/EG).

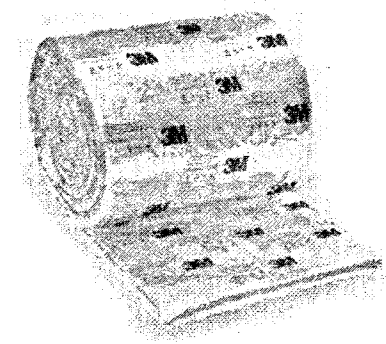

Flexible and lightweight with a thin profile for easier application and reduced space requirements

Product Features

- Two-layer wrap for grease ducts rated as a shaft alternative per ASTM E 2336
- Zero clearance to combustible throughout the entire enclosure system
- Bunted inner layer in 2-layer grease duct applications
- One-layer wrap for fire-resistive ventilation ducts per ISO 6944
- High flexibility for installation ease
- Foil encapsulated for blanket protection, less dust, and high wrap strength
- Wide range of penetration seal systems
- Available in:
 - 24" x 25 ft. (609.6mm x 7.62m) and
 - 48" x 25 ft. (1219.2mm x 7.62m) rolls
- Blanket adhered to foil scrim helps prevent wrap from slumping



2. Applications

3M™ Fire Barrier Duct Wrap 615+ is an ideal fire resistive enclosure for commercial kitchen grease ducts and ventilation air ducts. It is a proven alternative to a 1- or 2-hour fire-resistant rated shaft enclosures for grease ducts and provides zero clearance to combustible construction throughout the entire enclosure system (per ICC-ES ESR-1255). 3M™ Fire Barrier Water Tight Sealant 1000 NS, 3M™ Fire Barrier Water Tight Sealant 1003 SL or 3M™ Fire Barrier Silicone Sealant 2000+ is used in combination with 3M™ Fire Barrier Duct Wrap 615+ to firestop the duct when the duct penetrates fire-rated floor or wall assemblies. 3M™ Fire Barrier Duct Wrap 615+ also provides a firestop solution where a T-rating is required for penetrations located outside wall cavities or outside fire-resistance rated shaft enclosures.

Two-layer grease duct applications: 3M™ Fire Barrier Duct Wrap 615+ meets the criteria of ASTM E 2336 Standard Test Methods for Fire Resistive Grease Duct Enclosure Systems.

Single-layer ventilation duct applications: 3M™ Fire Barrier Duct Wrap 615+ has passed ISO 6944-1985 Fire Resistance Tests – Ventilation Ducts.

T-rating for metallic through-penetrating items: 3M™ Fire Barrier Duct Wrap 615+ is used in conjunction with 3M Fire Barrier sealants to achieve up to 2-hour equal F & T-ratings in ASTM E 814 (UL 1479) tested through-penetrations.

3. Specifications

Installation shall be in strict accordance with manufacturer's written instructions, as shown on the approved shop drawings. 3M™ Fire Barrier Duct Wrap 615+ shall be a high-temperature fibrous thermal insulation blanket encapsulated in a fiberglass-reinforced aluminized polyester foil. Duct Wrap density shall be nominal 6 pcf (96 kg/m³) and have a nominal 1-1/2" (38.1mm) thickness. The fiber blanket shall have a continuous use limit of 1000°C (1832°F). The blanket thermal resistance (R-value) at ambient temperature shall be minimum 6.3 - R_{fi} - hr.

Smoke Developed Index and Flame Spread Index of the bare blanket, and of the foil encapsulated blanket shall be 0.0. The foil encapsulation shall be bonded to the core blanket material.


For technical support relating to 3M™ Fire Protection Products and Systems, call: 1-800-328-1687
For more information on 3M™ Fire Protection Products, visit: www.3m.com/firestop

2

FIRE RETED DUCT WRAP SPECIFICATION

SCALE
NONE

7

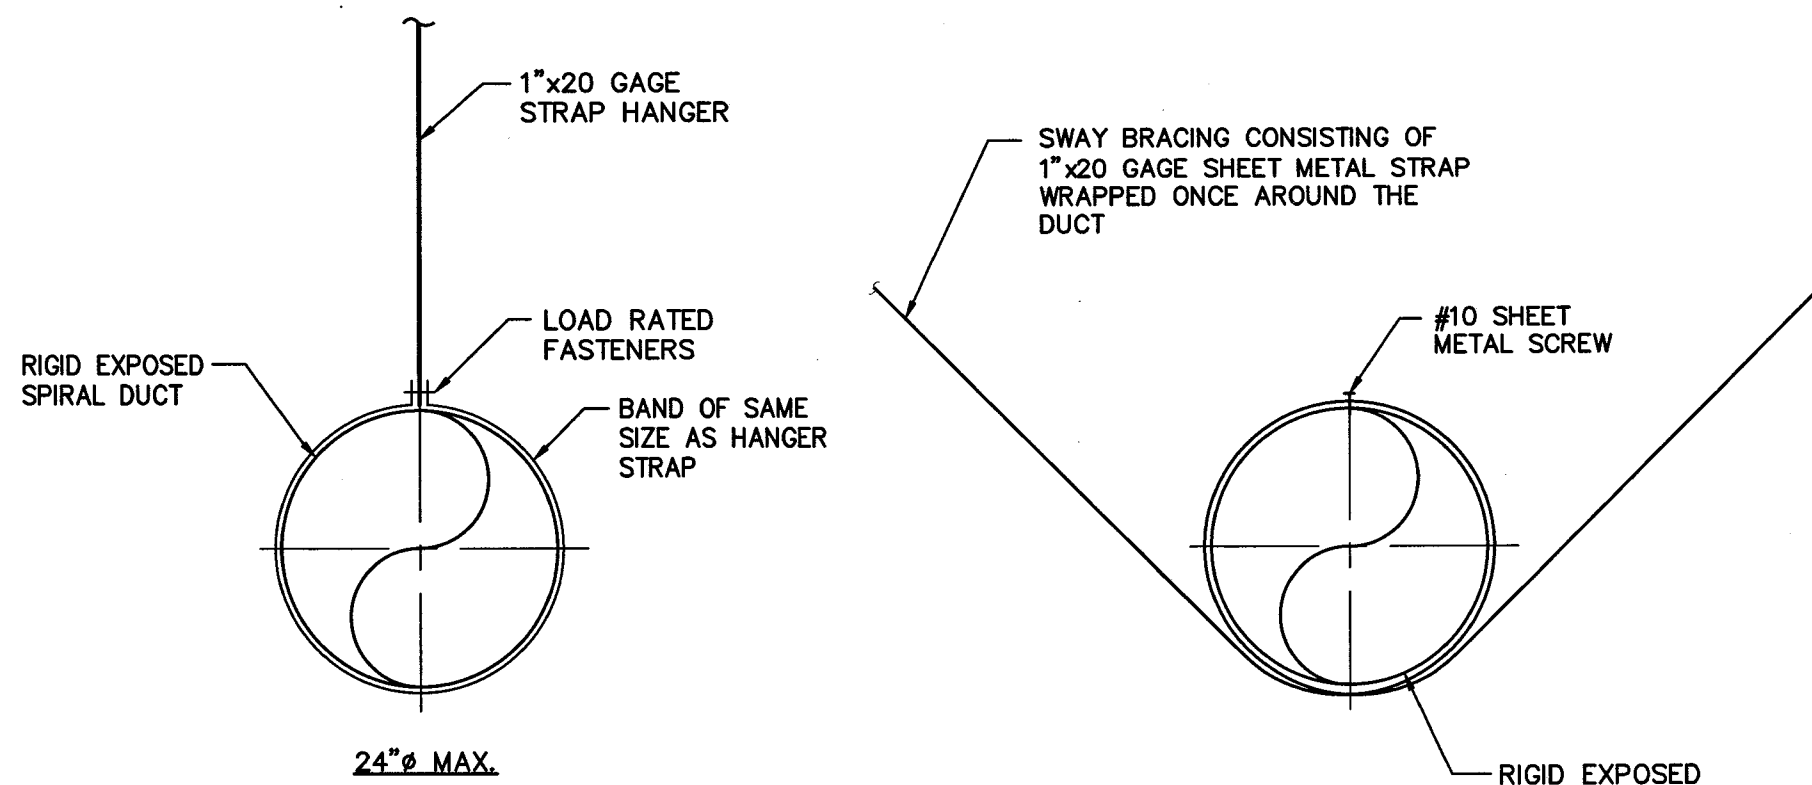


NOTES:

1. SPACING OF VERTICAL HANGER STRAP SHALL BE MAXIMUM 8'-0" O.C.
2. SPACING OF TRANSVERSE BRACING SHALL BE MAXIMUM 30'-0" O.C.
3. FOR MINIMUM SIZE OF OTHER HANGER TYPES, SEE SMACNA HVAC CONSTRUCTION STANDARDS TABLE 5-2.
4. FOR UPPER ATTACHMENTS TO BUILDING AND LOWER ATTACHMENTS TO DUCTS, SEE SMACNA HVAC DUCT CONSTRUCTION STANDARDS FIG. 5-1 THRU 5-5.

ROUND DUCT MOUNTING DETAIL

SCALE
NONE

5

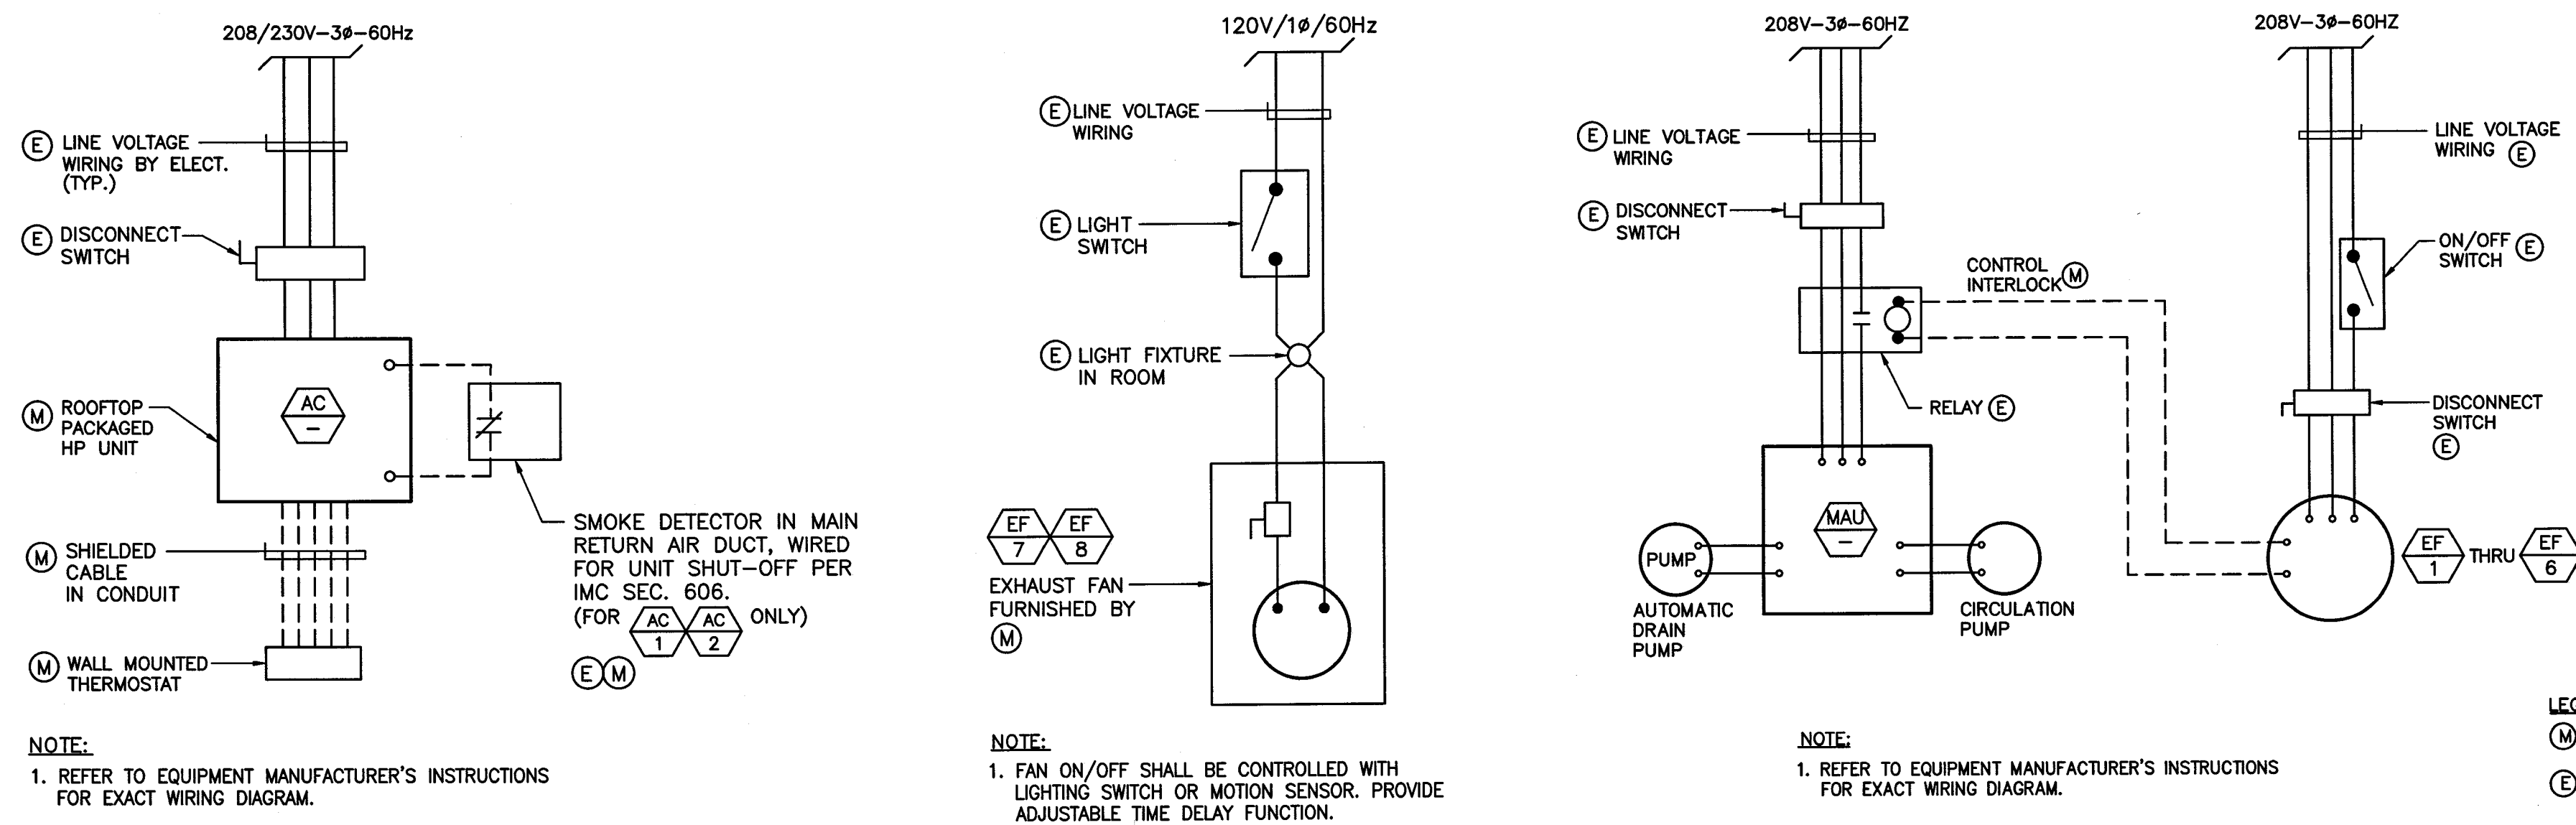

NOTE:

1. FAN ON/OFF SHALL BE CONTROLLED WITH LIGHTING SWITCH OR MOTION SENSOR. PROVIDE ADJUSTABLE TIME DELAY FUNCTION.

NOTE:

1. REFER TO EQUIPMENT MANUFACTURER'S INSTRUCTIONS FOR EXACT WIRING DIAGRAM.

LEGEND:

- (M) BY MECHANICAL CONTRACTOR
- (E) BY ELECTRICAL CONTRACTOR

EQUIPMENT CONTROL WIRING DIAGRAM

SCALE
NONE

6

WOU
DESIGN PARTNERS

5470 WILSHIRE BLVD, SUITE 930
LOS ANGELES, CA 90010


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18008
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REVISIONS

Δ CORRECTION SWRF 4-19-18
Δ CORRECTION BLDG. 4-26-18

PROJECT DATA

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DRAWN BY: JK
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APPROVED BY:


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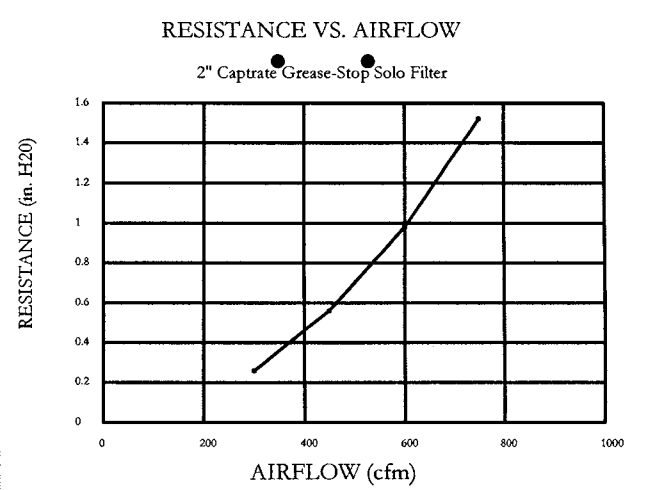
MECHANICAL DETAILS

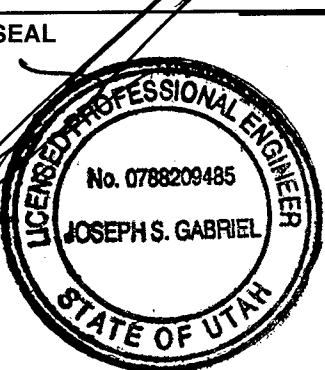SHEET NUMBER

M-5



Captrate
Grease-Stop Solo Filter

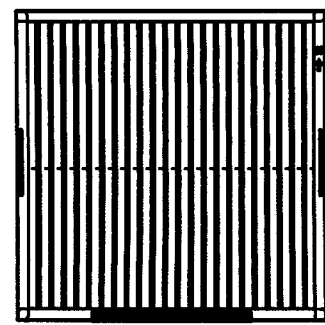

Filter Detail

CAPTRATE


EXHAUST CFM=LENGTH OF HOOD X CFM/LIN.FT. (LOAD)
SUPPLY CFM=EXHAUST CFM X PERCENTAGE REQUIRED
TOTAL DUCT AREA=144 X $\frac{\text{CFM}}{\text{FPM}(\%)}$
DUCT LENGTH= $\frac{\text{TOTAL DUCT AREA}}{\text{DUCT DEPTH}}$
GREASE-STOP SOLO FILTER IS ETL LISTED UNDER FILE NUMBER 3064404-001 AND COMPLIES WITH UL1046 STANDARD, NSF STANDARD #2, IFPA 96 AND IAC
CAPTIVE-AIRE VENTILATOR DUCT SIZES ARE CALCULATED USING AN EXHAUST VELOCITY OF 1600-1800 FPM AND A SUPPLY VELOCITY OF 1000 FPM
PLEASE CONSULT FACTORY FOR MAXIMUM ALLOWABLE DUCT SIZES

CALCULATIONS UTILIZED

CAPTIVE-AIRE HOODS ARE BUILT IN COMPLIANCE WITH:
• NFPA #95
• B.O.C.A. #93-18
• I.C.B.O. 34416
• SBCCI PST & ESI NO. 93137
• E.T.L. LISTED 3054804-001
• LOS ANGELES RR#8000
• ETL IS LISTED TO ULC STANDARDS




BUILDING CODES

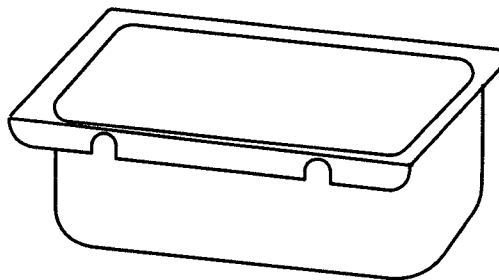

GREASE CUP WILL BE SUPPORTED BY TWO STUDS ON THE INSIDE WALL OF THE HOOD. THE GREASE WILL DRAIN THROUGH A CONCEALED GREASE TROUGH AND INTO THIS REMOVABLE/CLEANABLE CUP.

1/2 Pint Grease Cup Detail

1/2" DIA. ALL THREAD ROD CONNECTED TO ROOF JOIST THROUGH ANOTHER HANGING ANGLE
1/2" DIA. HEAVY DUTY NUT ONE ABOVE AND ONE BELOW HANGING ANGLE

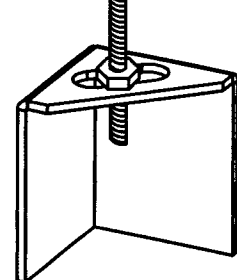

* ROD AND NUTS TO BE SUPPLIED BY INSTALLING CONTRACTOR
HANGING ANGLE IS PRE-FABRICATED AT FACTORY

ND-2 HANGING ANGLE DETAIL

HANGING ANGLES WILL BE LOCATED IN THE FOLLOWING LOCATIONS FOR WALL CANOPIES

HOOD STYLE	DIM FROM REAR	DIM FROM FRONT (24" High Hood)	DIM FROM FRONT (30" High Hood)
Wall Exhaust Only	4.166"	2.25"	2.25"
Wall With MUA		2.25"	2.25"
Back Shelf Exhaust Only	4.166"	2.25"	2.25"
Back Shelf With MUA		2.25"	2.25"
Condensate	2.25"	2.25"	

HANGING ANGLE LOCATIONS

HOOD INFORMATION

HOOD NO.	TAG	MODEL	LENGTH	MAX. COOKING TEMP.	EXHAUST PLENUM RISER(S)								HOOD CONSTRUCTION	HOOD CONFIG.	
					TOTAL EXH. CFM	WIDTH	LENG.	HEIGHT	DIA.	CFM	VEL.	S.P.		END TO END	ROW
1		4824 EX-2	8' 6"	450 Deg.	1800			4"	14"	1800	1684	-0.465"	430 SS Where Exposed	ALONE	ALONE

HOOD INFORMATION

HOOD NO.	TAG	FILTER(S)					LIGHT(S)			UTILITY CABINET(S)					FIRE SYSTEM PIPING	HOOD HANGING WGHT	
		TYPE	QTY.	HEIGHT	LENGTH	EFFICIENCY @ 7 MICRONS	QTY.	TYPE	WIRE GUARD	LOCATION	SIZE	FIRE SYSTEM		ELECTRICAL			SWITCHES
												TYPE	SIZE	MODEL #			QUANTITY
1		SS Baffle with Handles	6	16"	16"	30%	3	L55 Series E26	NO							YES	365 LBS


HOOD OPTIONS

HOOD NO.	TAG	OPTION
1		FIELD WRAPPER 18.00" High Front, Left BACKSPLASH 80.00" High X 103.00" Long 430 SS Vertical RIGHT END STANDOFF 1" Wide 48" Long Insulated RIGHT SIDESPLASH 80.00" High X 48.00" Long 430 SS Vertical BACKSPLASH - INSIDE CORNER 80.00" High X 2.00" Leg Length 430 SS Vertical

MECHANICAL AIR BALANCE


TOTAL HOOD EXHAUST	1800 CFM
MUA	1600 CFM
REMAINDER FROM HVAC	200 CFM

507.2.6 Clearances for Type I hood. A Type I hood shall be installed with a clearance to combustibles of not less than 18 inches (457 mm).
Exception: Clearance shall not be required from gypsum wallboard or 1/2-inch (12.7 mm) or thicker cementitious wallboard attached to noncombustible structures provided that a smooth, cleanable, nonabsorbent and noncombustible material is installed between the hood and the gypsum or cementitious wallboard over an area extending not less than 18 inches (457 mm) in all directions from the hood.

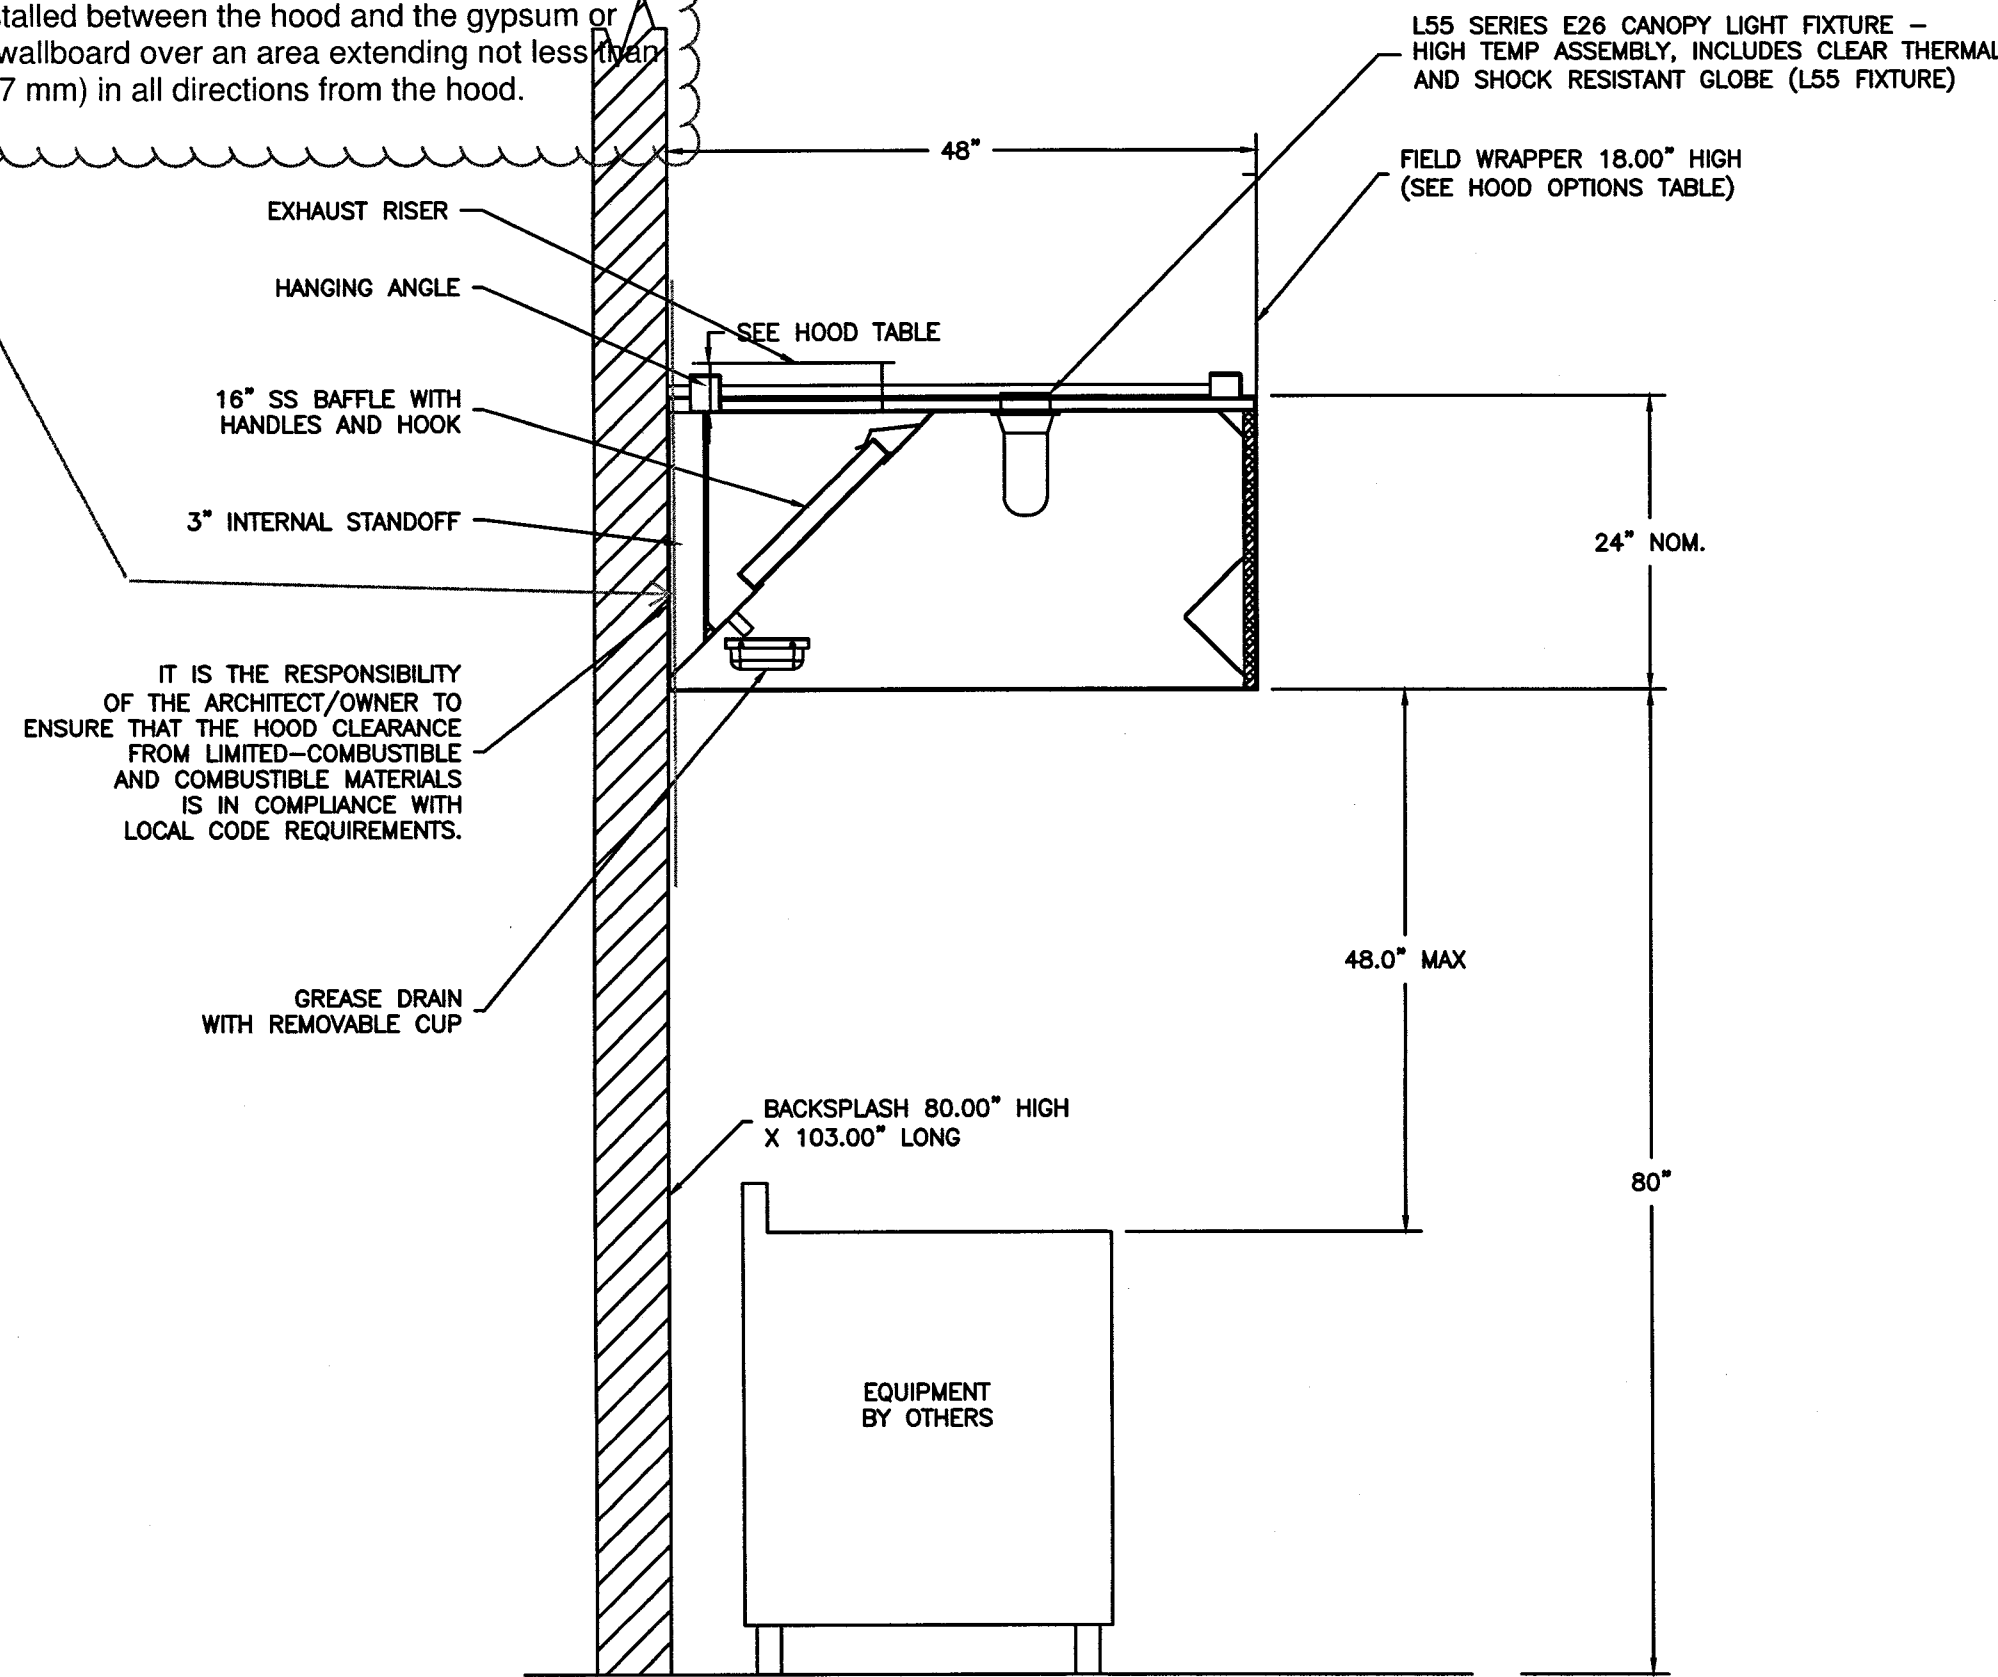


SECTION VIEW - MODEL 4824EX-2
HOOD - #1

NOTE- Exhaust Collar Must be Factory Installed. If A Different Size Or Location is Required, Please Note Change On Submittal.
Rear Discharge Is Available. Contact CaptiveAire For Possible Locations.

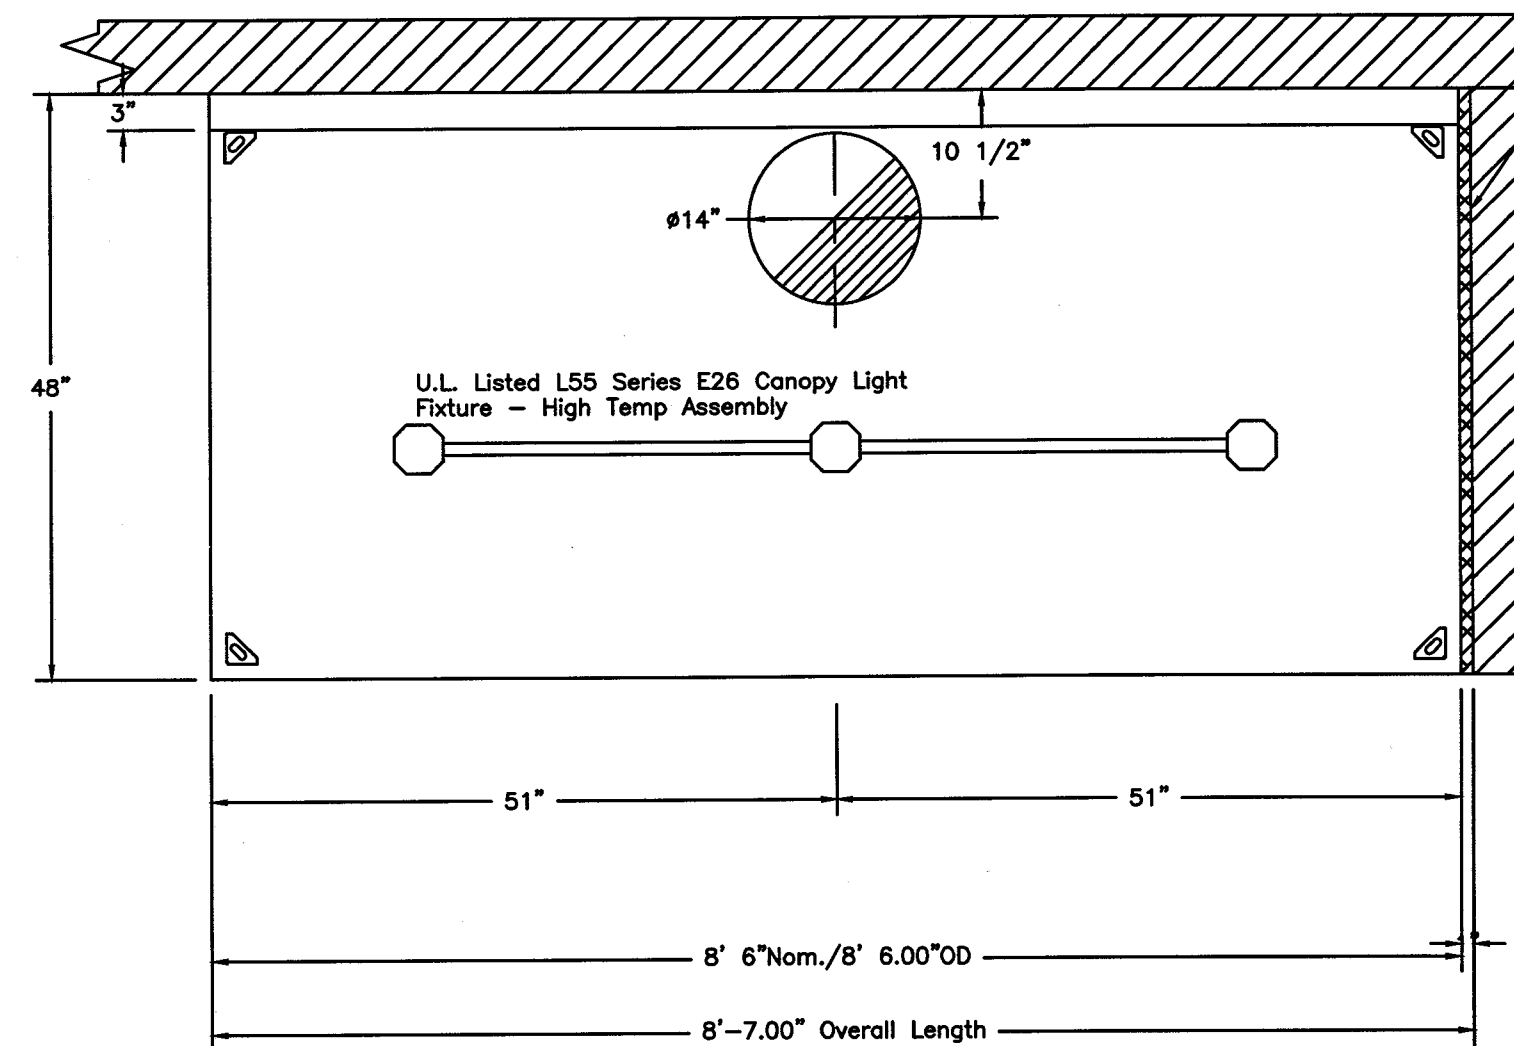

PLAN VIEW - Hood #1
8' 6.00" LONG 4824EX-2

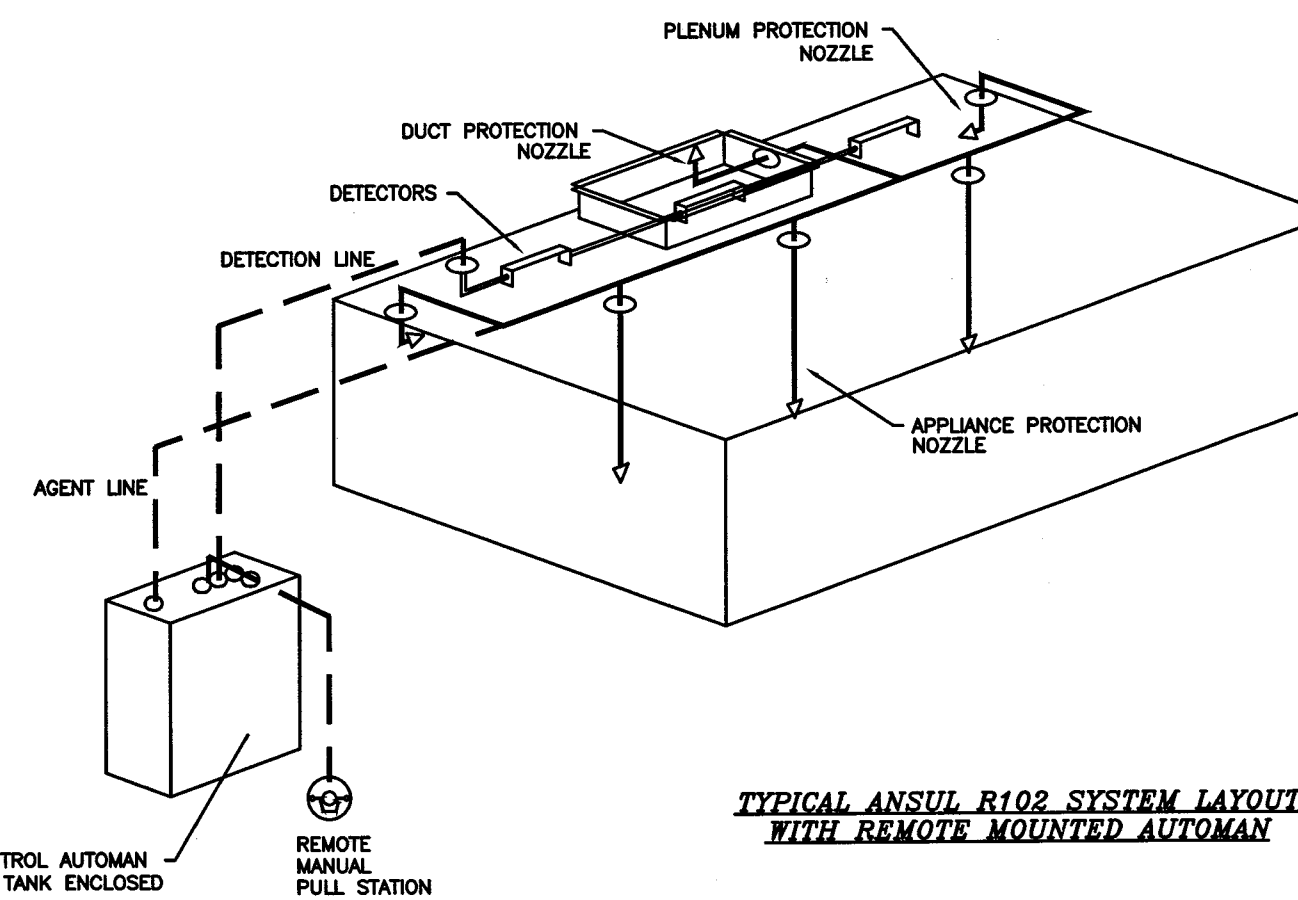

TYPICAL ANSUL R102 SYSTEM LAYOUT
WITH REMOTE MOUNTED AUTOMAN

HVAC DISTRIBUTION NOTE
IT IS RECOMMENDED NOT TO INSTALL HIGH VELOCITY DIFFUSERS OR HVAC RETURNS WITHIN TEN (10) FEET OF THE EXHAUST HOOD. PERFORATED DIFFUSERS ARE RECOMMENDED.

All Exhaust Fans, Tempered/Untempered Make-Up Air Units and Electrical Package to be Start-ed Up and Commissioned by Facotry Field Service Technician. Start-Up Report to be Sent to Engineer by Manufacturer When Complete.

FOR QUESTIONS CALL:
CHARLES FOREY
LOS ANGELES SALES OFFICE
REFERENCE JOB NUMBER
PHONE: 310.876.8505 REG81@CAPTIVEAIRE.COM

WOU
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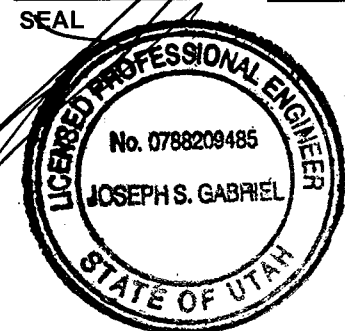
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180028

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REVISIONS

Δ CORRECTION SWIRF 4-19-18
Δ CORRECTION BLDG. 4-26-18

NO. ISSUE DATE

PROJECT DATA

PROJECT NUMBER:
DATE: 4-9-18
DRAWN BY: JK
CHECKED BY: ML
APPROVED BY:

SCALE

SHEET NAME

KITCHEN
HOOD
DETAILS

SHEET NUMBER

M-6



KOREAN BBQ - Midvale, UT rev1
7157 S. State St.,
MIDVALE, UT, 84047


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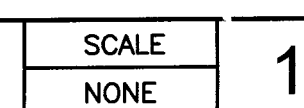
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SPECIFICATIONS


SHEET NO.
1



SCALE	2
NONE	

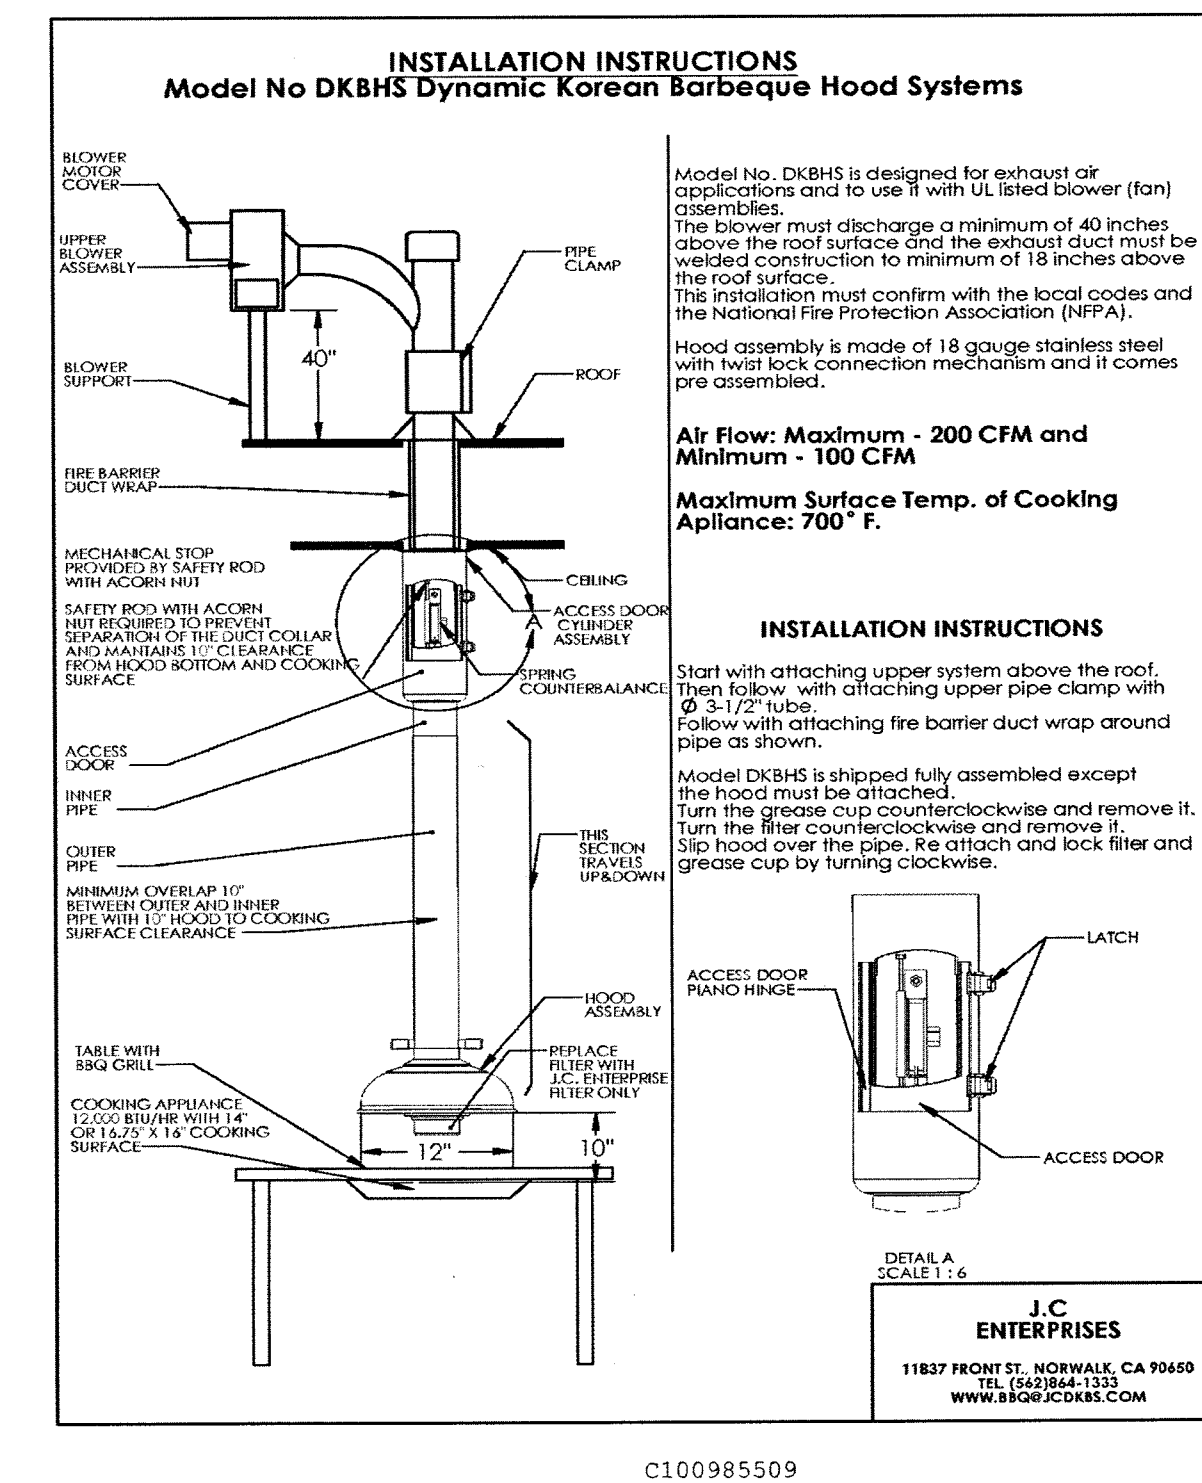

TYPICAL TABLE TOP HOOD & DUCT ELEVATION

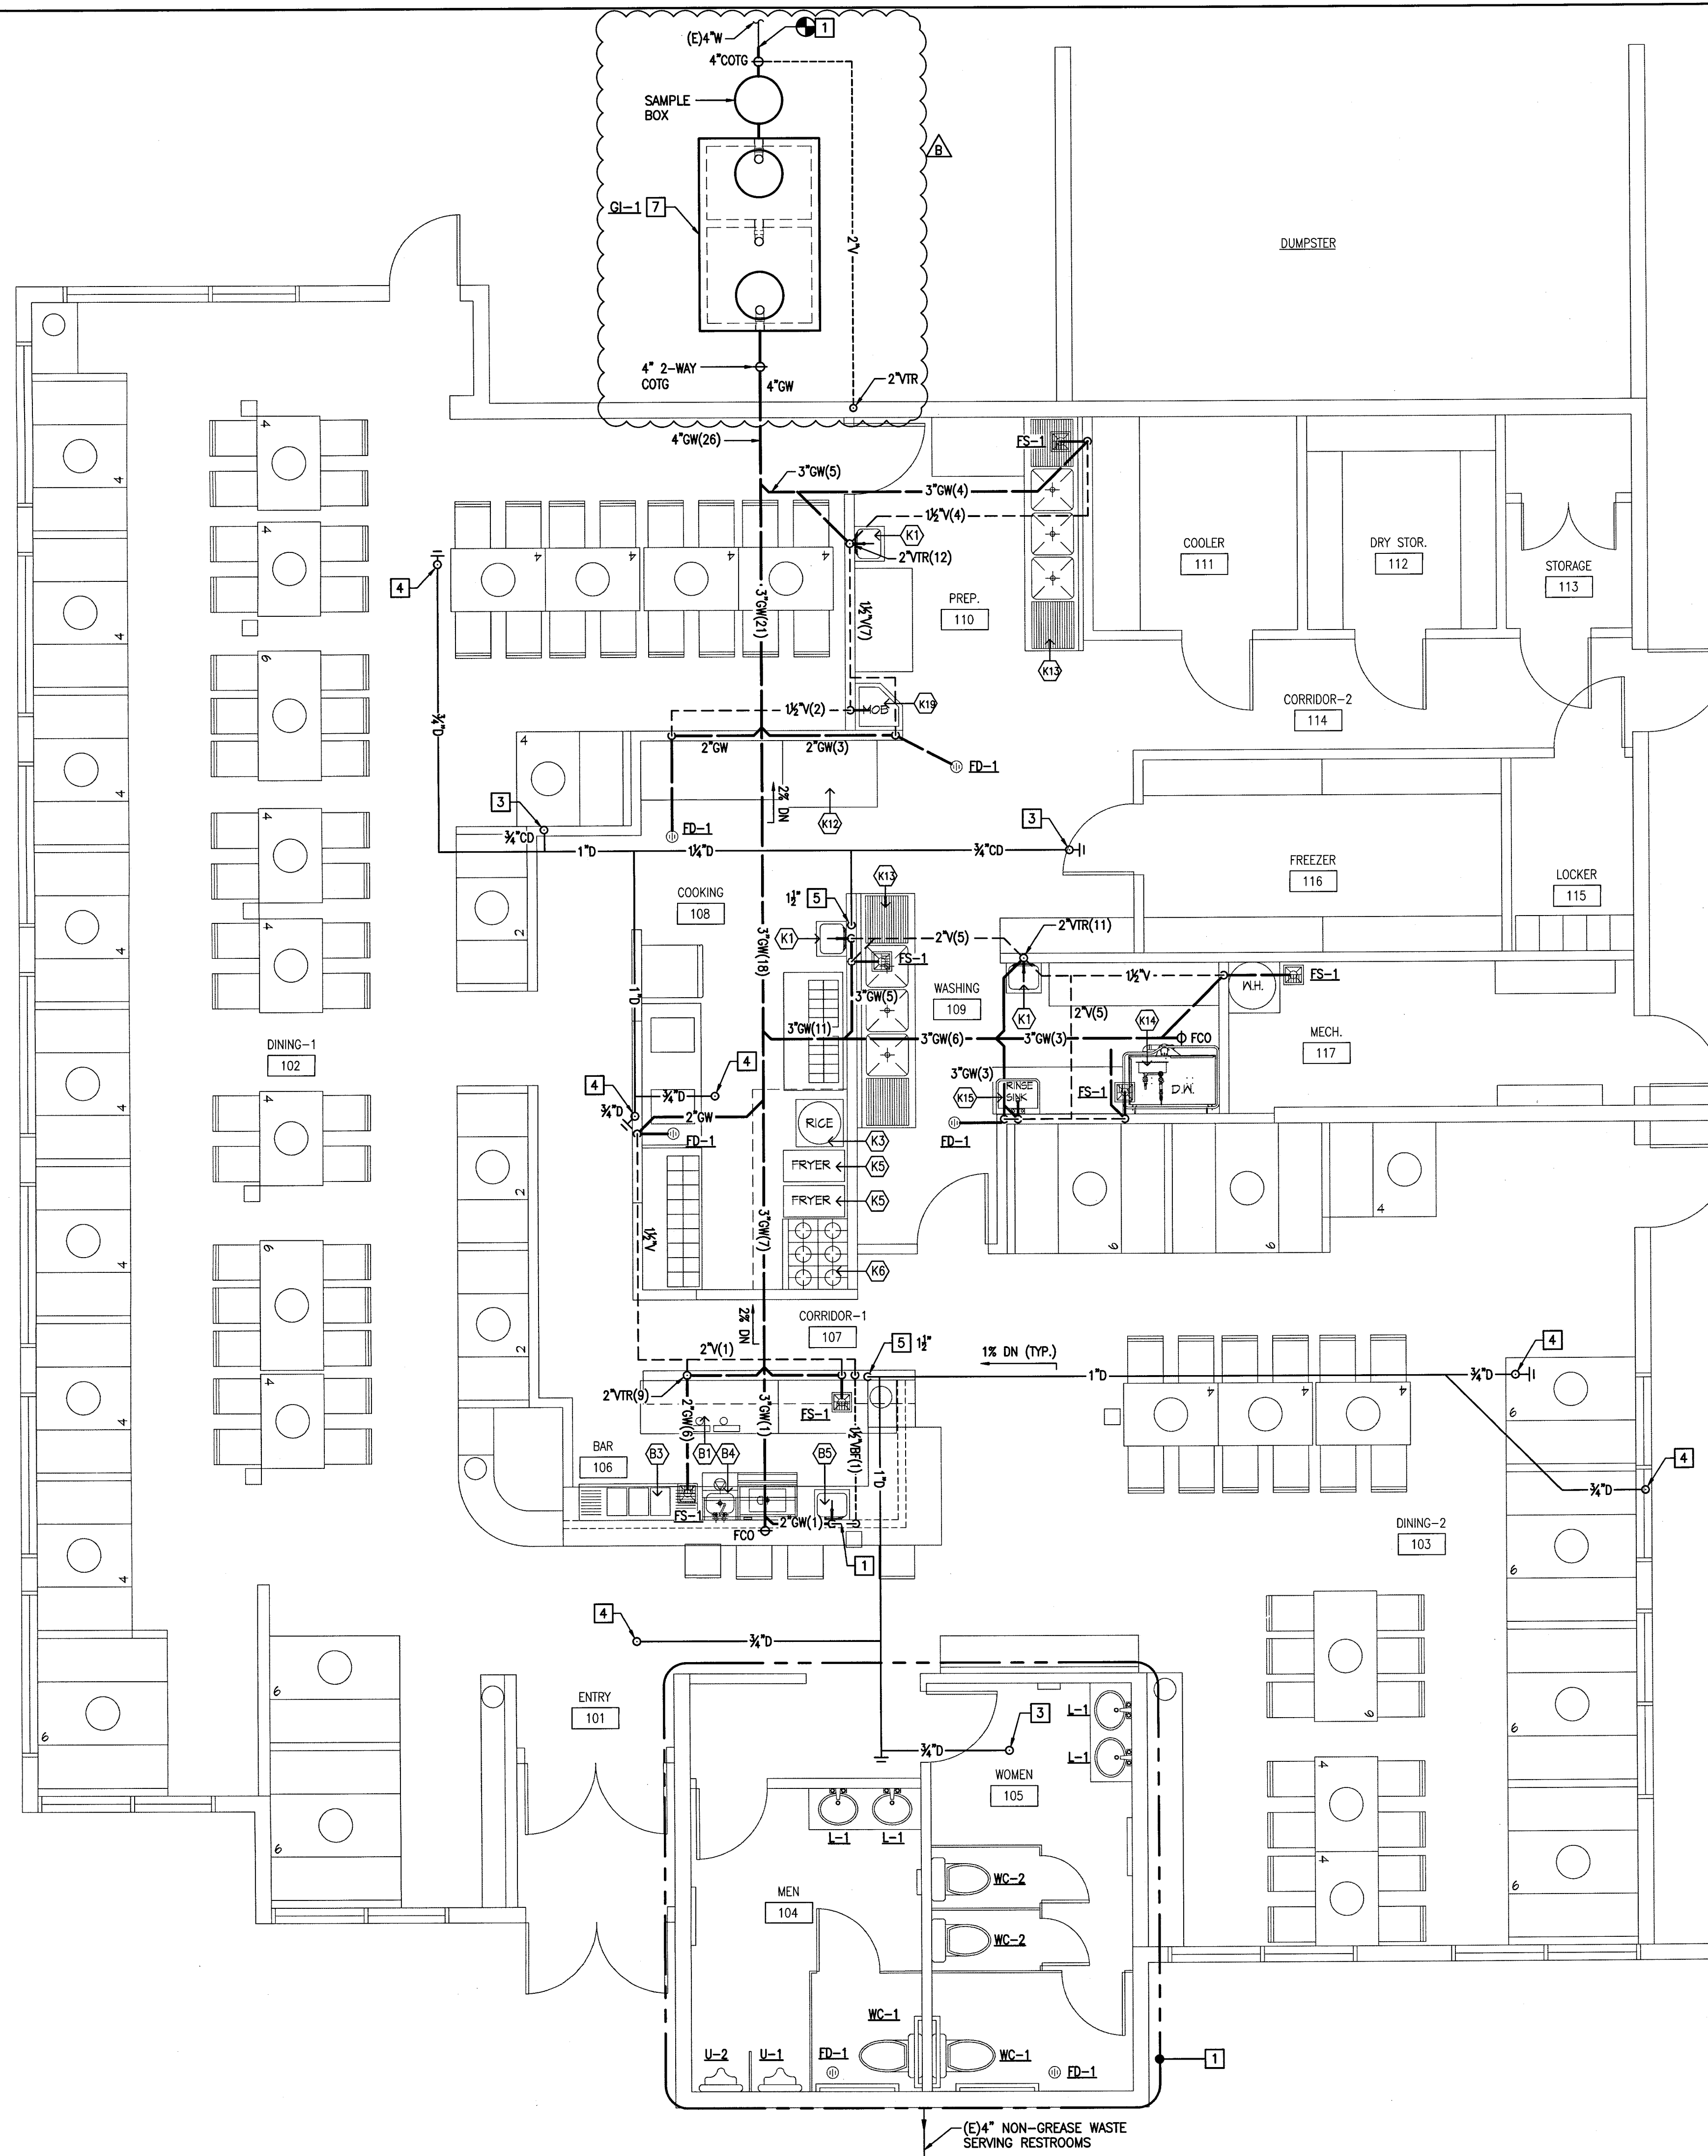

KEYNOTES:

- POINT OF CONNECTION TO (E) 4" WASTE.
- FOR RESTROOMS: REPLACE ALL EXISTING PLUMBING FIXTURES WITH NEW ONES AND RECONNECT TO (E) SANITARY SEWER & VENT.
- 3/4" CONDENSATE DRAIN UP THRU ROOF TO AC UNIT WITH TRAP AND VENT. REFER TO MECHANICAL ROOF PLAN M-4 FOR CONTINUATION.
- 3/4" DRAIN UP THRU ROOF TO MAKE-UP AIR UNIT. REFER TO MECHANICAL ROOF PLAN M-4 FOR CONTINUATION.
- DRAIN DOWN IN WALL AND SPILL TO ABOVE FLOOR SINK WITH MINIMUM 1" AIR GAP.
- PROVIDE VENT LOOP AS HIGH AS 6" ABOVE FLOOD LEVEL BEFORE ROUTING TO BELOW FLOOR.
- 1000 GALLON PRECAST GREASE INTERCEPTOR UNDER GROUND WITH SAMPLE BOX. REFER DETAILS ON SHEETS P-5 AND A-4.4.

GENERAL NOTES:

- VERIFY EXACT LOCATION & SIZE OF EXISTING WASTE PIPES PRIOR TO INSTALLATION. CONTACT ARCHITECT OR MECHANICAL ENGINEER IF THERE ARE ANY CONFLICTS BETWEEN THESE PLANS AND WHAT'S EXISTING ON THE JOB SITE.
- ALL EXISTING PIPING SHOWN ON THIS DRAWINGS ARE CLOSE APPROXIMATIONS AND SHALL BE VERIFIED PRIOR TO INSTALLATION OR BID.
- ALL PIPING SHOWN ON THIS DRAWING SHALL BE CONSIDERED NEW UNLESS NOTED OTHERWISE.

PLUMBING FLOOR PLAN - WASTE & VENT

SCALE: 1/4" = 1'-0"

WOU

DESIGN PARTNERS

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LOS ANGELES, CA 90010

- ARCHITECTURE BRANDING
- INTERIOR BRANDING
- PLANNING
- LAND-USE CONSULTATION


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REVISIONS

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- CORRECTION BLDG. 4-26-18

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PROJECT NUMBER:
DATE: 4-9-18
DRAWN BY: JK
CHECKED BY: ML
APPROVED BY:

SCALE

SHEET NAME

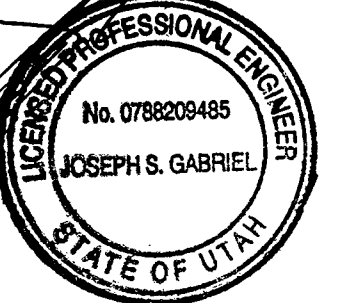**PLUMBING
FLOOR PLAN -
WASTE & VENT**

SHEET NUMBER

P-2

Korean BBQ of Utah
7157 S. State Street
Midvale, Utah, 84047

REVISIONS		
A	CORRECTION SHWR	4-19-18
B	CORRECTION BLDG.	4-26-18

NO.	ISSUE	DATE
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PROJECT DATA	
PROJECT NUMBER:	
DATE:	4-9-18
DRAWN BY:	JK
CHECKED BY:	ML
APPROVED BY:	


SCALE

SHEET NAME

**PLUMBING
FLOOR PLAN -
WATER**

SHEET NUMBER

P-3

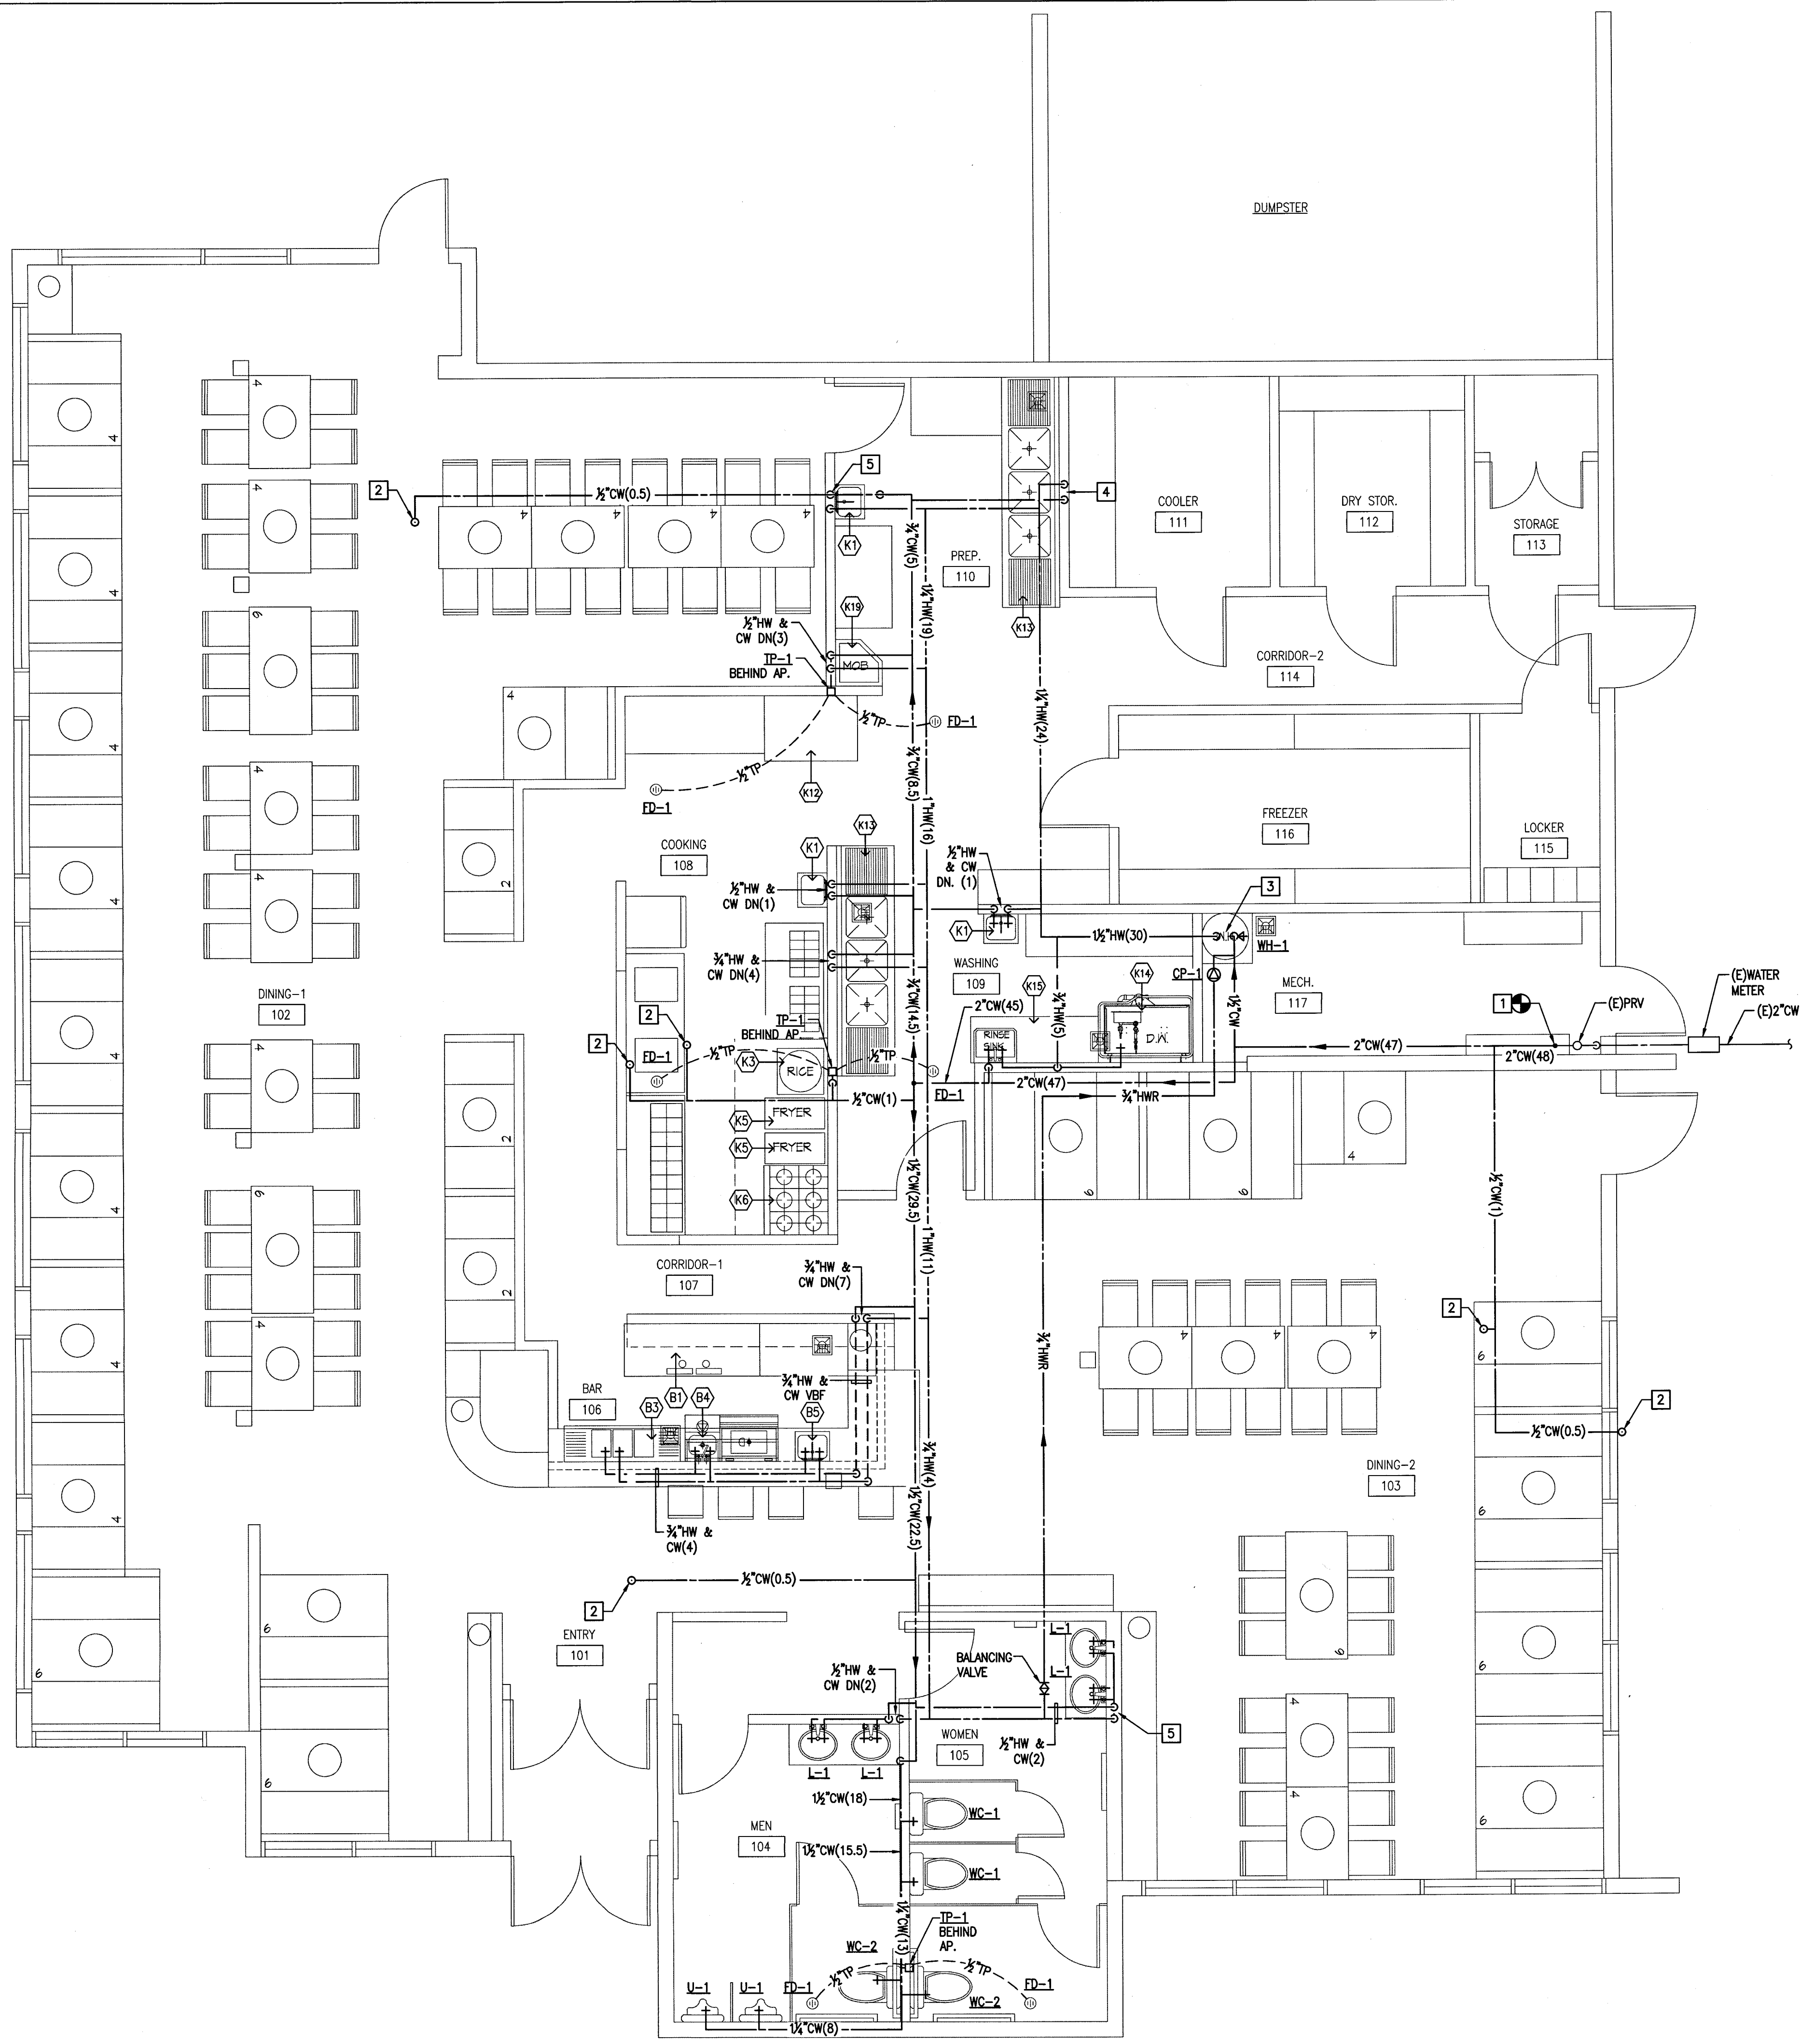


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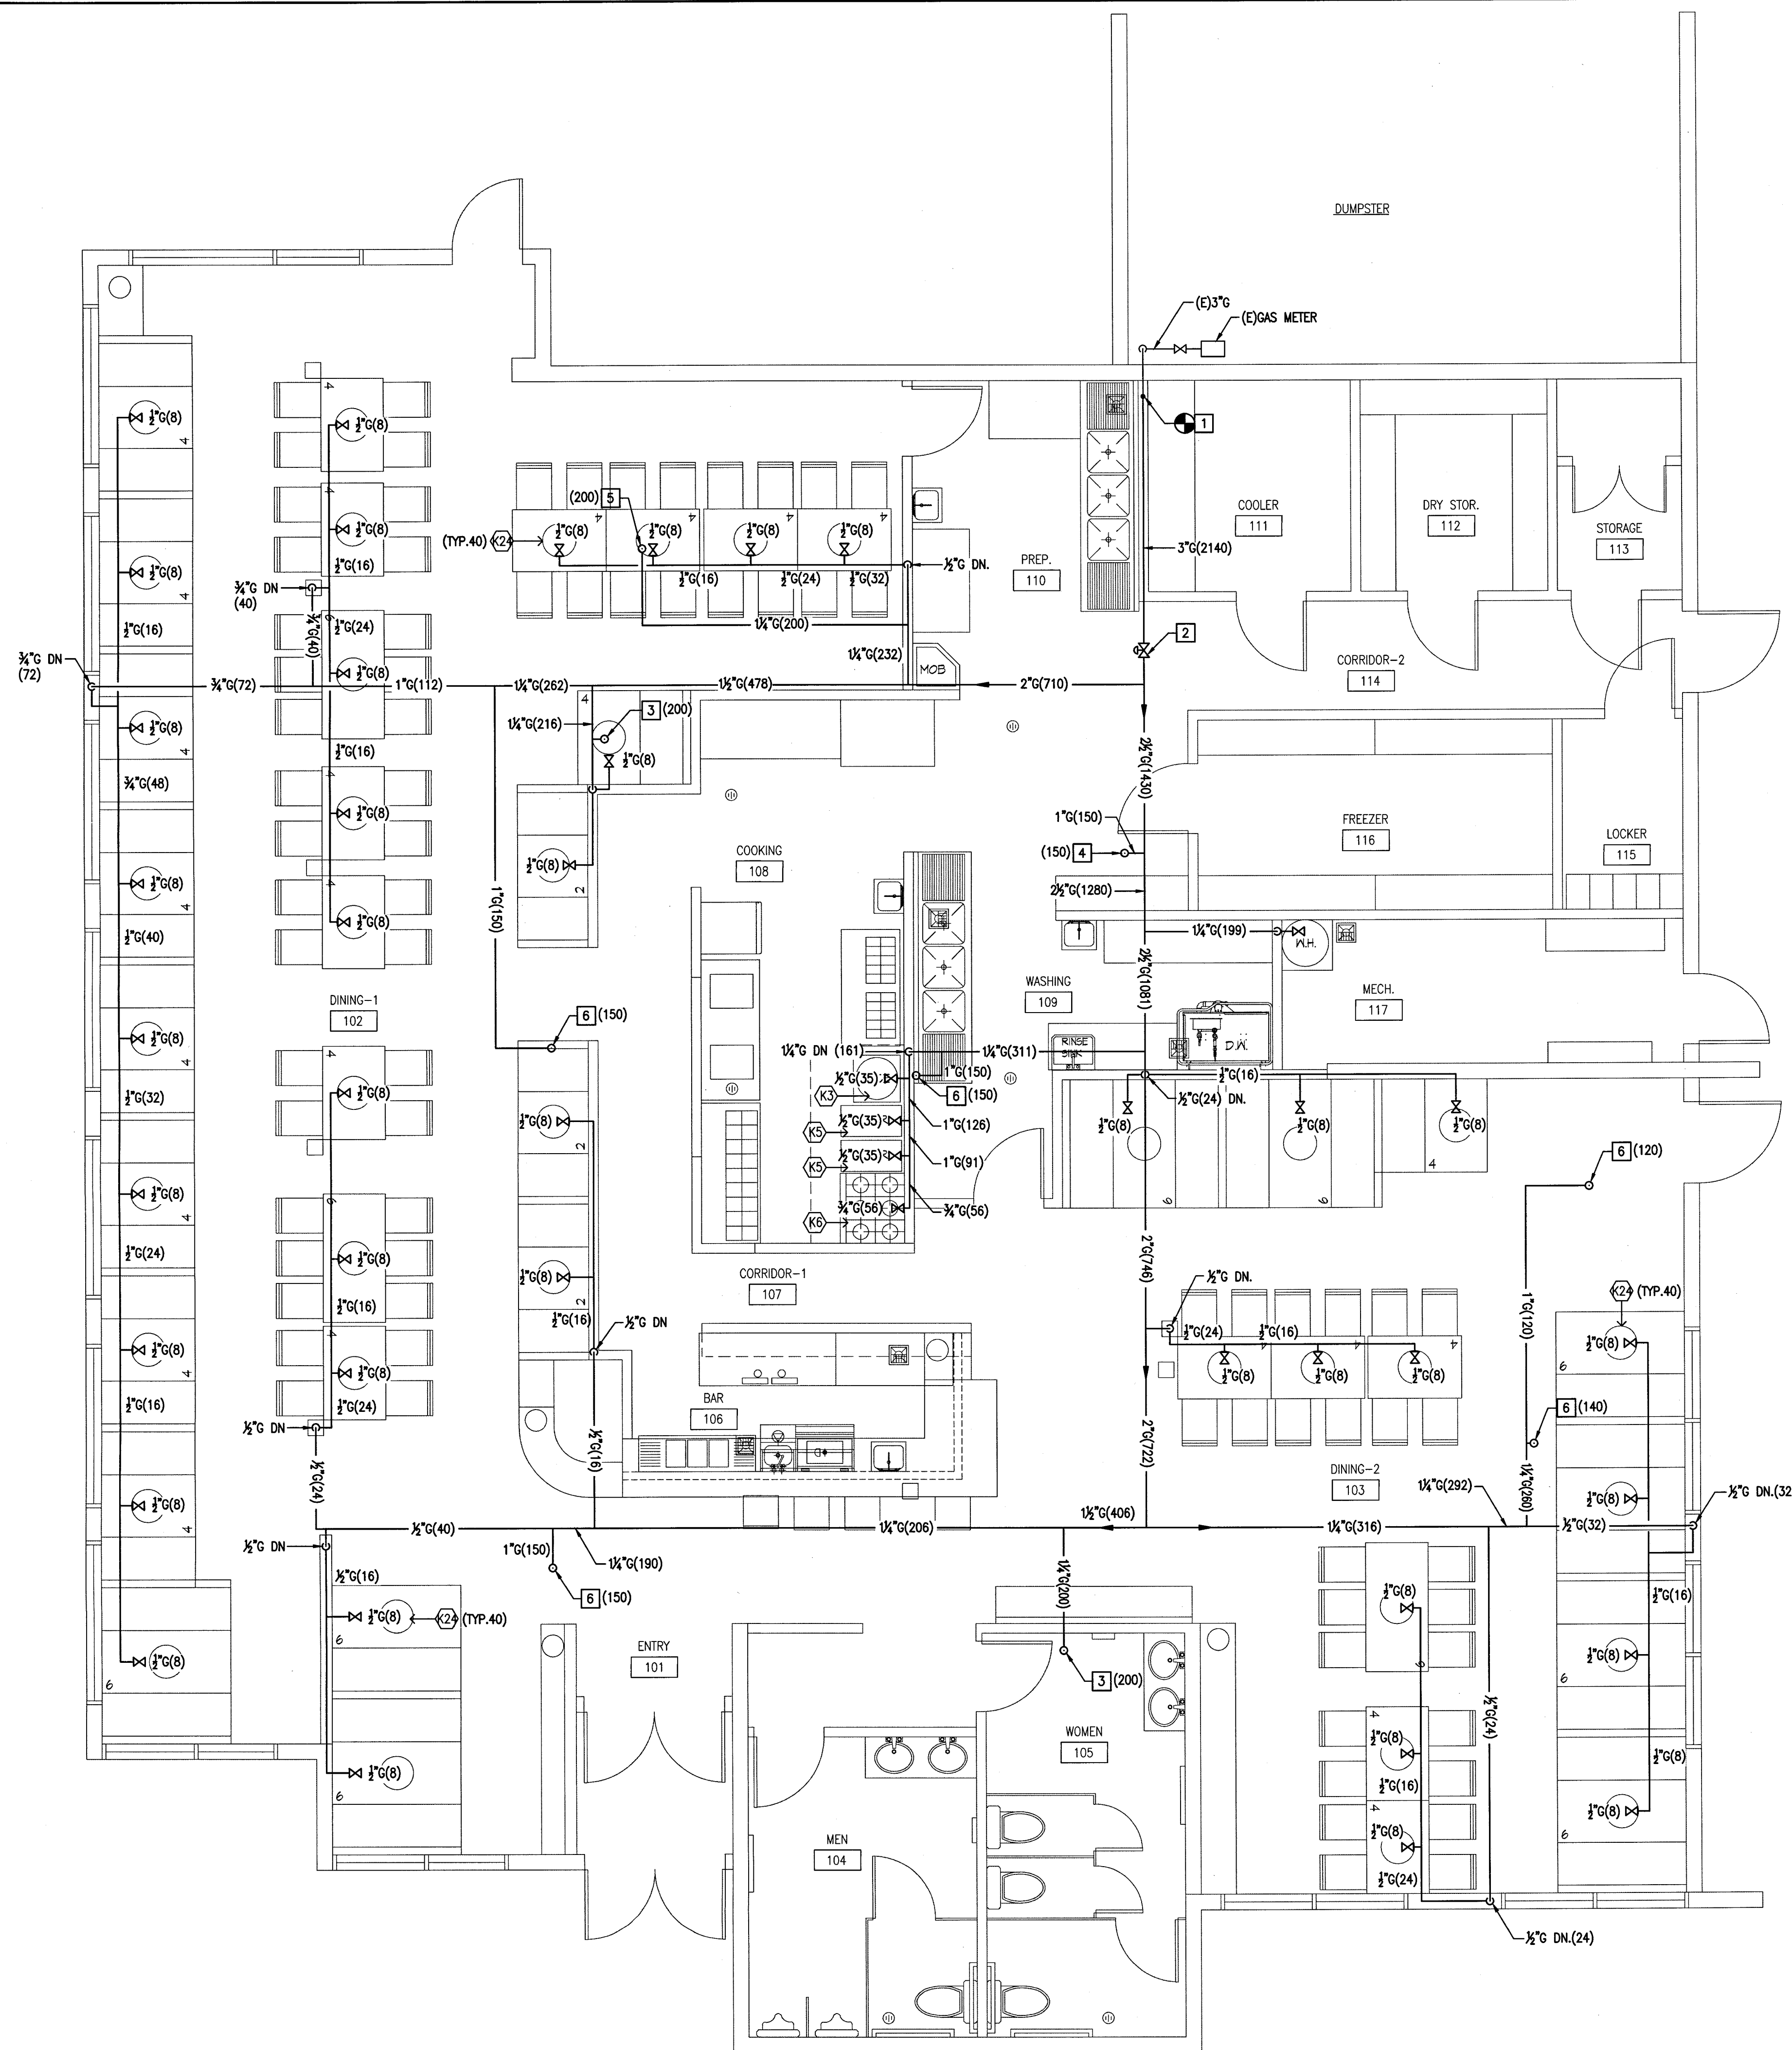
- 1 POINT OF CONNECTION TO EXISTING 2" COLD WATER AT THIS LOCATION.
- 2 1/2" COLD WATER UP THRU ROOF TO MAKE-UP AIR UNIT. REFER TO MECHANICAL ROOF PLAN M-4 FOR CONTINUATION.
- 3 1/2" HW & CW DOWN TO WATER HEATER.
- 4 3/4" HW & CW DOWN IN WALL.
- 5 1/2" HW & CW DOWN IN WALL.

GENERAL NOTES:

1. VERIFY EXACT LOCATION & SIZE OF EXISTING COLD WATER PIPING PRIOR TO INSTALLATION. CONTACT ARCHITECT OR MECHANICAL ENGINEER IF THERE ARE ANY CONFLICTS BETWEEN THESE PLANS AND WHAT'S EXISTING ON THE JOB SITE.
2. ALL EXISTING PIPING SHOWN ON THIS DRAWINGS, ARE CLOSE APPROXIMATIONS & SHALL BE VERIFIED PRIOR TO INSTALLATION & OR BID.
3. ALL PIPING SHOWN ON THIS DRAWING SHALL BE CONSIDERED NEW UNLESS NOTED OTHERWISE.

PLUMBING FLOOR PLAN - WATER
SCALE: 1/4" = 1'-0"



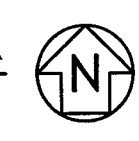

KEYNOTES:

- POINT OF CONNECTION TO EXISTING 3" GAS.
- AUTOMATIC SOLENOID GAS SHUT-OFF VALVE IN ACCESSIBLE LOCATION. INTERLOCK WITH HOOD FIRE SUPPRESSION SYSTEM.
- 1 1/2" GAS UP THRU ROOF TO AC UNIT. REFER TO MECHANICAL ROOF PLAN M-4 FOR CONTINUATION.
- 1" GAS UP THRU ROOF TO AC UNIT. REFER TO MECHANICAL ROOF PLAN M-4 FOR CONTINUATION.
- 1 1/2" GAS UP THRU ROOF TO MAKE-UP AIR UNIT. REFER TO MECHANICAL ROOF PLAN M-4 FOR CONTINUATION.
- 1" GAS UP THRU ROOF TO MAKE-UP AIR UNIT. REFER TO MECHANICAL ROOF PLAN M-4 FOR CONTINUATION.

GAS NOTES:

- GAS PIPING IS SIZED PER 2015 IPC TABLE 402.4(2) (LOW PRESSURE) SCHEDULE 40 METALLIC PIPE
- GAS DEMAND AND TOTAL DEVELOPED LENGTH:
GAS TYPE: NATURAL
INLET PRESSURE: LESS THAN 2 PSI
PRESSURE DROP: 0.5 IN. W.C.
SPECIFIC GRAVITY: 0.60
GAS LOAD: WATER HEATER = 199 CFH
KITCHEN COOK EQUIPMENT = 181 CFH
TABLE BURNER (8.0x40) = 320 CFH
AIR CONDITIONING UNIT = 550 CFH
MAKE-UP AIR UNIT = 910 CFH
TOTAL LOAD = 2140 CFH
TOTAL DEV. LENGTH TO METER (PIPE RUN) = 150 FEET

GAS PIPE SIZING TABLE	
PIPE SIZE	CFH
1/2"	40
3/4"	83
1"	157
1-1/4"	322
1-1/2"	482
2"	928
2-1/2"	1480
3"	2610
4"	5330







GENERAL NOTES:


- VERIFY EXACT LOCATION & SIZE OF EXISTING GAS METER & PIPING PRIOR TO INSTALLATION. CONTACT ARCHITECT OR MECHANICAL ENGINEER IF THERE ARE ANY CONFLICTS BETWEEN THESE PLANS AND WHAT'S EXISTING ON THE JOB SITE.
- ALL EXISTING PIPING SHOWN ON THIS DRAWING ARE CLOSE APPROXIMATIONS AND SHALL BE VERIFIED PRIOR TO INSTALLATION OR BID.
- ALL PIPING SHOWN ON THIS DRAWING SHALL BE CONSIDERED NEW UNLESS NOTED OTHERWISE.

PLUMBING FLOOR PLAN - GAS

SCALE: 1/4" = 1'-0"



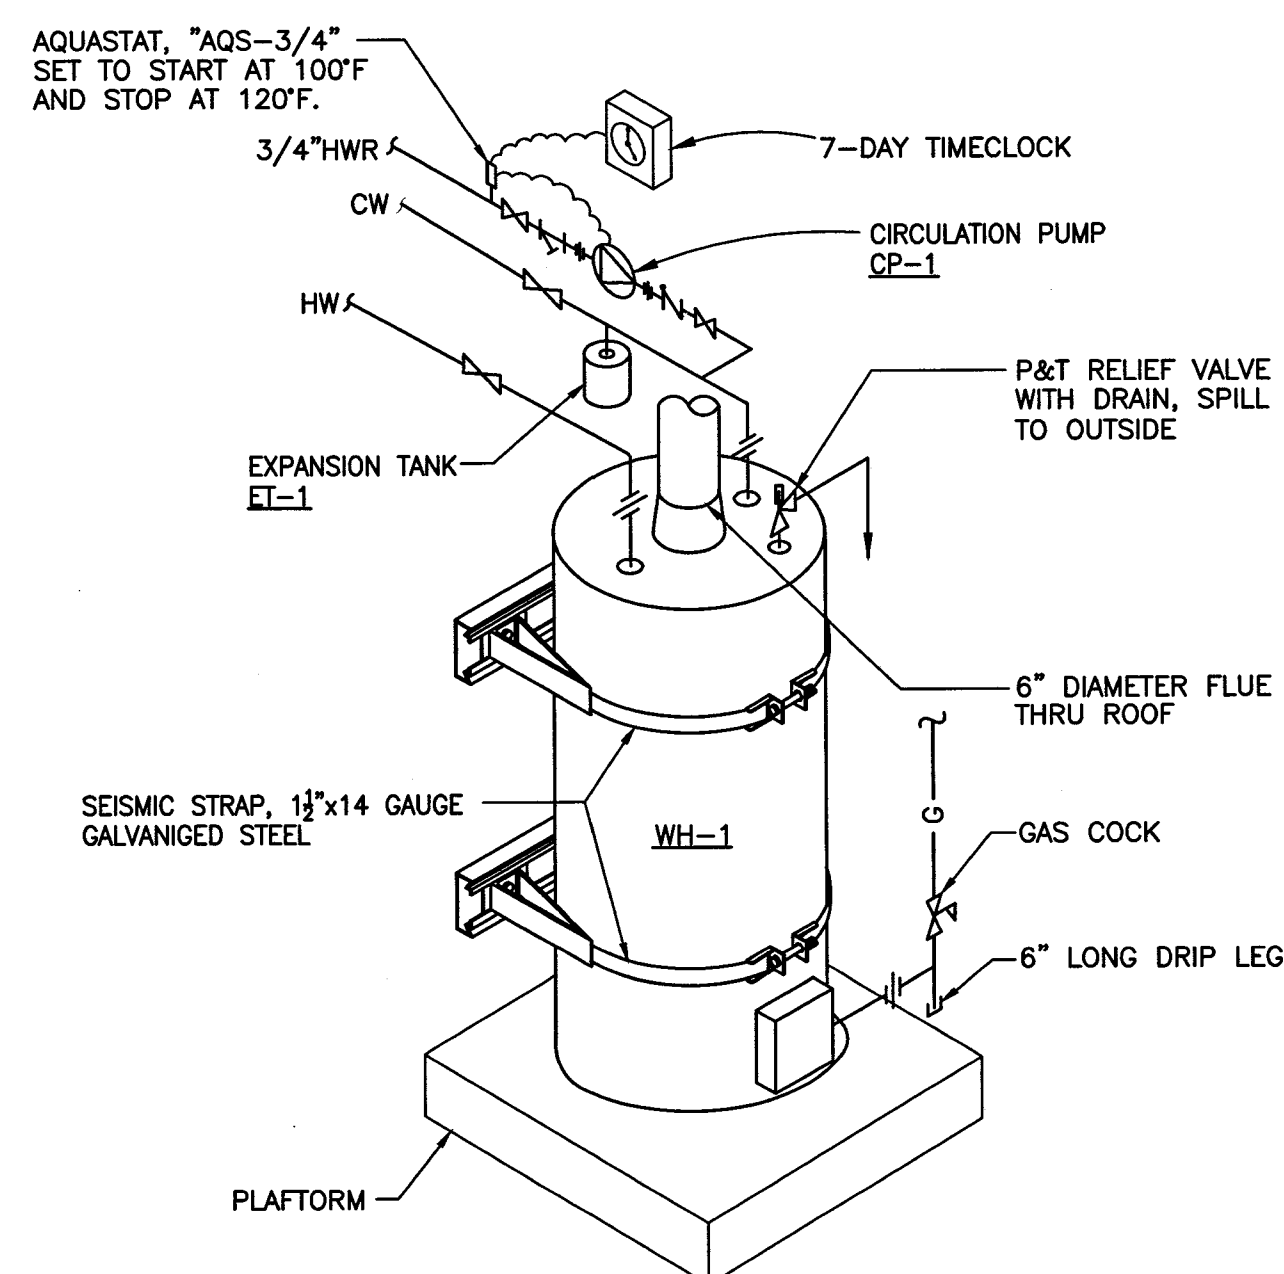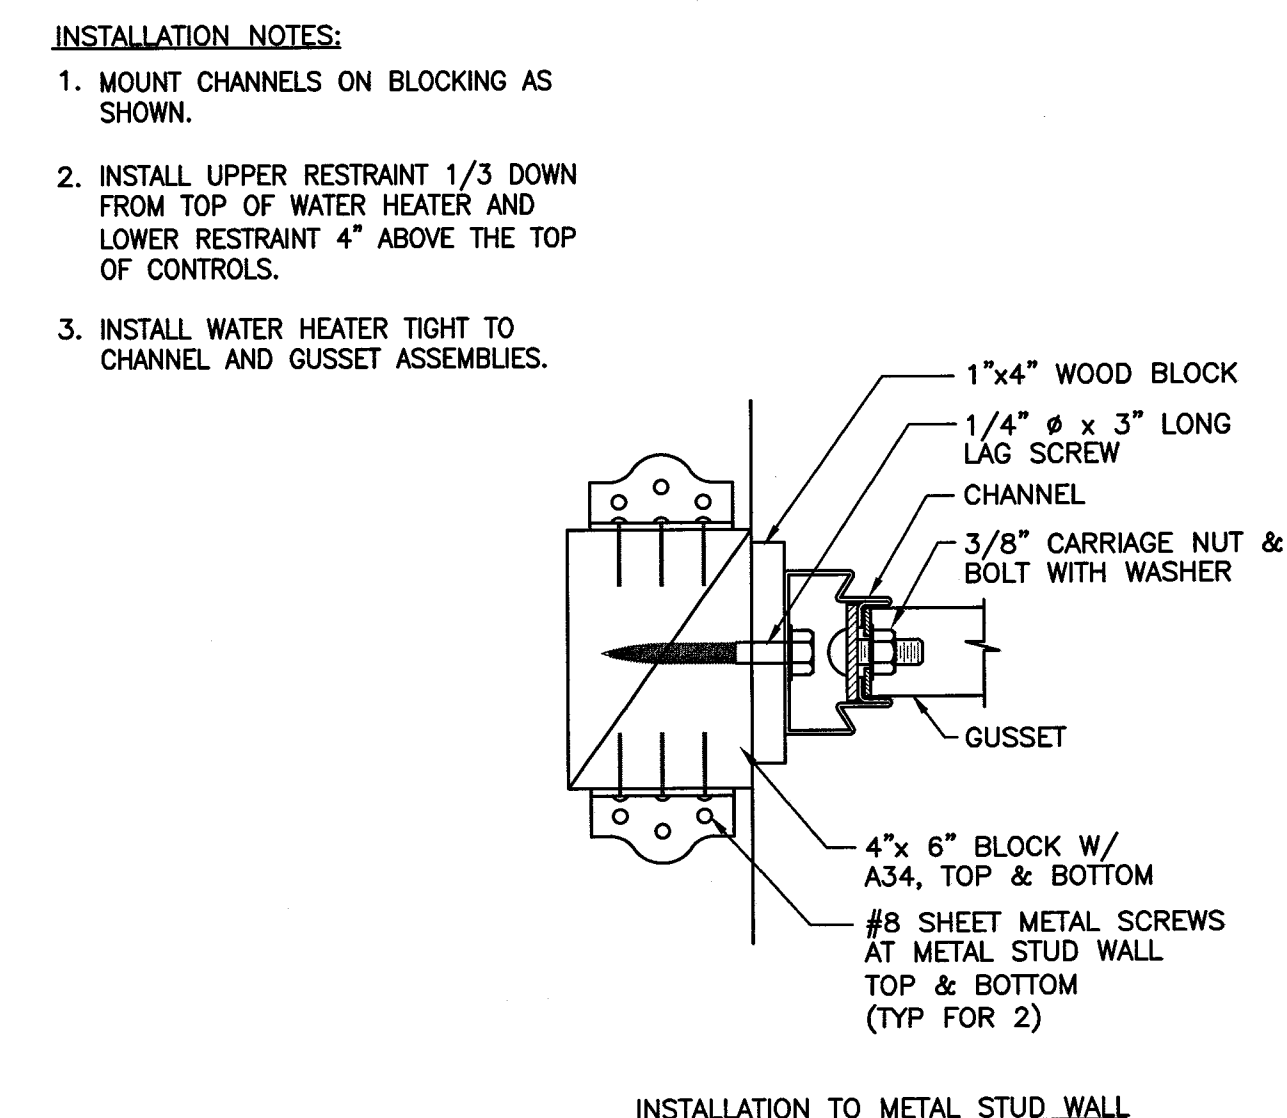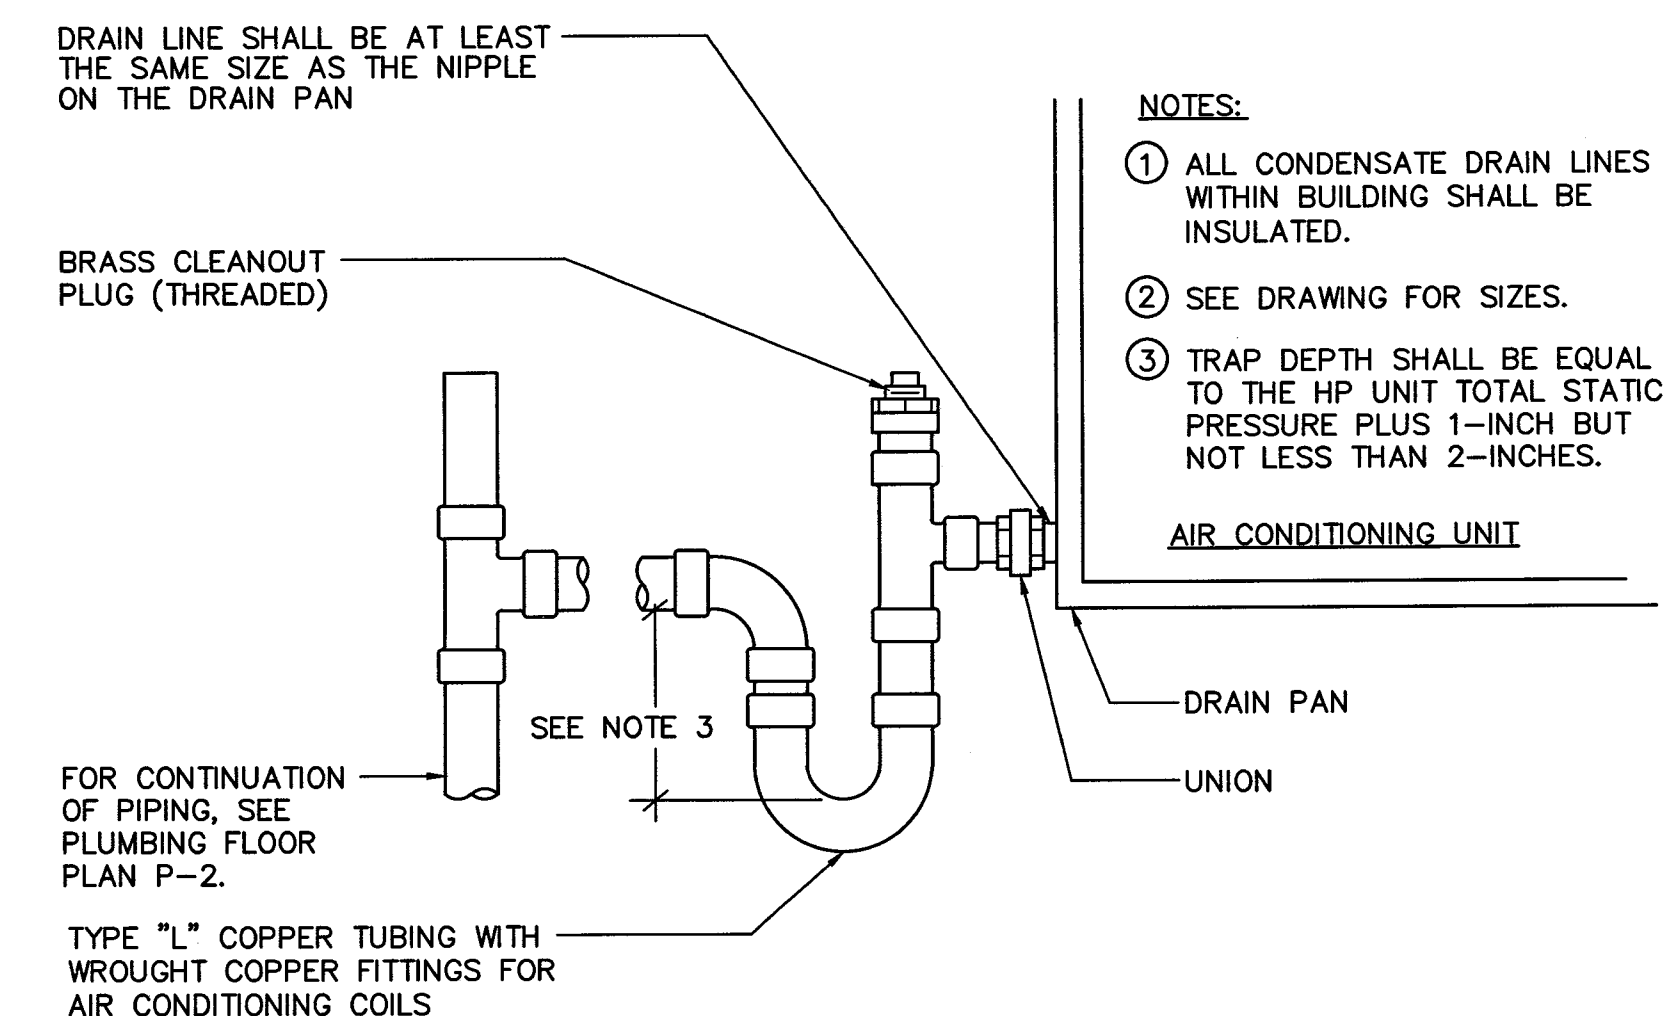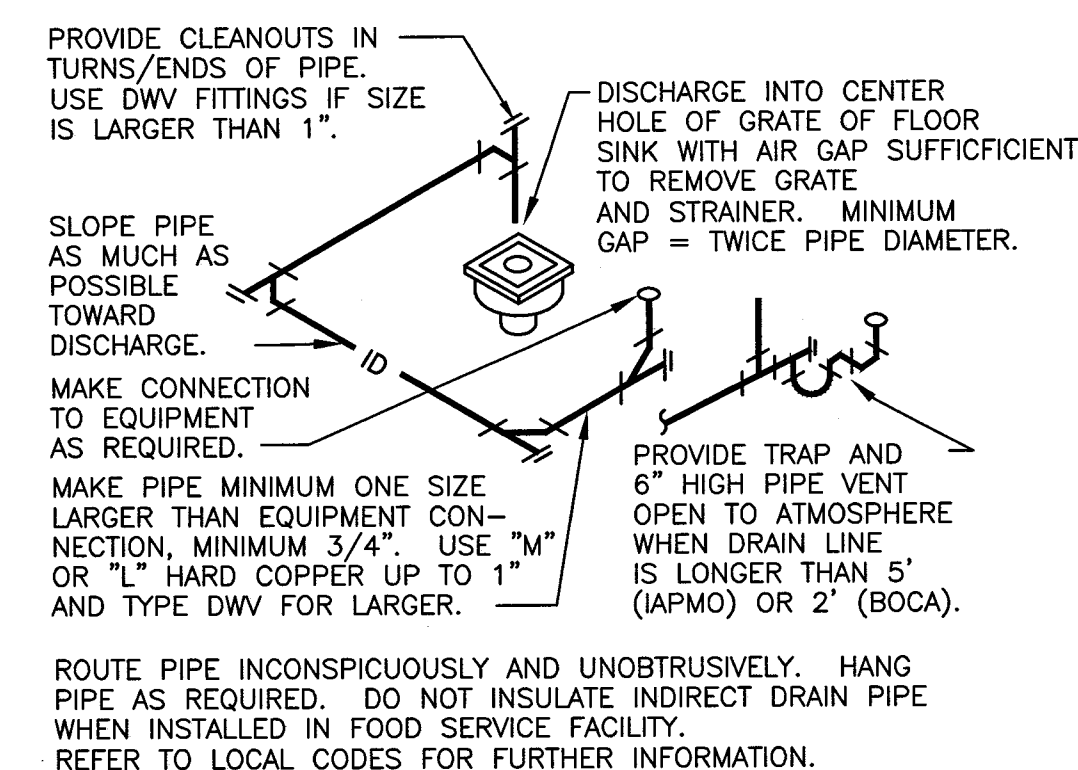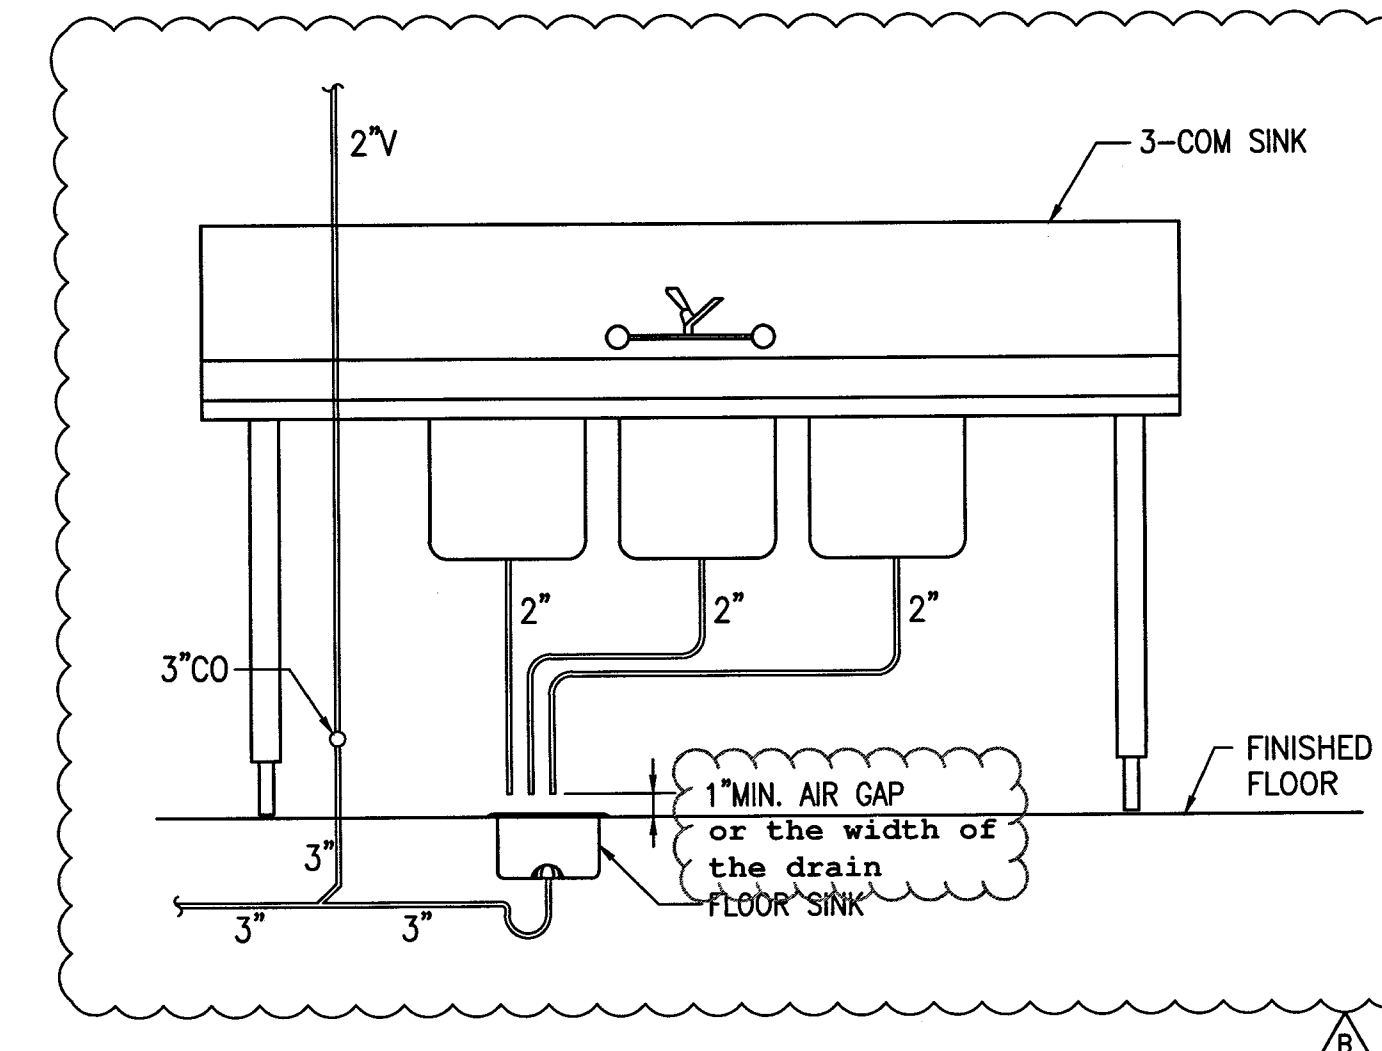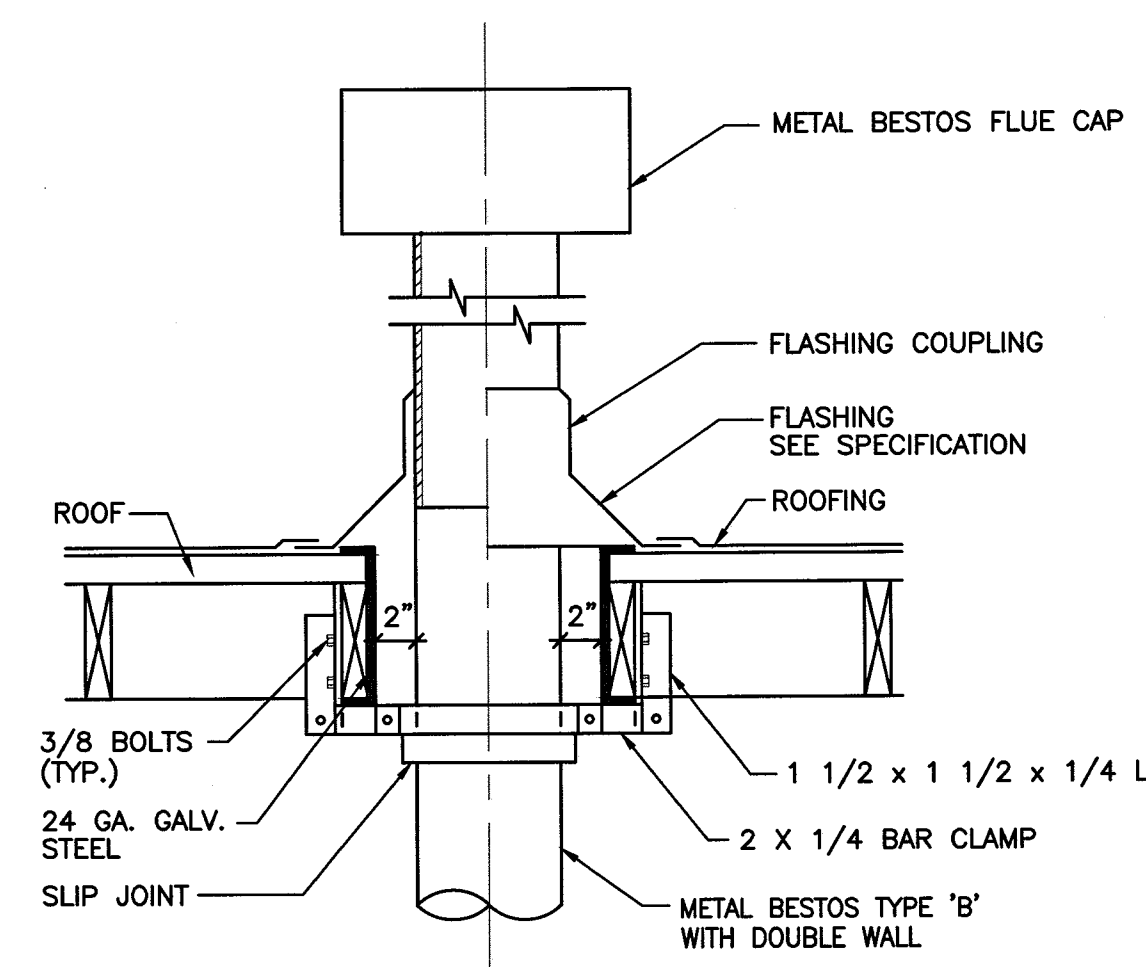

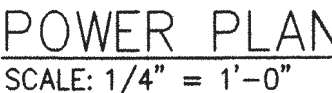[illegible]

WOU
DESIGN PARTNERS

3470 WILSHIRE BLVD. SUITE 930
LOS ANGELES, CA 90010

- ARCHITECTURE BRANDING
- INTERIOR BRANDING
- PLANNING
- LAND-USE CONSULTATION


SEAL

PROFESSIONAL ENGINEER
No. 078826-005
JOSEPH S. GABRIEL
STATE OF UTAH

TITLE

Korean BBQ of Utah
7157 S. State Street
Midvale, Utah, 84047

REVISIONS		
CORRECTION BLDG. 5-17-18		
NO.	ISSUE	DATE
PROJECT DATA		
PROJECT NUMBER :		180367
DATE :		03/16/18
DRAWN BY :		CB
CHECKED BY :		PC
APPROVED BY :		
SCALE		
SHEET NAME		
SHEET NUMBER		

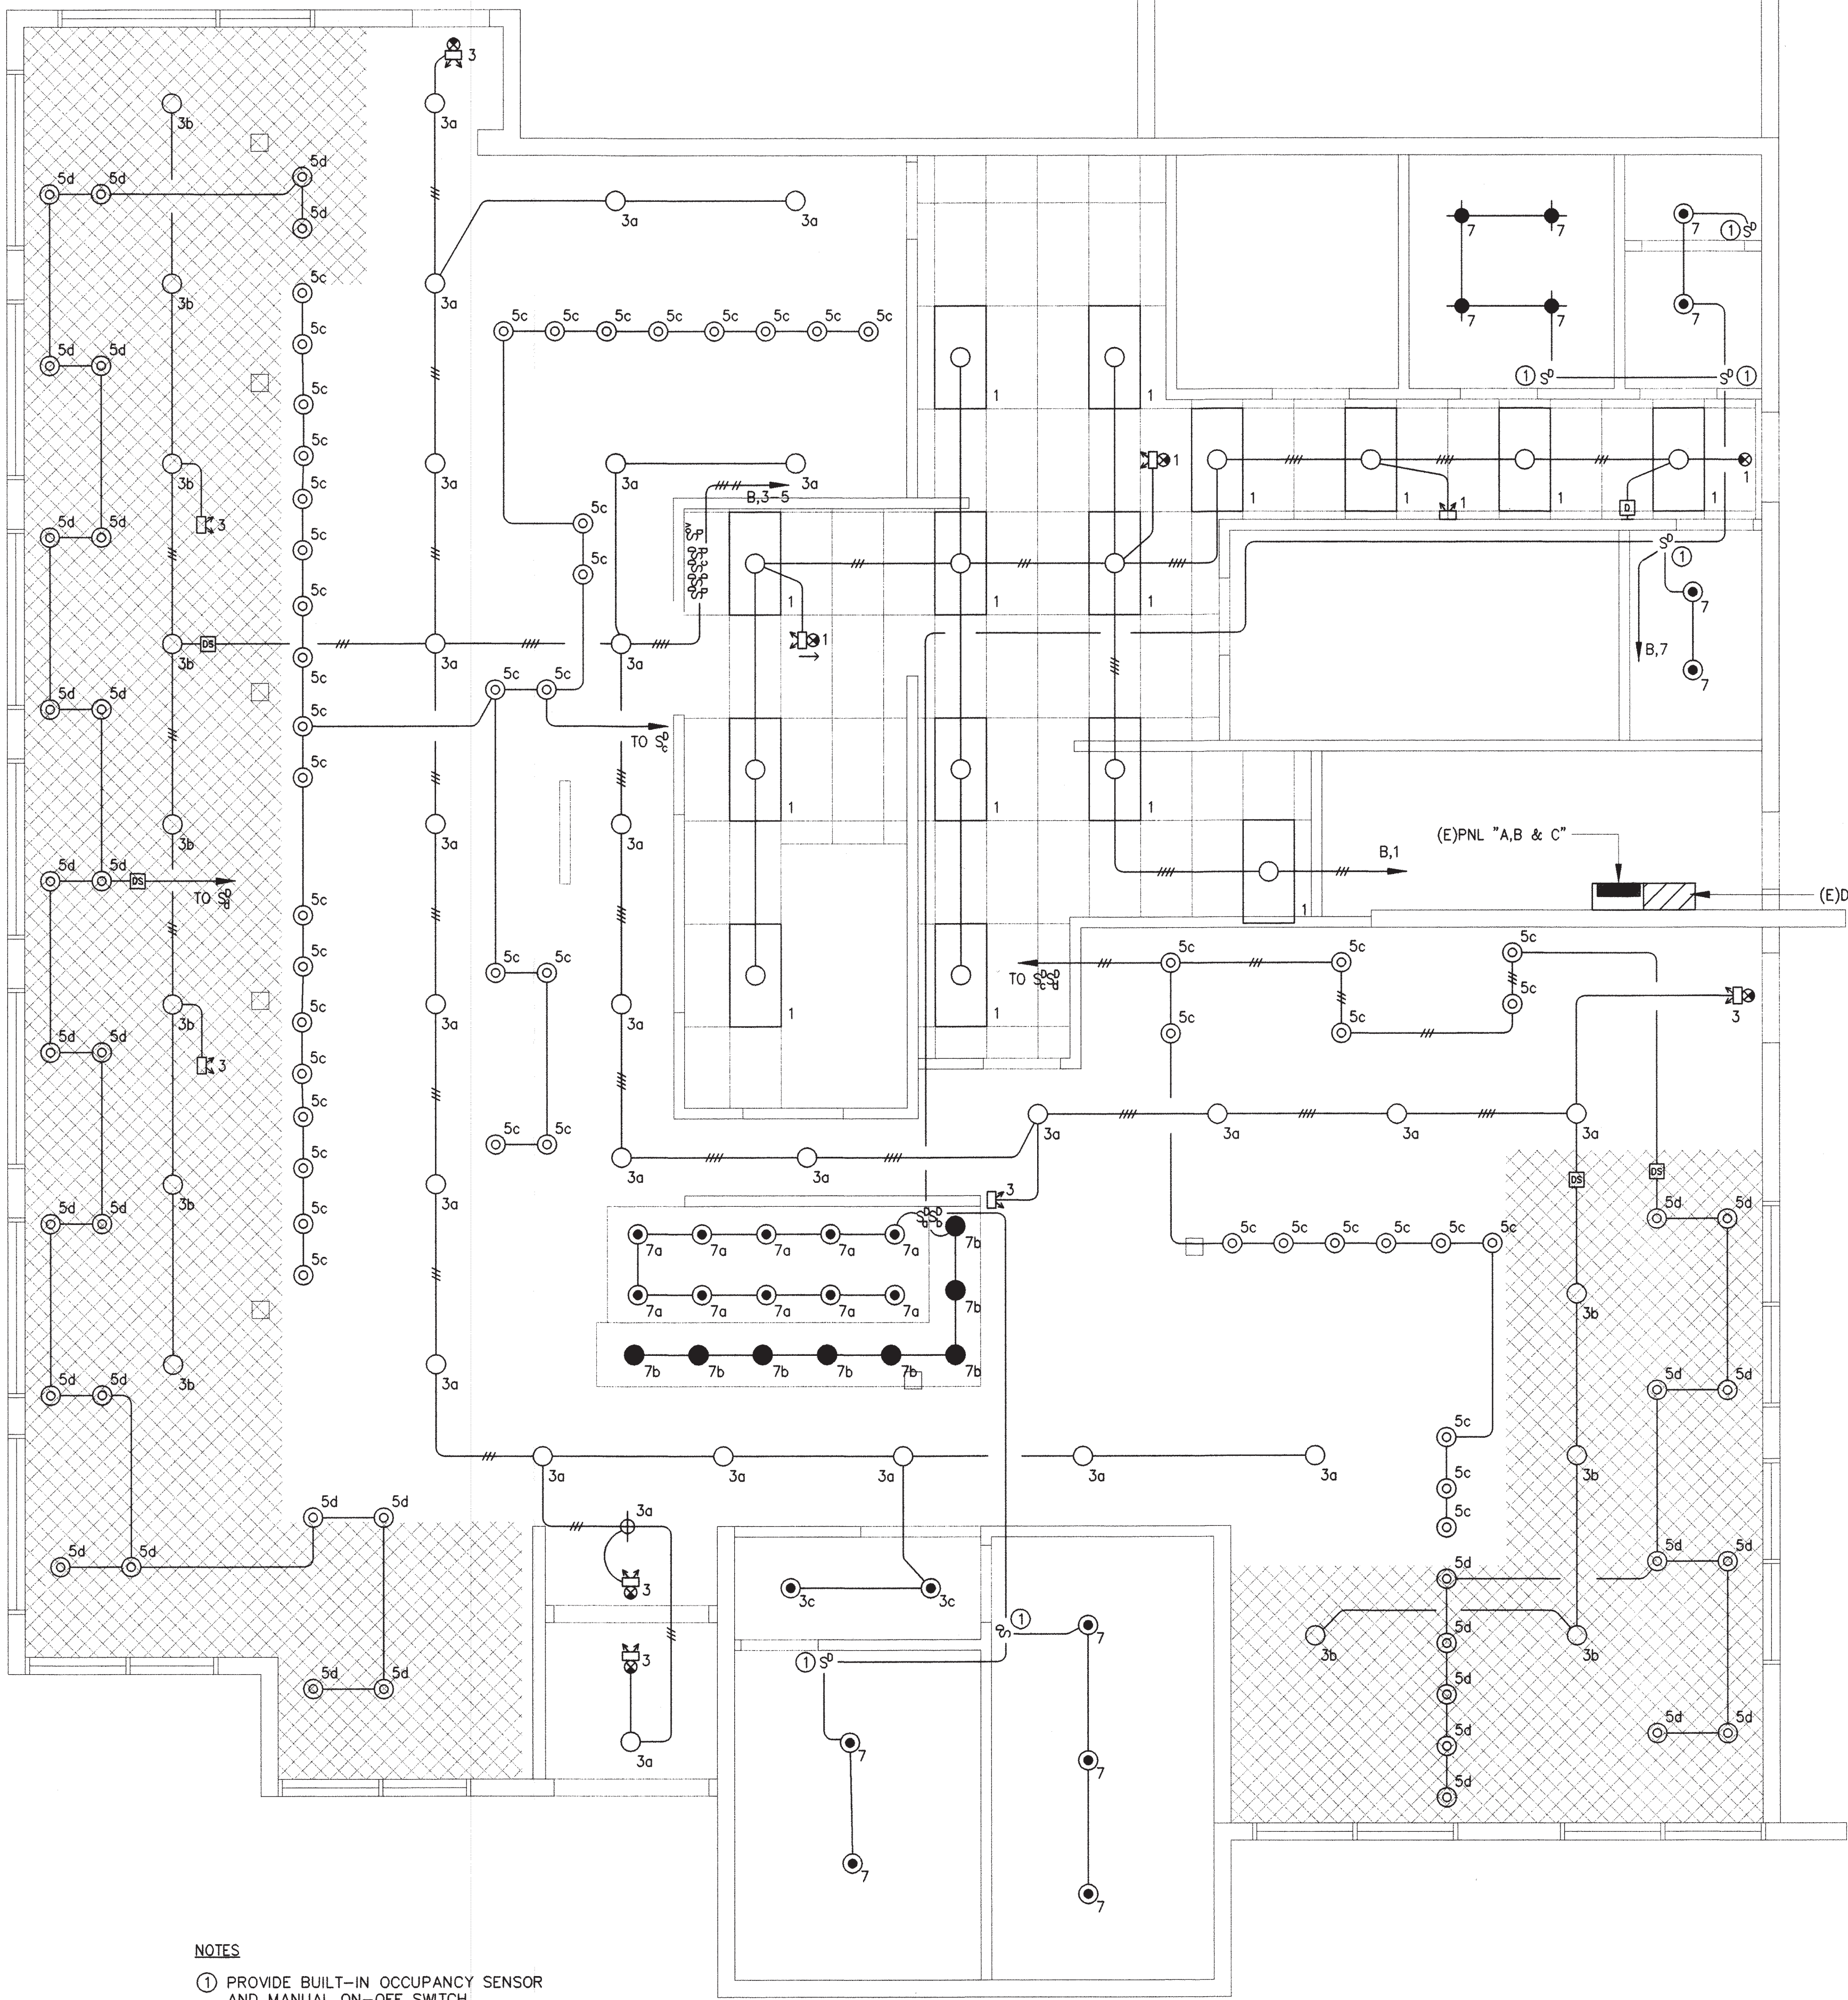


LIGHTING PLAN
SCALE: 1/4" = 1'-0"

LEGEND
PRIMARY SIDELIGHT DAYLIGHT AREA
(HATCHED)

LIGHTING FIXTURE SCHEDULE

SYMBOL	TYPE	VOLT	LAMP	MTD	DESCRIPTION/MANUFACTURER
	A	120	49W LED 4884 LUMENS	R	2' X 4' LED LIGHT WITH 0-10VDC DIMMER DRIVER
	L1	120	21W LED	R	LED DOWN LIGHT
	L2	120	9.5W LED	P	LED PENDANT LIGHT
	L3	120	9.5W LED	P	LED PENDANT LIGHT
	L5	120	15.5W LED	R	LED DOWN LIGHT
	L6	120	15W LED	R	LED DOWN LIGHT
	L7	120	12W LED	S	LED LIGHT
	E	120	25W	S	EMERGENCY LIGHT WITH 90 MIN. BATTERY BACKUP
	X	120	5W LED	S	EXIT SIGN WITH 90 MIN. BATTERY BACKUP
	EX	120	5W LED, 25W	S	EXIT SIGN AND EMERGENCY LIGHT WITH 90 MIN. BATTERY BACKUP


ALL LIGHTS SHALL BE SELECTED BY OWNER/ARCHITECT

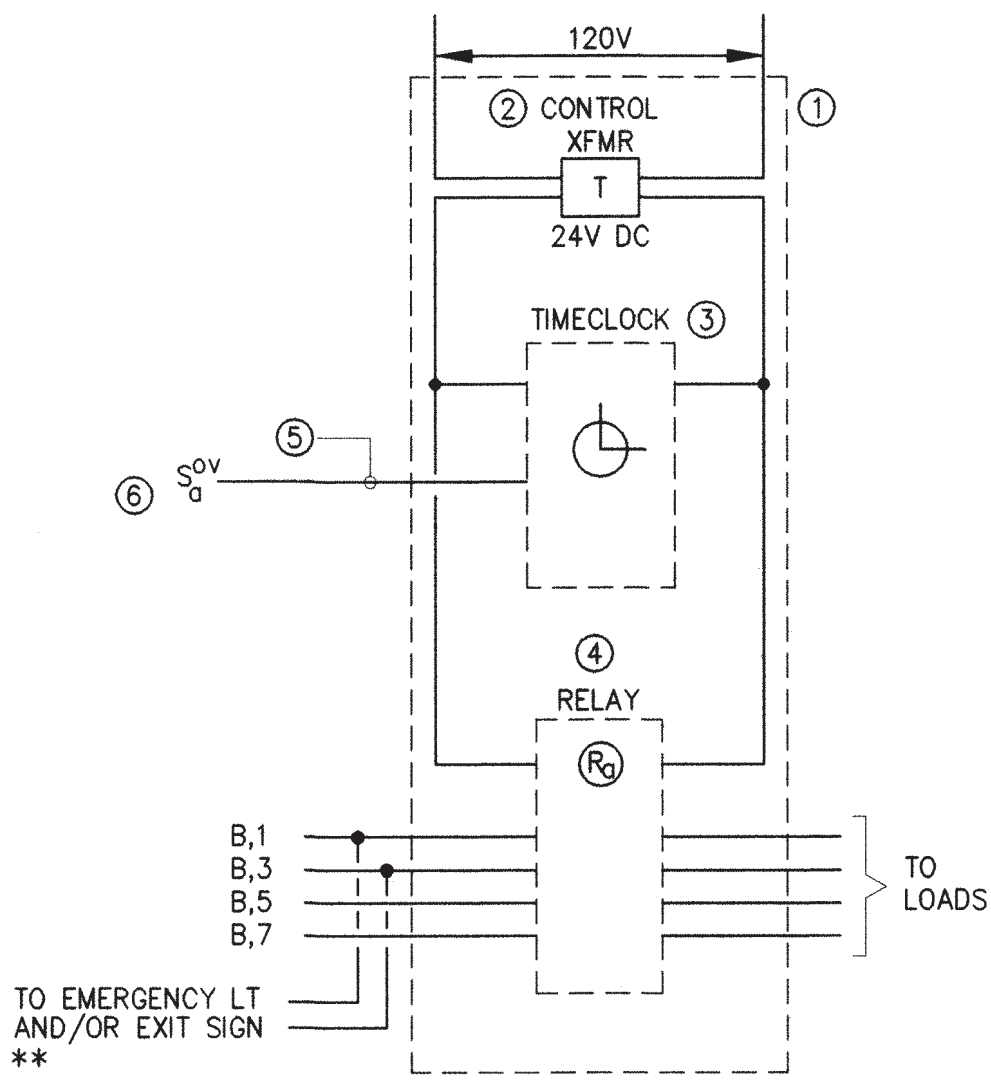

BLDG LIGHT SHUT-OFF &
OVERRIDE CONTROL DIAGRAM

NOTES

- 1 LIGHTING CONTROL PANEL WITH CONTROL XFMR, TIMECLOCK AND RELAYS. CERTIFIED BY 2015 IECC. INSTALL ADJACENT TO BRANCH CIRCUIT PANELBOARD. COOPER SERIES LK SERIES OR EQUAL
 - 2 CONTROL TRANSFORMER, 120V AC TO 24V DC, SIZE, AND PRIMARY AND SECONDARY PROTECTION AS REQUIRED.
 - 3 365 DAY PROGRAMMABLE ELECTRONIC TIME CLOCK WITH 10 HR BATTERY BACKUP
 - 4 OUTPUT RELAY WITH 24V DC COIL, POLE AS REQUIRED
 - 5 3#18 PLENUM RATED LOW VOLTAGE WIRING
 - 6 OVERRIDE SWITCH FOR EACH RELAY OUTPUT, MECHANICAL OR TOGGLE SWITCH (MOMENTARY CONTACT OR MAINTAINED CONTACT) LABEL "OVERRIDE SW" SEE LIGHTING PLAN FOR LOCATION. 0-2HR MAXIMUM.
- * FOR EMERGENCY LIGHTS WITH BATTERY BACKUP OR NIGHTLIGHTS. PROVIDE BYPASS WIRING AS REQUIRED

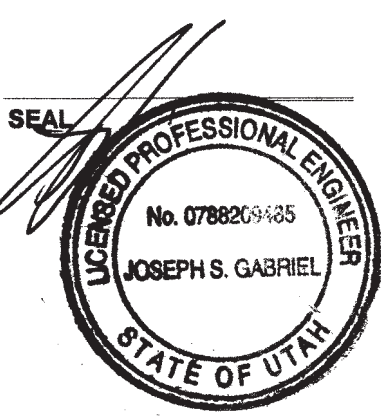

TITLE

Korean BBQ of Utah
7157 S. State Street
Midvale, Utah, 84047

REVISIONS

NO.	ISSUE	DATE


PROJECT DATA

PROJECT NUMBER:	190307
DATE:	03/16/19
DRAWN BY:	CB
CHECKED BY:	PC
APPROVED BY:	

SCALE

SHEET NAME

SHEET NUMBER

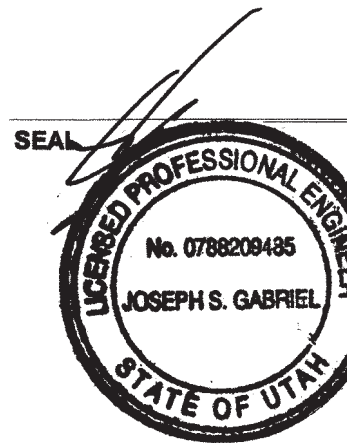

TITLE

Korean BBQ of Utah
7157 S. State Street
Midvale, Utah, 84047


REVISIONS		
NO.	ISSUE	DATE

PROJECT DATA	
PROJECT NUMBER:	180397
DATE:	03/16/18
DRAWN BY:	CS
CHECKED BY:	PC
APPROVED BY:	

SCALE

SHEET NAME

SHEET NUMBER

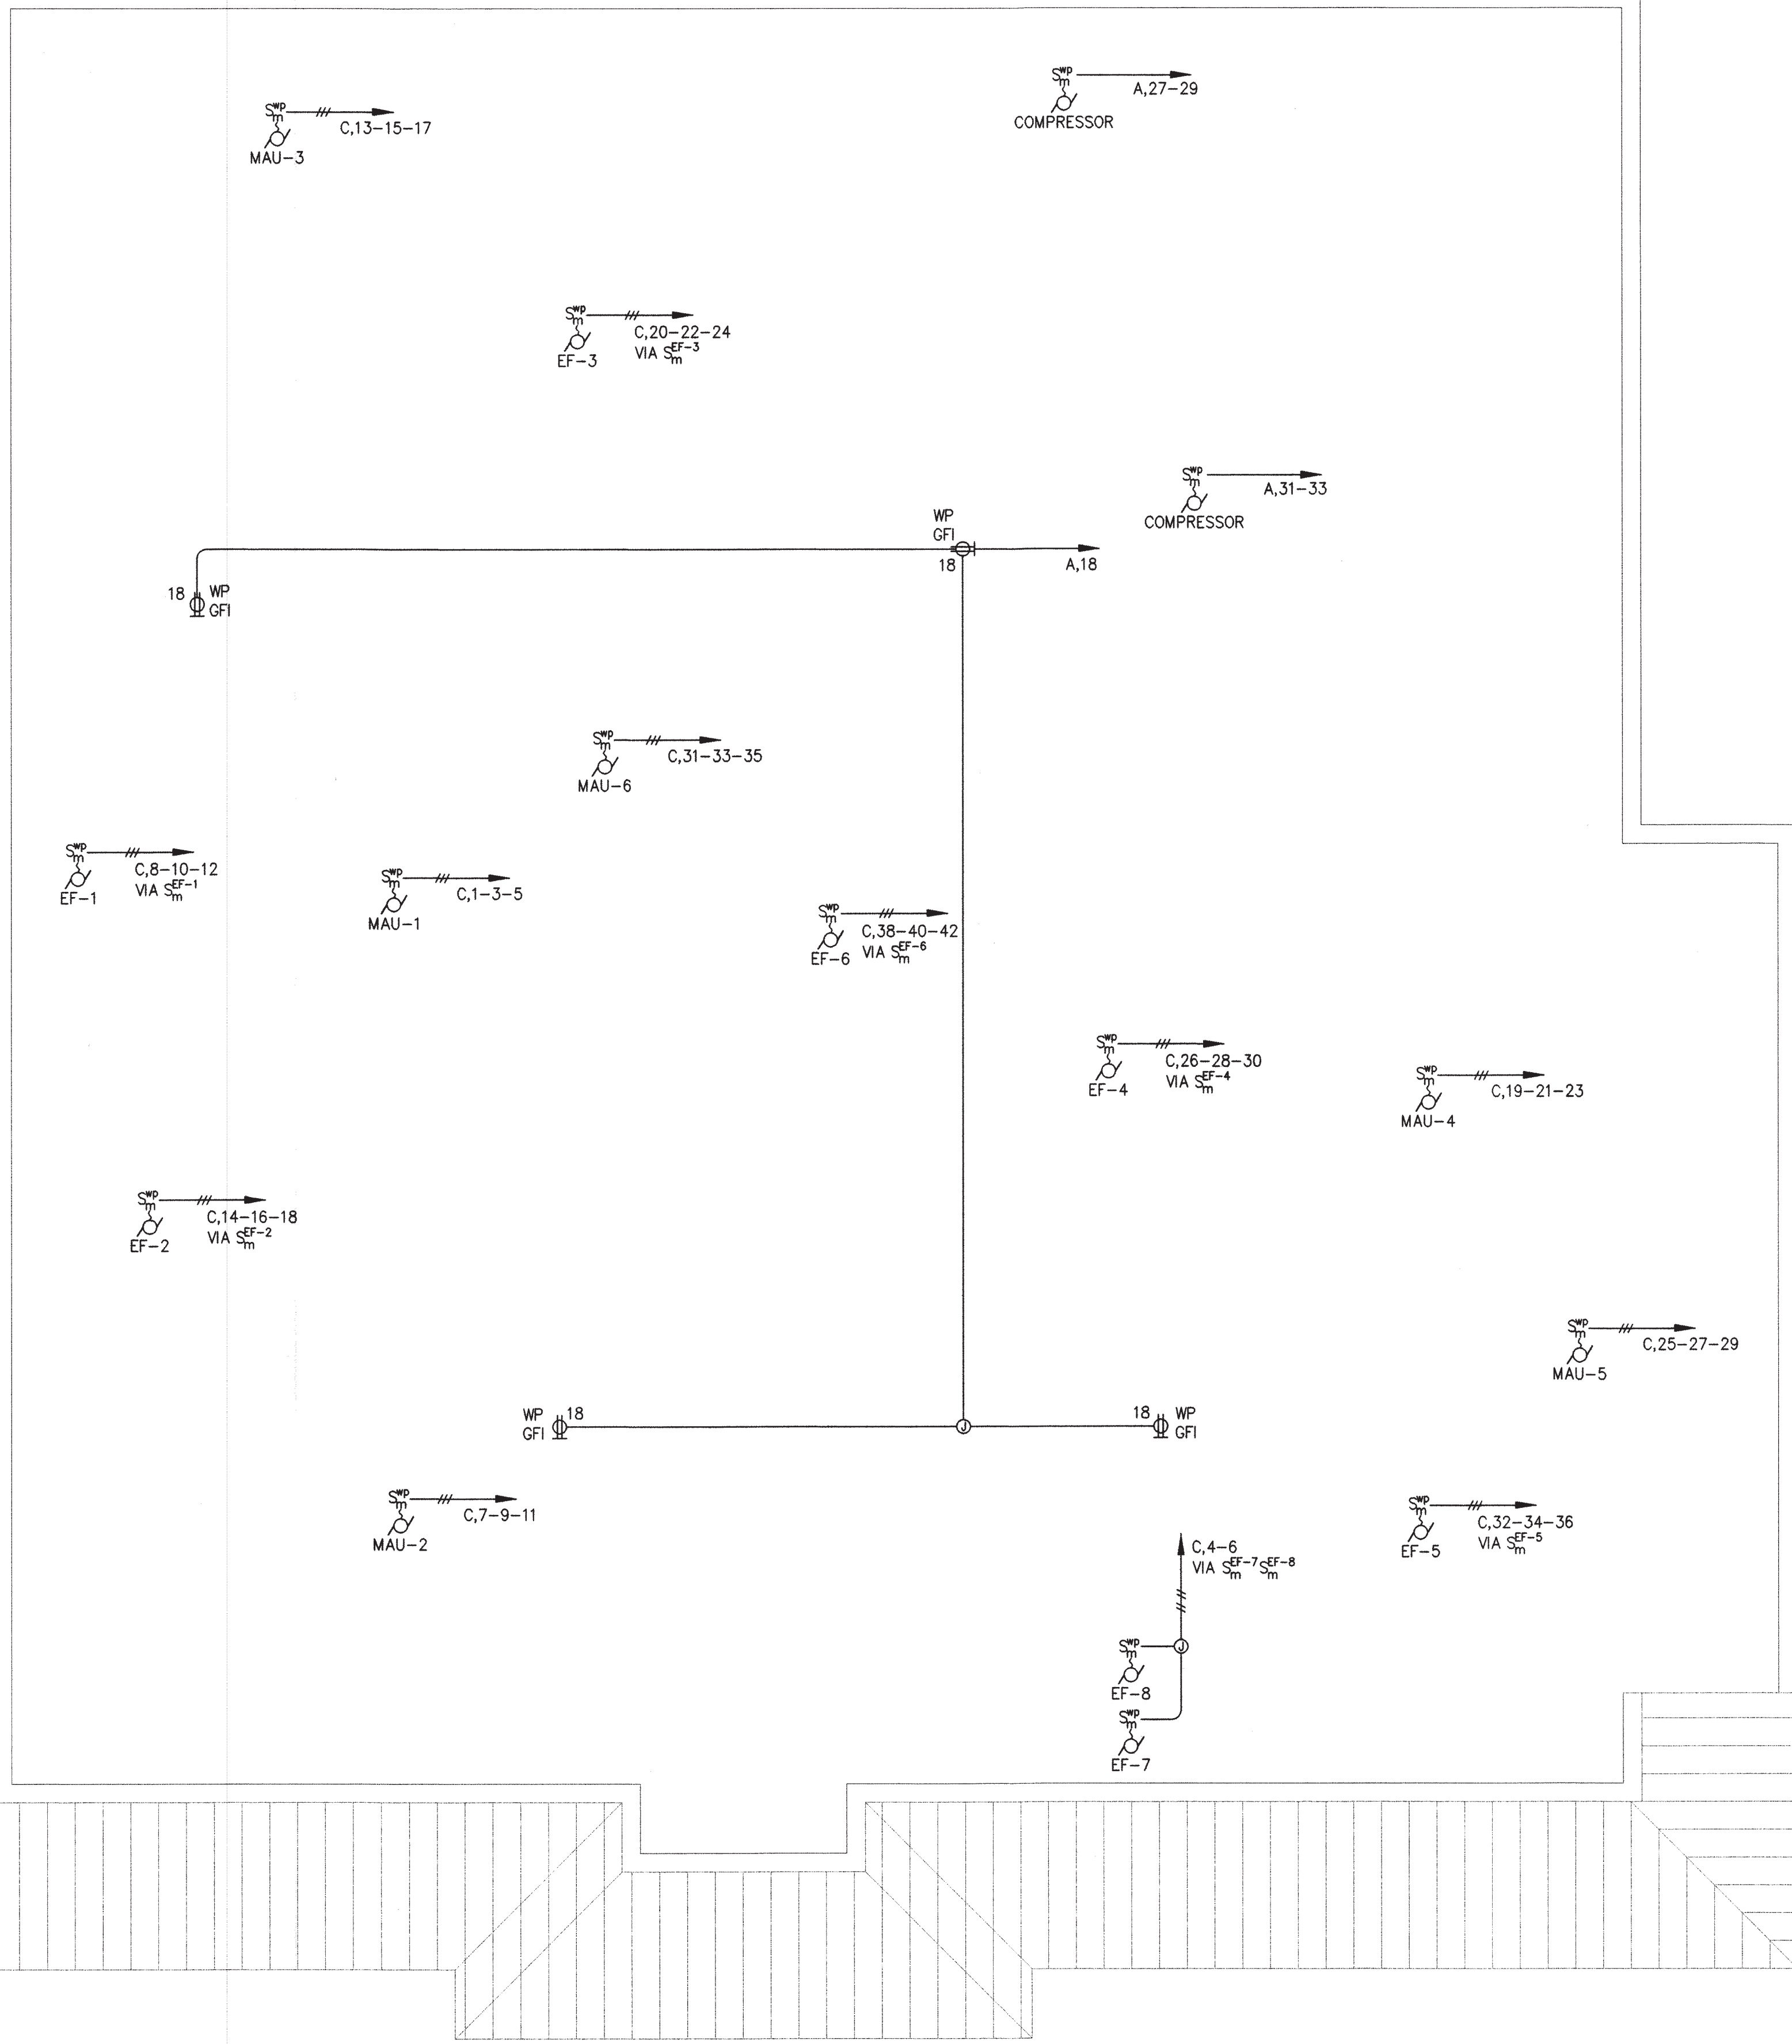

ROOF PLAN
SCALE: 1/4" = 1'-0"



COMcheck Software Version 4.0.8.1

Interior Lighting Compliance Certificate

Project Information

Energy Code: 2015 IECC
Project Title: KOREAN BBQ OF UTAH
Project Type: Alteration

Construction Site: 7157 S. STATE STREET
MIDVALE, UT 84047
Owner/Agent: MICHAEL J LEE
TWC ENTERPRISE
Designer/Contractor:

Allowed Interior Lighting Power

A Area Category	B Floor Area (ft2)	C Allowed Watts / ft2	D Allowed Watts (B X C)
1-RESTAURANT (Dining-Family)	4700	0.95	4465
Total Allowed Watts =			4465

Proposed Interior Lighting Power

A Fixture ID : Description / Lamp / Wattage Per Lamp / Ballast	B Lamps/ Fixture	C # of Fixtures	D Fixture Watt.	E (C X D)
RESTAURANT (Dining-Family 4700 sq.ft.)				
LED 1: A: Other:	1	15	49	735
LED 2: L1: Other:	1	39	21	819
LED 3: L2: Other:	1	86	10	817
LED 4: L3: Other:	1	8	10	76
LED 5: L5: Other:	1	21	16	326
LED 6: L6: Other:	1	1	15	15
LED 7: L7: Other:	1	4	12	48
Total Proposed Watts =			2836	

Interior Lighting PASSES

Interior Lighting Compliance Statement

Compliance Statement: The proposed interior lighting alteration project represented in this document is consistent with the building plans, specifications, and other calculations submitted with this permit application. The proposed interior lighting systems have been designed to meet the 2015 IECC requirements in COMcheck Version 4.0.8.1 and to comply with any applicable mandatory requirements listed in the Inspection Checklist.

Josep Gabriel PE
Name - Title Signature Date 6/13/18

Project Title: KOREAN BBQ OF UTAH Report date: 04/06/18
Data filename: \\Comp2\\pc\\PROJECT\\RESTAURANT\\KOREAN BBQ OF UTAH\\KOREAN BBQ OF UTAH T24.cck Page 1 of 5



COMcheck Software Version 4.0.8.1

Inspection Checklist

Energy Code: 2015 IECC

Requirements: 0.0% were addressed directly in the COMcheck software

Text in the "Comments/Assumptions" column is provided by the user in the COMcheck Requirements screen. For each requirement, the user certifies that a code requirement will be met and how that is documented, or that an exception is being claimed. Where compliance is itemized in a separate table, a reference to that table is provided.

Section # & Req. ID	Plan Review	Complies?	Comments/Assumptions
C103.2 [PR4] ¹	Plans, specifications, and/or calculations provide all information with which compliance can be determined for the interior lighting and electrical systems and equipment and document where exceptions to the standard are claimed. Information provided should include interior lighting power calculations, wattage of bulbs and ballasts, transformers and control devices.	<input type="checkbox"/> Complies <input type="checkbox"/> Does Not <input type="checkbox"/> Not Observable <input type="checkbox"/> Not Applicable	

Additional Comments/Assumptions:

1 High Impact (Tier 1) 2 Medium Impact (Tier 2) 3 Low Impact (Tier 3)

Project Title: KOREAN BBQ OF UTAH Report date: 04/06/18
Data filename: \\Comp2\\pc\\PROJECT\\RESTAURANT\\KOREAN BBQ OF UTAH\\KOREAN BBQ OF UTAH T24.cck Page 2 of 5

Section # & Req. ID	Rough-In Electrical Inspection	Complies?	Comments/Assumptions
C405.2.1 [EL15] ¹	Lighting controls installed to uniformly reduce the lighting load by at least 50%.	<input type="checkbox"/> Complies <input type="checkbox"/> Does Not <input type="checkbox"/> Not Observable <input type="checkbox"/> Not Applicable	
C405.2.1 [EL18] ¹	Occupancy sensors installed in required spaces.	<input type="checkbox"/> Complies <input type="checkbox"/> Does Not <input type="checkbox"/> Not Observable <input type="checkbox"/> Not Applicable	
C405.2.1, C405.2.2 [EL23] ¹	Independent lighting controls installed per approved lighting plans and all manual controls readily accessible and visible to occupants.	<input type="checkbox"/> Complies <input type="checkbox"/> Does Not <input type="checkbox"/> Not Observable <input type="checkbox"/> Not Applicable	
C405.2.2.1 [EL22] ¹	Automatic controls to shut off all building lighting installed in all buildings.	<input type="checkbox"/> Complies <input type="checkbox"/> Does Not <input type="checkbox"/> Not Observable <input type="checkbox"/> Not Applicable	
C405.2.3 [EL16] ¹	Daylight zones provided with individual controls that control the lights independent of general area lighting.	<input type="checkbox"/> Complies <input type="checkbox"/> Does Not <input type="checkbox"/> Not Observable <input type="checkbox"/> Not Applicable	
C405.2.3.1, C405.2.3.2 [EL20] ¹	Primary sidelighted areas are equipped with required lighting controls.	<input type="checkbox"/> Complies <input type="checkbox"/> Does Not <input type="checkbox"/> Not Observable <input type="checkbox"/> Not Applicable	
C405.2.3.1, C405.2.3.3 [EL21] ¹	Enclosed spaces with daylight area under skylights and rooftop monitors are equipped with required lighting controls.	<input type="checkbox"/> Complies <input type="checkbox"/> Does Not <input type="checkbox"/> Not Observable <input type="checkbox"/> Not Applicable	
C405.2.4 [EL4] ¹	Separate lighting control devices for specific uses installed per approved lighting plans.	<input type="checkbox"/> Complies <input type="checkbox"/> Does Not <input type="checkbox"/> Not Observable <input type="checkbox"/> Not Applicable	
C405.2.4 [EL8] ¹	Additional interior lighting power allowed for special functions per the approved lighting plans and is automatically controlled and separated from general lighting.	<input type="checkbox"/> Complies <input type="checkbox"/> Does Not <input type="checkbox"/> Not Observable <input type="checkbox"/> Not Applicable	
C405.3 [EL6] ¹	Exit signs do not exceed 5 watts per face.	<input type="checkbox"/> Complies <input type="checkbox"/> Does Not <input type="checkbox"/> Not Observable <input type="checkbox"/> Not Applicable	

Additional Comments/Assumptions:

1 High Impact (Tier 1) 2 Medium Impact (Tier 2) 3 Low Impact (Tier 3)

Project Title: KOREAN BBQ OF UTAH Report date: 04/06/18
Data filename: \\Comp2\\pc\\PROJECT\\RESTAURANT\\KOREAN BBQ OF UTAH\\KOREAN BBQ OF UTAH T24.cck Page 3 of 5

Section # & Req. ID	Final Inspection	Complies?	Comments/Assumptions
C303.3, C408.2.5.2 [F117] ¹	Furnished O&M instructions for systems and equipment to the building owner or designated representative.	<input type="checkbox"/> Complies <input type="checkbox"/> Does Not <input type="checkbox"/> Not Observable <input type="checkbox"/> Not Applicable	
C405.4.1 [F118] ¹	Interior installed lamp and fixture lighting power is consistent with what is shown on the approved lighting plans, demonstrating proposed watts are less than or equal to allowed watts.	<input type="checkbox"/> Complies <input type="checkbox"/> Does Not <input type="checkbox"/> Not Observable <input type="checkbox"/> Not Applicable	See the Interior Lighting fixture schedule for values.
C408.2.5.1 [F116] ¹	Furnished as-built drawings for electric power systems within 90 days of system acceptance.	<input type="checkbox"/> Complies <input type="checkbox"/> Does Not <input type="checkbox"/> Not Observable <input type="checkbox"/> Not Applicable	
C408.3 [F133] ¹	Lighting systems have been tested to ensure proper calibration, adjustment, programming, and operation.	<input type="checkbox"/> Complies <input type="checkbox"/> Does Not <input type="checkbox"/> Not Observable <input type="checkbox"/> Not Applicable	

Additional Comments/Assumptions:

1 High Impact (Tier 1) 2 Medium Impact (Tier 2) 3 Low Impact (Tier 3)

Project Title: KOREAN BBQ OF UTAH Report date: 04/06/18
Data filename: \\Comp2\\pc\\PROJECT\\RESTAURANT\\KOREAN BBQ OF UTAH\\KOREAN BBQ OF UTAH T24.cck Page 4 of 5


Project Title: KOREAN BBQ OF UTAH Report date: 04/06/18
Data filename: \\Comp2\\pc\\PROJECT\\RESTAURANT\\KOREAN BBQ OF UTAH\\KOREAN BBQ OF UTAH T24.cck Page 5 of 5



DESIGN PARTNERS

3470 WILSHIRE BLVD. SUITE 930
LOS ANGELES, CA 90010

- ARCHITECTURE BRANDING
- INTERIOR BRANDING
- PLANNING
- LAND-USE CONSULTATION

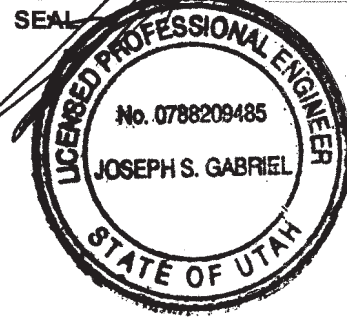

TITLE

Korean BBQ of Utah
7157 S. State Street
Midvale, Utah, 84047

REVISIONS

NO. ISSUE DATE

PROJECT DATA

PROJECT NUMBER : 180307
DATE : 03/16/18
DRAWN BY : CB
CHECKED BY : PC
APPROVED BY :

SCALE

SHEET NAME

SHEET NUMBER