


United States Department of Agriculture Forest Service

R04, INTERMOUNTAIN REGION ASHLEY NATIONAL FOREST DAGGETT COUNTY, UTAH

FLAMING GORGE RANGER DISTRICT ADDITION

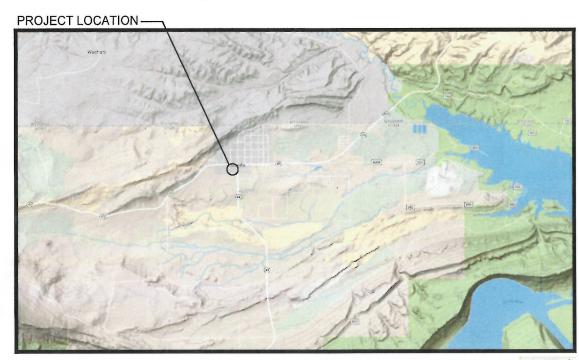

Map data 62017 600

FLAMING GORGE RANGER DISTRICT ADDITION SITE 25 WEST HWY 43


VICINITY MAP

PROJECT LOCATION:

The Project Site is located on USDA Forest Service property at the address of 25 West Hwy 43, Manila, UT 84046

TRAVEL DIRECTIONS FROM VERNAL:

Head North on S Vernal Ave toward Main St. (3.4 mi) Continue onto US-191 N (31.4 mi) Continue straight onto UT-44 N (27.9 mi)

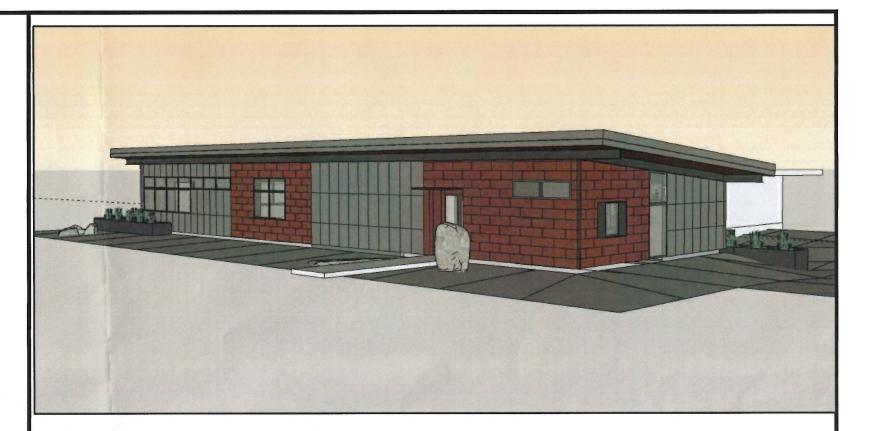

PROJECT DESCRIPTION

a. This project consists of constructing an office addition of approximately 3225 square feet to the Flaming Gorge Ranger District Office building. The existing facility is located in Manila, Daggett County, Utah on property owned by the Ashley National Forest. The project includes some site demolition and disposal, minor building demolition, preparation for new construction and the construction of an addition on the west end of the existing District Office. The work includes the construction of a new addition that will be connected by a breezeway and planter. The additional office space will include a new conference room with break area, open office areas, single offices, hallways, bathrooms, mechanical room, and telecom space. The project includes the installation of HVAC systems, plumbing, and the construction of a new concrete entries. The project will include new landscaping, irrigation, and exterior site elements as shown in the drawings and specifications. The project shall meet all ABA accessibility guidelines and standards.

POREST ENGINEER

DISTRICT PANGER

DATE

DISTRICT PANGER

DATE

DATE

POREST SUPERVISOR

DATE

APPROVED:

DIRECTOR OF ENGINEERING

DATE

SHEET 01

OF 119

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United States Department of Agriculture Forest Service

REGION 4
INTERMOUNTAIN REGION

STAMPS, LOGOS, AND SEALS

| , | <i>a a i</i> | |
|-----------|------------------|------|
| 2/2 | Regina Freel | |
| 4 | 11/29/18 | |
| <u>3</u> | | |
| <u>^2</u> | | |
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| NO. | REVISION / ISSUE | DATE |

PROJECT NAME

FLAMING GORGE RANGER DISTRICT OFFICE ADDITION

ASHLEY
NATIONAL FOREST

FLAMING GORGE RANGER DISTRICT

DRAWING TITLE

DRAWING SHEET INDEX

| DATE 11/16/2018 | ARCHIV | E NO. | |
|------------------------|-------------------|---------|---------------|
| DESIGNER C. LEWI | DESIGNER C. LEWIS | | HEET NO. |
| DRAWN SMHW | 1 | G | i 2 |
| D. JEPPS | EN | | |
| PROJECT NO. 644 | | SHEET 2 | OF 119 |

| | SCHEDULE FLAMING GORGE RANGER 11/16 | | | DDITION | | |
|----------------|--|-------------------|------|--|----------------|-------|
| ITEM NUMBER | DESCRIPTION | METHOD OF MEAS | UNIT | QUANTITY | PRICE | TOTAL |
| | Base | e Bid | | | | |
| 011900 | Mobilization and Bonding | LSQ | LS | 1 | | |
| 000501.1.3 | District Office Addition Broken into Schedule of Values | | | | | |
| | Divison 01: General Conditions | LSQ | LS | 1 | | |
| | Division 02: Existing Conditions | LSQ | LS | 1 | | |
| | Division 03: Concrete | LSQ | LS | 1 | | |
| | Division 05: Metals | LSQ | LS | 1 | | |
| | Division 06: Wood, Plastics and Composites | LSQ | LS | 1 | | |
| | Division 07: Thermal and Moisture Protection | LSQ | LS | 1 | | |
| | Division 08: Openings | LSQ | LS | 1 | | |
| | Division 09: Finishes | LSQ | LS | 1 | | |
| | Division 10: Specialties | LSQ | LS | 1 | | |
| | Division 11 and 12: Equipment and Furnishings | | LS | | | |
| | | LSQ | | 1 | | |
| | Division 22: Plumbing Division 23: Heating, Ventilation and Air | LSQ | LS | 1 | | |
| | Conditioning Division 26, 27, 28: Electrical, Communications and | LSQ | LS | 1 | | |
| | Security Division 31 and 32: Earthwork and Exterior | LSQ | LS | 1 | | |
| | Improvements | LSQ | LS | 1 | | |
| 000501-2 | Steel planter boxes adjacent to bldg | LSQ | LS | 1 | | |
| 260500-1 | Electrical Service and Feeder to Panel D Electrical parking lot lighting and damaged com | LSQ | LS | 1 | | |
| 260500-2 | cable | LSQ | LS | 1 | | |
| | | | | | Total Base - | |
| | Bid Op | otion-A | | | | |
| 129300-1 | Site furnishings : picnic table | AQ | EA | 2 | | |
| 129300-2 | Site furnishings : bike rack | AQ | EA | 1 | | |
| 328000 | Landscape irrigation system Exterior plants, planting media, installation of | LSQ | LS | 1 | | |
| 329310 | Government furnished boulders | LSQ | LS | 1 | | |
| 329400 | Landscape stone, weed barrier, steel edging | LSQ | LS | 1 | | |
| | | | | Ī | Total Option - | |
| | Bid O _I | otion-B | | | T | |
| 321200 | (Civil work) asphalt parking Lot | LSQ | LS | 1 | | |
| 033000 | Concrete sidewalk, hardscape, curb, gutter | LSQ | LS | 1 | | |
| | | | | 1 | Fotal Option - | |



REGION 4
INTERMOUNTAIN REGION

STAMPS, LOGOS, AND SEALS

S/s Regina Freel

11/29/18

1
NO. REVISION/ISSUE DATE

PROJECT NAME

FLAMING GORGE RANGER DISTRICT OFFICE ADDITION

ASHLEY
NATIONAL FOREST

FLAMING GORGE RANGER DISTRICT

DRAWING TITLE

SCHEDULE OF ITEMS

| 11/16/2018 | ARCHIV | E NO. | |
|-------------------|--------|-----------|---------------|
| DESIGNER C. LEWIS | | DRAWING S | |
| DRAWN SMHW | 1 | G | 3 |
| CHECKED D. JEPPS | EN | | |
| PROJECT NO. 644 | | SHEET 3 | OF 119 |

GENERAL NOTES:

- AN EXTENSIVE EFFORT HAS BEEN MADE TO LOCATE ALL POSSIBLE EXISTING UTILITY LINES FROM RECORDS AND EVIDENCE IN THE FIELD, HOWEVER, THE COMPLETENESS OR ACCURACY OF THE LOCATIONS SHOWN CANNOT BE GUARANTEED. THE CONTRACTOR IS RESPONSIBLE FOR ESTABLISHING THE LOCATION OF ALL EXISTING UTILITIES. ANY LOCATION STAKED OR SHOWN IS APPROXIMATE. CALL 811 TO HAVE UTILITIES MARKED BEFORE BEGINNING CONSTRUCTION. IF CONFLICTS ARE FOUND, NOTIFY THE CONTRACTING OFFICER
- INFRASTRUCTURE SUCH AS: ELECTRICAL, SEWER, WATER AND PHONE LINES EXIST. THE CONTRACTOR SHALL COORDINATE WITH THE CONTRACTING OFFICER'S REPRESENTATIVE TO LOCATE, PRESERVE, AND INTERRUPT ANY OF THE CURRENT
- SEE "E" SHEETS FOR ELECTRICAL DESIGN.
- ALL OBLITERATED ROAD BASE ROAD MATERIALS SHALL BE REUSED AS ROAD BASE MATERIAL OR AS OTHER FILL MATERIAL IN APPROPRIATE AREAS. THE CONTRACTOR SHALL REMOVE AND STOCKPILE ROAD BASE FOR REUSE, AND USE AS CRUSHED AGGREGATE BASE COURSE IN THE CONSTRUCTION OF THE NEW PARKING AREA.
- ALL CLEARING AND GRUBBING SHALL CONFORM TO SECTION 311000 IN THE SPECIFICATIONS. ALL NON-SALVAGEABLE MATERIAL SHALL BE DISPOSED OF AT AN APPROVED LANDFILL.
- CONTRACTOR SHALL MINIMIZE OUTAGES AND ACCESS DISTURBANCE TO THE EXISTING FACILITIES. ALL DISRUPTIONS TO THE EXISTING FACILITIES MUST BE COORDINATED THROUGH THE C.O.R.
- CONTRACTOR SHALL COORDINATE WITH THE CITY AND UDOT AND OBTAIN NECESSARY PERMITS FOR WORK PERFORMED WITHIN HIGHWAY 43 AND HIGHWAY 44 STREET RIGHT
- STAKING WILL BE COMPLETED BY THE CONTRACTOR AND APPROVED BY THE CONTRACTING OFFICER'S REPRESENTATIVE.
- THE CONTRACTOR SHALL FINISH GRADE THE SITE TO DRAIN AS SHOWN ON THE DRAWINGS. THE PROPOSED CONTOURS ARE GENERALIZATIONS AND MAY BE ADJUSTED BASED ON ACTUAL FILL MATERIAL AVAILABLE AND AS APPROVED BY THE CONTRACTING
- 10. CONCRETE SIDEWALKS AND SLABS NEXT TO BUILDINGS SHALL BE SLOPED TO DRAIN AWAY FROM THE BUILDING AT A MINIMUM OF 2 PERCENT.
- 11. ALL CUT AND FILL SLOPES SHALL BE SLOPED AT 4:1 UNLESS OTHERWISE INDICATED ON THE PLANS
- ALL CONSTRUCTION PERFORMED WITHIN THE UDOT'S RIGHT-OF-WAY SHALL FOLLOW UDOT STANDARDS DRAWINGS AND SPECIFICATIONS.
- ALL WATERLINE SHALL BE SLOPED A MINIMUM 2% TO DRAIN.
- 14. BURY WATERLINE A MINIMUM OF 48 INCHES TO TOP OF PIPE. ADDITIONAL DEPTH MAY BE REQUIRED TO MAINTAIN A MINIMUM SLOPE OF 2%.
- 15. THE MINIMUM ALLOWABLE BENDING RADIUS FOR HDPE PIPE IS 30 TIMES THE NOMINAL PIPE DIAMETER.

| NOM. PIPE DIA. | MIN. BENDING RADIUS |
|----------------|---------------------|
| 1" | 2'-6" |
| 2" | 5'-0" |
| 3" | 7'-6" |
| 4" | 10'-0" |
| 6" | 15'-0" |

- 16. INSTALL THE WATER SYSTEM ACCORDING TO APPLICABLE FEDERAL, STATE AND LOCAL REGULATIONS FOR PUBLIC DRINKING WATER SYSTEMS.
- CLEARING LIMITS SHALL BE 5 FEET ON BOTH SIDES OF THE UTILITY TRENCH. THE CONTRACTOR SHALL USE CAUTION AND AVOID DAMAGE TO TREES AND VEGETATION. THE CONTRACTOR SHALL CONFINE ALL OPERATIONS AND ACTIVITIES TO WITHIN THE CLEARING LIMITS.
- CONNECTIONS BETWEEN NEW AND EXISTING WATERLINES SHALL BE INSTALLED IN MANNER RECOMMENDED BY THE PIPE MANUFACTURER AND APPROVED BY THE CONTRACTING OFFICER. COMPRESSION—TYPE FITTINGS ARE NOT ALLOWED
- WHERE UTILITY LINES CROSS ASPHALT ROADS, SAW CUT AND REPAIR WITH COLD ASPHALT MIX. SEE TRENCHING DETAILS.
- INSTALL THRUST BLOCKS FOR ALL 4" AND LARGER WATERLINES AT CHANGES IN DIRECTION GREATER THAN 45 DEGREES AND AT ALL TEES.
- 21. SEE SHEET C4 FOR WATER AND WASTEWATER.
- 22. WHERE NEW WATERLINES INTERSECT SEWERLINES, THE NEW WATERLINES SHALL BE INSTALLED ACCORDING TO APPLICABLE FEDERAL, STATE AND LOCAL REGULATIONS, INCLUDING: UTAH DIVISION OF DRINKING WATER, RULES GOVERNING PUBLIC DRINKING WATER SYSTEMS, R309-550, SEE PIPE SEPARATION DETAILS

LEGEND:

---- W ---- EXISTING WATERLINE NEW SEWERLINE - - S - FXISTING SEWERLINE NEW ELECTRICAL LINE — — E — EXISTING POWER TELECOMMUNICATIONS LINE — T —— EXISTING TELECOMMUNICATIONS LINE — X — NEW FENCE — — X — EXISTING FENCE ----> ---- SWALE DIRECTION NEW STORM DRAIN NEW GASLINE

— W — NEW WATERLINE

(V) **CURB VALVE AND BOX - SIZE VARIES** (\$) EXISTING SANITARY SEWER MANHOLE S

0 CLEANOUT \bigcirc POWER POLE

NEW SANITARY SEWER MANHOLE

9310 MAJOR CONTOUR AND ELEVATION (FEET)

LANDSCAPE AREA

ACCESSIBLE PARKING STALL

NEW ASPHALT

SIGN

TELEPHONE PEDESTAL EXISTING SURVEY CONTROL POINT

ABBREVIATION LEGEND:

CP SURVEY CONTROL POINT TBC TOP BACK OF CURB BW...... BACK OF WALK FG FINISHED GRADE BLDG.... BUILDING FF FINISHED FLOOR ...FLOWLINE .. POINT OF CURVE .. POINT OF TANGENT POC..... POINT ON CURVE GRD GROUND EO..... EDGE OF ROAD LPP..... LIGHT UTILITY POLE TPP..... TELEPHONE UTILITY POLE . SLOPE GB GRADE BREAK SD STORM DRAIN SANITARY SEWER SS .. W WATER MH..... MAN HOLE (##) EXISTING ELEVATION ÌNÝ INVERT CB CATCH BASIN FNC.... FENCE LPG.... LIQUEFIED PETROLEUM GAS HDPE ...HIGH DENSITY POLYETHYLENE MIN MINIMUM EP EDGE OF PAVEMENT CONC .. CONCRETE CL CENTER LINE

.. SIDEWALK



United States Department of Agriculture Forest Service

> (R04) INTERMOUNTAIN REGION

STAMPS, LOGOS, AND SEALS

| NO. | REVISION / ISSUE | DATE |
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| 4 | 11/29/18 | |
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FLAMING GORGE RANGER DISTRICT

ADDITION

PROJECT NAME


ASHLEY NATIONAL FOREST


FLAMING GORGE DISTRICT


DRAWING TITLE


GENERAL SITE NOTES AND LEGEND

| VE NO. |
|-------------------|
| DRAWING SHEET NO. |
| |
| C1 |
| |
| |
| SHEET 4 OF 119 |
| |

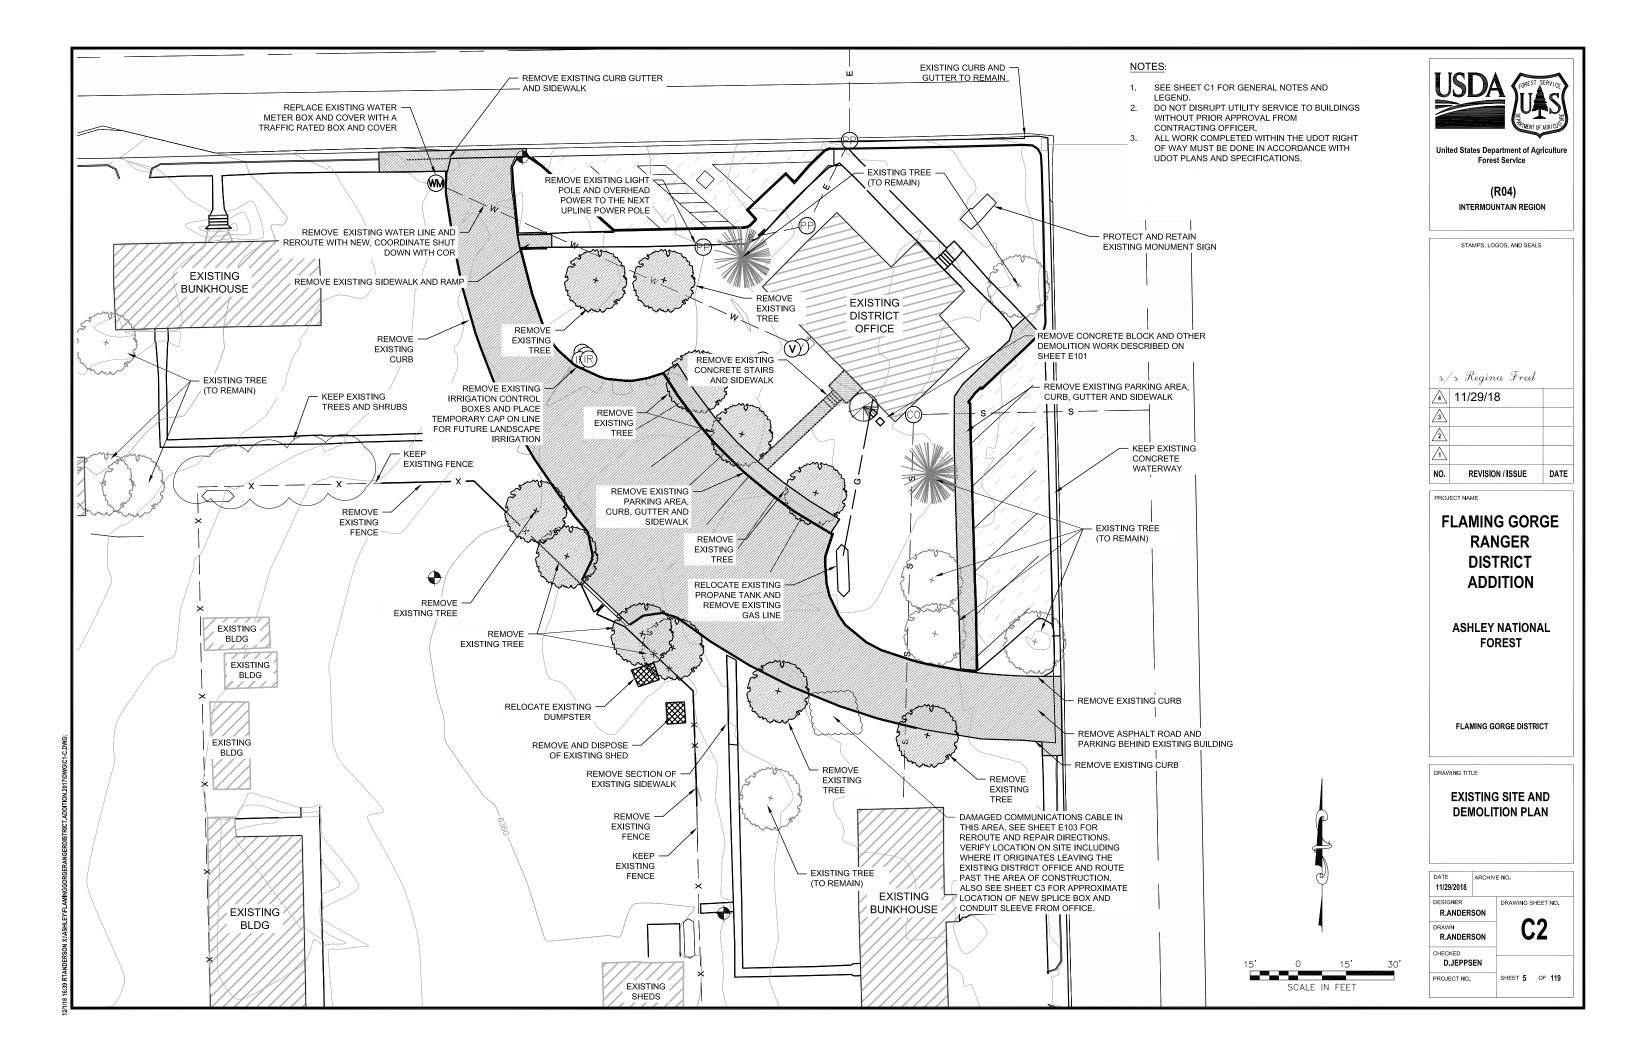

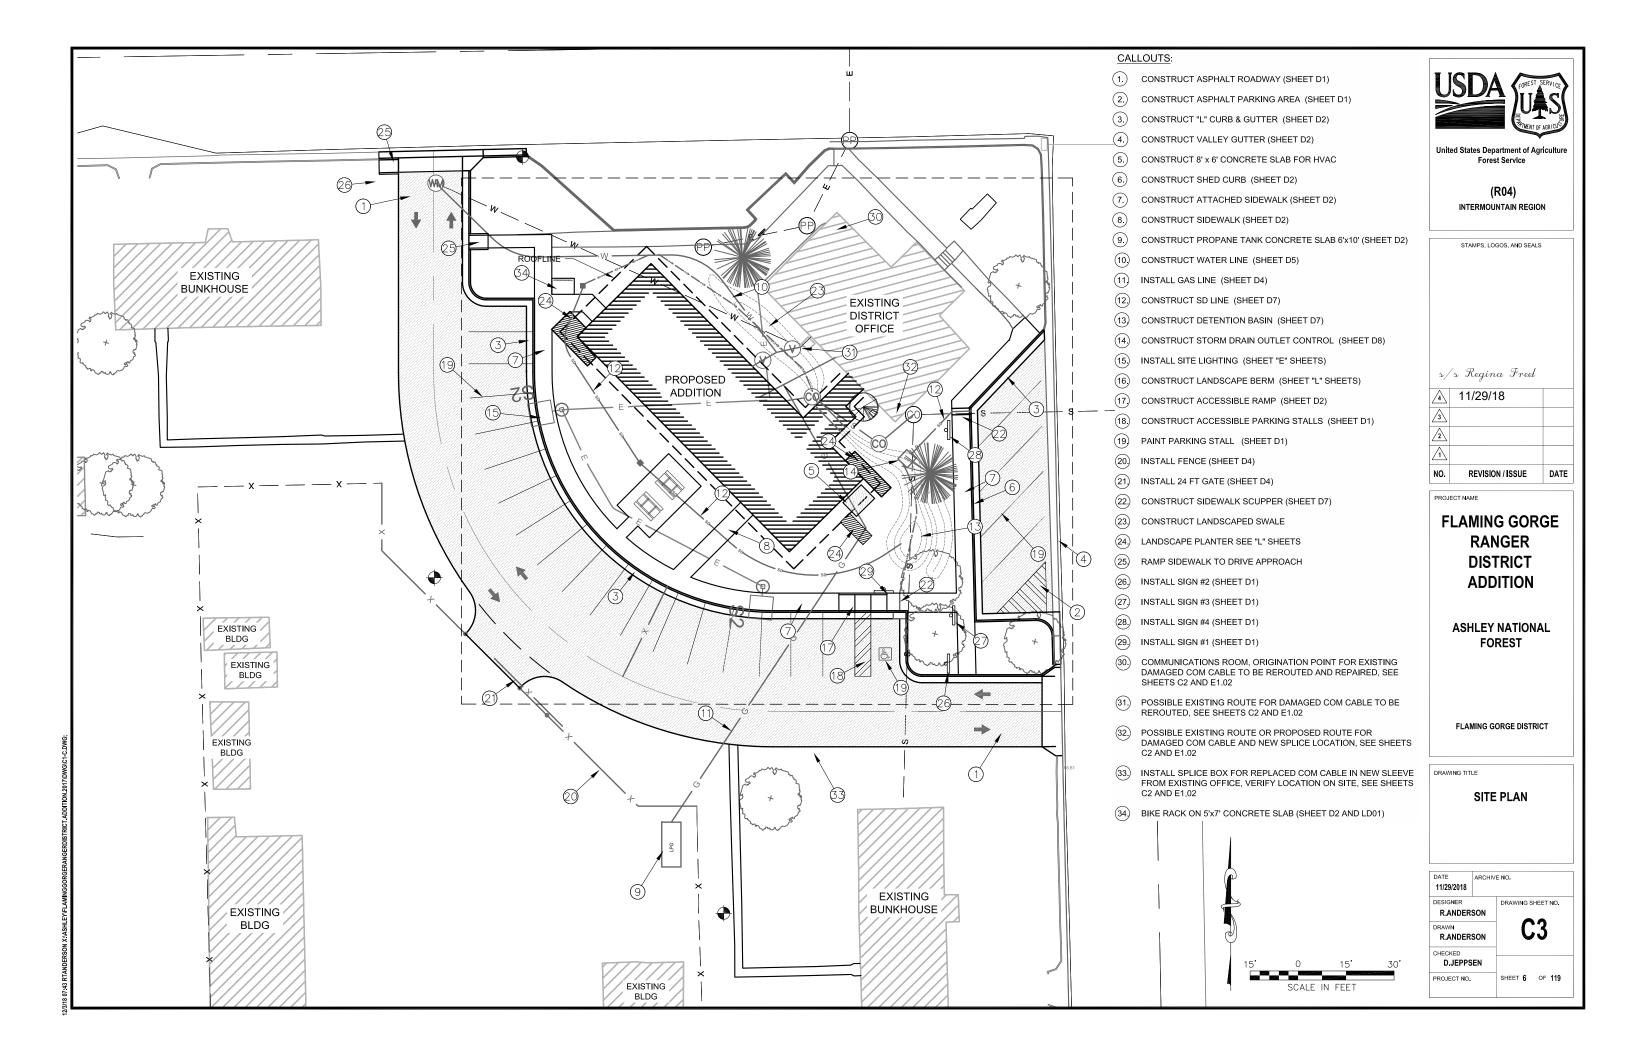

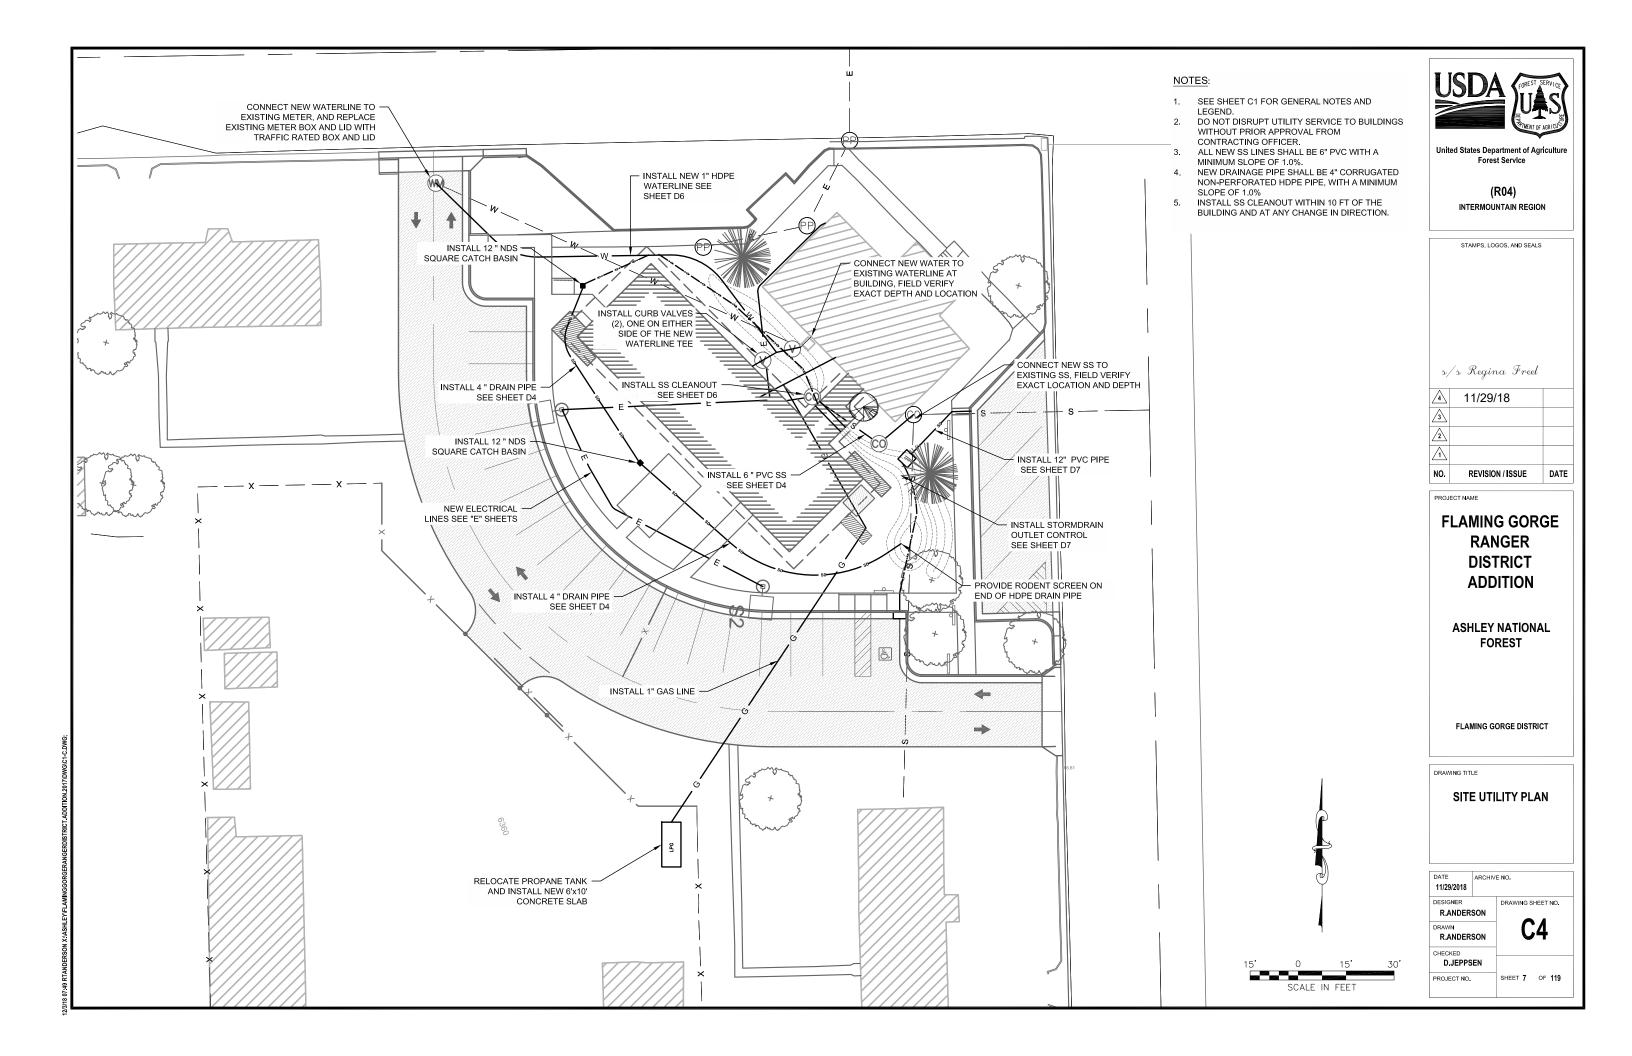

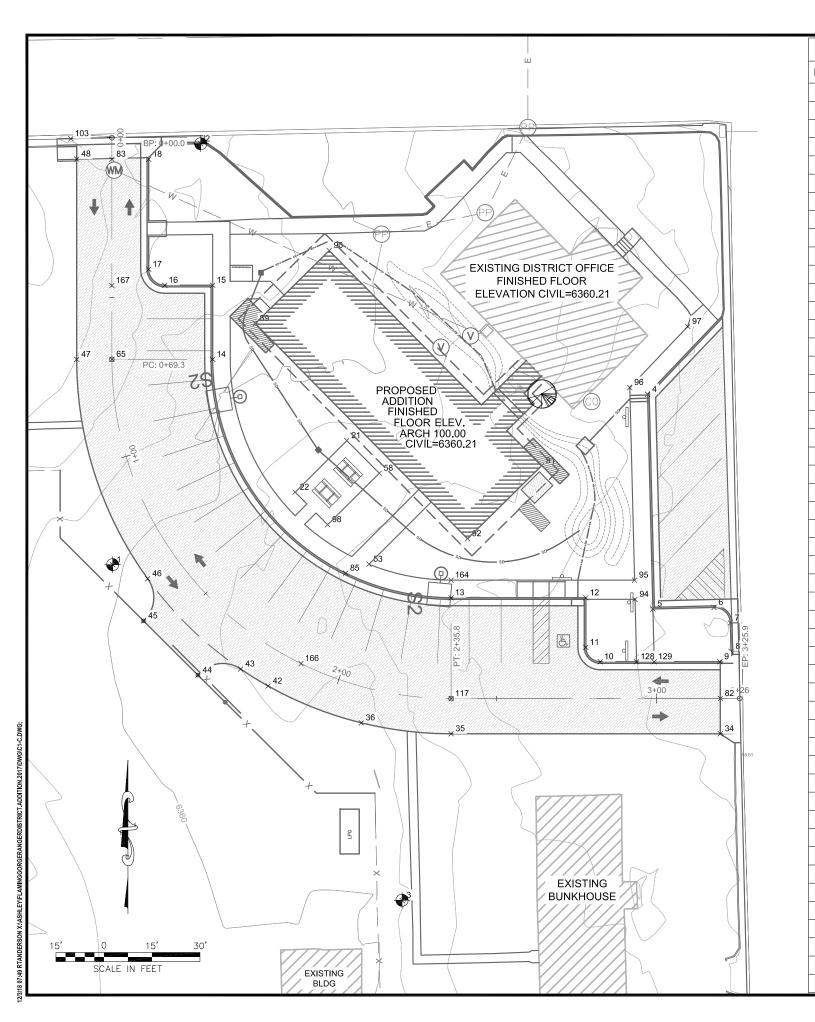

| Point Table | | | | | |
|-------------|-------------|------------|-----------|--------------|--|
| Point # | Northing | Easting | Elevation | Description | |
| 164 | 14889036.26 | 1992794.54 | 6358.22 | SW | |
| 129 | 14889010.76 | 1992858.00 | 6356.99 | SW | |
| 128 | 14889010.76 | 1992852.50 | 6357.10 | SW | |
| 117 | 14888999.26 | 1992794.54 | 6358.24 | CL | |
| 103 | 14889174.21 | 1992675.73 | 6362.86 | GUTTER EXIST | |
| 98 | 14889053.60 | 1992755.96 | 6359.83 | CONC | |
| 97 | 14889115.52 | 1992868.48 | 6355.73 | SW | |
| 96 | 14889096.46 | 1992850.38 | 6366.24 | sw | |
| 95 | 14889036.26 | 1992851.87 | 6356.92 | SW | |
| 94 | 14889030.26 | 1992852.02 | 6356.80 | SW | |
| 92 | 14889049.20 | 1992799.68 | 6356.92 | BLDG | |
| 91 | 14889072.00 | 1992822.78 | 6356.92 | BLDG | |
| 90 | 14889139.25 | 1992756.45 | 6356.92 | BLDG | |
| 89 | 14889116.45 | 1992733.34 | 6356.92 | BLDG | |
| 85 | 14889038.45 | 1992761.58 | 6359.51 | TBC | |
| 83 | 14889167.78 | 1992688.54 | 6362.50 | cl | |
| 82 | 14888999.26 | 1992878.66 | 6355.83 | cl | |
| 65 | 14889105.26 | 1992688.54 | 6361.25 | cl | |
| 58 | 14889069.66 | 1992772.10 | 6360.00 | CONC | |
| 53 | 14889041.22 | 1992768.86 | 6356.92 | SW | |
| 48 | 14889167.83 | 1992677.54 | 6362.72 | EP | |
| 47 | 14889105.26 | 1992677.54 | 6361.64 | EP | |
| 46 | 14889036.71 | 1992699.73 | 6360.24 | EP | |
| 45 | 14889023.52 | 1992698.43 | 6359.78 | EP | |
| 44 | 14889006.58 | 1992715.44 | 6359.38 | EP | |
| 43 | 14889008.49 | 1992713.44 | 6359.42 | EP EP | |
| 42 | 14889003.18 | 1992737.38 | 6359.28 | EP | |
| 36 | 14888991.68 | 1992766.46 | 6358.85 | EP | |
| 35 | 14888988.26 | 1992794.54 | 6358.66 | EP EP | |
| 34 | 14888988.26 | 1992794.54 | 6356.06 | EP EP | |
| 22 | 14889063.75 | 1992745.83 | 6359.62 | CONC | |
| | | | | | |
| 21 | 14889079.88 | 1992761.95 | 6359.78 | CONC | |
| 18 | 14889167.78 | 1992700.04 | 6362.28 | TBC | |
| 17 | 14889133.41 | 1992700.04 | 6362.54 | TBC | |
| 16 | 14889128.41 | 1992705.04 | 6362.64 | TBC | |
| 15 | 14889128.41 | 1992720.04 | 6362.34 | TBC | |
| 14 | 14889105.26 | 1992720.04 | 6360.65 | TBC | |
| 13 | 14889030.76 | 1992794.54 | 6358.11 | TBC | |
| 12 | 14889030.76 | 1992836.65 | 6357.42 | TBC | |
| 11 | 14889015.26 | 1992836.65 | 6357.73 | TBC | |
| 10 | 14889010.76 | 1992841.15 | 6357.64 | TBC | |
| 9 | 14889010.76 | 1992878.50 | 6356.10 | TBC | |
| 8 | 14889013.98 | 1992882.04 | 6355.94 | TBC | |
| 7 | 14889022.87 | 1992881.81 | 6355.88 | TBC | |
| 6 | 14889027.74 | 1992876.69 | 6356.31 | TBC | |
| 5 | 14889027.27 | 1992857.60 | 6356.69 | TBC | |
| 4 | 14889094.33 | 1992855.93 | 6356.12 | TBC | |
| 3 | 14888936.20 | 1992779.20 | 6359.11 | CP3 | |
| 2 | 14889172.62 | 1992716.29 | 6361.78 | CP2 | |
| 1 | 14889041.07 | 1992688.78 | 6391.14 | CP1 | |



(R04)
INTERMOUNTAIN REGION

STAMPS, LOGOS, AND SEALS

| ۵/ | s Regina Freel | |
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| 4 | 11/29/18 | |
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| NO. | REVISION / ISSUE | DATE |

PROJECT NAME

FLAMING GORGE RANGER DISTRICT ADDITION


ASHLEY NATIONAL FOREST

FLAMING GORGE DISTRICT

DRAWING TITLE

SITE GRADING AND DRAINAGE PLAN

| 11/29/2018 | 741011111 | | |
|-----------------|---------------------|---------|---------------|
| DESIGNER RANDER | DESIGNER R.ANDERSON | | SHEET NO. |
| R.ANDER | R.ANDERSON | | 75 |
| CHECKED D.JEPPS | CHECKED D.JEPPSEN | | |
| PROJECT NO. | | SHEET 8 | OF 119 |

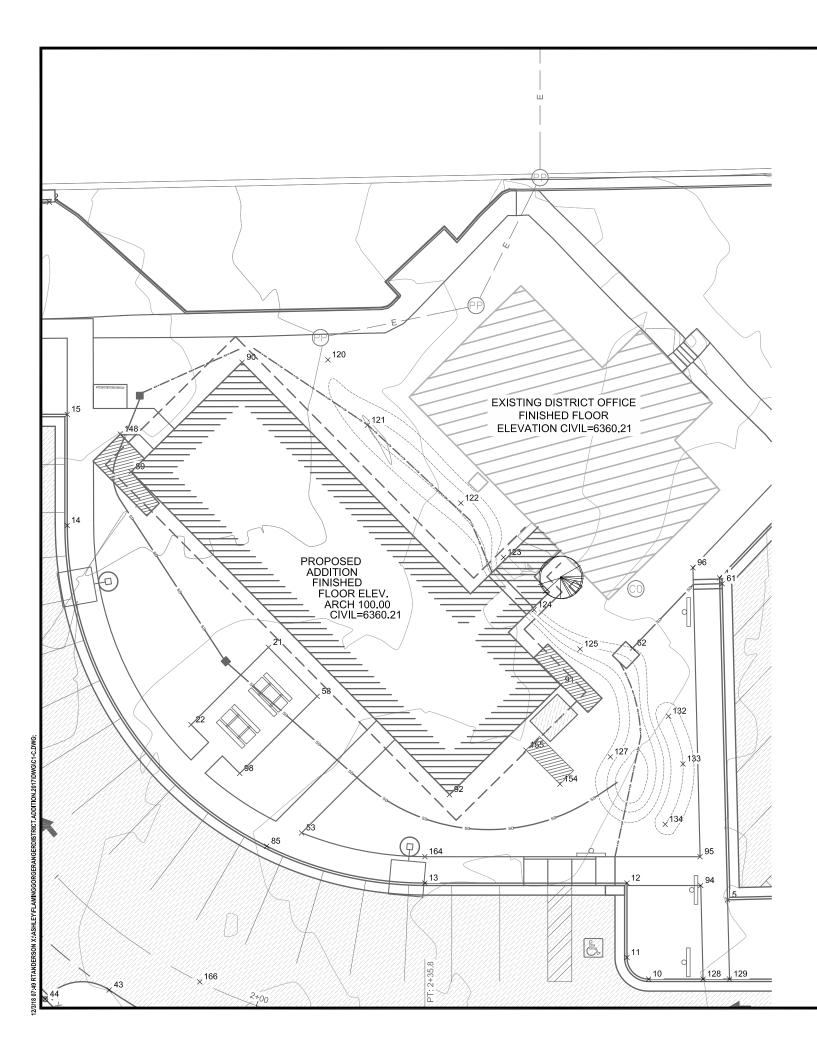

| Point Table | | | | | |
|-------------|-------------|------------|-----------|-------------|--|
| Point # | Northing | Easting | Elevation | Description | |
| 155 | 14889058.46 | 1992815.60 | -1.82 | PLANTER | |
| 154 | 14889051.39 | 1992822.68 | -1.82 | PLANTER | |
| 148 | 14889124.29 | 1992731.10 | 6356.92 | PLANTER | |
| 134 | 14889042.99 | 1992844.60 | 6358.00 | BERM | |
| 133 | 14889055.59 | 1992848.31 | 6358.00 | BERM | |
| 132 | 14889065.52 | 1992845.31 | 6358.00 | BERM | |
| 127 | 14889057.06 | 1992833.18 | 6356.82 | SWALE | |
| 126 | 14889072.58 | 1991851.54 | 6356.33 | SWALE | |
| 125 | 14889079.51 | 1992826.89 | 6356.51 | SWALE | |
| 124 | 14889087.70 | 1992817.29 | 6356.81 | SWALE | |
| 123 | 14889098.60 | 1992810.92 | 6356.92 | SWALE | |
| 122 | 14889109.93 | 1992802.03 | 6357.56 | SWALE | |
| 121 | 14889126.15 | 1992782.57 | 6358.29 | SWALE | |
| 120 | 14889139.77 | 1992774.34 | 6358.81 | SWALE | |
| 62 | 14889079.71 | 1992837.80 | 6355.77 | INV | |
| 61 | 14889093.13 | 1992856.46 | 6355.62 | INV | |



S/S Regina Freel

A 11/29/18

3

NO. REVISION/ISSUE DATE

FLAMING GORGE RANGER

ADDITION

ASHLEY NATIONAL FOREST

DISTRICT

FLAMING GORGE DISTRICT

DRAWING TITLE

FINE SITE LAYOUT AND GRADING PLAN

DATE 11/29/2018

DESIGNER RANDERSON

DRAWN RANDERSON


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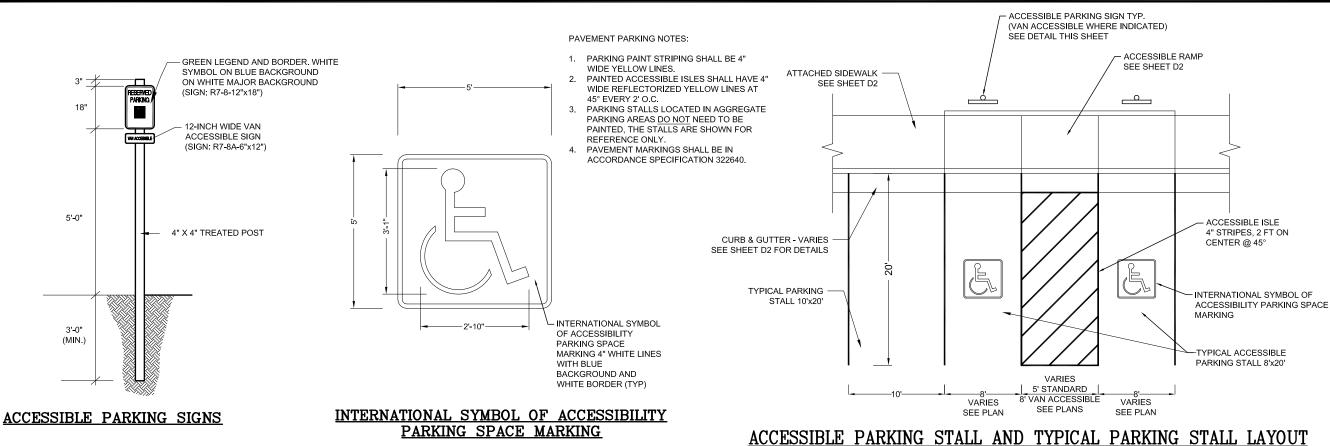
PROJECT NO.


ARCHIVE NO.

DRAWING SHEET NO.

CAMBER OF 119




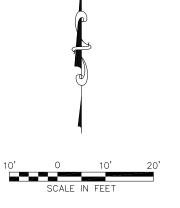

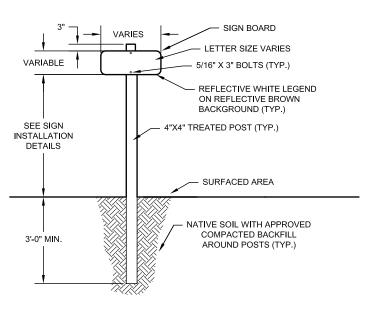


SINGLE POST SIGNS


| | SIGN LIST | | | | | | |
|---------|--|---------------|---|--|--------------------------------|--|--|
| | SINGLE POST SIGNS (4"X4" POSTS) | | | | | | |
| | DESCRIPTION SIGN # QUANTITY SIZE NOTES COLOR | | | | | | |
| SIGN #1 | ACCESSIBLE PARKING W/ VAN ACCESSIBLE PLAQUE | R7-8-12 R7-8a | 2 | | GREEN ON WHITE, BLUE SYMBOL | | |
| SIGN #2 | NO UNAUTHORIZED ACCESS BEYOND THIS POINT | FRD-3-4 | 2 | | WHITE ON BROWN | | |
| SIGN #3 | VISITOR PARKING ∜ | FRD-2-4 | 2 | | WHITE ON BROWN | | |
| SIGN #4 | | FRD-2-4 | 2 | | WHITE ON BROWN | | |

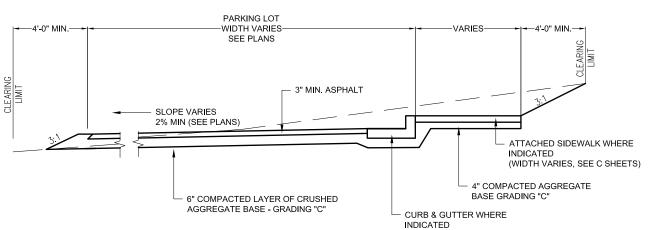


PAVED PARKING SECTION w/ CURB & GUTTER

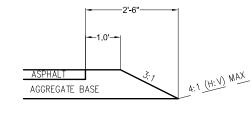


TYPICAL SHOULDER

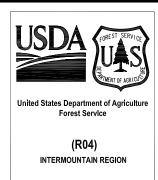

| | STAMPS, LOGOS, AND SEALS | 3 |
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ACCESSIBILITY DETAILS
AND PARKING AREA
SECTION

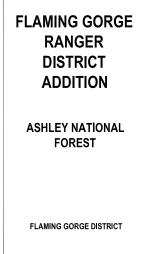

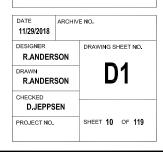



SIDEWALKS

- ALL SIDEWALKS SHALL HAVE A MINIMUM THICKNESS OF
- 4" UNLESS OTHERWISE NOTED. ALL SIDEWALKS SHALL BE PLACED ON A MINIMUM 4" LAYER OF AGGREGATE GRADING "C".
- MAX CROSS SLOPE OF 2.0%

CURB & GUTTERS

- CONTRACTION JOINTS EVERY 10' O.C. 1/2" DEEP, EXPANSION JOINTS EVERY 50' O.C.
- MINIMUM 0.5% LONGITUDINAL SLOPE FOR VALLEY GUTTER AND 30 INCH CURB & GUTTER.
- PLACED ON A MINIMUM 6" LAYER OF COMPACTED AGGREGATE GRADING "C".

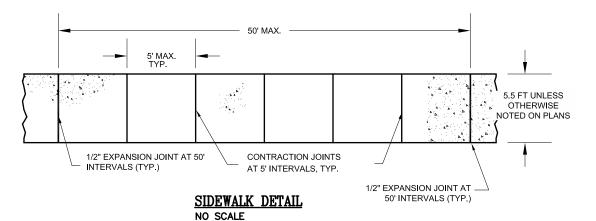

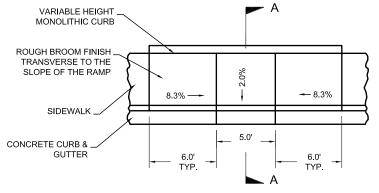



STAMPS, LOGOS, AND SEALS

s/s Regina Freel

REVISION / ISSUE

FLAMING GORGE

RANGER DISTRICT **ADDITION**

ASHLEY NATIONAL

FOREST

FLAMING GORGE DISTRICT

DATE

11/29/18


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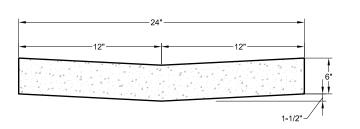
NO.

PROJECT NAME

ACCESSIBLE RAMP DETAIL





ATTACHED SIDEWALK SECTION NO SCALE

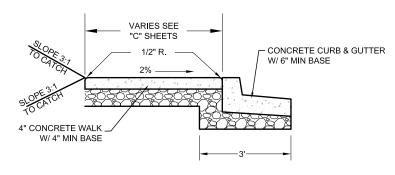

VALLEY GUTTER DETAIL


THROUGH-CHANNEL DETAIL

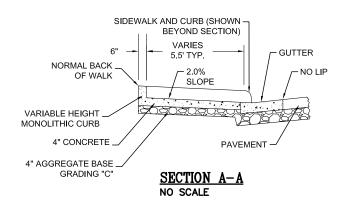

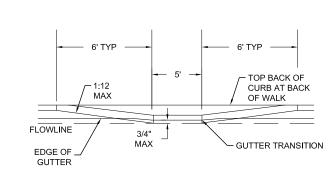







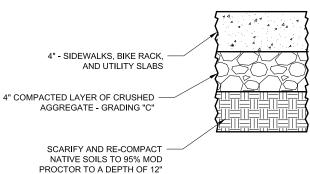

SHED CURB & GUTTER DETAIL

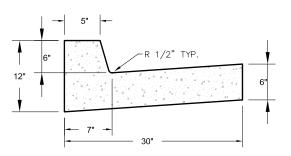

"L" CURB & GUTTER DETAIL

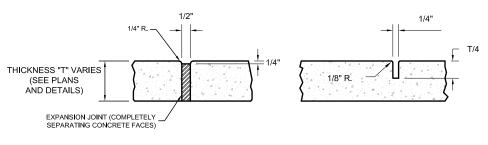

EXPANSION JOINT DETAIL NO SCALE

12"

CONTRACTION JOINT DETAIL NO SCALE


CONCRETE SECTION DETAIL

DRAWING TITLE **CURB, GUTTER AND** SIDEWALK DETAILS

ARCHIVE NO. 11/29/2018 DRAWING SHEET NO. R.ANDERSON R.ANDERSON D.JEPPSEN PROJECT NO. SHEET 11 OF 119



NDS, INC. 851 NORTH HARVARD AVE. LINDSAY, CA 93247 TOLL FREE: 1-800-726-1994 PHONE: (559) 562-9888 FAX: (559) 562-4488 www.ndspro.com

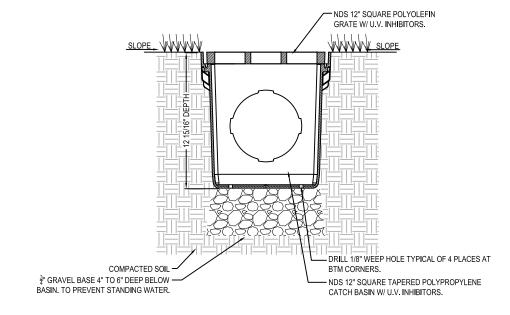

SECTION

- NOTES:

 1. GRATE TO BE ATTACHED TO CATCH BASIN WITH SCREW PROVIDED AT TIME OF INSTALLATION.

 2. RISER CAN BE CUT TO ACHIEVE EXACT ELEVATION.

 3. DO NOT USE OVER 5 RISERS WITH CATCH BASIN.


- 4. INSTALLATION TO BE COMPLETED IN ACCORDANCE WITH MANUFACTURER'S SPECIFICATIONS.
- 5. DO NOT SCALE DRAWING.
- 6. THIS DRAWING IS INTENDED FOR USE BY ARCHITECTS, ENGINEERS, CONTRACTORS, CONSULTANTS AND DESIGN
- PROFESSIONALS FOR PLANNING PURPOSES ONLY.

 7. ALL INFORMATION CONTAINED HEREIN WAS CURRENT AT THE TIME OF DEVELOPMENT BUT MUST BE REVIEWED AND APPROVED BY THE PRODUCT MANUFACTURER TO BE CONSIDERED ACCURATE.





REVISION DATE 8-24-2015

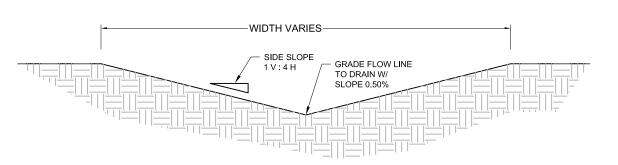

DETENTION BASIN SECTION



(R04) INTERMOUNTAIN REGION

STAMPS, LOGOS, AND SEALS

s/s Regina Freel 11/29/18 <u>_3</u> <u>^2</u> NO. REVISION / ISSUE DATE

PROJECT NAME

FLAMING GORGE RANGER DISTRICT **ADDITION**


ASHLEY NATIONAL FOREST


FLAMING GORGE DISTRICT

DRAWING TITLE

NDS INLET BASIN AND **DETENTION BASIN DETAILS**

| DATE ARCHIVE 11/29/2018 | | E NO. | |
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| 11/29/2010 | | | |
| DESIGNER | | DRAWING S | HEET NO. |
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| R.ANDER | SON | Ľ | <i>,</i> |
| CHECKED | | | |
| D.JEPPS | EN | | |
| PROJECT NO. | | SHEET 12 | OF 119 |
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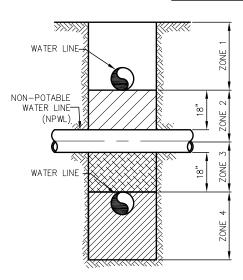


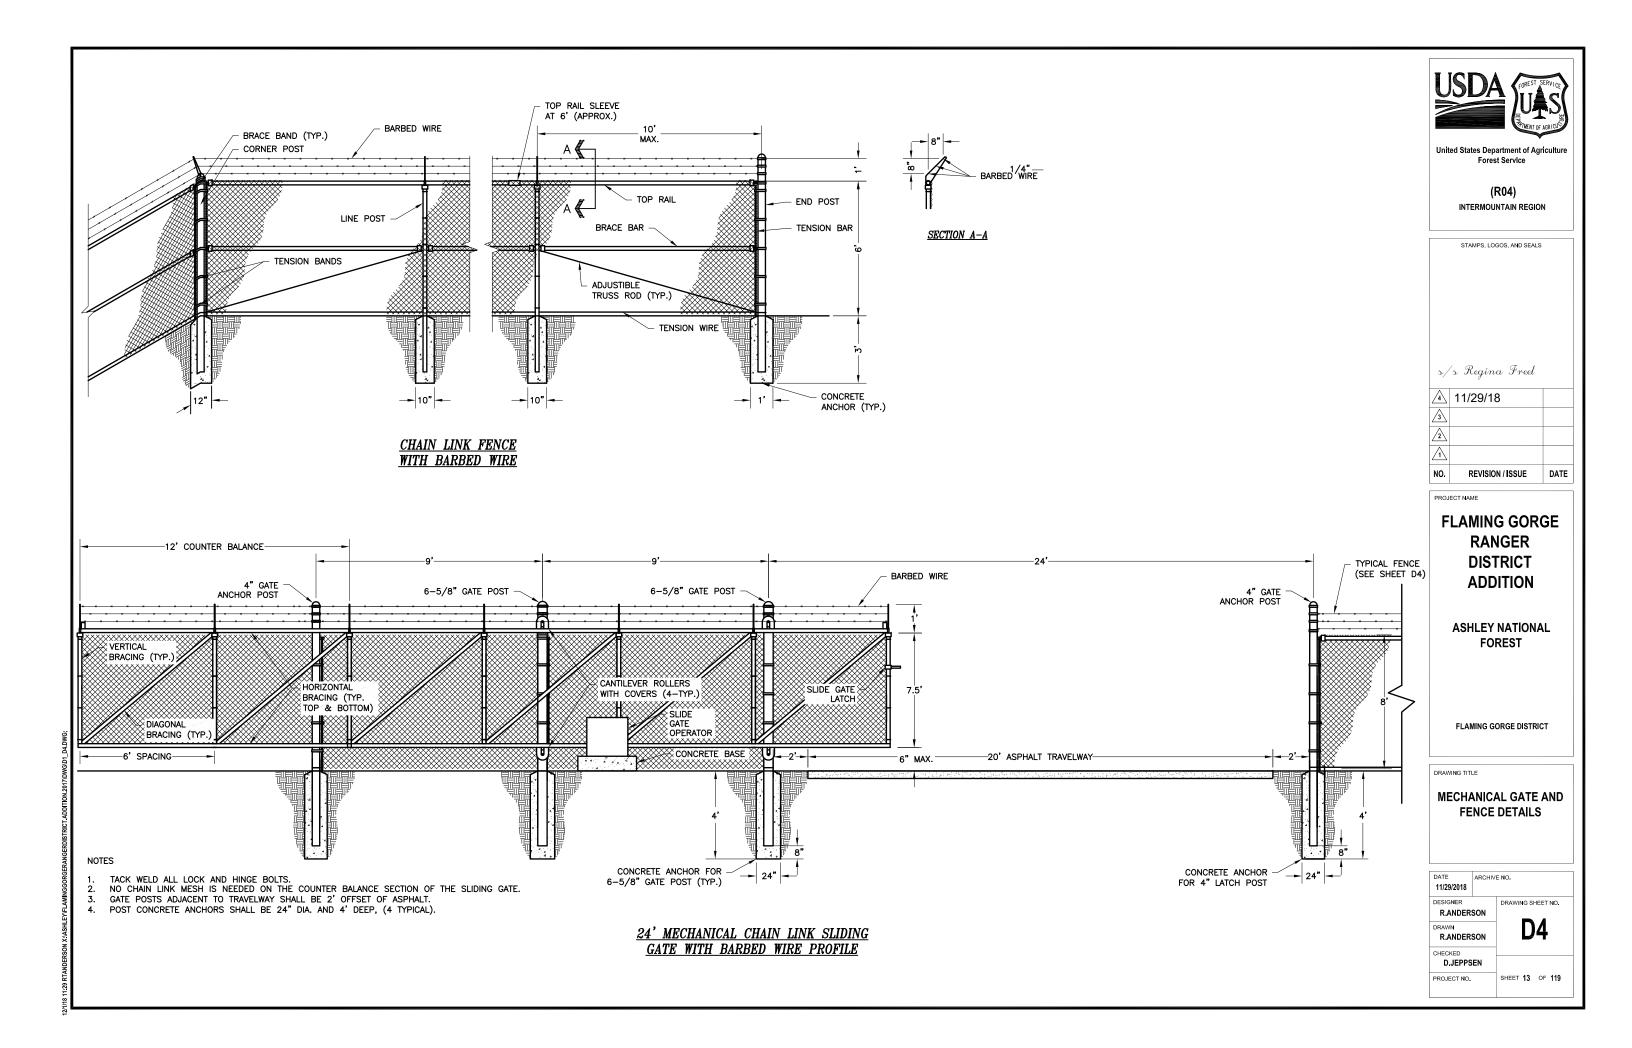

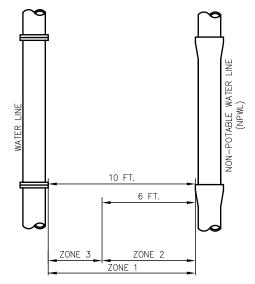NOTES:

- ZONE 1: A) WATERLINE AND NPWL SEPARATED 10' OR MORE NO SPECIAL REQUIREMENTS
- ZONE 2: A) WATERLINE AND NPWL SEPARATED BY AT LEAST 6 FEET AT OUTSIDE WALLS.
 - AND B) WATERLINE AT LEAST 18 INCHES HIGHER IN ELEVATION THAN THE NPWL.
 - AND EITHER C) NPWL CONSTRUCTED TO WATER MAIN STANDARDS AND PRESSURE TESTED FOR WATER TIGHTNESS.
 - OR D) NPWL ENCASED IN AT LEAST 4 INCHES OF CONCRETE MEASURED AT THE BELL.
 - OR E) SITE SPECIFIC REQUIREMENTS APPROVED BY DEQ.
- ZONE 3: WATER AND NPWL SEPARATED LESS THAN 6' NOT ALLOWED.

HORIZONTAL SEPARATION REQUIREMENTS



NOTES:


- ZONE 1: A) WATERLINE ABOVE NPWL MUST BE SEPARATED BY AT LEAST 18 INCHES.
 - AND B) ONE FULL, UNCUT LENGTH OF WATER PIPE MUST BE CENTERED OVER THE CROSSING SO THAT THE JOINTS ARE AS FAR AS POSSIBLE FROM THE NPWL.
- ZONE 2: A) WATERLINE ABOVE NPWL, LESS THAN 18 INCHES ONE FULL, UNCUT LENGTH OF WATER PIPE MUST BE CENTERED OVER THE CROSSING SO THAT THE JOINTS ARE AS FAR AS POSSIBLE FROM THE NPWL.
 - OR B) NPWL MAIN MUST BE CONSTRUCTED TO WATER MAIN STANDARDS AND PRESSURE TESTED FOR WATER TIGHTNESS FOR A HORIZONTAL DISTANCE OF 10 FEET ON BOTH SIDES OF CROSSING.
 - OR C) EITHER THE NPWL OR WATER MAIN OR BOTH MUST BE ENCASED IN AT LEAST 4 INCHES OF CONCRETE MEASURED AT THE BELL FOR A HORIZONTAL DISTANCE OF 10 FEET ON BOTH SIDES OF THE CROSSING.
- ZONE 3: WATERLINE BELOW NPWL, LESS THAN 18 INCHES SAME REQUIREMENTS AS ZONE 2 EXCEPT THE NPWL MUST ALSO BE SUPPORTED ABOVE THE CROSSING TO PREVENT SETTLING.
- ZONE 4: WATERLINE ABOVE NPWL, MORE THAN 18 INCHES SAME REQUIREMENTS
 AS ZONE 1 EXCEPT THE NPWL MUST ALSO BE SUPPORTED ABOVE THE
 CROSSING TO PREVENT SETTLING.

VERTICAL SEPARATION REQUIREMENTS

POTABLE & NON-POTABLE UTILITY LINE INTERSECTION DETAILS

TRENCHING NOTES:

- 1. WALLS SHALL BE VERTICAL FOR TRENCHES LESS THAN 5'-0" DEEP AT CENTERLINE. FOR DEPTHS GREATER THAN 5'-0", THE WALLS SHALL BE LAID BACK TO MEET APPLICABLE SAFETY STANDARDS.
- 2.IF BOTTOM OF TRENCH IS UNSATISFACTORY BEDDING MATERIAL, A MINIMUM OF 6" OF PIPE—ZONE MATERIAL OR IMPORTED SPECIAL BEDDING SHALL BE USED DEPENDING ON MATERIAL ENCOUNTERED. IF SOIL IS OF A UNIFORM TEXTURE MEETING PIPE—ZONE MATERIAL SPECIFICATIONS, THIS NEED NOT BE EXCAVATED. IF FOR SEWERLINE, ROUND TRENCH SO BOTTOM HALF OF CIRCUMFERENCE OF THE PIPE WILL REST ON UNDISTURBED SOIL.
- 3.REQUIRED DEPTH OF BEDDING VARIES WITH TYPE OF PIPE. SEE SPECIFICATIONS TO DETERMINE IF OTHER THAN 12" IS REQUIRED OVER TOP OF PIPE.
- 4.IN AREAS WHERE TRENCH RESURFACING IS REQUIRED, THIS INDICATES MAXIMUM PAY WIDTH ALLOWED.
- 5.MAINTAIN 8" MINIMUM HORIZONTAL SEPARATION BETWEEN UTILITY LINES IN THE SAME TRENCH.
- 6.UTILITY LINES SHALL BE BURIED A MINIMUM OF 30 INCHES UNLESS OTHERWISE NOTED, WATER LINES SHALL BE BURIED A MINIMUM OF 48 INCHES.
- 6.WRAP ALL BURIED, NON-METALLIC PIPE WITH TRACER WIRE. WHERE POSSIBLE, ATTACH TRACER WIRE TO OBJECTS OR STRUCTURES ABOVE GRADE (SEE SPECIFICATION SECTION 312000).

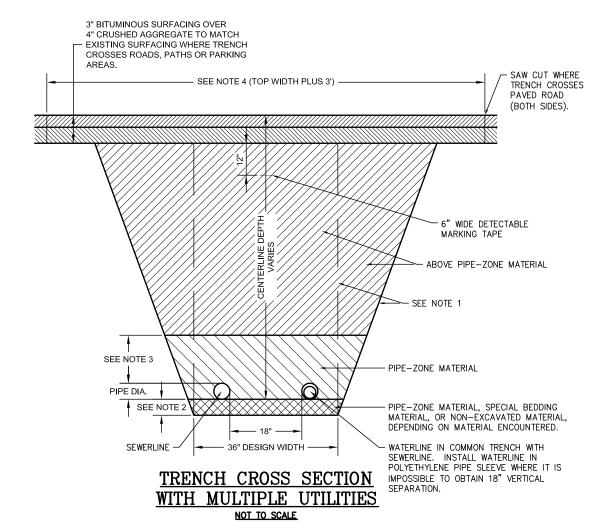



(R04)
INTERMOUNTAIN REGION

STAMPS, LOGOS, AND SEALS

s/s Regina Freel

11/29/18

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NO. REVISION/ISSUE DATE

FLAMING GORGE

PROJECT NAME

RANGER DISTRICT ADDITION

ASHLEY NATIONAL FOREST

FLAMING GORGE DISTRICT


DRAWING TITLE

TRENCH SEPARATION DETAILS

DATE 11/29/2018 ARCHIVE NO.

DESIGNER RANDERSON
DRAWN RANDERSON
CHECKED D.JEPPSEN
PROJECT NO.

ARCHIVE NO.
DRAWING SHEET NO.
DRAWING SHEET NO.
SHEET 14 OF 119

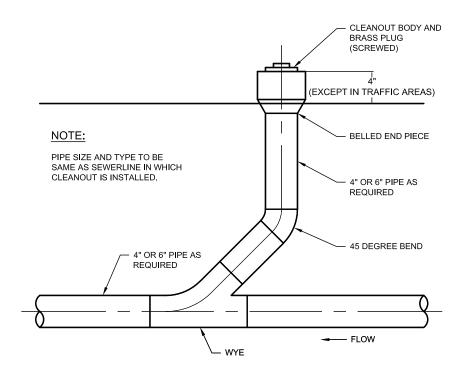

SEWER CLEANOUT



United States Department of Agriculture Forest Service

(R04)
INTERMOUNTAIN REGION

STAMPS, LOGOS, AND SEALS

s/s Regina Freel

| NO. | REVISION / ISSUE | DATE |
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PROJECT NAME

FLAMING GORGE RANGER DISTRICT ADDITION


ASHLEY NATIONAL FOREST

FLAMING GORGE DISTRICT


DRAWING TITLE

SANITARY SEWER CLEANOUT DETAILS

| 11/29/2018 ARCHIVE | | E NO. | |
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| DESIGNER R.ANDERSON | | DRAWING SI | _ |
| R.ANDERSON | | D6 | |
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| PROJECT NO. | | SHEET 15 | OF 119 |

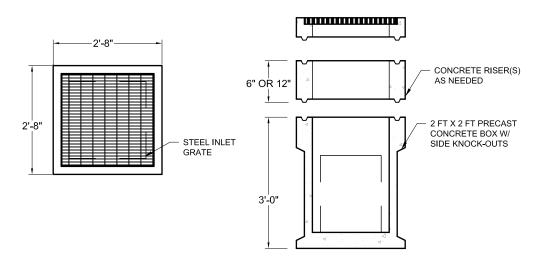


PRECAST CONCRETE INLET BOX

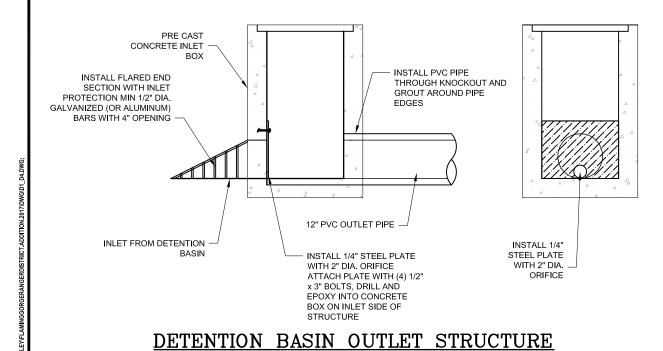

NOTE

- 1. (\longrightarrow) INDICATES DIRECTION OF FLOW.
- 2. DIMENSION 'B' EQUALS 'A' +1
- 1/2" THICK STEEL DIAMOND PLATE SHALL BE PAINTED PER SPECIFICATIONS (MIN 2 COATS).
- H' EQUALS CURB FACE HEIGHT. DIMENSIONS TO BE NOTED ON PLANS OR ESTABLISHED IN THE FIELD.
- 5. FOR CURB AND GUTTER, USE 2 FT TRANSITIONS TO VERTICAL CURB.
 6. FOR MULTIPLE SCUPPERS PROVIDE 4" BETWEEN
- FOR MULTIPLE SCUPPERS PROVIDE 4" BETWEEN ADJACENT PANELS OF STEEL DIAMOND PLATE. INTERMEDIATE POSTS FOR BARRICADE RAILINGS SHALL BE PLACED MIDWAY IN 4" AREA BETWEEN ADJACENT PANELS.
- STEEL DIAMOND PLATE SHALL BE DELIVERED AS ONE PIECE, CONFORMING TO THE REQUIRED SCUPPER DIMENSIONS. PLATES SHALL NOT BE SPI ICED
- SCUPPER FLOW LINE SHALL BE FLUSH WITH PAVEMENT ON INLET SIDE, AND SHALL HAVE A 1" LIP ON OUTLET SIDE OF SCUPPER.

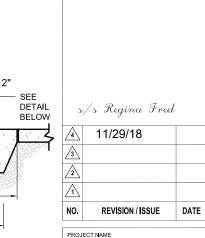

FLAMING GORGE RANGER DISTRICT ADDITION

United States Department of Agriculture

Forest Service

(R04)

INTERMOUNTAIN REGION

STAMPS, LOGOS, AND SEALS

ASHLEY NATIONAL FOREST

FLAMING GORGE DISTRICT

OUTLET DETAILS

DETENTION BASIN

DATE 11/29/2018 ARCHIVE NO.


DESIGNER RANDERSON DRAWING SHEET NO.

DRAWN RANDERSON

CHECKED D.JEPPSEN

PROJECT NO.

SHEET 16 OF 119

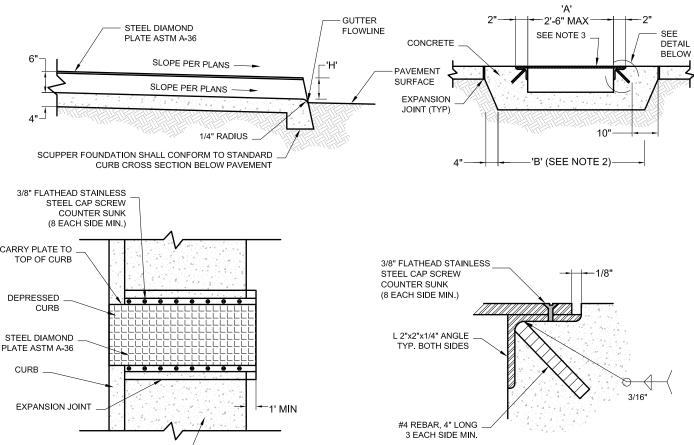

SIDEWALK WIDTH . PER PLAN

SIDEWALK SCUPPER DETAIL



LANDSCAPE ELEMENTS



1" APACHE GOLD DECORATIVE GRAVEL (3" UNIFORM DEPTH, TYP)



4"-6" GREY RIVER ROCK (4" UNIFORM DEPTH, TYP)



2"-4" BASALT ANGULAR ROCK (4" UNIFORM DEPTH, TYP)



WEATHERED STEEL PLANTER (3, CUSTOM)

DECORATIVE LANDSCAPE BOULDER (30, TYP)



OVERSIZED DECORATIVE LANDSCAPE BOULDER (4, TYP)




FLAGSTONE STEPPER (12, TYP) SIZE: 2' X 3' MINIMUM



LANDSCAPED DRAINAGE SWALE (SEE GRADING/DRAINAGE PLAN)

NOTES:

- 1. SEE SHEET LD01 FOR PLANTING DETAILS.
- 2. PLANT QUANTITIES ARE PROVIDED FOR CONVENIENCE ONLY. THE DRAWING SHOWING PLANTING LAYOUT SUPERCEDES THE PLANT SCHEDULE.
- INSTALL EDGING BETWEEN ALL LAWN AND DECORATIVE GRAVEL/ROCK AREAS AND/OR AS SHOWN ON THE DRAWINGS.
- 4. ALL PLANTINGS INCLUDING: TREES, SHRUBS, GROUNDCOVERS AND NATIVE GRASS AREAS SHOWN ON THIS PLAN WITHIN THE CONSTRUCTION LIMIT LINE SHALL HAVE A PERMANENT IRRIGATION SPRINKLER SYSTEM DESIGNED BY AND INSTALLED BY THE CONTRACTOR TO IRRIGATE THESE AREAS AS SHOWN ON THIS PLAN.
- IRRIGATE THESE AREAS AS SHOWN ON THIS PLAN.
 5. SEE SPECIFICATION 328000 FOR IRRIGATION SYSTEM DESIGN AND CONSTRUCTION REQUIREMENTS.
- 6. INSTALL DECORATIVE ALL GRAVEL/ROCK TO A UNIFORM COMPACTED 3—INCH DEPTH IN ALL LOCATIONS AS IDENTIFIED ON THE DRAWINGS. INSTALL DECORATIVE GRAVEL IN ALL LOCATIONS NOT SHOWN AS LAWN OR FLAGSTONE. (SEE SPECIFICATION 329400).
- EXISTING TREES SHOWN ARE FOR CONVENIENCE ONLY.
 THE CONTRACTOR SHALL BE RESPONSIBLE FOR
 VERIFYING THE ACTUAL NUMBER AND LOCATION OF
 TREES, SHRUBS AND VEGETATION TO BE REMOVED.

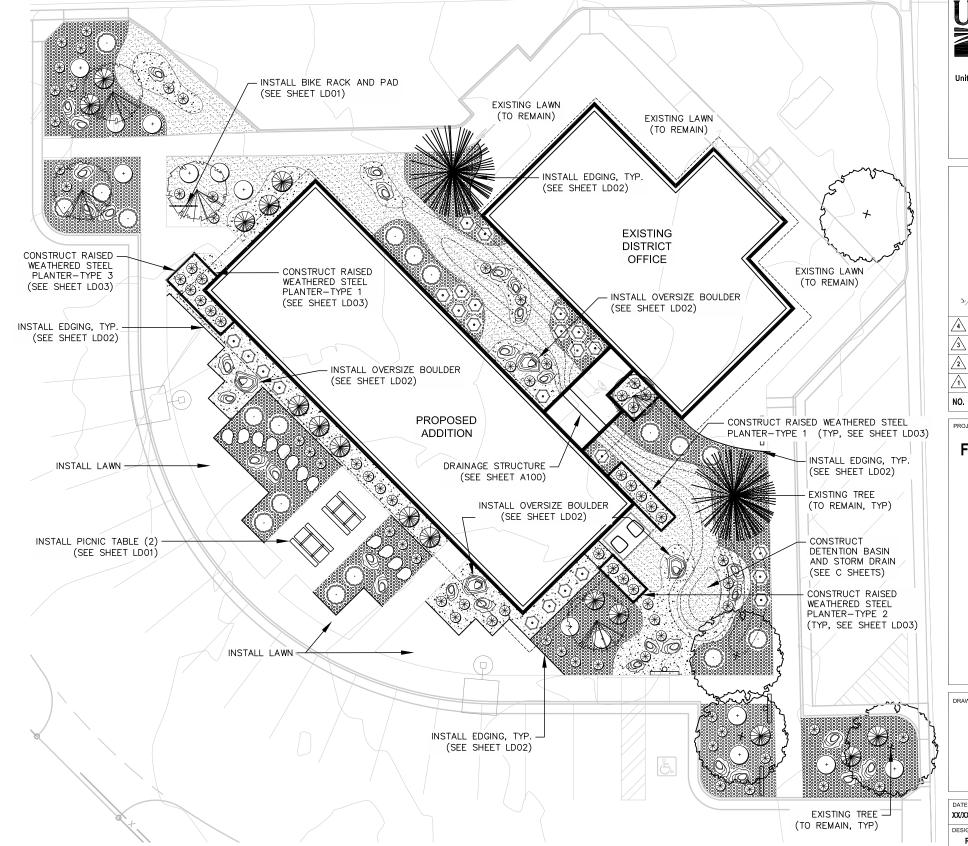



d States Department of Agriculture Forest Service

(R04)
INTERMOUNTAIN REGION

STAMPS, LOGOS, AND SEALS

\$\sigma \text{\$\text{Regina Freel}}\$

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DATE

PROJECT NAME

FLAMING GORGE RANGER DISTRICT ADDITION

REVISION / ISSUE

ASHLEY NATIONAL FOREST

FLAMING GORGE DISTRICT

DRAWING TITLE

LANDSCAPE PLAN

DATE
XX/XX/XXXXX

DESIGNER
R. BUDGE

DRAWIN
R. BUDGE

CHECKED
D. JEPPSEN

PROJECT NO.


ARCHIVE NO.


DRAWING SHEET NO.

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SHEET 17 OF 119


10' 0 10' 20' SCALE IN FEET



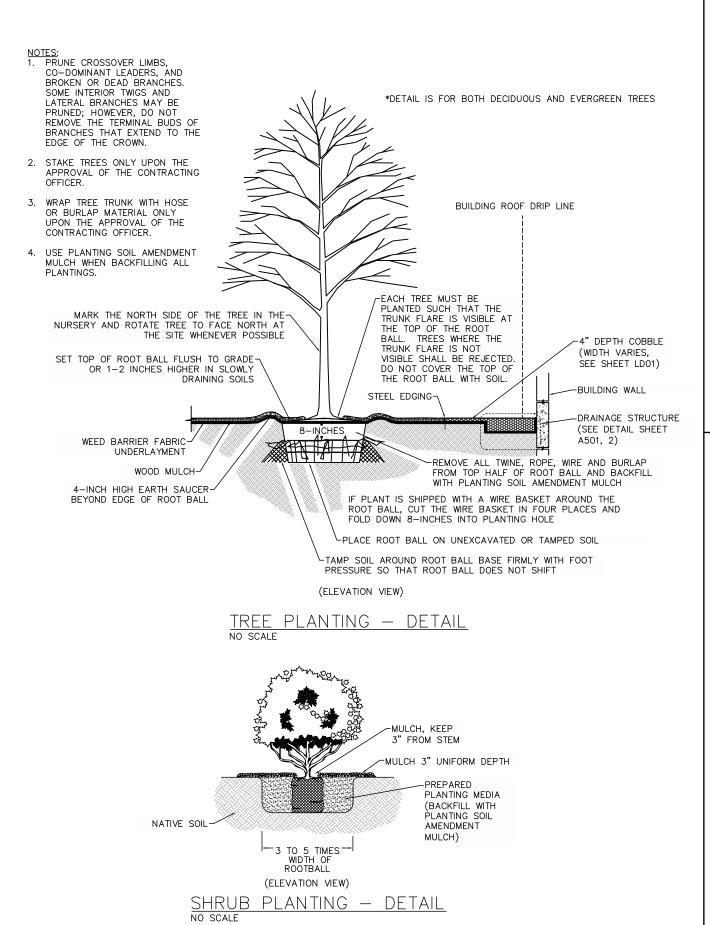

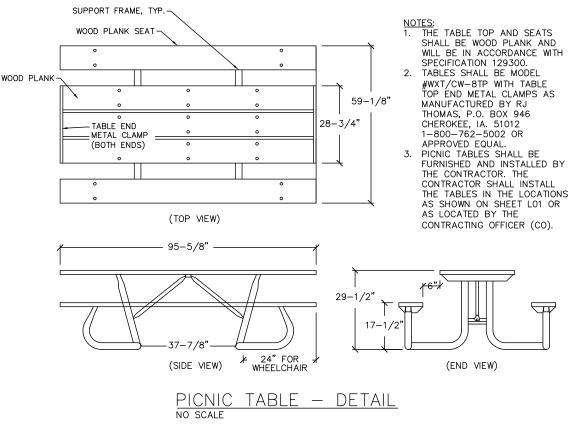NOTES:

- THICKEN CONCRETE SLAB TO 9" DEPTH UNDER EACH FLANGE FOR ANCHOR WEDGE INSTALLATION.
- 2. PLACE CONCRETE PAD ON 4" COMPACTED AGGREGATE BASE GRADING "C"
- INSTALL BIKE RACKS IN THE LOCATIONS AS SHOWN ON SHEET LO1 OR AS APPROVED BY THE CONTRACTING OFFICER.
- 4. BIKE RACKS SHALL BE FURNISHED AND INSTALLED BY THE CONTRACTOR. THE CONTRACTOR SHALL PROVIDE BIKE RACK AND ANCHORING MECHANISMS NECESSARY TO COMPLETE THE INSTALLATION.
- 5. BIKE RACK SHALL BE PILOT ROCK MODEL: SRP/G-7, ANCHORING SYSTEM MODEL: ANC3-4 AS MANUFACTURED BY THE R.J. THOMAS MFG. CO. INC., CHEROKEE, IOWA OR APPROVED EQUAL. PHONE: 1-800-762-5002, WEB SITE: WWW.PILOTROCK.COM

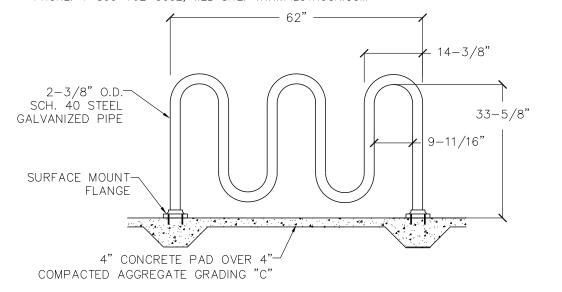

BIKE RACK INSTALLATION — DETAIL

JSDA FOREST SERVICE USS

United States Department of Agricultu Forest Service

(R04)
INTERMOUNTAIN REGION

STAMPS, LOGOS, AND SEALS

s/s Regina Freel

| NO. | REVISION / ISSUE | DATE |
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PROJECT NAME

FLAMING GORGE RANGER DISTRICT ADDITION

ASHLEY NATIONAL FOREST

FLAMING GORGE DISTRICT


DRAWING TITLE

PLANTING AND SITE FURNISHING DETAILS



DECORATIVE BOULDER NOTES:

- SET FRACTURED OR SOILED SIDE OF ROCK INTO EARTH AT A DEPTH OF 1/3 THE HEIGHT OF THE BOULDER.
- 2. PLACE BOULDERS AT RANDOM SPACINGS SO THEY APPEAR NATURAL.
- 3. SELECT DECORATIVE BOULDERS SHALL BE AT LEAST 24" X 36" IN SIZE.
- DECORATIVE LANDSCAPE BOULDERS SHALL BE PURCHASED FROM A COMMERCIAL SOURCE.

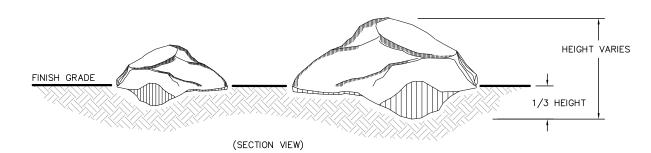


30" MIN.

DECORATIVE BOULDER PLANTING - DETAIL

NO SCALE

OVERSIZE DECORATIVE BOULDER NOTES:

- 1. SET FRACTURED OR SOILED SIDE OF ROCK INTO EARTH AT A DEPTH OF 1/3 THE HEIGHT OF THE BOULDER.
- WHEN BACKFILLING HAUNCH SOIL AROUND OVERSIZE BOULDER IN 6" LIFTS AND COMPACT UNTIL FINISH GRADE IS MET.
- 3. SELECT OVERSIZE DECORATIVE BOULDERS THAT SHALL AVERAGE AT LEAST 5' TALL ABOVE FINISHED GRADE WHEN BURIED BY 30" WIDE IN SIZE WHEN MEASURED IN THE SMALLEST DIMENSION.

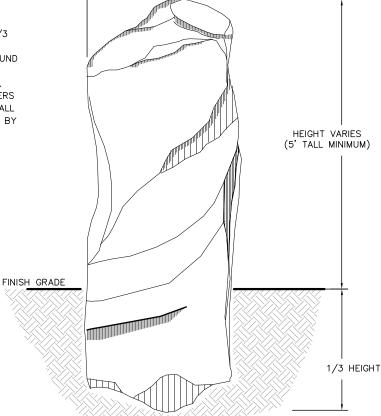


(SECTION VIEW)

OVERSIZED DECORATIVE BOULDER PLANTING - DETAIL

NO SCALE

NOTES

- 3/8" MINUS CRUSHER FINES TO HAVE PROPER MOISTURE CONTENT FOR COMPACTING TO THE SPECIFIED DENSITY.
- 2. CRUSHER FINES TO BE COMPACTED WITH VIBRATOR.
- 5. PERMALOC ATHLETEDGE SPORTS SURFACE RESTRAINT MANUFACTURER PROVIDED 10" SPIRAL STEEL STAKES OR APPROVED EQUAL.

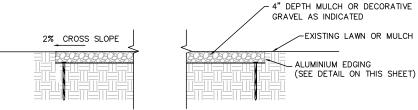

(SECTION VIEW)


INSTALLATION PER MANUFACTURER'S "INSTALLATION GUIDELINES"


- 1. 8'-0" (2.44 M) SECTIONS CONNECTED WITH 4" (102 MM) SLIDING CONNECTOR.
- 2. MAINTAIN 3/8" (9.5 MM) GAP BETWEEN SECTIONS TO ALLOW FOR PRODUCT EXPANSION IN EXTREME TEMPERATURES.
- EXPANSION IN EXTREME TEMPERATURES.

 CORNERS: NOTCH BASE ONLY AND FORM A CONTINUOUS CORNER.
- 4. PERMALOC ATHLETEDGE AS
 MANUFACTURED BY PERMALOC
 CORPORATION, HOLLAND MI.
 (800) 356–9660,
 (616) 399–9600
 WWW.PERMALOC.COM OR APPROVED EQUAL

SIZE: 8' LENGTHS (2.44 M) LENGTHS w/ 0.210" (5.33 MM)
THICK EXPOSED TOP LIP
4" X 3" (102 MM X 76 MM)

FINISH: BLACK DURAFLEX-ELECTROSTATICALLY APPLIED BAKED ON PAINT MEET AAMA 2603

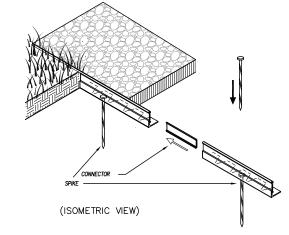

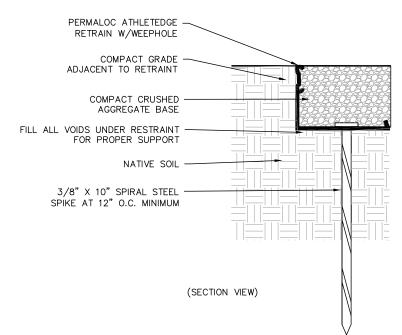

STEEL EDGING — DETAIL

ted States Department of Agricult
Forest Service

(R04)
INTERMOUNTAIN REGION

PROJECT NAME

FLAMING GORGE RANGER DISTRICT ADDITION

ASHLEY NATIONAL FOREST

FLAMING GORGE DISTRICT

DRAWING TITLE

BOULDERS, EDGING AND DECORATIVE GRAVEL DETAILS

DATE
03/02/2018

DESIGNER
R.BUDGE

DRAWN
R.BUDGE

CHECKED
D.JEPPSEN
PROJECT NO.

ARCHIVE NO.


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DRAWING SHEET NO.

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L.D.02

SHEET 19 OF 119



1" ELECTRIC DRIP VALVE

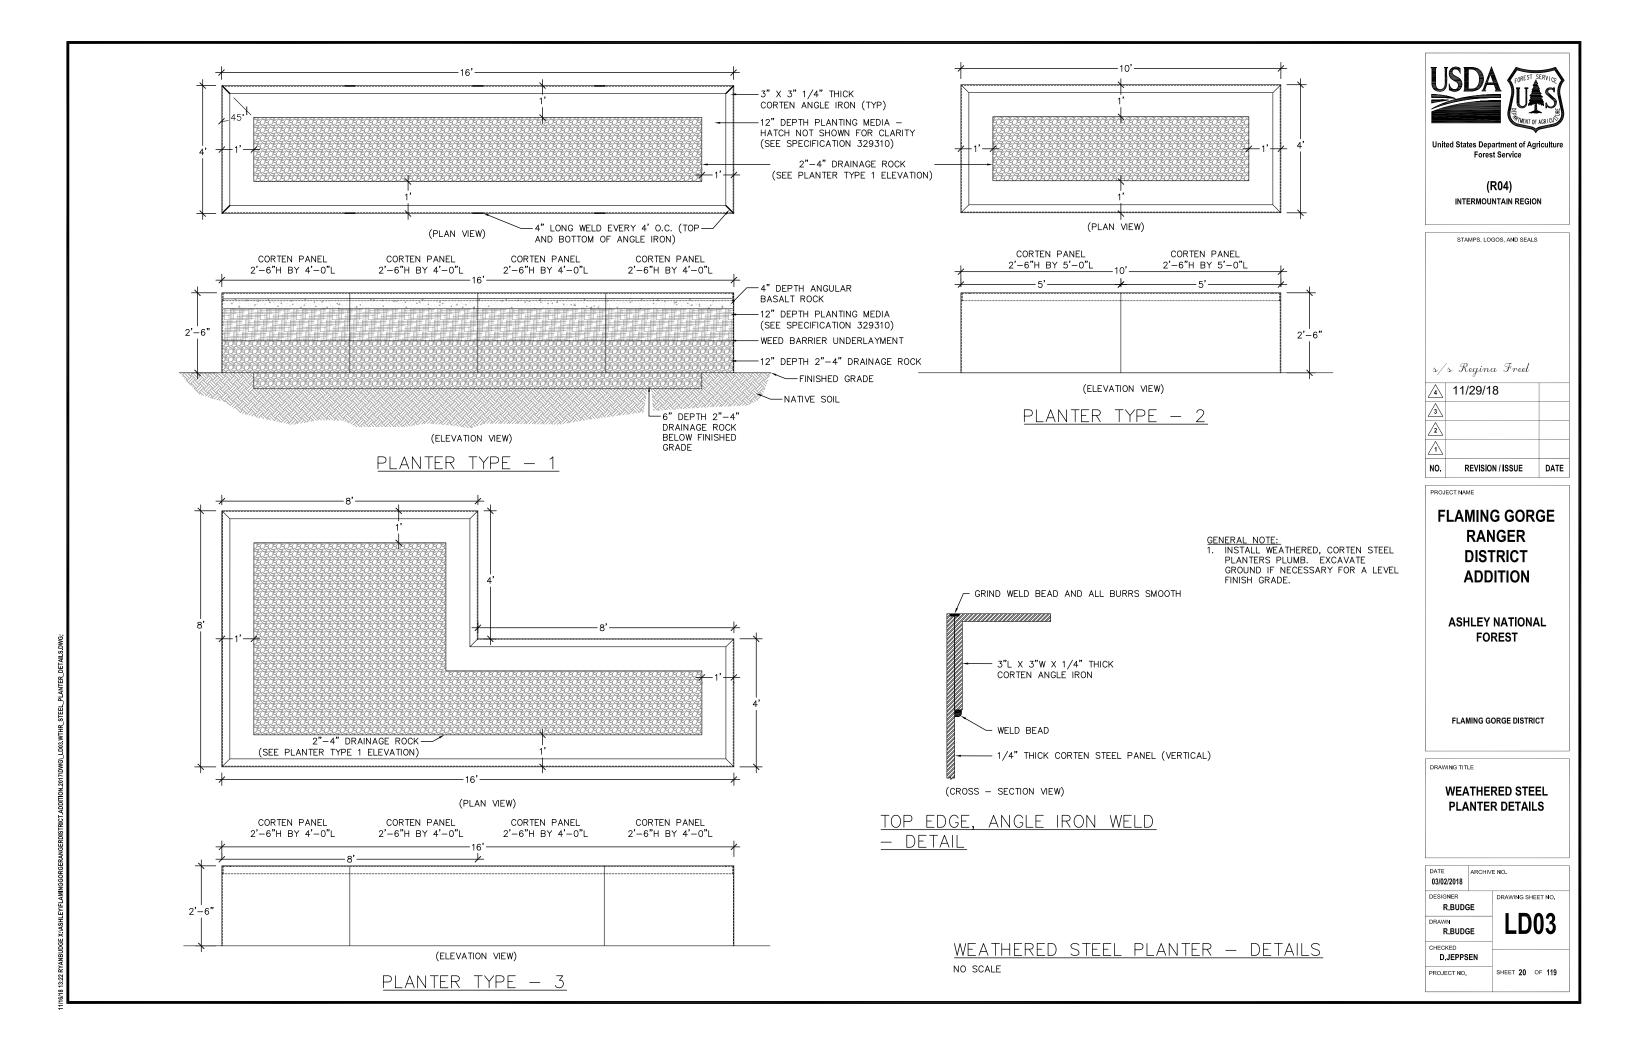1" ELECTRIC TURF VALVE

1804 POPUP SPRINKLER (NOZZLE 5'-8' MPR, SEE PLAN)

I-20 POPUP ROTOR (NOZZLE 18'-22', SEE PLAN)

▼ 1804 POPUP SPRINKLER (NOZZLE XERI PC 4'X4' SQUARE)

3/4" HOSE BIB ON 18" RISER

→ 1" ISOLATION VALVE

--- 1" MAINLINE (PVC SCHED. 40)

---- 1" LATERAL LINE (PVC CLASS 200)

FLEX PIPE DRIP TUBING (1/2" POLYETHYLENE) WITH FLUSH VALVE


___ 3" SLEEVE (PVC)

----- CONTROLLER WIRE (14-STRAND)

C CONTROLLER (12-STATION)

IRRIGATION NOTES:

- 1. SEE SHEETS IRD01 & IRD02 FOR IRRIGATION SYSTEM DETAILS.
- 2. SEE SPECIFICATION 328000 FOR REQUIREMENTS.
- 3. THE IRRIGATION SYSTEM IS DESIGNED TO OPERATE AT 30 PSI WITH A FLOW RATE OF 18 GPM. IF THESE CONDITIONS DO NOT EXIST NOTIFY THE CONTRACTING OFFICER IMMEDIATELY.
- 4. ALL SPRINKLER IRRIGATION PRODUCTS AND MATERIALS SHALL BE MANUFACTURED BY RAIN BIRD CORPORATION OR AN APPROVED EQUAL.
- 5. ALL MAIN LINES ARE TO BE 1" PVC SCHEDULE 40 PIPE AND ALL LATERAL LINES ARE TO BE 1" PVC CLASS 200 PIPE. AVOID SEWER LINES, UTILITY LINES, COMMUNICATION LINES AND TOWER WHEN INSTALLING IRRIGATION MAINLINES AND LATERAL LINES.
- INSTALL NEW CONTROLLER, WIRE, PIPE, HOSE BIBS, VALVES, VALVE BOXES, MANIFOLDS FOR NEW VALVES, FITTINGS, ISOLATION VALVES, EMISSION DEVICES, DRAINS, CONNECTIONS, AND ALL OTHER COMPONENTS NEEDED FOR A COMPLETE IRRIGATION SYSTEM.
- THE IRRIGATION SYSTEM SHALL BE CONNECTED TO A BACKFLOW PREVENTER THAT MEETS OR EXCEEDS APPLICABLE STATE REGULATIONS. THE BACKFLOW PREVENTER SHALL BE INSTALLED IN THE BUILDING'S MECHANICAL ROOM.
- 8. A 1-INCH COPPER PIPE TAP WILL BE PROVIDED IN THE BUILDING'S MECHANICAL ROOM FOR THE IRRIGATION SYSTEM POINT OF CONNECTION.
- 9. THIS DRAWING IS SCHEMATIC. ACTUAL INSTALLATION MAY VARY FROM THE DRAWING TO MEET ACTUAL SITE CONDITIONS AS APPROVED BY THE CONTRACTING OFFICER. DO NOT PLACE ANY VALVES, DRAINS, BOXES OR CANS IN ANY HARDSCAPE OR ASPHALT SURFACES.
- 10. THE CONTRACTOR SHALL PROVIDE THE OWNER WITH AN AS-BUILT DRAWING OF THE INSTALLED IRRIGATION SYSTEM ALONG WITH ANY SPRINKLER ADJUSTMENT KEYS, MANUALS AND OTHER ITEMS NEEDED TO MAINTAIN AND OPERATE THE SYSTEM
- 11. MAINLINE SHALL HAVE A STOP & WASTE VALVE INSTALLED AT THE END LINE AT THE LOWEST POINT IN IT'S OWN VALVE BOX.
- 12. INSTALL AUTO DRAINS IN ALL LATERAL LINE PIPING AT ALL LOW SPOTS.
- 13. COORDINATE IRRIGATION SLEEVE INSTALLATION TO OCCUR PRIOR TO HARDSCAPE INSTALLATION.

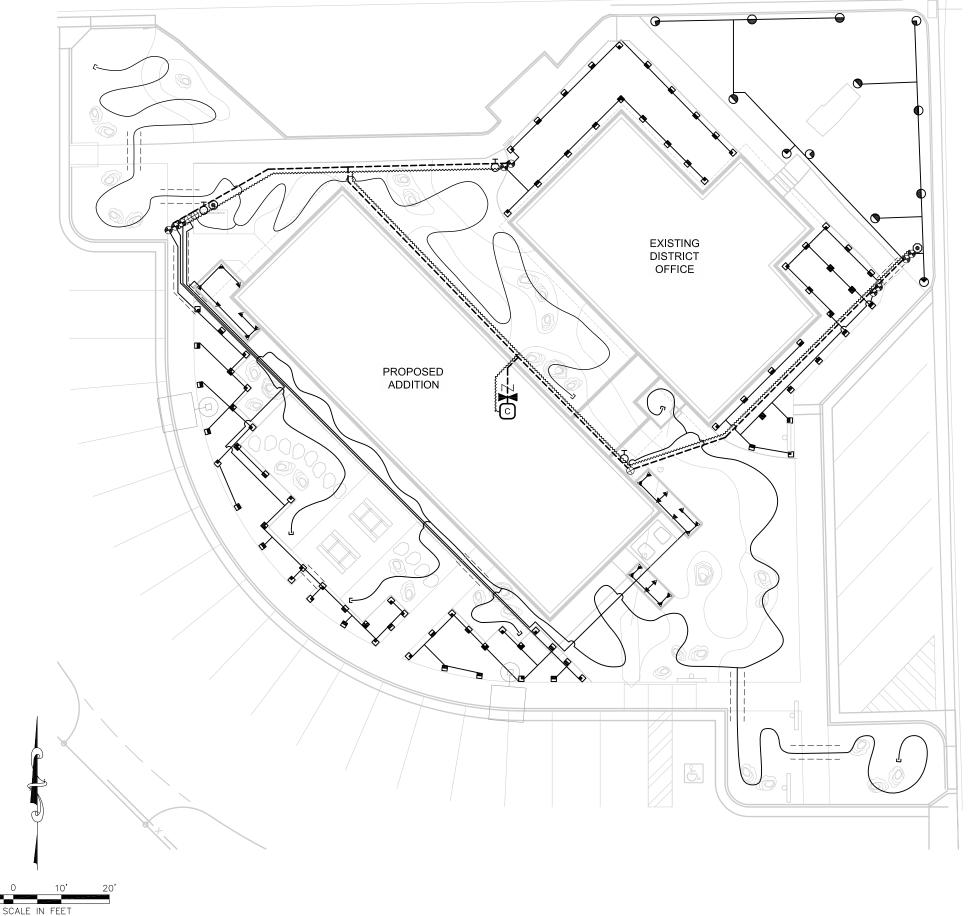



INTERMOUNTAIN REGION

STAMPS, LOGOS, AND SEALS

s/s Regina Freel

11/29/18

12

10

NO. REVISION/ISSUE DATE

FLAMING GORGE RANGER DISTRICT ADDITION

PROJECT NAME

ASHLEY NATIONAL FOREST

FLAMING GORGE DISTRICT

DRAWING TITLE

IRRIGATION PLAN

DATE
XX/XX/XXXXX

DESIGNER
R. BUDGE

DRAWN
R. BUDGE

CHECKED
D. JEPPSEN

PROJECT NO.


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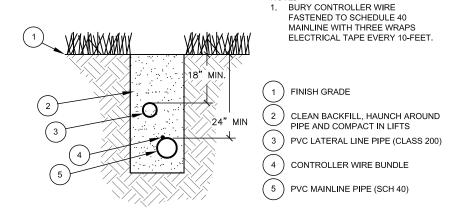
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R. BUDGE

SHEET 21 OF 119


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PVC SCH PIPE INSTALLATION DETAIL (NO SCALE)

(DANGER)

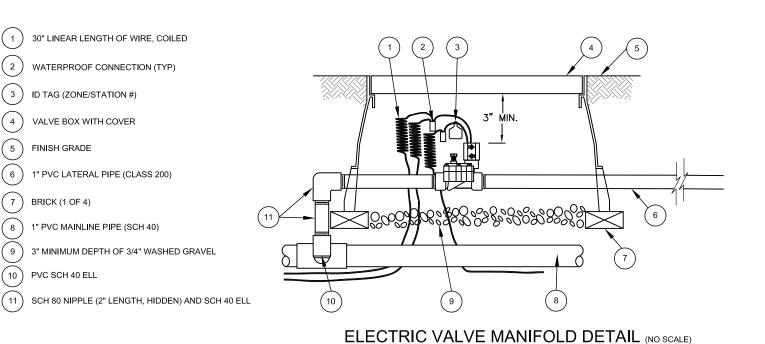

HOSE BIB INSTALLATION DETAIL (NO SCALE)

3/4" GALVANIZED STEEL RISER

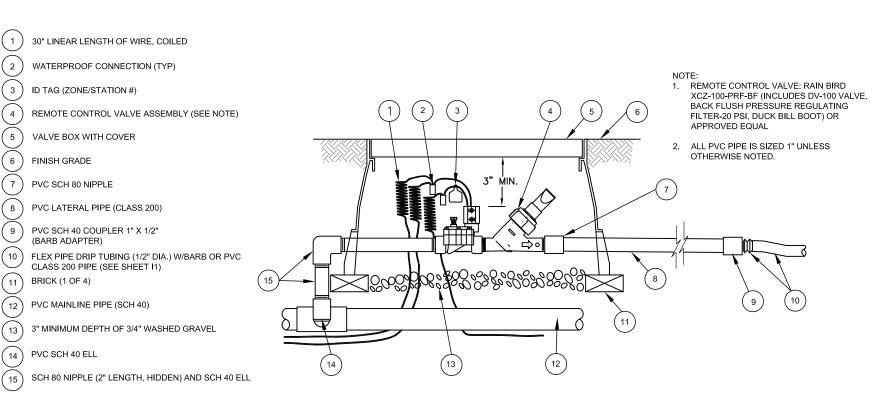(18" ABOVE FINISHED GRADE)

2" X 2" X 12" REDWOOD STAKE

PVC MAINLINE PIPE (SCH. 40)

3/4" PVC SCH. 80 STREET ELL

PER OSHA 1926,51(b)(1) ATTACH

NON-POTABLE WATER SIGN TO ANY HOSE BIB CONNECTED TO

3/4" PVC SCH. 80 NIPPLE

ADJUSTABLE TIE STRAP

3/4" VALVE (BRASS)

IRRIGATION SYSTEM.

(LENGTH AS REQ.)

FINISH GRADE

(3)



s/s Regina Freel 11/29/18 3 2 NO. REVISION / ISSUE

STAMPS, LOGOS, AND SEALS

FLAMING GORGE RANGER DISTRICT **ADDITION**

ASHLEY NATIONAL FOREST

FLAMING GORGE DISTRICT

DRAWING TITLE

IRRIGATION DETAILS

| 03/02/2018 ARCHIV | | NO. | |
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| DESIGNER R.BUDGE | | DRAWING S | HEET NO. |
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| CHECKED D.JEPPSI | ΞN | | |
| PROJECT NO. | | SHEET 22 | OF 119 |

ELECTRIC DRIP VALVE MANIFOLD WITH PRESSURE REDUCTION DETAIL (NO SCALE)

(3)

(4)

(6)

(12)

30" LINEAR LENGTH OF WIRE, COILED

WATERPROOF CONNECTION (TYP)

ID TAG (ZONE/STATION #)

VALVE BOX WITH COVER

PVC LATERAL PIPE (CLASS 200)

PVC SCH 40 COUPLER 1" X 1/2"

PVC MAINLINE PIPE (SCH 40)

(13) 3" MINIMUM DEPTH OF 3/4" WASHED GRAVEL

FINISH GRADE

PVC SCH 80 NIPPLE

(BARB ADAPTER)

(11) BRICK (1 OF 4)

(14) PVC SCH 40 ELL

FLEX PIPE DRIP TUBING, DISTRIBUTION DRIP TUBING AND DRIP EMITTER LAYOUT DETAIL (NO SCALE)

1 VALVE BOX WITH COVER


(2) FINISH GRADE

(3) FLEX PIPE DRIP TUBING (1/2" DIA.)

4) 1/2" STOP / WASTE, BALL VALVE WITH CLASP

3.0-INCH MINIMUM DEPTH OF 3/4-INCH WASHED GRAVEL

6 BRICK (1 OF 4)

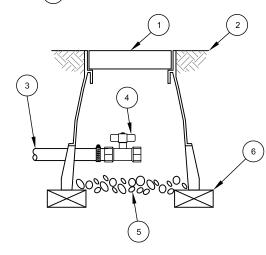

FLUSH VALVE DETAIL (NO SCALE)


1 RAIN BIRD XERI-SPRAY OR DRIP EMITTER (SEE SHEET IR01 TO DETERMINE)

(2) 1/4" TUBING STAKE: TS-025


(3) 1/4" VINYL DISTRIBUTION DRIP TUBING: PT-025

(4) INSERT FITTING: 1/4" BARB CONNECTOR: SPB-025

(5) FLEX PIPE DRIP TUBING (1/2" DIA. POLYETHYLENE)

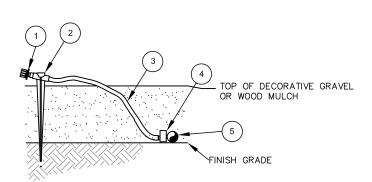


EMITTER DETAIL (NO SCALE)

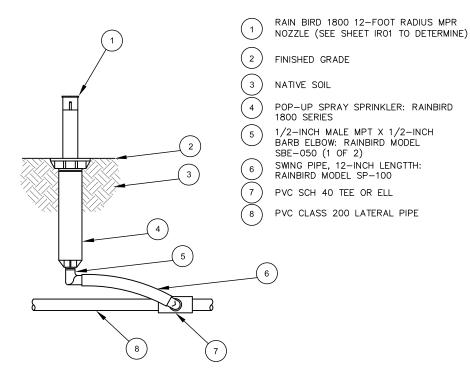

1800 SERIES POP-UP SPRINKLER WITH NOZZLE DETAIL

(NO SCALE)

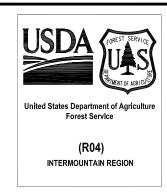

STAMPS, LOGOS, AND SEALS

x/x Regina Freel

11/29/18

2

NO. REVISION/ISSUE DATE

FLAMING GORGE RANGER DISTRICT ADDITION

ASHLEY NATIONAL FOREST

FLAMING GORGE DISTRICT

DRAWING TITLE

IRRIGATION DETAILS CONT'D.

DATE
03/02/2018

DESIGNER
R.BUDGE

DRAWIN
R.BUDGE

CHECKED
D.JEPPSEN

PROJECT NO.


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SHEET 23 OF 119

OILET COMPARTMENT CLEARANCES: AVATORY & ACCESSORY CLEARANCES



15" TO)

17" MIN.

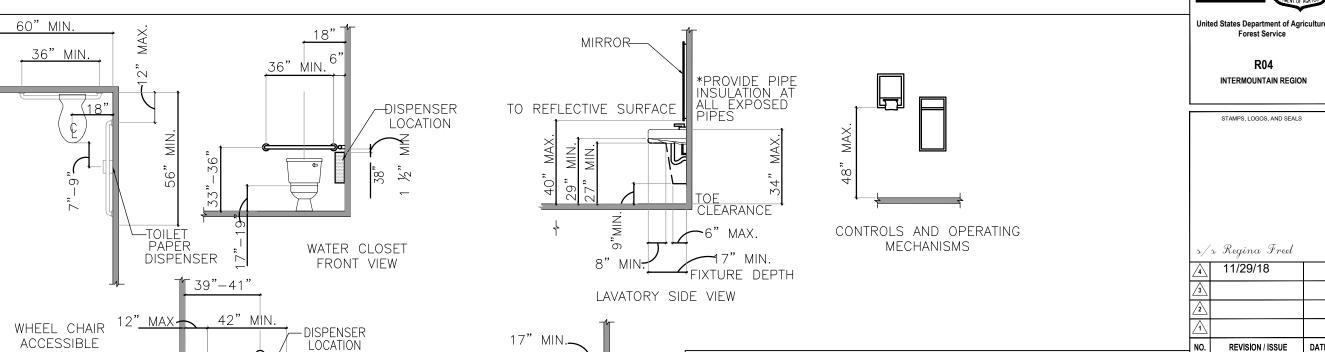19" MAX.


48" MIN.


LAVATORY PLAN VIEW

CLEAR FLOOR SPACE

M N

DOOR AND DOORWAY LEARANCE REQUIREMENTS:

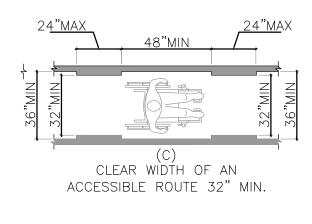

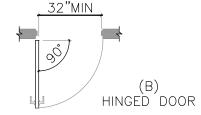

FLAMING GORGE RANGER DISTRICT OFFICE

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INTERMOUNTAIN REGION

STAMPS, LOGOS, AND SEALS

ASHLEY NATIONAL FOREST

FLAMING GORGE RANGER

ACCESSIBILITY STANDARDS

| DATE 11/16/2018 | ARCHIVE NO. |
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| PROJECT NO. | SHEET 24 OF 119 |

CĻÓSETS Jef fer -PARTITION \mathcal{G}_c 9"MIN ÈLEVATION

ACCESSIBLE

WATER

ACCESSIBLE

TOILET STALL PLAN VIEW

BEVELED CHANGE IN LEVEL

WHEELCHAIR ACCESSIBLE TOILET COMPARTMENT TOE CLEARANCE

N N

WATER CLOSET

SIDE VIEW

SHOWER CLEARANCES AND — ACCESSORY HEIGHT REQUIREMENTS:

TRANSFER TYPE
SHOWER COMPARTMENT

22"-23"

SEAT WALL


2-1/2MAX

15"-16"

CONTROL LOCATION

CONTROL LOCATION


L-SHAPED SHOWER SEATS

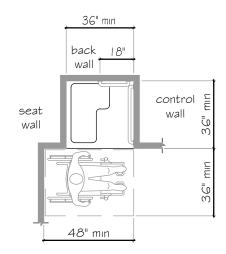

TRANSFER TYPE SHOWER COMPARTMENT SIZE AND CLEARANCE W/ GRAB BARS


TRANSFER TYPE SHOWER CLEARANCES

ELECTRIC WATER COOLER REQUIREMENT

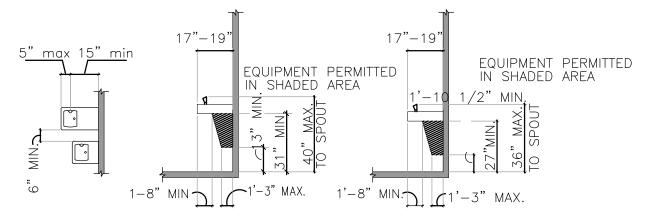


PLAN VIEW NON ADA ELEVATIONS HEIGHTS

DRINKING FOUNTAIN CLEARANCES

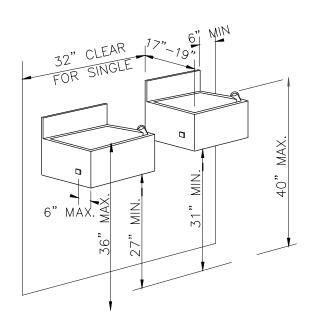

FOUNTAINS

NOTE:
ILLUSTRATIONS SHOWN HERE ARE FOR
DIMENSIONAL ACCESSIBILITY PURPOSES ONLY.
A SECOND DRINKING FOUNTAIN SHOULD BE
PROVIDED AT A MOUNTING HEIGHT AND
CLEARANCES SHOWN.

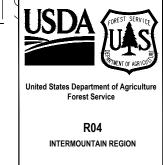

STAMPS, LOGOS, AND SEALS

FLAMING GORGE RANGER DISTRICT OFFICE ADDTION

ASHLEY NATIONAL FOREST


FLAMING GORGE RANGER DISTRICT

DRAWING TITLE

ACCESSIBILITY STANDARDS

| 11/16/2018 | ARCHIVE NO. | |
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| DESIGNER SMHW | ı | DRAWING SHEET NO. |
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| PROJECT NO. | | SHEET 25 OF 119 |

BERANGERDISTRICT.ADDITION.2017\DWG\GA1.01.2.ACCESSIBILITY.L

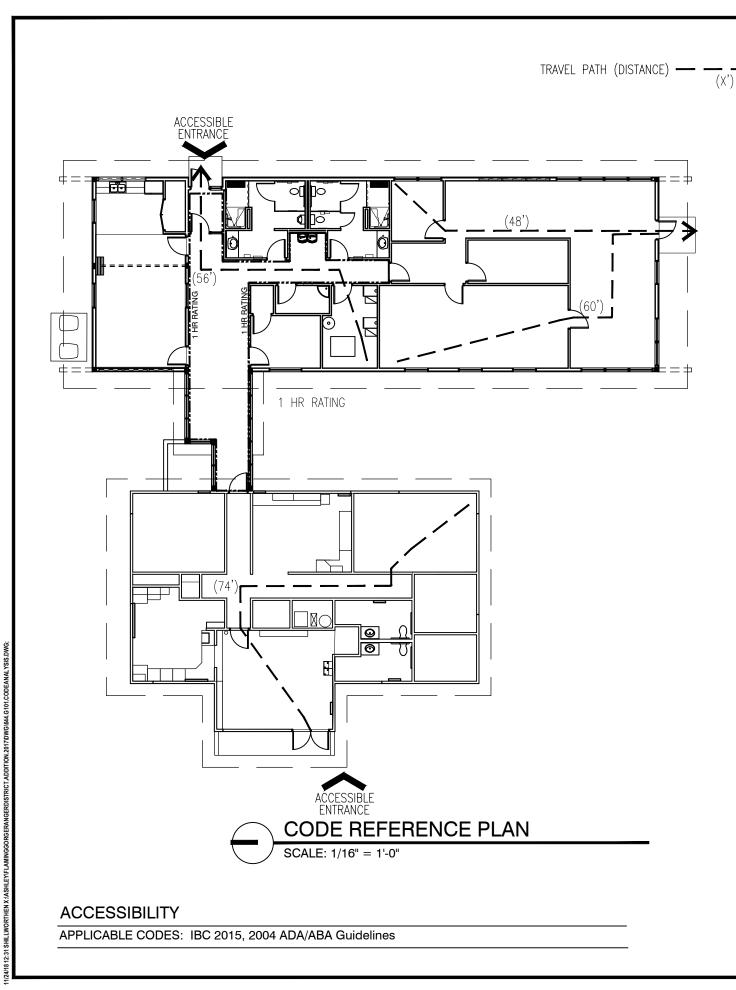

Allowable Area per Floor:

*Area Modifications: Not needed

| CODE SUMMARY: | | | |
|---|--------------------------------------|--|----------------------|
| APPLICABLE CODES: | | | |
| International Building Code International Mechanical Code International Fuel Gas Code International Plumbing Code International Fire Code | 2015 2015 2015 2015 2015 | National Electrical Code ANSI/ASHRAE/IESNA Standard 90.1-2010 International Energy Conservation Code | 2017 2010 2015 |
| Occupancies Group - IBC ChaType of Construction - IBC TABSprinklers: Required: NO Providence | BLE 601: V- | Mixed Occupance B 3. Occupancy Se Type of Sprinkler Syst | paration: N/A |
| Manila Ground Snow Load: Manila Elevation above sea lev NOTE: See Structural Drawing | 100 PSF rel: 6348 ft | Wind Speed: 115 mph, e Manila Frost Depth: 36 sign Criteria | |
| Number of Stories: 1 Stor | у | Building Height: 13'-9" | |
| Δctual Δrea per Floor: | 3 401 ± 2025 = F | 5516 GSE | |

8. Design Occupant Load: 59 (Actual Max Occupant Load, both structures) 9. Exit Width Required (TABLE 1005.3.2): 12" (.2/occ.) Exit Width Provided: 132" 2 EXITS AT 36", 1 EXITS AT 60" Min. Door Width - Sec. 1010.1.1 32" Minimum Corridor Width - Sec. 1020.2: Exit Separation -Sec. 1007.1.1: 1/2 *diag. Dead End Corridor - Sec. 1020.4: 20' max. Provided: 3 Number of Exits Required SEC 10007: 2

9,000 GSF per IBC TABLE 506.2

10. Plumbing Fixture Requirements (IBC TABLE 2902.1): 59 occ. = 28 male, 28 female a) Water Closets - Required(m) 2 Provided (m) <u>3</u> (f) <u>3</u> b) Lavatories - Required (m) 2 (f) 2 Provided (m) 2 (f) 2 a) Bath Tubs or Showers: 2 provided a) Drinking Fountains: 2 provided Service Sinks: 1 provided

11. Fire Resistance Rating: VB construction Requirements for the Exterior Walls based on the fire separation distance (in hours) -IBC Chapter 6: North: 0 South: 0 East: 0 West: 0

| Element | Hrs | Element | Hrs |
|----------------------------|-----|--|-----|
| Exterior Bearing Walls | 0 | Floors - Ceiling Floors | 0 |
| Interior Bearing Walls | 0 | Roofs - Ceiling Roofs | 0 |
| Exterior Non-Bearing Walls | 0 | Exterior Doors & Windows | 0 |
| Structural Frame | 0 | Corridor (Fire Partitions) -TABLE 1020.1 | 1 |
| Partitions - Permanent | 0 | Corridor Doors - TABLE 716.5 | 1/3 |
| | | Corridor Windows - TABLE 716.5* | 1/3 |
| | | *Max. Window Area < 25% of WALL | 3 |

Interior Finishes Class (fire spread): A = Exit Enclosures / Passageways Based on IBC TABLE 803.11 (for Non- B = Corridors

Minimum Roof Covering Fire Classification - IBC TABLE 1505.1: C (Const. Type V-B)

The addition has a code occupant load of 44. (21 people in 2,030 SF of office (100 SF/ person) and and 23 people in the 340 SF conference room (15 SF/ person). According to IBC Table 1020.1, the corridor requires a 1 hour fire rating.



INTERMOUNTAIN REGION

| | STAMPS, LOGOS, AND SEALS | 3 |
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| <u>4</u> <u>3</u> | | |
| <u>4</u> <u>3</u> | | |

FLAMING GORGE RANGER DISTRICT

OFFICE ADDITION

PROJECT NAME


ASHLEY NATIONAL FOREST


FLAMING GORGE RANGER DISTRICT


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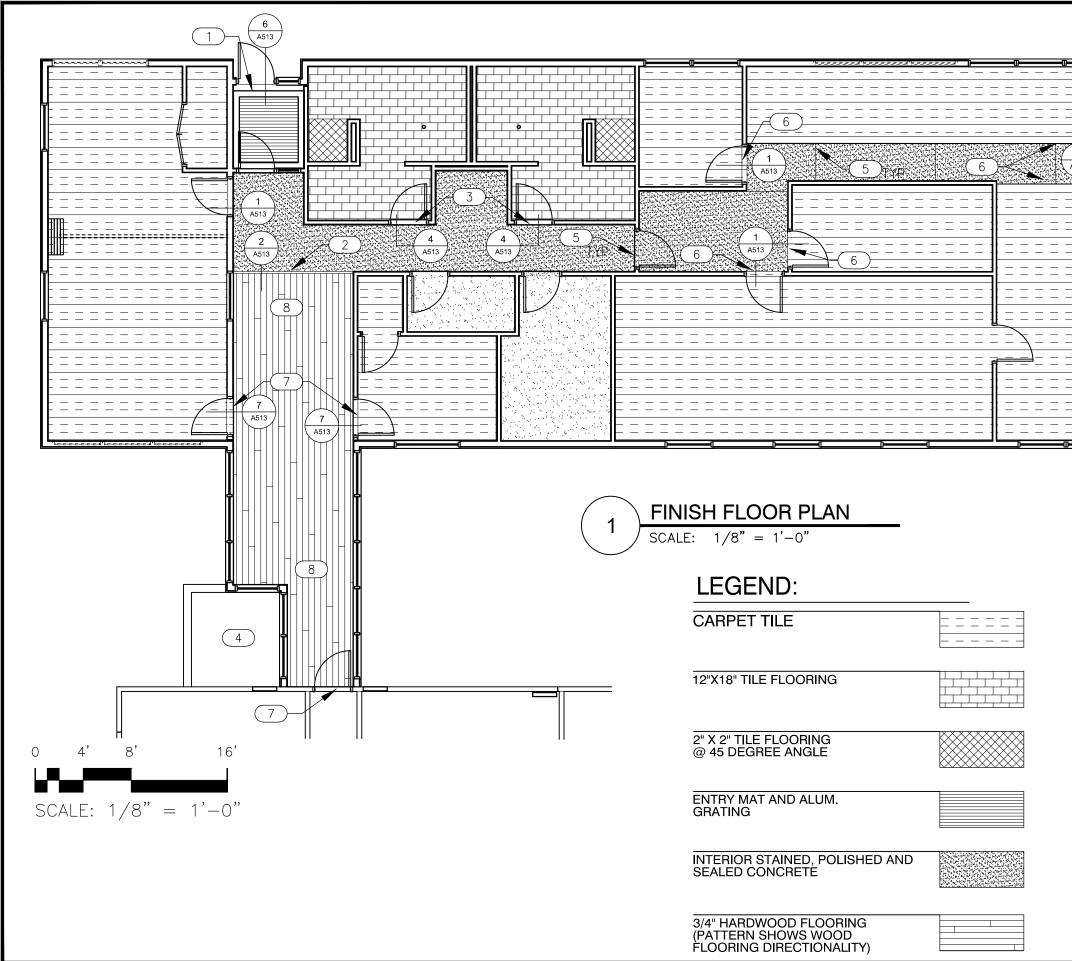
CODE ANALYSIS

| DATE 11/16/2018 | ARCHIV | E NO. | |
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| D. JEPPS | EN | | |
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| | STAMPS, LOGOS, AND SEALS | |
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FLAMING GORGE
RANGER
DISTRICT OFFICE
ADDITION

ASHLEY NATIONAL FOREST

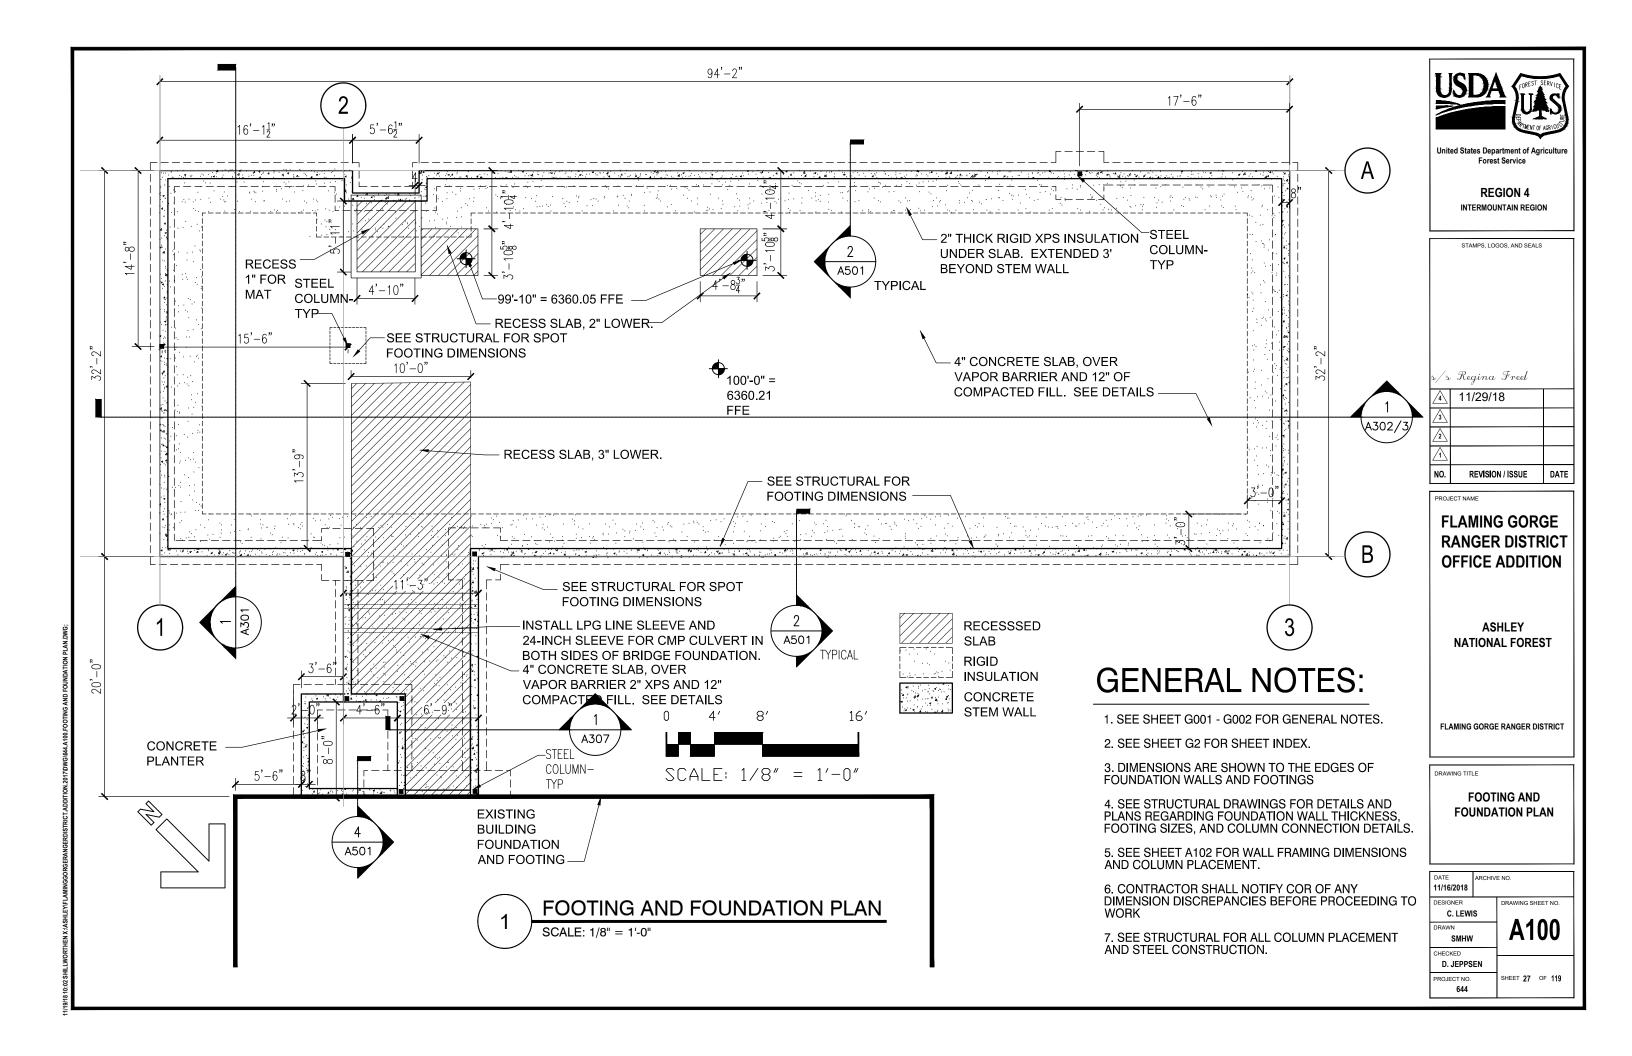FINISHED FLOOR PLAN

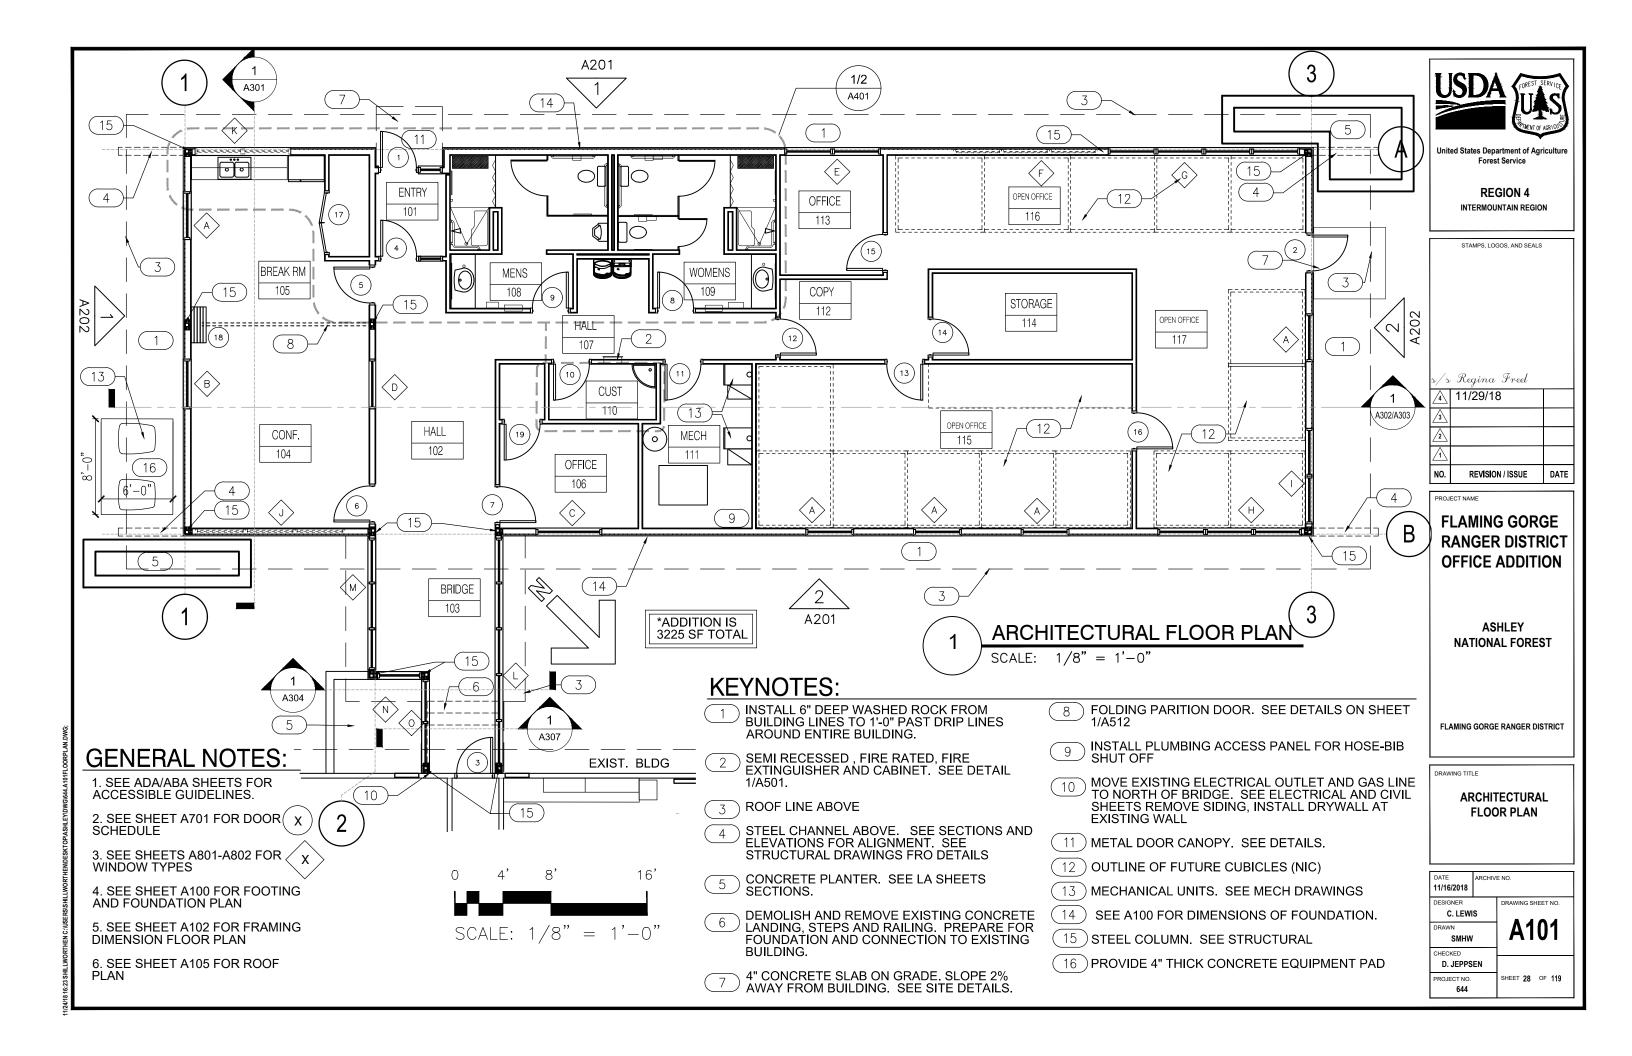
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| | | | |

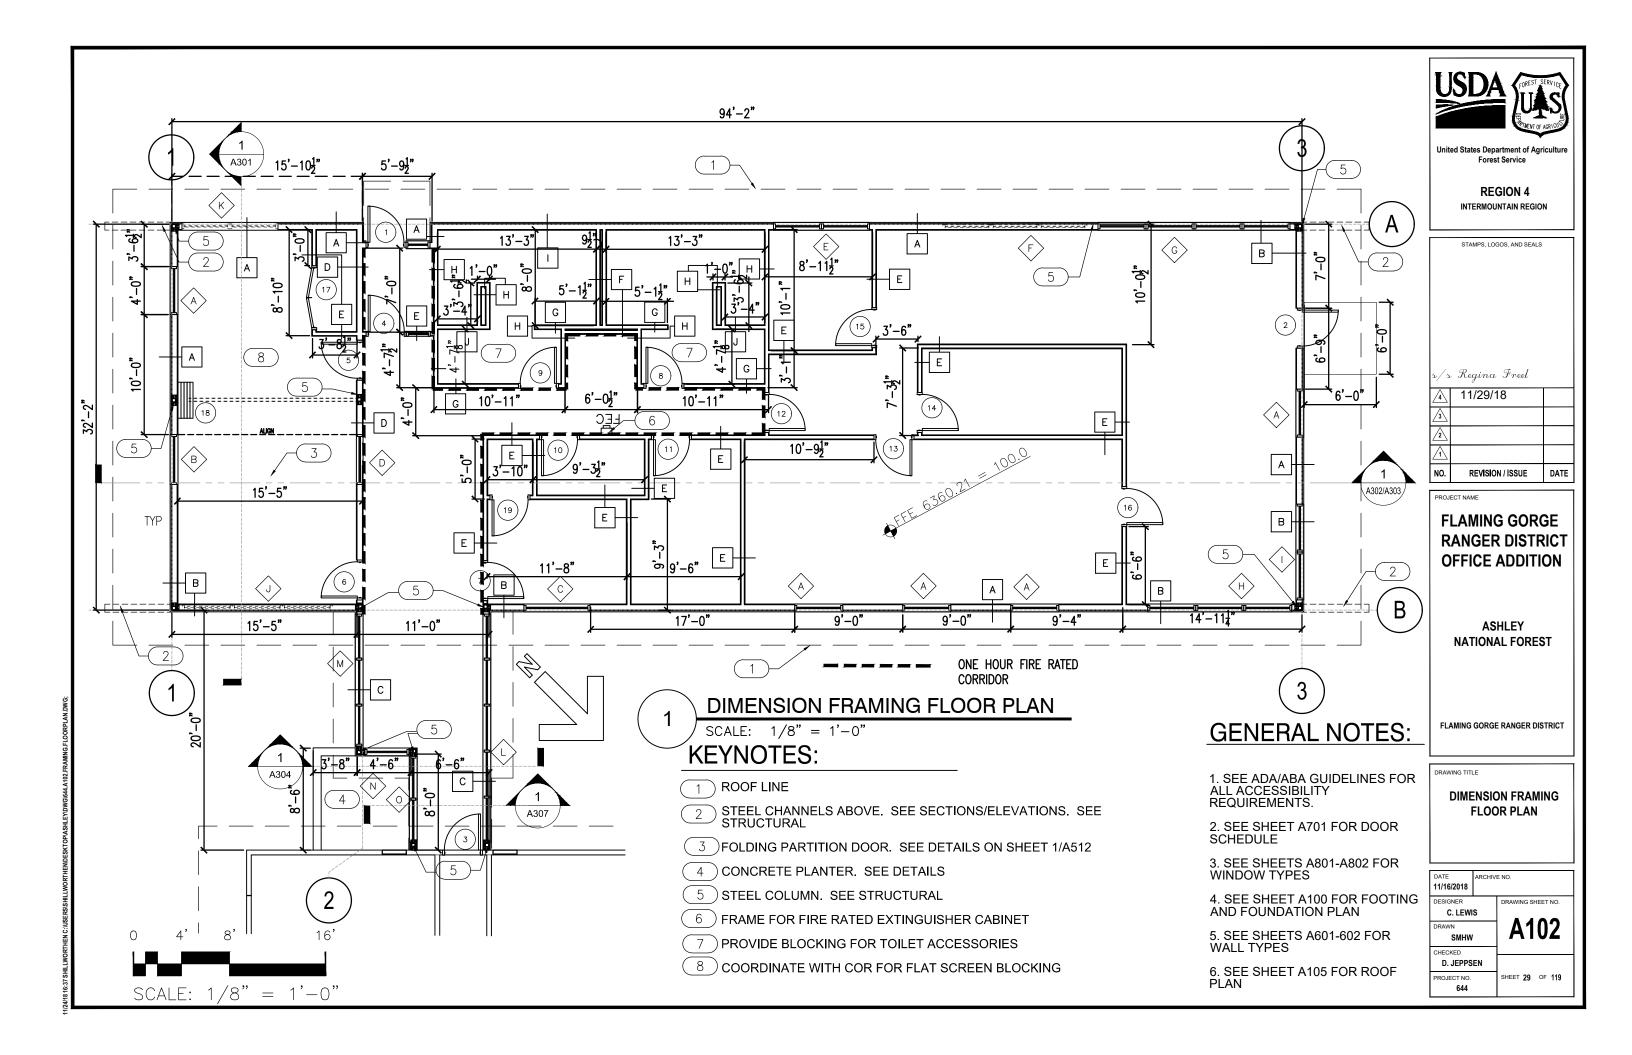1 METAL THRESHOLD. SEE DETAIL INDICATED ON PLAN.

A513

- CONCRETE TO WOOD TRANSITION. SEE DETAIL INDICATED ON PLAN.
- 3 CONCRETE TO TILE TRANSITION. SEE DETAIL INDICATED ON PLAN.
- 4 EXTERIOR PLANTER.
- 5 CONCRETE CONSTRUCTION JOINT. SEE STRUCTURAL
- 6 RUBBER CARPET THRESHOLD. SEE DETAIL INDICATED ON PLAN.
- 7 CARPET TO WOOD TRANSITION. SEE DETAIL INDICATED ON PLAN.
- 8 WOOD FLOOR OVER VAPOR BARRIER, TREATED SLEEPERS AND 3" T&G PLYWOOD. SEE SPEC & TRANSITION DETAIL FOR INFORMATION

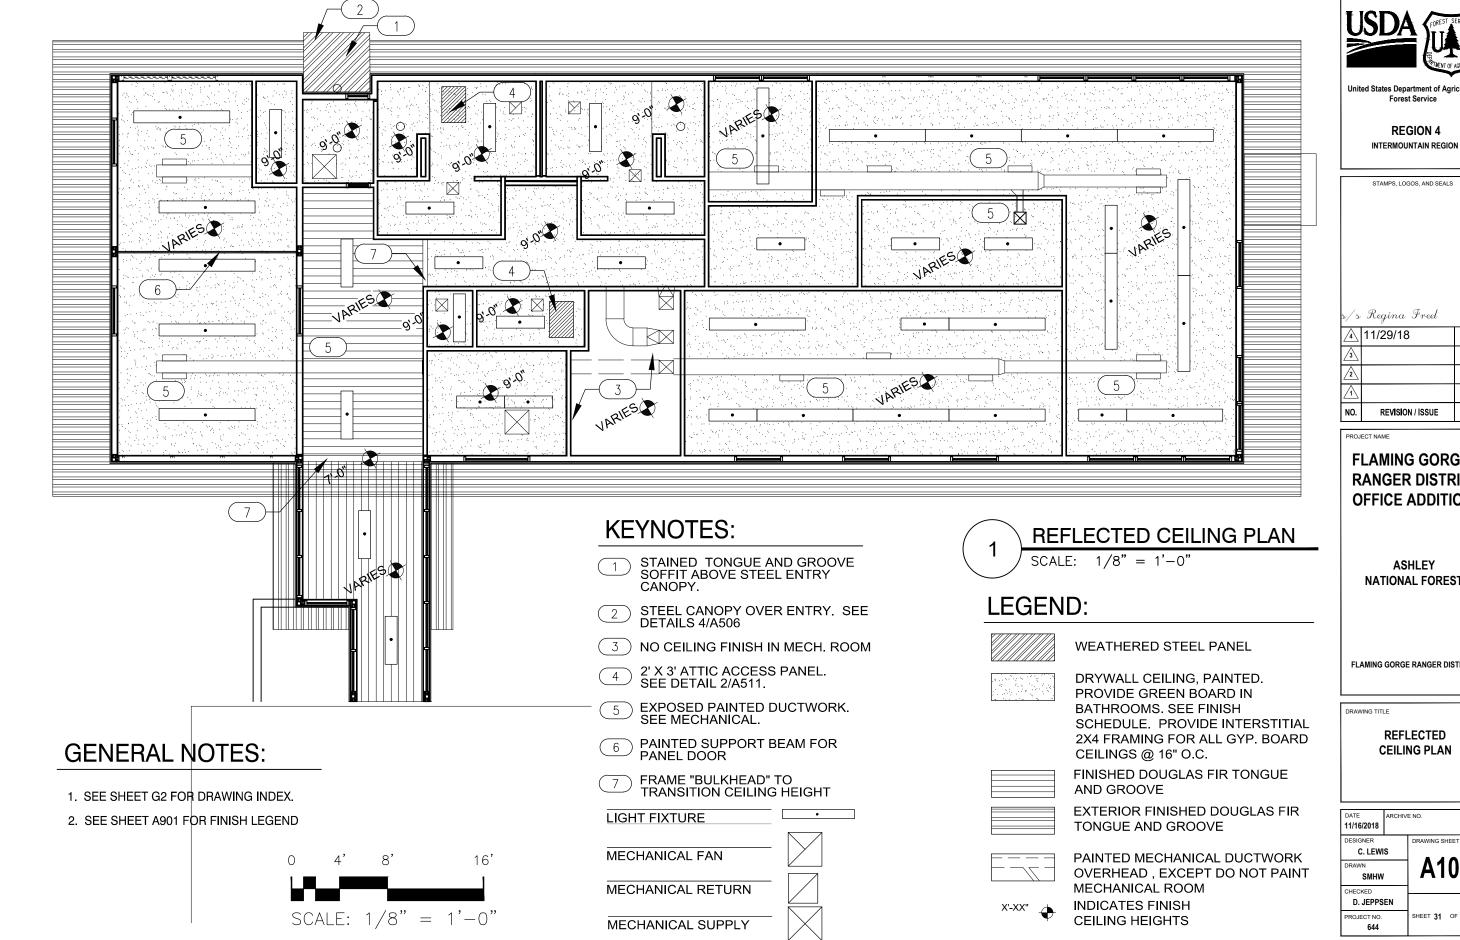

United States Department of Agriculture Forest Service

REGION 4

STAMPS, LOGOS, AND SEALS /s Regina Freel 11/29/18 DATE REVISION / ISSUE

PROJECT NAME

FLAMING GORGE RANGER DISTRICT **OFFICE ADDITION**


ASHLEY NATIONAL FOREST


FLAMING GORGE RANGER DISTRICT


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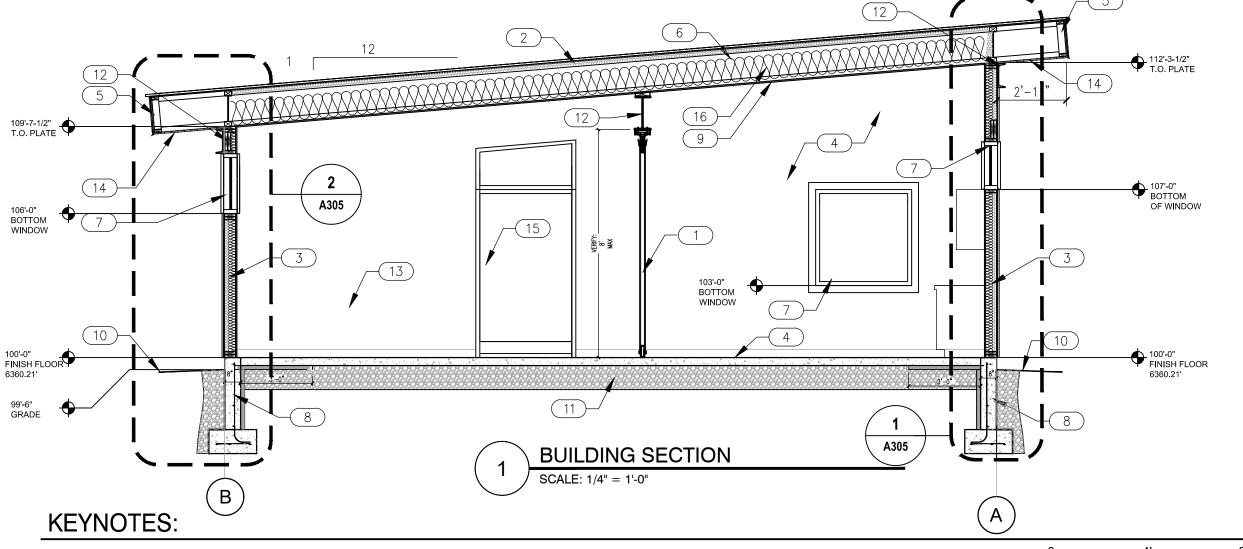
REFLECTED **CEILING PLAN**

ARCHIVE NO. 11/16/2018 DRAWING SHEET NO. C. LEWIS A104 SMHW HECKED D. JEPPSEN SHEET 31 OF 119 644



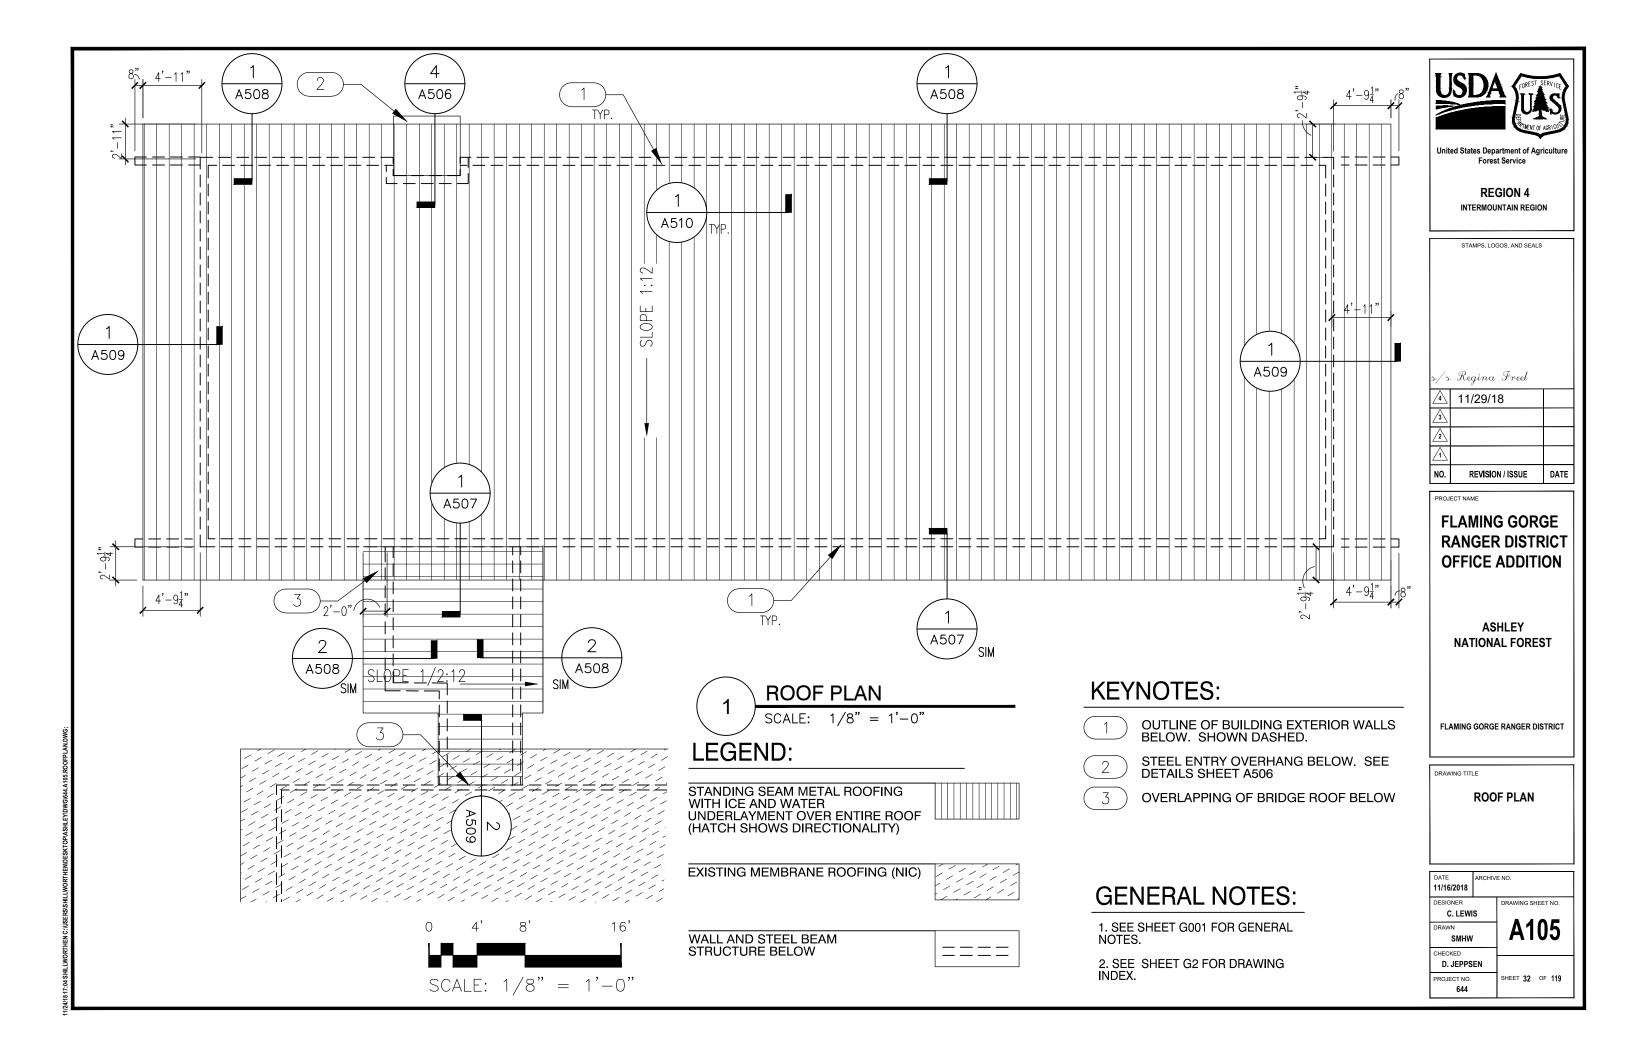


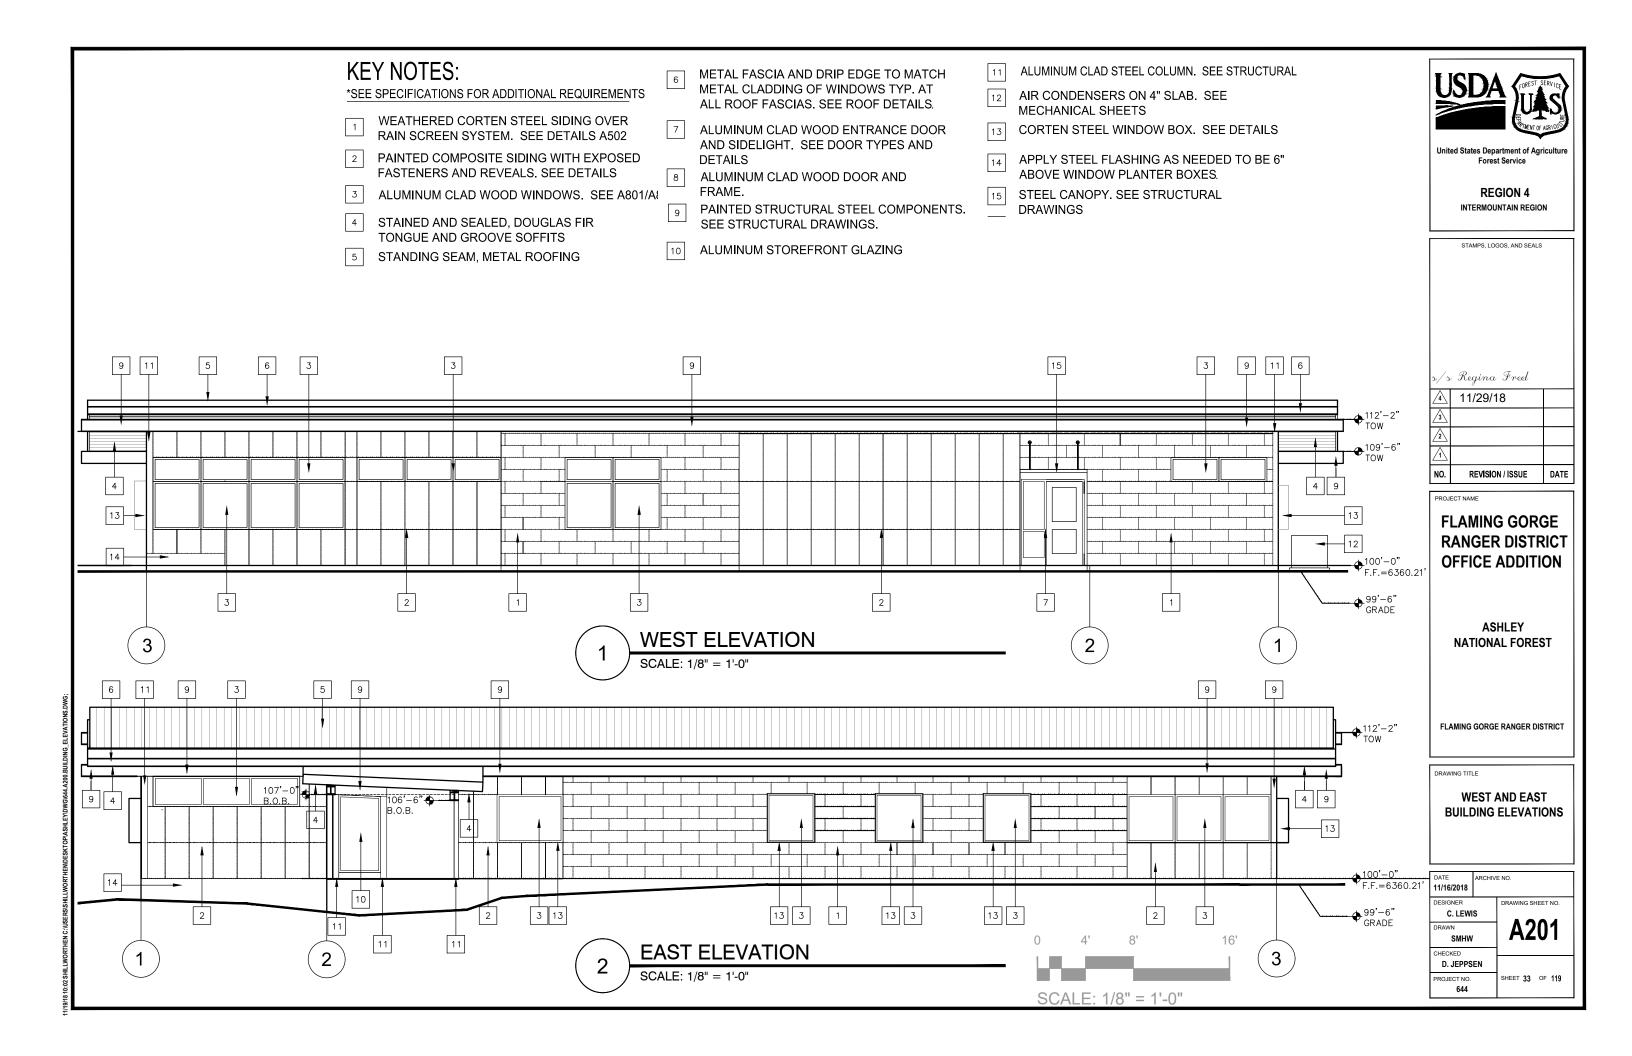

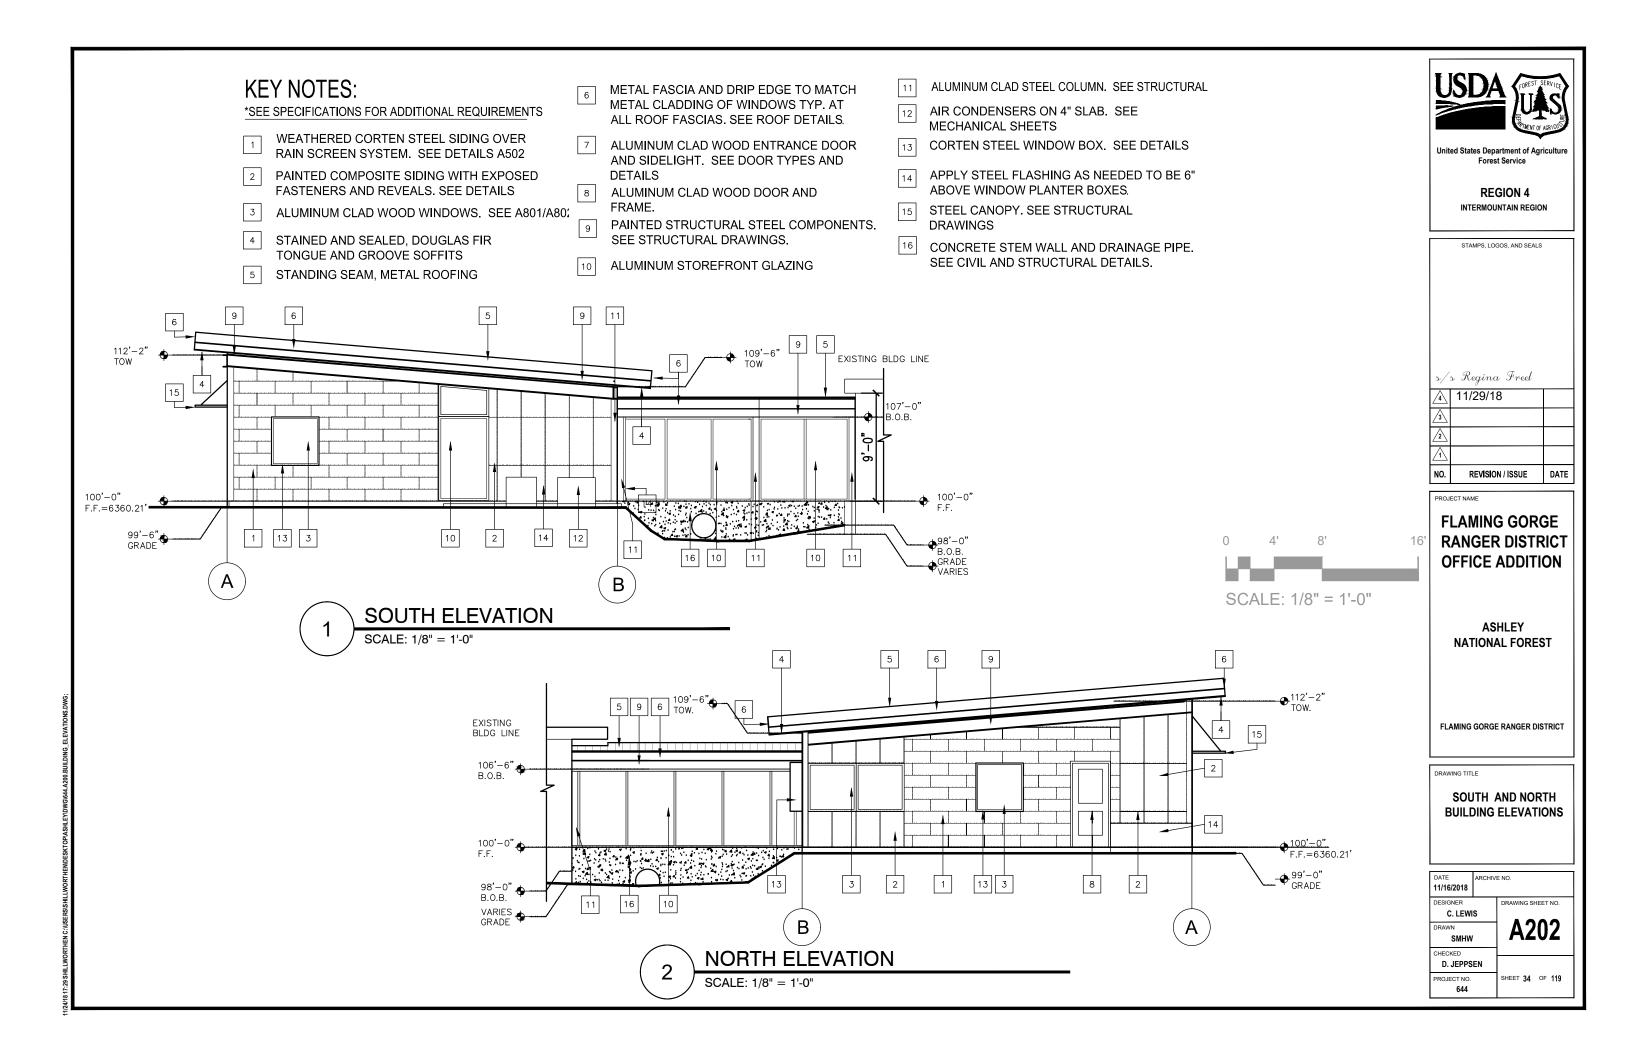

- 1 ACOUSTICAL PARTITION DOOR. SEE SPECIFICATIONS.
- 2 STANDING SEAM STEEL ROOFING OVER ICE AND WATER SHIELD TO COVER ENTIRE ROOF. SEE ROOF DETAIL SHEETS AND ROOF PLAN (A105) FOR ADDITIONAL INFORMATION.
- 2X6 EXTERIOR STUD WALL 2" THICK HIGH DENSITY SPRAY FOAM, 3 ½" BLOWN IN FIBERGLASS BLANKET, EXTERIOR SHEATHING, BUILDING WRAP, 1 X FURRING WITH WEATHERING STEEL OR COMPOSITE PANEL SIDING. SEE ELEVATIONS, DETAILS AND SPECS
- (4) BASE/ FLOORING MATERIAL. SEE FINISH PLAN
- 5 2 X FRAMING, 16" OC, SHEATHING, PREFINISHED METAL, DRIP EDGE AND METAL FASCIA. SEE ROOF DETAILS.
- 6 TJI JOISTS. SEE STRUCTURAL
- 7 ALUMINUM CLAD WOOD WINDOW, TRIM. SEE WINDOW ELEVATIONS AND DETAILS.
- 8 CONCRETE FOOTING AND FOUNDATION. SEE DETAILS AND STRUCTURAL DRAWINGS.

- 9 PAINTED GYPSUM BOARD CEILING. SEE REFLECTED CEILING PLAN.
- EXTERIOR FINISH GRADE SHALL BE SLOPED MIN. 2% AWAY FROM BLDG AND START 6" BELOW TOP OF FOUNDATION WALL. SEE CIVIL PLANS FOR ALL GRADING ELEVATIONS.
- 4" CONCRETE SLAB, VAPOR BARRIER, 3' WIDTH OF 2" RIGID INSULATION AT PERIMETER AND STEM WALL, OVER 12" DEEP CLEAN FREE-DRAINING COMPACTED GRAVEL.
- 12 PAINTED STEEL CHANNEL. SEE STRUCTURAL DRAWINGS
- 13 PAINTED GYPSUM BOARD AT WALLS.
- 3/4" DOUG-FIR TONGUE AND GROOVE SOFFIT WITH METAL TRIM. SEE ROOF DETAILS
- 15) ALUMINUM STOREFRONT WINDOW SYSTEM
- 2" OF CLOSED-CELL, HIGH-DENSITY SPRAY FOAM INSULATION AND 12" DEPTH BLOWN IN BLANKET INSULATION.

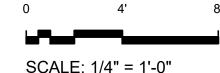

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REGION 4
INTERMOUNTAIN REGION

| Regina Freel | |
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FLAMING GORGE RANGER DISTRICT OFFICE ADDITION


ASHLEY
NATIONAL FOREST


FLAMING GORGE RANGER DISTRICT

DRAWING TITLE

BUILDING SECTION

| DATE 11/16/2018 | ARCHIV | E NO. |
|---------------------|--------|-------------------|
| DESIGNER C. LEWI | S | DRAWING SHEET NO. |
| DRAWN SMHW | | A301 |
| CHECKED D. JEPPSEN | | |
| PROJECT NO. 644 | | SHEET 35 OF 119 |

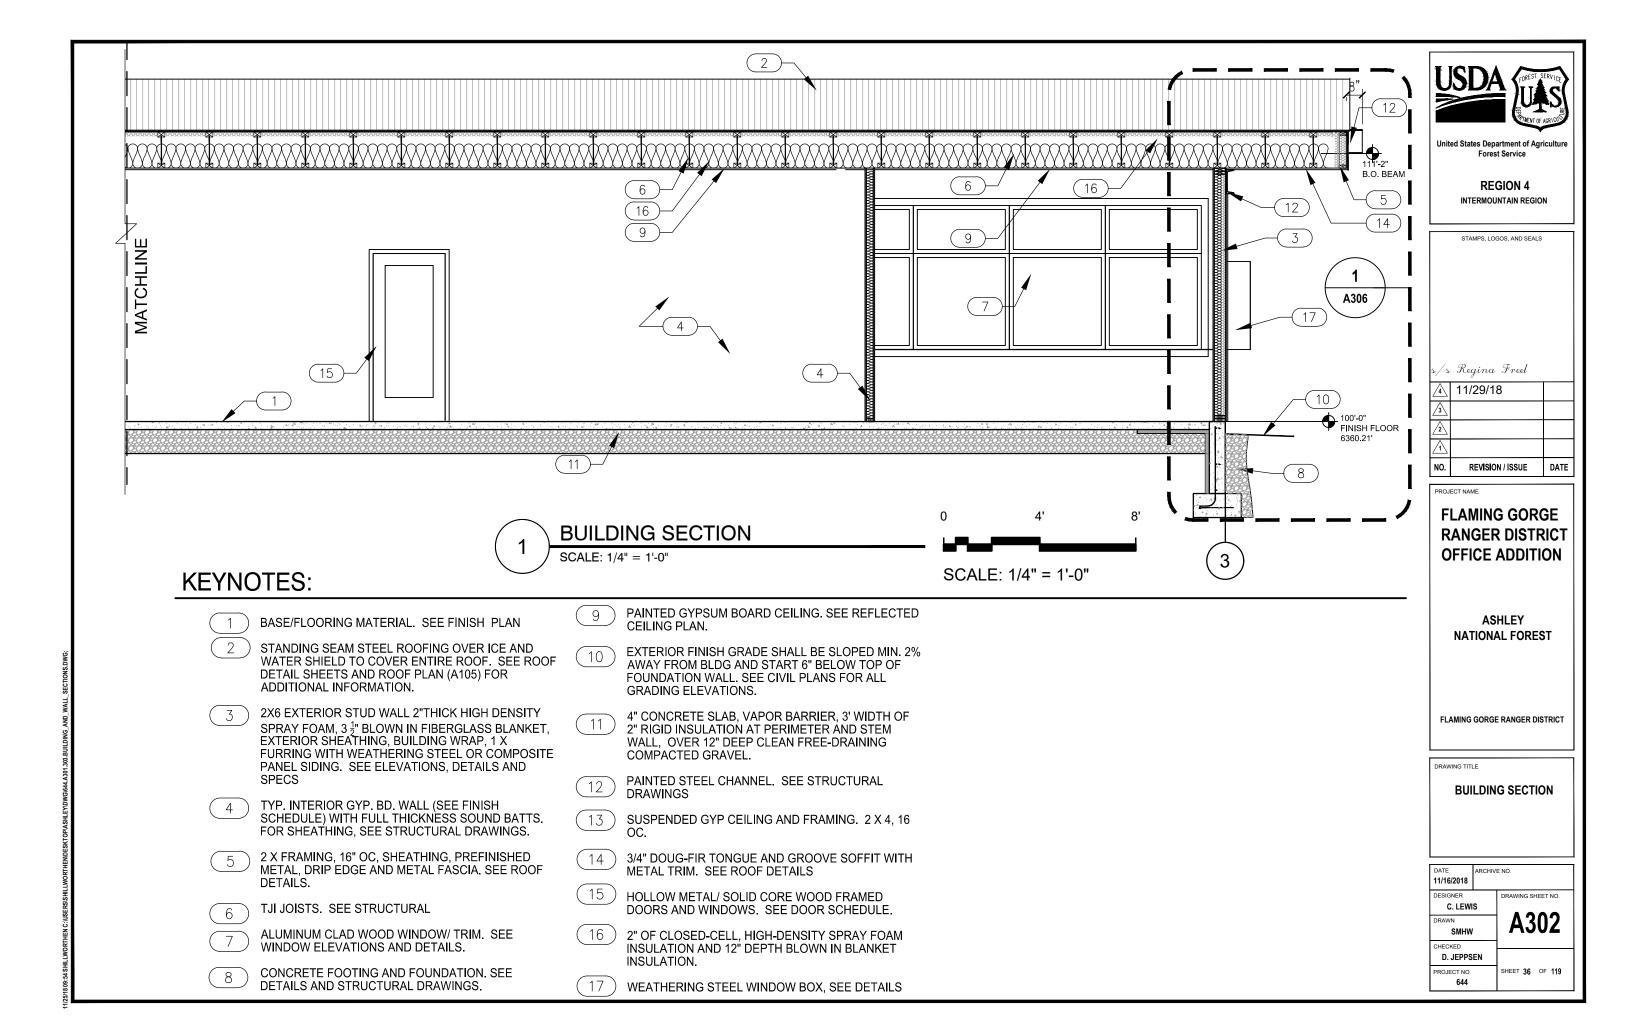

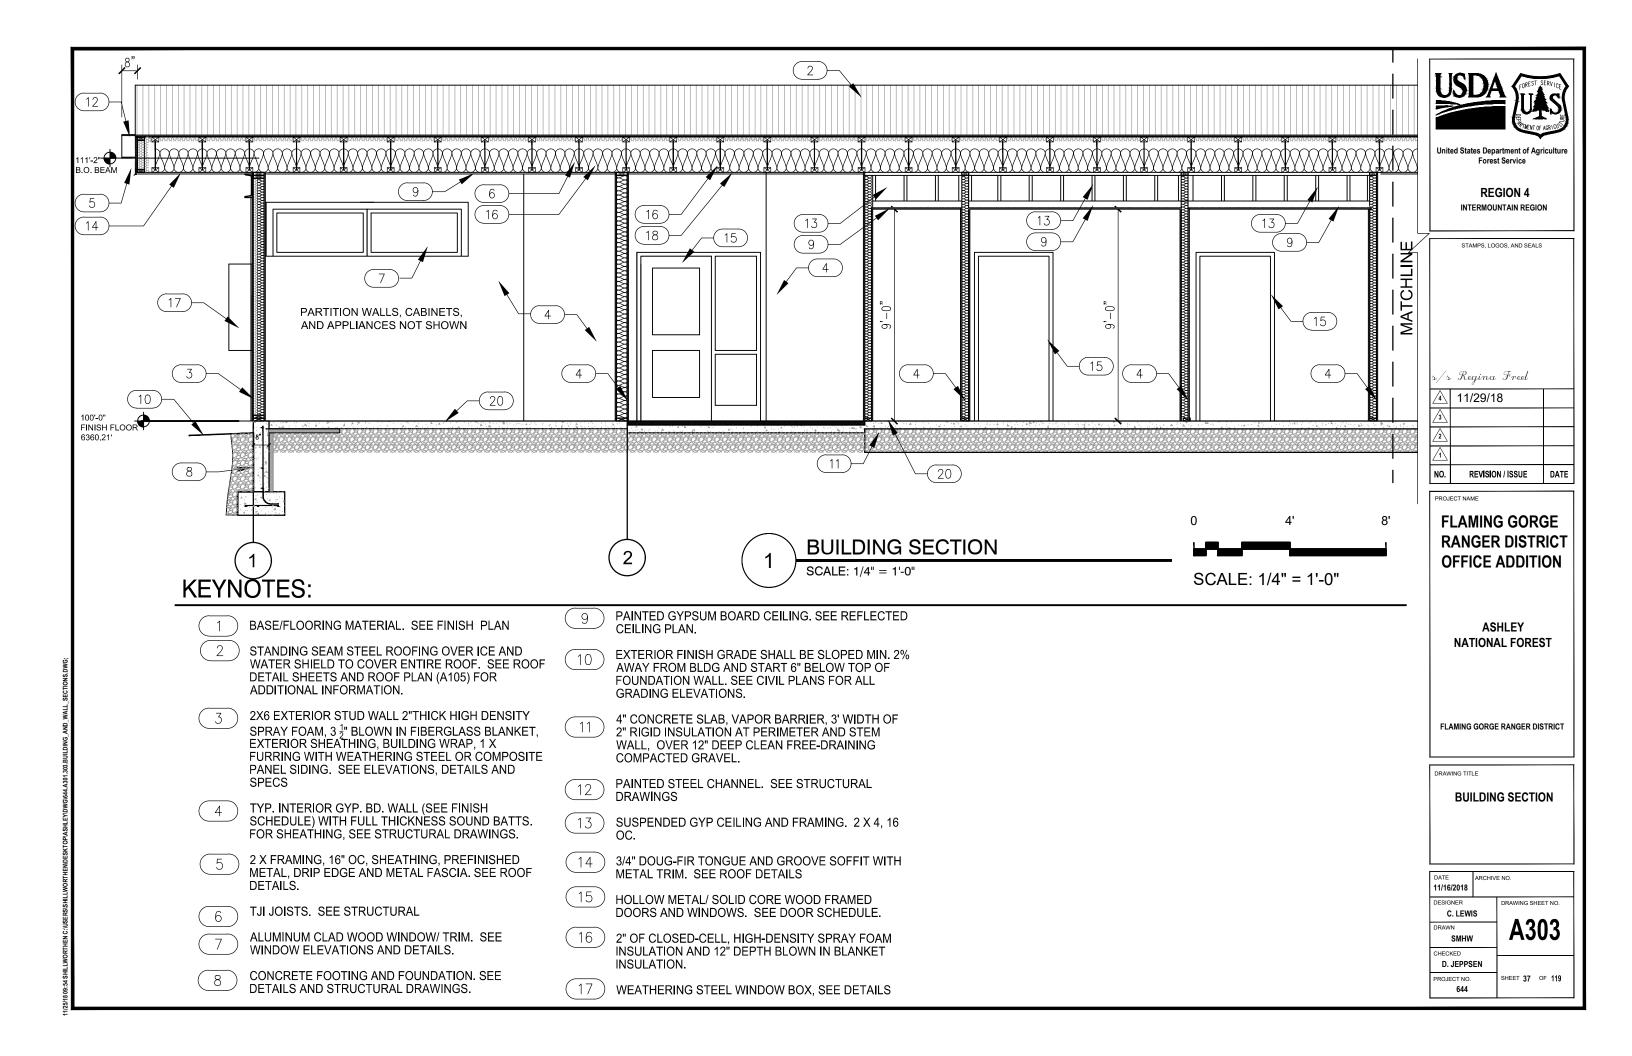

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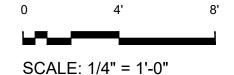
BUILDING SECTION

SCALE: 1/4" = 1'-0"

KEYNOTES:

- STANDING SEAM STEEL ROOFING OVER ICE AND WATER SHIELD TO COVER ENTIRE ROOF. SEE ROOF DETAIL SHEETS AND ROOF PLAN (A105) FOR ADDITIONAL INFORMATION.
- 2 TJI JOISTS. SEE STRUCTURAL.
- CONCRETE FOOTING AND FOUNDATION. SEE DETAILS AND STRUCTURAL DRAWINGS.
- 4 EXTERIOR FINISH GRADE SHALL BE SLOPED MIN. 2% AWAY FROM BLDG AND START A MINIMUM OF 6" BELOW TOP OF FOUNDATION WALL. SEE CIVIL PLANS FOR ALL GRADING ELEVATIONS.
- 4" CONCRETE SLAB, OVER VAPOR BARRIER, 2" RIGID INSULATION, RECESSED, WOOD FLOOR
- 6 PAINTED STEEL BEAM. WELD/COPE CORNER JOINT FOR WATERTIGHT ASSEMBLY. SEE STRUCTURAL.
- 7 3/4" DOUG-FIR TONGUE AND GROOVE SOFFIT. SEE ROOF DETAILS
- 2" OF CLOSED-CELL, HIGH-DENSITY SPRAY FOAM INSULATION AND 8" DEPTH BLOWN IN BLANKET INSULATION.

- $\frac{3}{4}$ " DOUG-FIR TONGUE AND GROOVE CEILING FINISH. SEE FINISH DETAILS.
- CONCRETE FOOTINGS AND FOUNDATION WALLS.
 PLANTER BOX LINED WITH WATERPROOF
 MEMBRANE. SEE PLANTER DETAIL 4/A501. SEE
 LANDSCAPE SHEETS FOR PLANTINGS. PLANTING
 MEDIA, 12" WASHED ROCK, NATIVE SOIL
- (12) ALUMINUM CLAD STEEL COLUMN. SEE STRUCTURAL





United States Department of Agriculture Forest Service

REGION 4
INTERMOUNTAIN REGION

STAMPS, LOGOS, AND SEALS

s/s Regina Freel

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PROJECT NAME

FLAMING GORGE RANGER DISTRICT OFFICE ADDITION


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NATIONAL FOREST

FLAMING GORGE RANGER DISTRICT

DRAWING TITLE

BUILDING SECTION

| 11/16/2018 | ARCHIVE NO. | |
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| DESIGNER C. LEWI | s | DRAWING SHEET NO. |
| DRAWN SMHW | 1 | A304 |
| D. JEPPS | EN | |
| PROJECT NO. 644 | | SHEET 38 OF 119 |

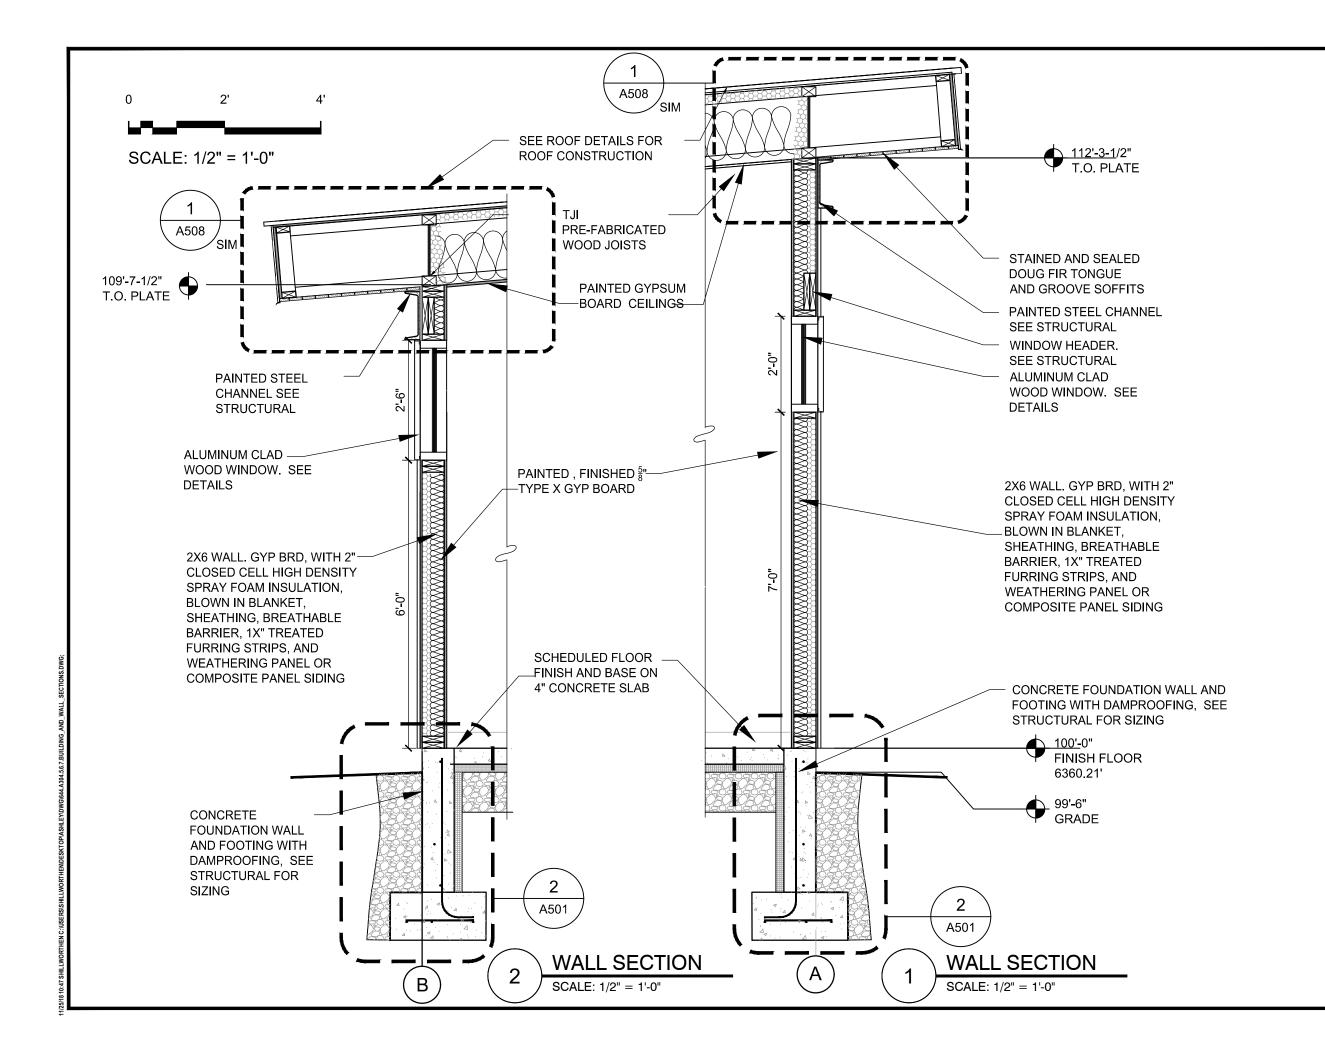



REGION 4
INTERMOUNTAIN REGION

STAMPS, LOGOS, AND SEALS

x/s Regina Freel

11/29/18

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NO. REVISION/ISSUE DATE

PROJECT NAME

FLAMING GORGE RANGER DISTRICT OFFICE ADDITION


ASHLEY
NATIONAL FOREST


FLAMING GORGE RANGER DISTRICT

DRAWING TITLE

WALL SECTIONS

| 11/16/2018 | ARCHIV | E NO. | |
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| PROJECT NO. 644 | | SHEET 39 OF 119 | |

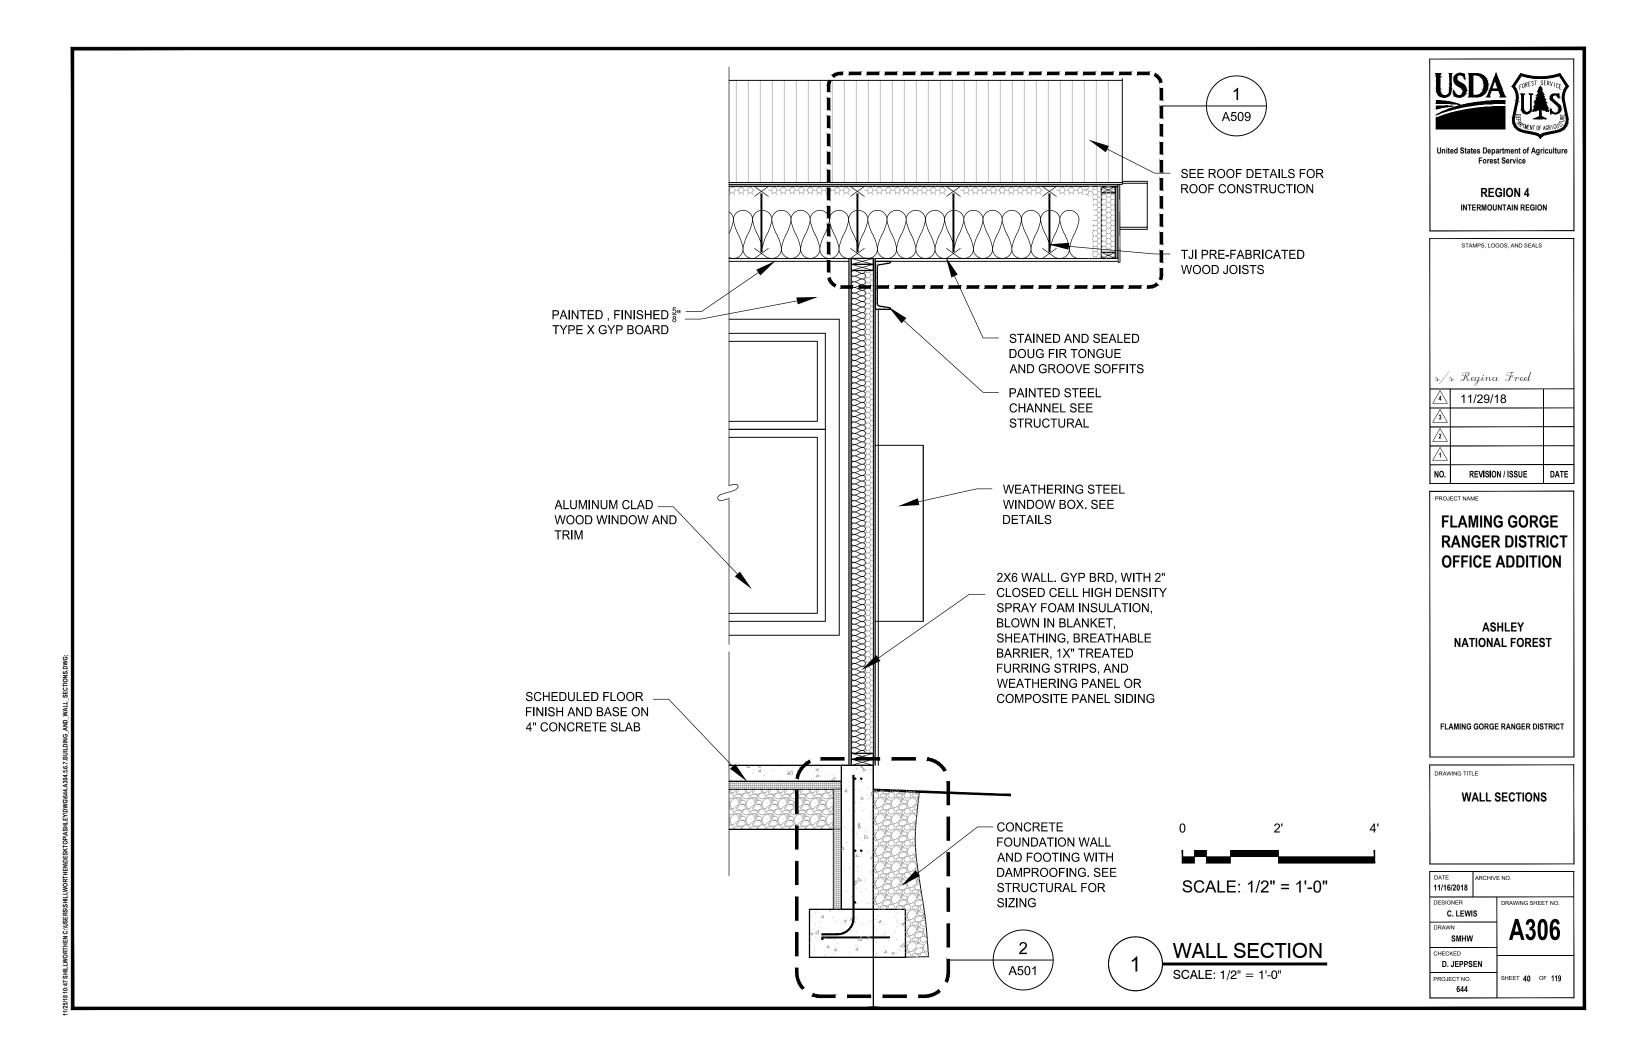

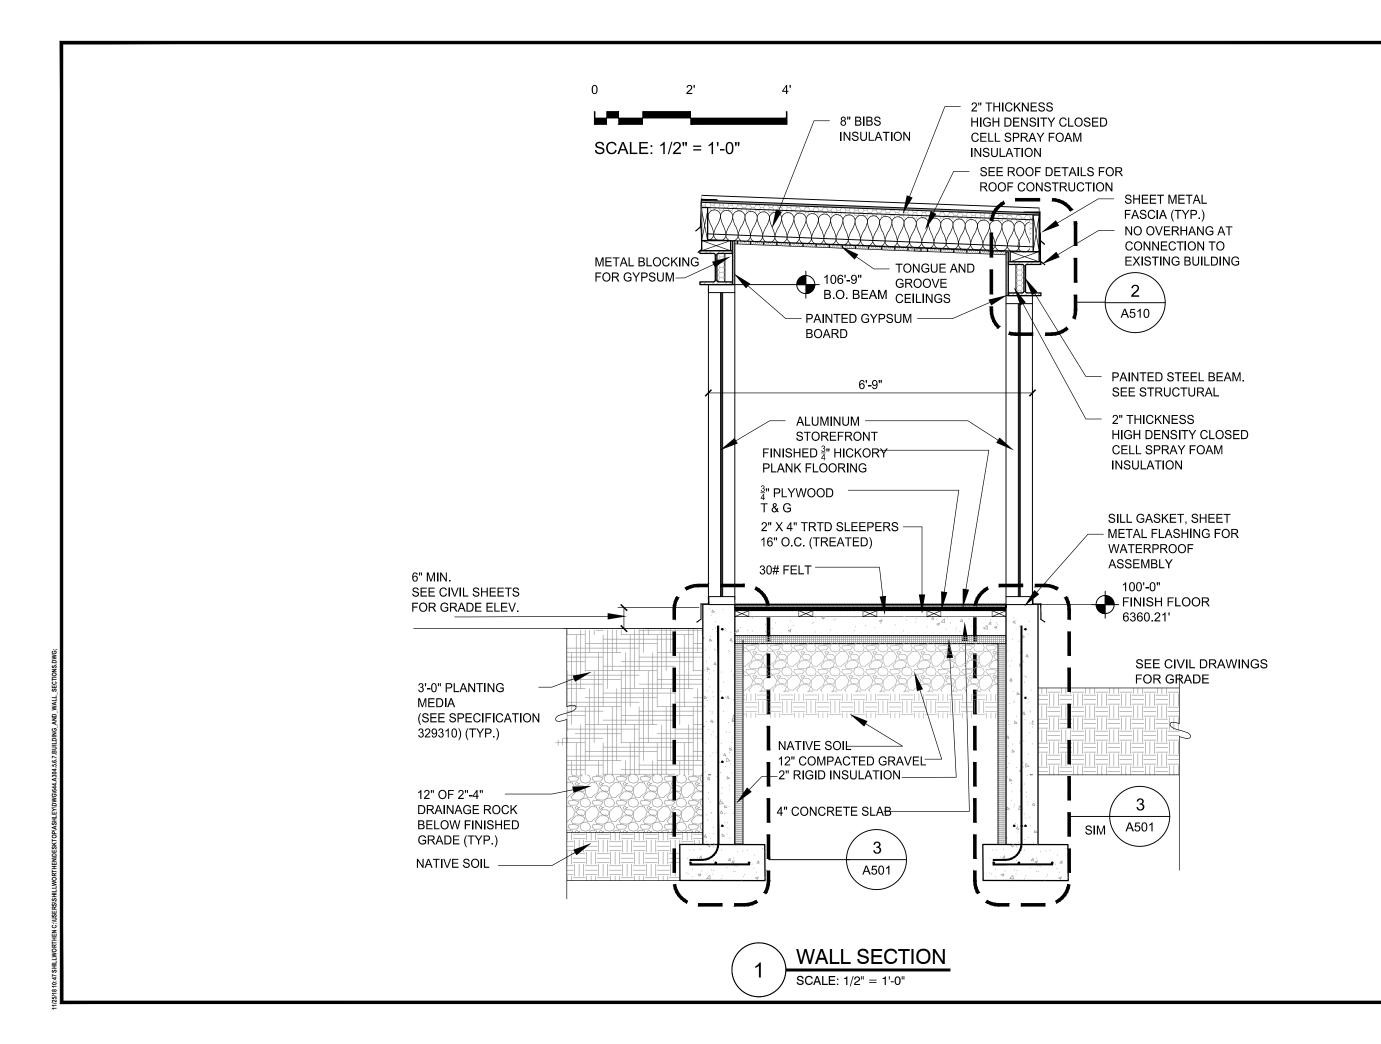



INTERMOUNTAIN REGION

STAMPS, LOGOS, AND SEALS

S/S Regina Freel

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NO. REVISION/ISSUE DATE

FLAMING GORGE RANGER DISTRICT OFFICE ADDITION

PROJECT NAME

ASHLEY
NATIONAL FOREST

FLAMING GORGE RANGER DISTRICT

DRAWING TITLE

WALL SECTIONS

| DATE 11/16/2018 | ARCHIV | E NO. | |
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| DESIGNER C. LEWI | s | DRAWING S | |
| DRAWN SMHW | | A3 | 807 |
| CHECKED D. JEPPS | EN | | |
| PROJECT NO. 644 | | SHEET 41 | OF 119 |


- FRP WALL PANEL to 48" W/6" RUBBER BASE. SEE FINISH SCHEDULE.
- SHOWER WITH CERAMIC TILE WALLS & FLOOR. SEE PLUMBING DRAWINGS. SEE A903 FOR **ACCESSORIES**
- FOLD DOWN PHENOLIC SHOWER SEAT. SEE A903 ACCESSORY SCHEDULE.
- CEILING AND FLOOR MOUNTED LAMINATE 4 FACED TOILET PARTITION WALLS. SEE SPEC
- CERAMIC WALL TILE, SEE FINISH SCHEDULE. SEE INTERIOR ELEVÁTIONS FOR HEIGHT.
- COUNTER, SINK AND FAUCET. SEE PLUMBING DRAWINGS. SEE DETAILS 1/A511 AND 3/A511.
- FINISHED SOLID CORE WOOD DOOR AND HOLLOW METAL FRAME. SEE DOOR SCHEDULE.
- 8) URINAL. SEE PLUMBING DRAWINGS AND SPEC.
- ALUMINUM CLAD WOOD WINDOWS. SEE WINDOW ELEVATIONS AND DETAILS.
- CERAMIC FLOOR TILE. 10
- STAINLESS STEEL ROBE HOOKS. SEE 11 ACCESSORY SCHEDULE.
- 12 TOILET. SEE PLUMBING DRAWINGS AND SPEC.
- TILE BACKER BOARD BEHIND CERAMIC ACCENT
- 14

- DITRA SHOWER KIT, PAN OR EQ. SEE TILE SPEC. 15)
- SOLID SURFACE COUNTERTOPS, P-LAM FACED WOOD CABINETRY. SEE DETAILS AND ELEVATIONS.
- PROVIDE 10# FIRE EXTINGUISHER. MOUNT 17 BELOW COUNTER
- 18 JANITOR FLOOR SINK. SEE PLUMBING **DRAWINGS**
- 19) PROVIDE AND INSTALL REFRIGERATOR. SEE APPLIANCE SCHEDULE.
- 20 SOLID SURFACE BENCH. SEE DETAILS ON SHEET 2/A512.
- STAINLESS STEEL SEMI-RECESSED PAPER TOWEL AND WASTE COMBINATION. SEE 21 ACCESSORY SCHEDULE.
- 22) INSTALL UTILITY SHELVING, SEE 4/A511.
- SURFACE MOUNTED AUTOMATIC HAND DRYER. SEE ACCESSORY SCHEDULE.
- 36" X 36" SURFACE MOUNTED MIRROR. SEE ACCESSORY SCHEDULE.
- STAINLESS STEEL GRAB BARS. SEE ACCESSORY SCHEDULE
- 26 CARPET TILE FLOORING
- COUNTER MOUNTED SOAP DISPENSER. SEE 27 ACCESSORY SCHEDULE.

- TOILET PAPER DISPENSER. SEE ACCESSORY SCHEDULE.
- SANITARY NAPKIN DISPOSAL UNIT. SEE ACCESSORY SCHEDULE.
- TOILET SEAT COVER DISPENSER. SEE ACCESSORY SCHEDULE.
- 31 WATER RESIST GYP BOARD OVER FRAMING.
- STAINLESS STEEL ROD AND CURTAIN. SEE 32 ACCESSORY SCHEDULE.
- PROVIDE/ INSTALL MICROWAVE. SEE APPLIANCE 33 SCHEDULE
- ALUMINUM CLAD WOOD ENTRY DOOR. 34 SIDELIGHT AND HARDWARE.
- ENTRY MAT. SEE FINISH FLOOR PLAN AND DETAILS.
- STAINED/SEALED CONCRETE FLOORING. SEE 36
- SEMI RECESSED FIRE EXTINGUISHER CABINET AND EXTINGUISHER
- DRINKING FOUNTAIN WITH WATER BOTTLE FILLER, SEE PLUMBING DRAWINGS.
- 24" X 48" SURFACE MOUNTED MIRROR. SEE 39 **ACCESSORY SCHEDULE A903**
- MOP AND BROOM HOLDER. SEE ACCESSORY


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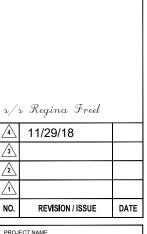
- SEE ADA/ABA GUIDELINES FOR ALL ACCESSIBILITY REQUIREMENTS.
- SEE CABINET ELEVATIONS AND DETAILS FOR DIMENSIONS THAT ARE NOT SHOWN ON THIS
- SEE FINISH SCHEDULE, AND INTERIOR ELEVATIONS ON A402, A403, AND A404 FOR TILE LOCATIONS
- CONTRACTOR SHALL VERIFY AND FIELD MEASURE ALL AS-BUILT DIMENSIONS BEFORE ORDERING INSTALL ITEMS.
- SEE ACCESSORY SCHEDULE ON A903

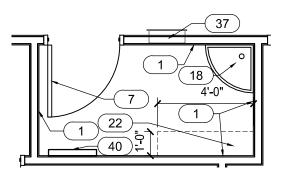

CUSTODIAN ENLARGED PLAN

SCALE: 1/4" = 1'-0"



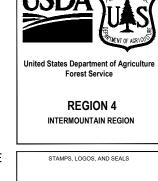

FLAMING GORGE RANGER DISTRICT OFFICE ADDITION


> **ASHLEY** NATIONAL FOREST

FLAMING GORGE RANGER DISTRICT

DRAWING TITLE

ENLARGED FLOOR PLANS

| 11/16/2018 | ARCHIVE NO. | |
|---------------------|-------------|-------------------------------|
| DESIGNER C. LEWI | s | DRAWING SHEET NO. |
| DRAWN SMHW | | A401 |
| D. JEPPSEN | | |
| PROJECT NO. 644 | | SHEET 42 OF 119 |

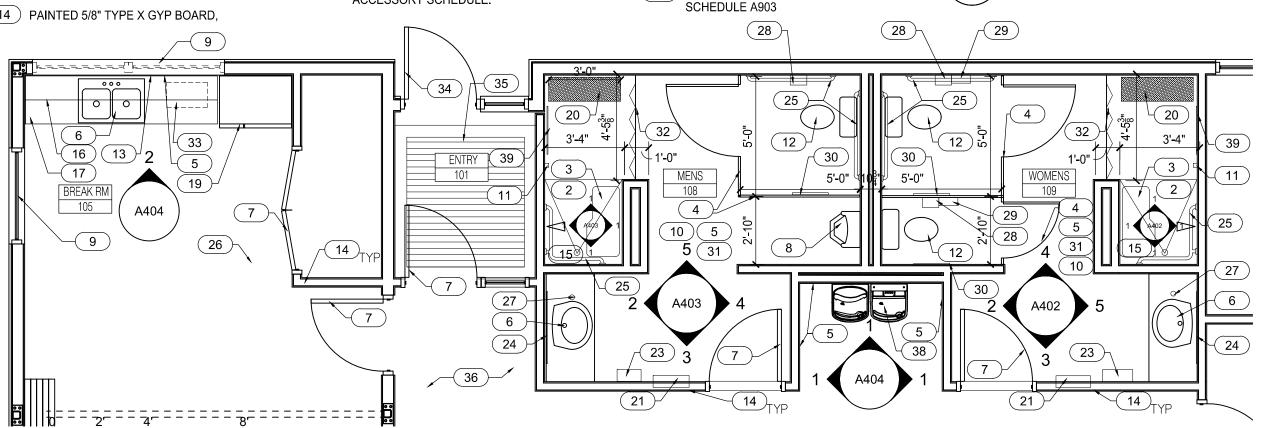

SCALE: 1/4" = 1'-0"

BREAKROOM, ENTRY, AND RESTROOMS ENLARGED PLAN

SCALE: 1/4" = 1'-0"

KEYNOTES:

- ACCESSIBLE SHOWER WITH TILE WALLS AND FLOOR. SLOPE FLOOR TILE TO DRAIN. PROVIDE ACCESSIBLE SOLID SURFACE TRANSITION AT FLOOR WHERE SHOWER TILE MEETS FLOOR TILE. SEE PLUMBING DRAWINGS FOR FIXTURE AND PLUMBING INFO.
- 2 STAINLESS STEEL GRAB BARS. MOUNT AS SHOWN IN GA1.01 AND GA1.02
- 3 FOLD DOWN SHOWER SEAT. SEE PLUMBING DRAWINGS.
- 4 CEILING/FLOOR MOUNTED LAMINATE FACED TOILET PARTITIONS, SEE SPECS.
- 5 CERAMIC WALL TILE, SEE FINISH SCHEDULE.
- 6 COUNTER, SINK AND FAUCET. SEE PLUMBING DRAWINGS. DRAIN GUARD PER ACCESSORY SCHEDULE

- 7 SOLID CORE WOOD DOOR AND HOLLOW METAL FRAME. SEE DOOR SCHEDULE.
- 8 STAINLESS TOILET SEAT COVER DISPENSER.
- 9 DITRA, SCHLUTER SHOWER KIT OR EQ.. SEE SPEC.
- 10 STAINLESS STEEL ROBE HOOKS. SEE ACCESSORY SCHEDULE.
- (11) TOILET. SEE PLUMBING DRAWINGS.
- 12 FRAMING AND TILE BAKER BOARD BEHIND CERAMIC TILE. SEE WALL TYPES FOR LOACTIONS
- 〔13) PAINTED 5/8" TYPE X GYP BOARD/ GREEN BOARD
- 14 SOLID SURFACE BENCH. SEE DETAILS ON SHEET 2/A512.
- STAINLESS STEEL SEMI-RECESSED PAPER TOWEL AND WASTE COMBO. SEE ACCESSORY SCHEDULE.
- 16 SURFACE MOUNTED AUTOMATIC HAND DRYER. SEE ACCESSORY SCHEDULE.

- 17 SURFACE MOUNTED MIRROR. SEE ACCESSORY SCHEDULE.
- 18 CERAMIC TILE ACCENT, 12" WIDE
- 19 SOAP DISPENSER. SEE ACCESSORY SCHEDULE.
- 20 TOILET PAPER DISPENSER. SEE ACCESSORY SCHEDULE.
- 21 SANITARY NAPKIN DISPOSAL UNIT. SEE ACCESSORY SCHEDULE.
- 22 STAINLESS STEEL ROD, HOOKS AND CURTAIN. SEE ACCESSORY SCHEDULE.

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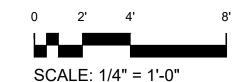
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23 STAINLESS SHOWER BASKET/ HOLDER, SEE ACCESSORY SCHEDULE

GENERAL NOTES:

- 1. SEE GA1.01/GA1.02 FOR ALL ACCESSIBILITY REQUIREMENTS.
- 2. SEE CABINET ELEVATIONS AND DETAILS FOR DIMENSIONS THAT ARE NOT SHOWN ON THIS SHEET.
- 3. SEE FINISH SCHEDULE, AND INTERIOR ELEVATIONS ON A402, A403, AND A404 FOR TILE LOCATIONS
- 4. CONTRACTOR SHALL VERIFY AND FIELD MEASURE ALL AS-BUILT DIMENSIONS BEFORE ORDERING INSTALL ITEMS.
- 5. SEE ACCESSORY SCHEDULE ON A903



3 A511


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United States Department of Agriculture Forest Service

REGION 4
INTERMOUNTAIN REGION

STAMPS, LOGOS, AND SEALS



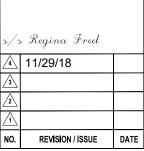

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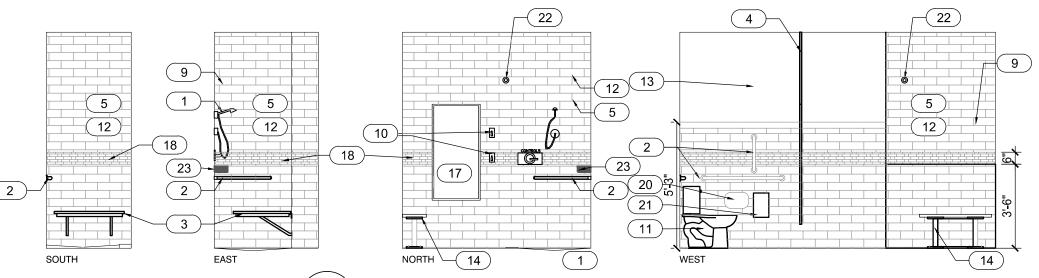
FLAMING GORGE RANGER DISTRICT

DRAWING TITLE


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INTERIOR ELEVATIONS WOMENS





1 WOMENS SHOWER ELEVATIONS
SCALE 1/4" = 1'-0"

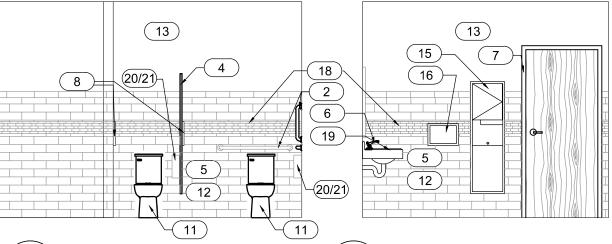

WOMENS SOUTH ELEVATION
SCALE 1/4" = 1'-0"

4 WOMENS WEST ELEVATION
SCALE 1/4" = 1'-0"


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5 WOMENS NORTH ELEVATION
SCALE 1/4" = 1'-0"


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3 WOMENS EAST ELEVATION
SCALE 1/4" = 1'-0"




KEYNOTES:

- 1 CERAMIC WALL TILE, SEE FINISH SCHEDULE.
- 2 BREAKROOM SOLID SURFACE COUNTERTOP, LAMINATE COVERED WOOD CABINETS, SINK AND FAUCET. SEE PLUMBING DRAWINGS. SEE DETAIL 1/A511. CONTRACTOR TO PROVIDE SHOP DRAWINGS.
- 3 CERAMIC ACCENT TILE OVER BACKER BOARD
- 4 ALUMINUM CLAD WOOD WINDOWS. SEE WINDOW ELEVATIONS. SEE WINDOW DETAILS.
- 5 TILE BOARD BEHIND ALL CERAMIC WALL TILE
- (6) PAINTED 5/8" TYPE X GYP BOARD,
- 7 DRINKING FOUNTAIN WITH WATER BOTTLE FILLER. SEE PLUMBING DRAWINGS.
- (8) COVED CERAMIC WALL BASE. SEE A901
- 9 PROVIDE AND INSTALL REFRIGERATOR SEE APPLIANCE SCHEDULE, A903.
- 10 PROVIDE AND INSTALL MICROWAVE. SEE APPLIANCE SCHEDULE. A903
- RUBBER BASE AND CARPET. SEE FINISH SCHEDULE

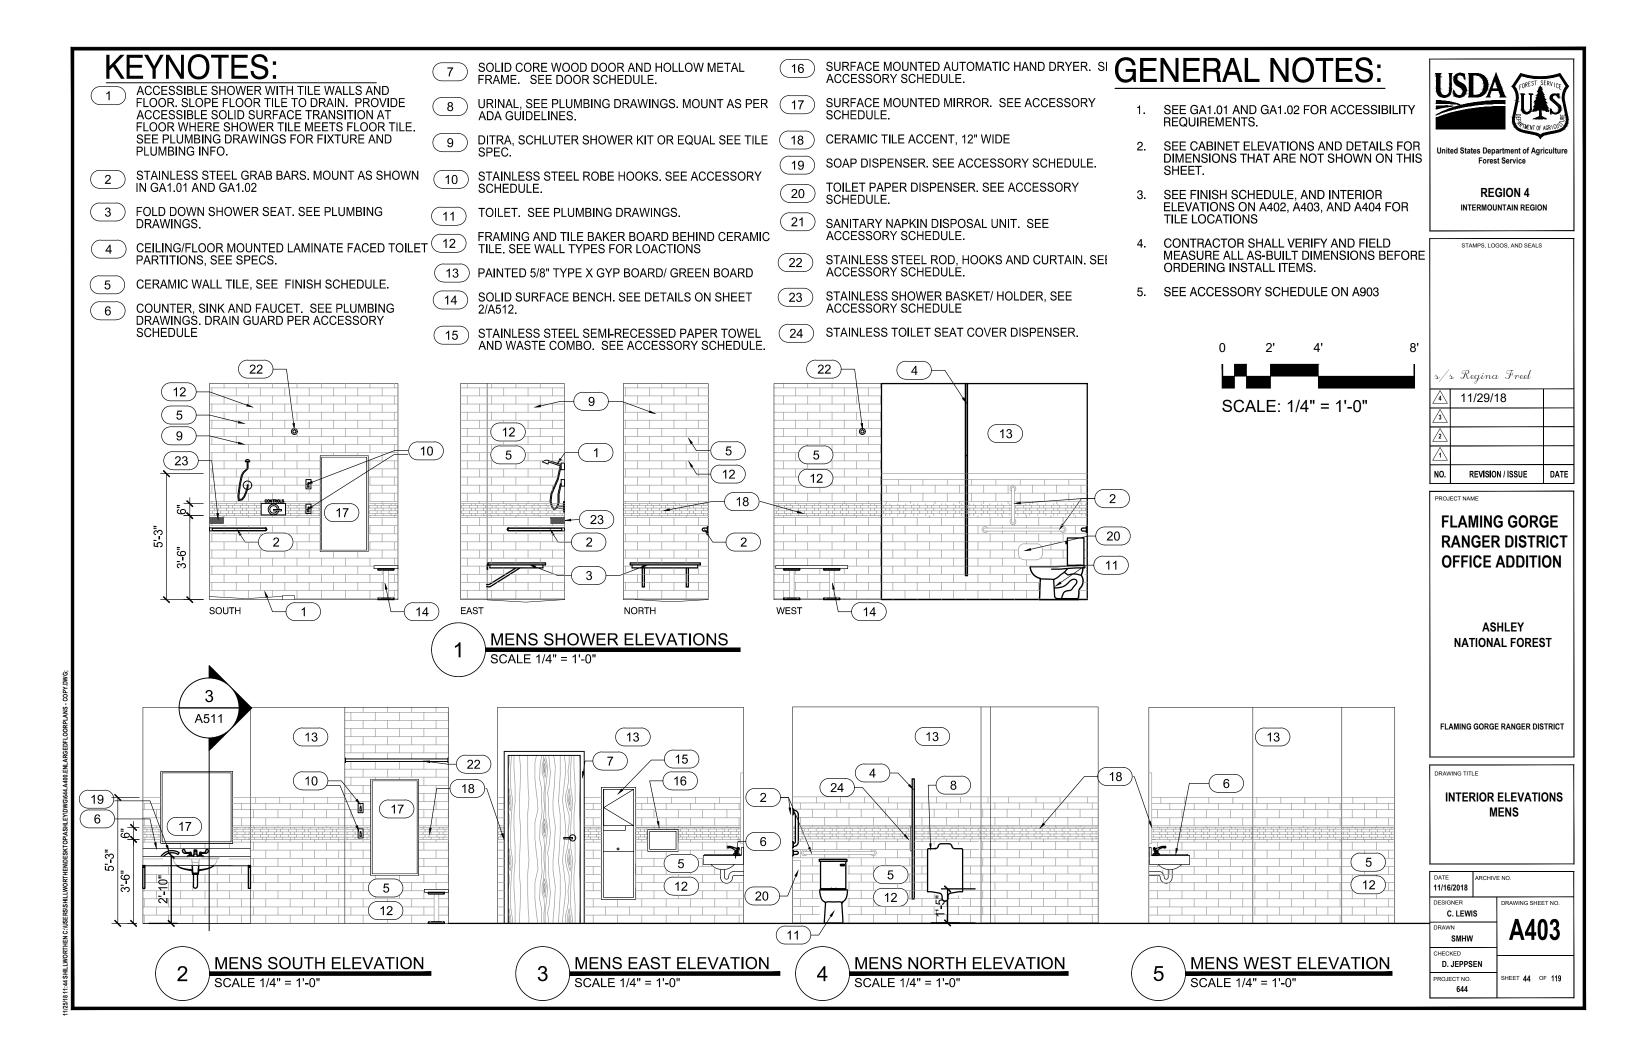

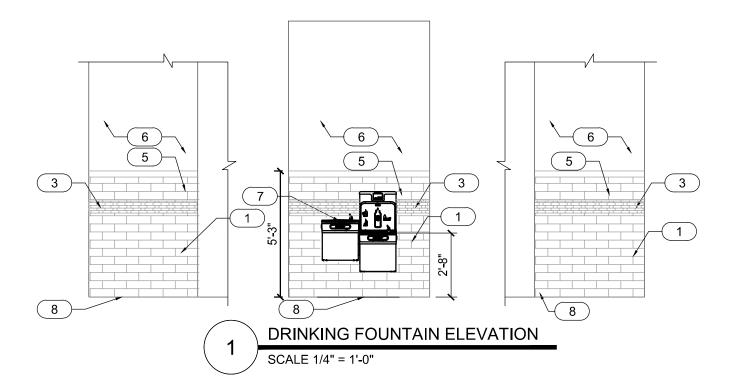GENERAL NOTES:


- 1. SEE SHEET G001 G002 FOR GENERAL NOTES.
- 2. SEE G2 SHEET FOR DRAWING INDEX.
- 3. SEE ADA/ABA GUIDELINES FOR ALL ACCESSIBILITY REQUIREMENTS.
- 4. SEE CABINET ELEVATIONS AND DETAILS FOR DIMENSIONS THAT ARE NOT SHOWN ON THIS SHEET
- 5. SEE FINISHING SCHEDULE, AND INTERIOR ELEVATIONS ON A402, AND A403 FOR TILE LOCATIONS
- 6. CONTRACTOR SHALL VERIFY AND FIELD MEASURE ALL AS-BUILT DIMENSIONS BEFORE ORDERING INSTALL ITEMS
- 7. SEE ACCESSORY SCHEDULE ON A903

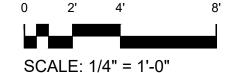

United States Department of Agriculture Forest Service

REGION 4
INTERMOUNTAIN REGION

STAMPS, LOGOS, AND SEALS

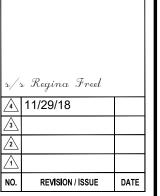

PROJECT NAME

FLAMING GORGE RANGER DISTRICT OFFICE ADDITION


ASHLEY
NATIONAL FOREST


FLAMING GORGE RANGER DISTRICT


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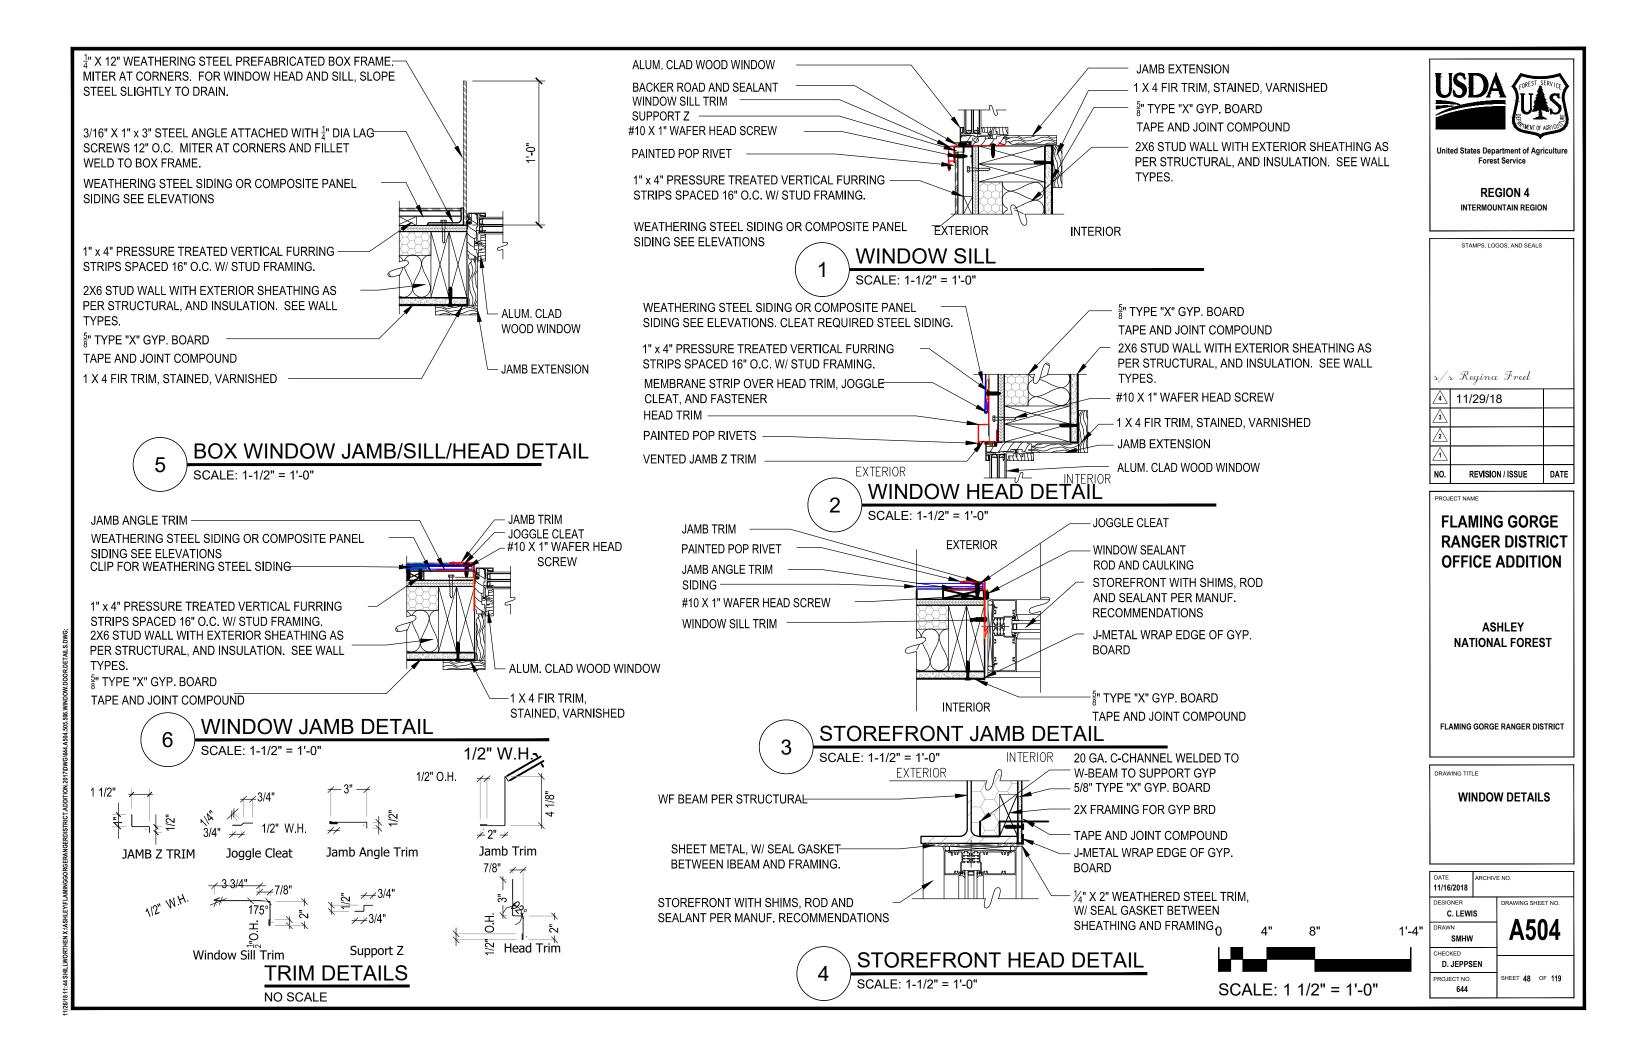
INTERIOR ELEVATIONS


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| DESIGNER C. LEWI | s | DRAWING SHEET NO. |
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| PROJECT NO. 644 | | SHEET 45 OF 119 |




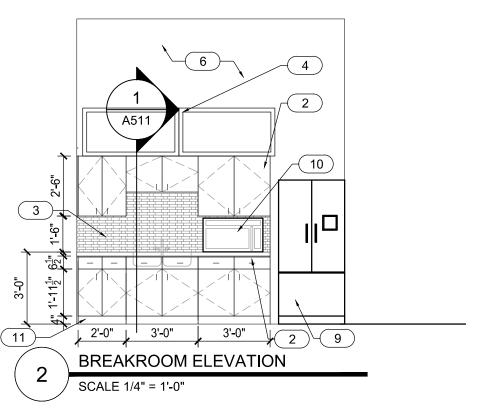


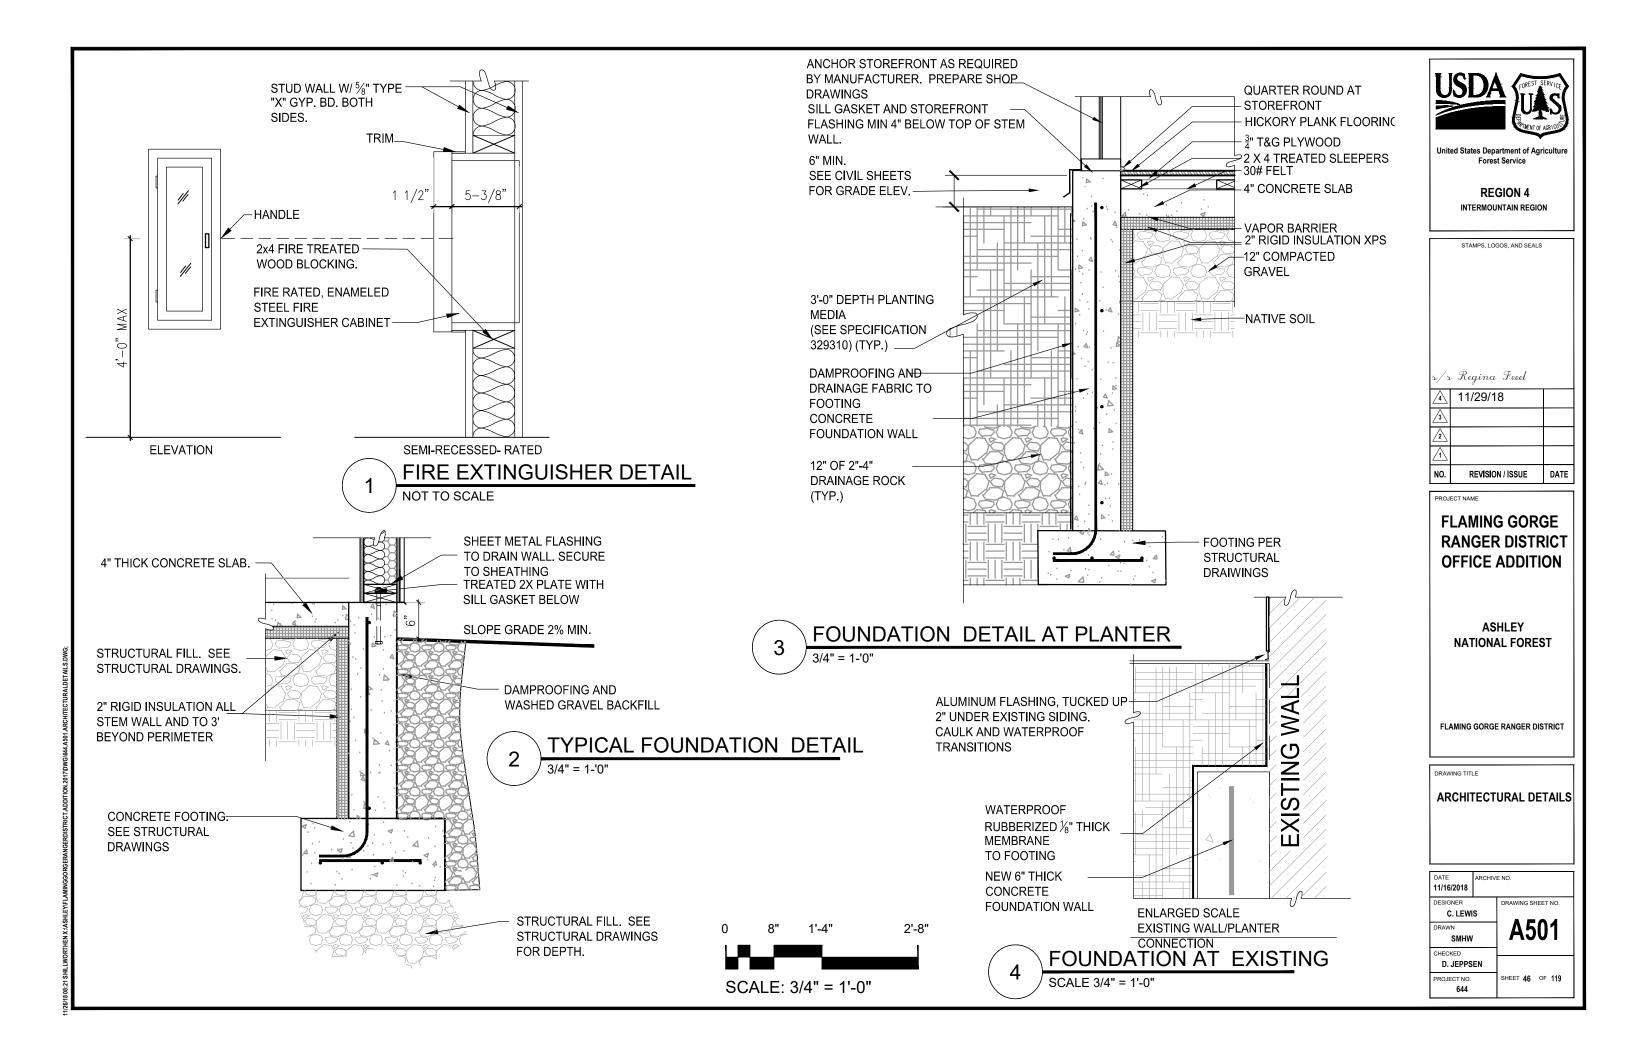

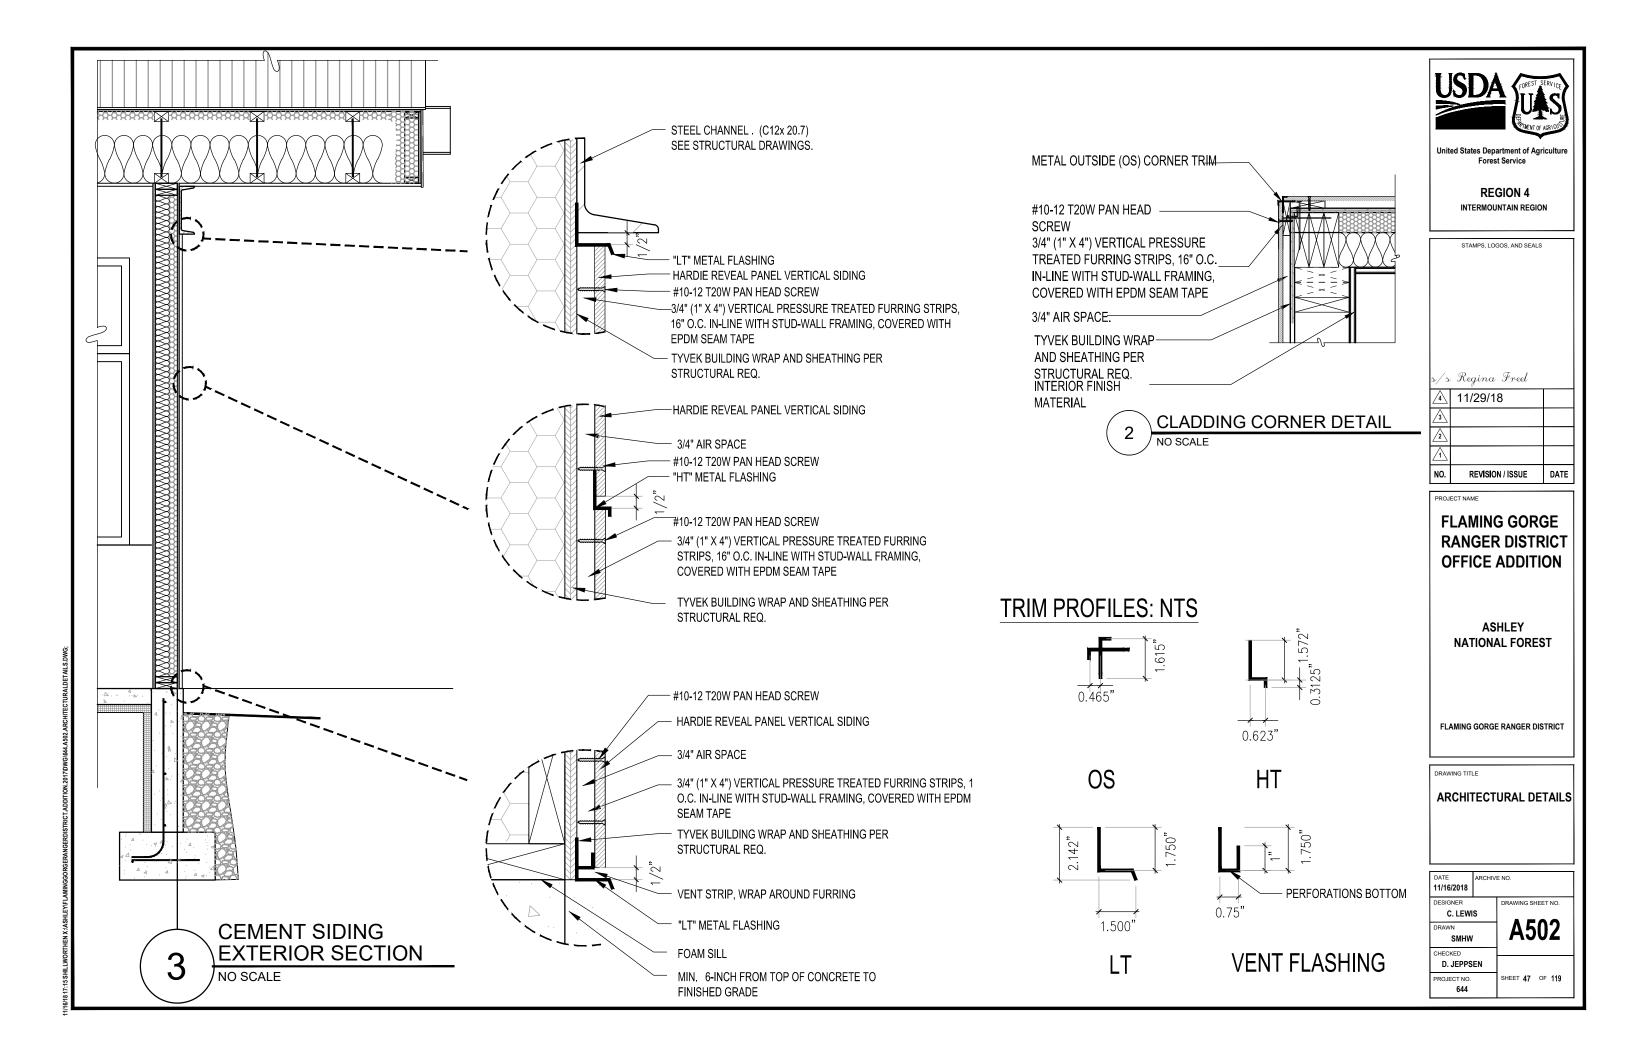

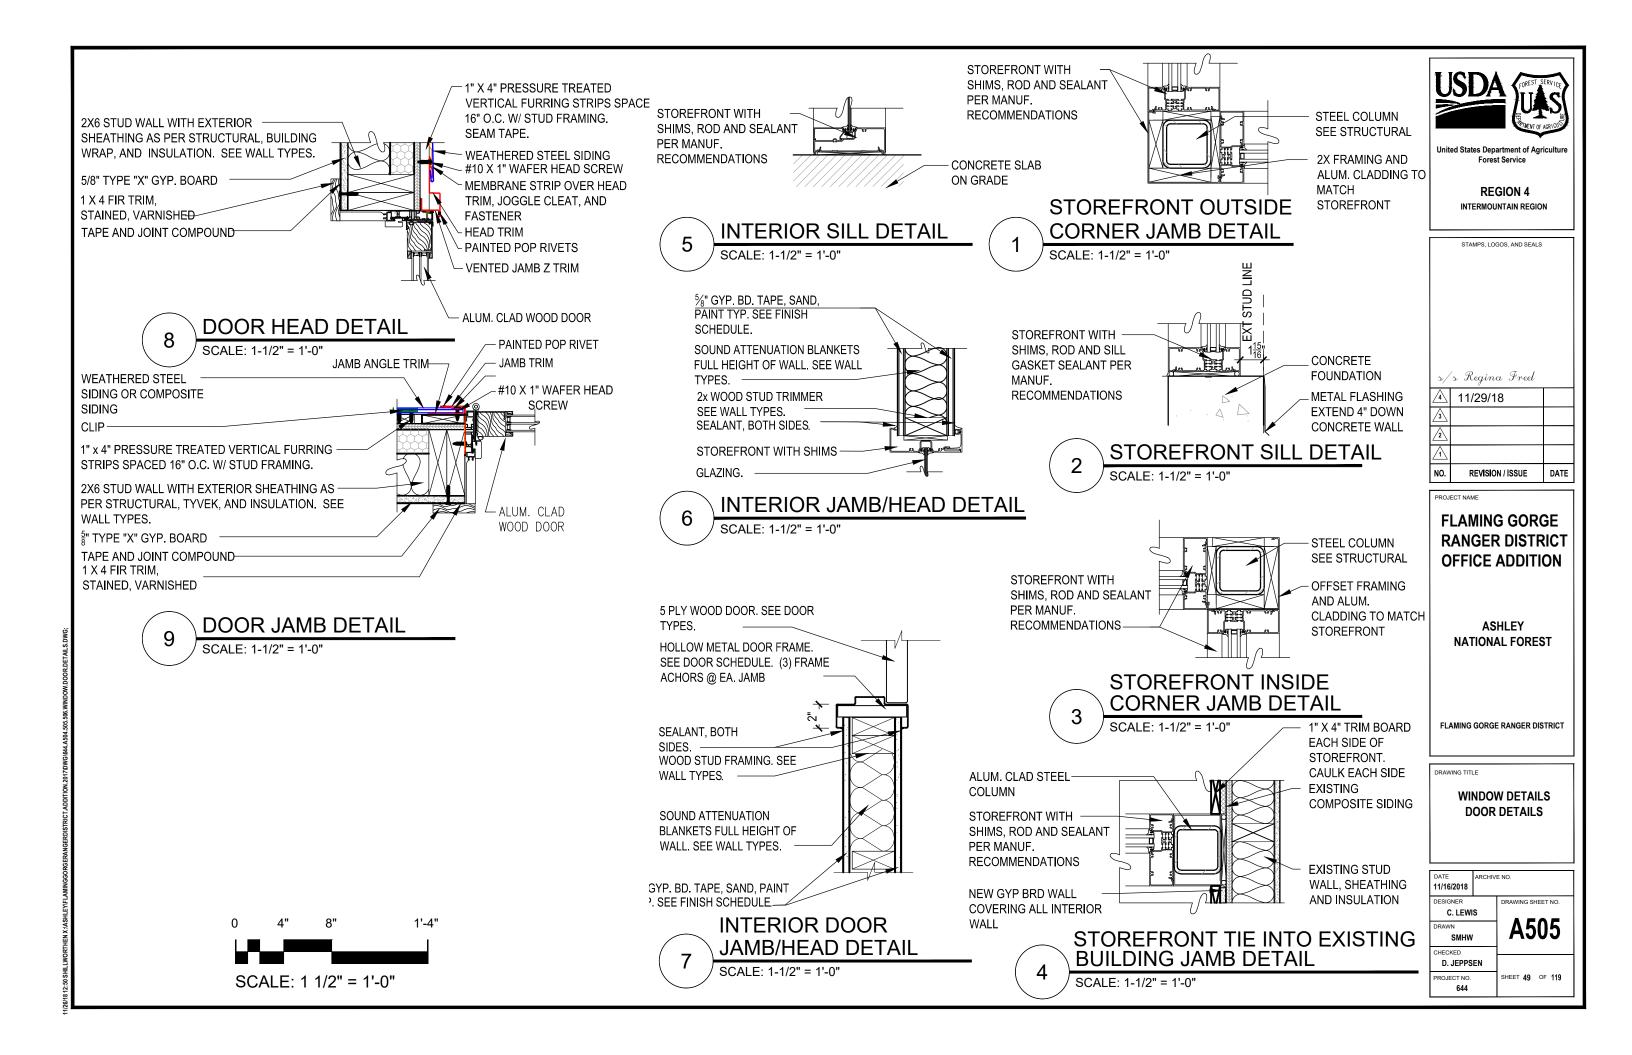

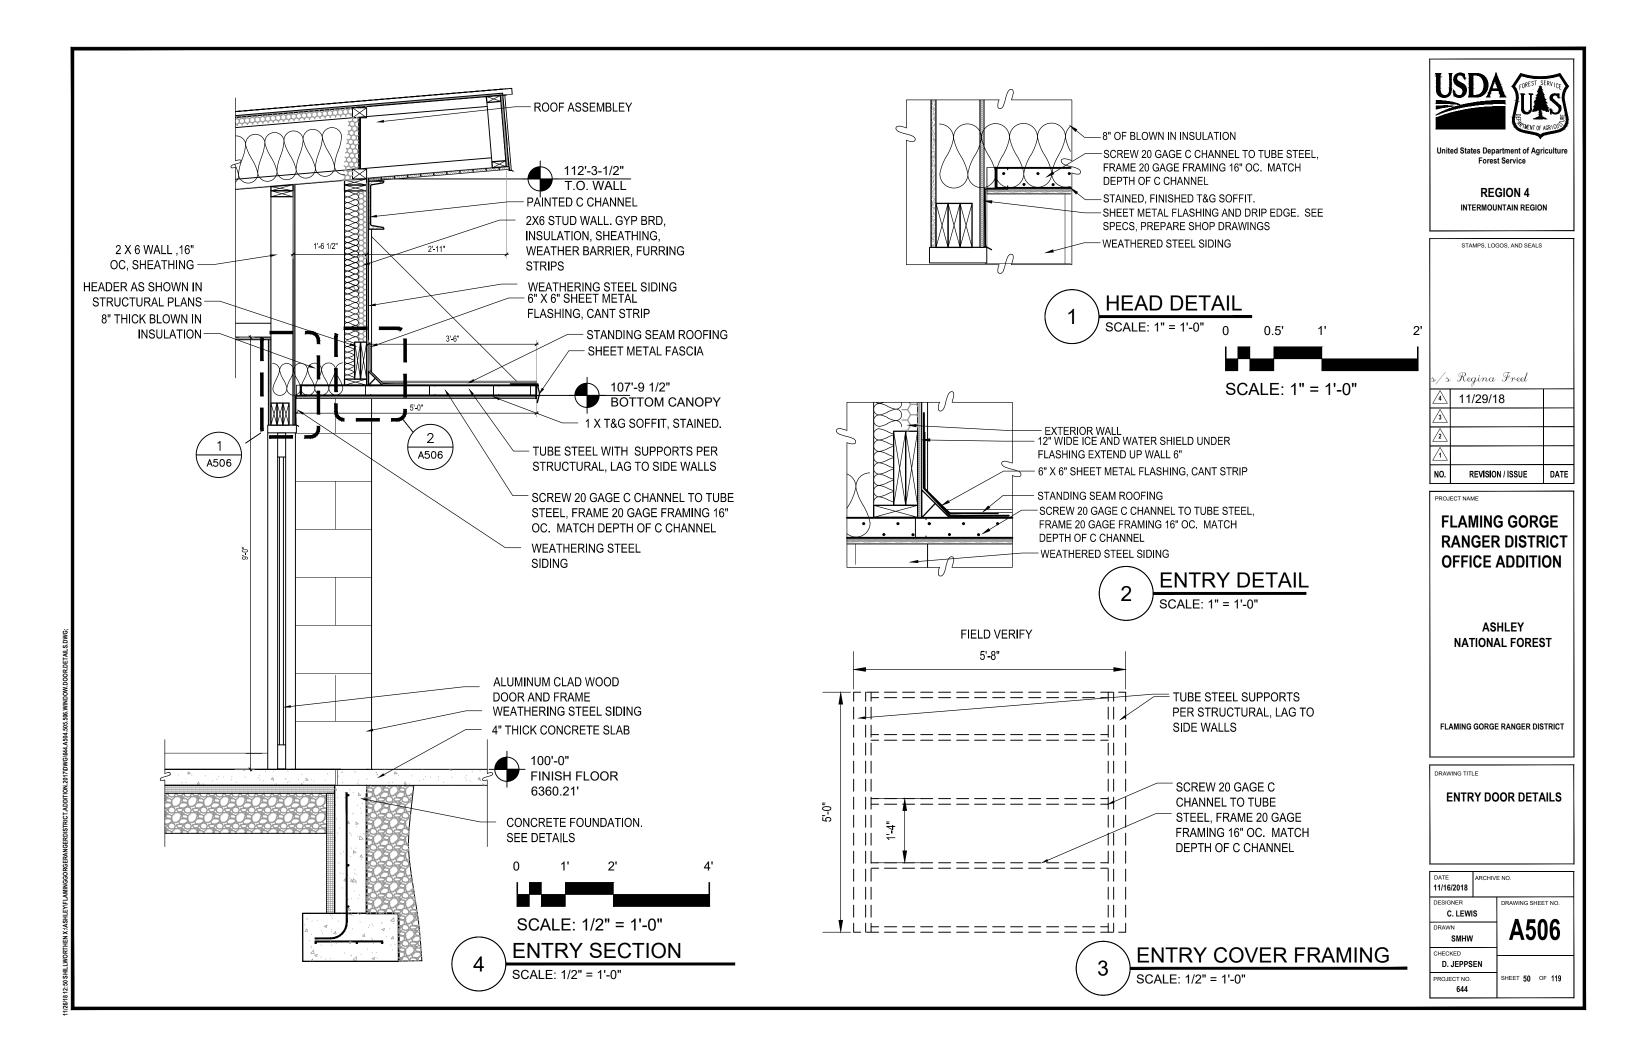

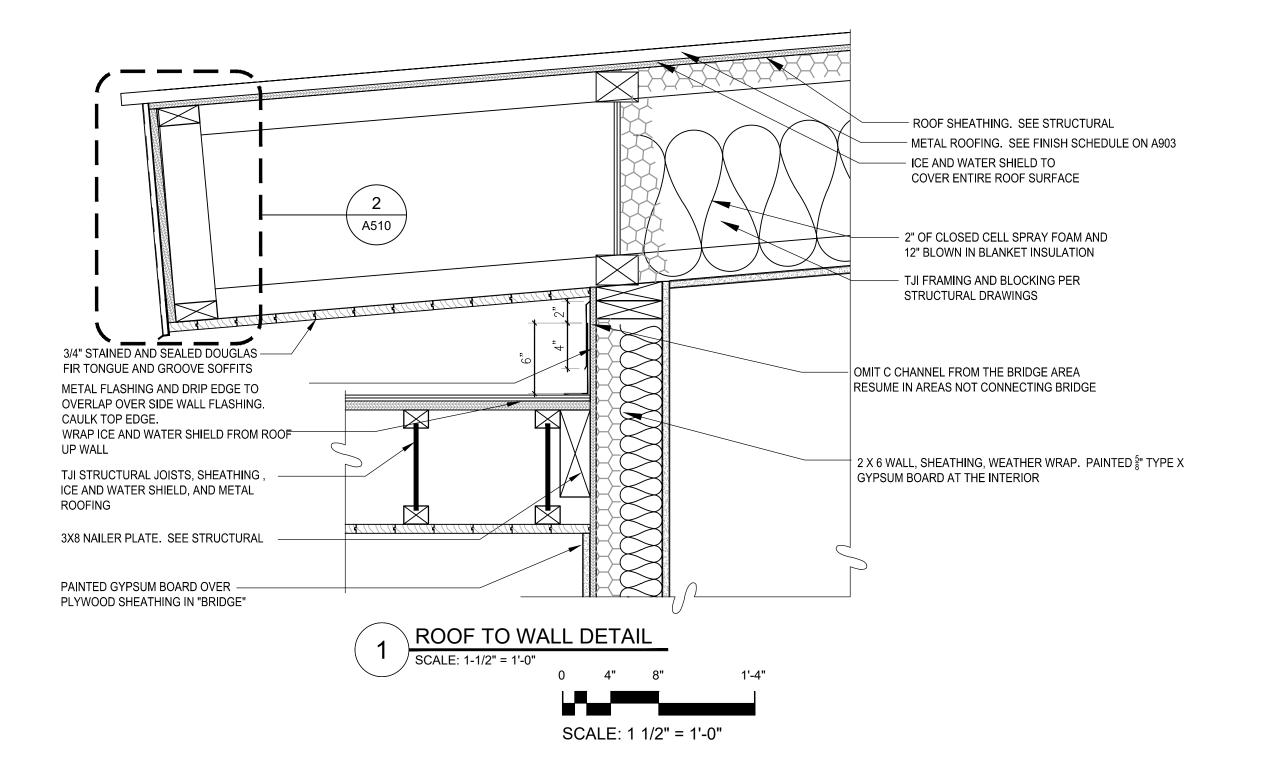



REGION 4
INTERMOUNTAIN REGION

STAMPS, LOGOS, AND SEALS

s/s Regina Freel

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FLAMING GORGE RANGER DISTRICT OFFICE ADDITION


ASHLEY
NATIONAL FOREST


FLAMING GORGE RANGER DISTRICT

DRAWING TITLE

ROOF DETAILS

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| DESIGNER C. LEWI | s | DRAWING SHEET NO | |
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| PROJECT NO. 644 | | SHEET 51 OF 11 | 9 |

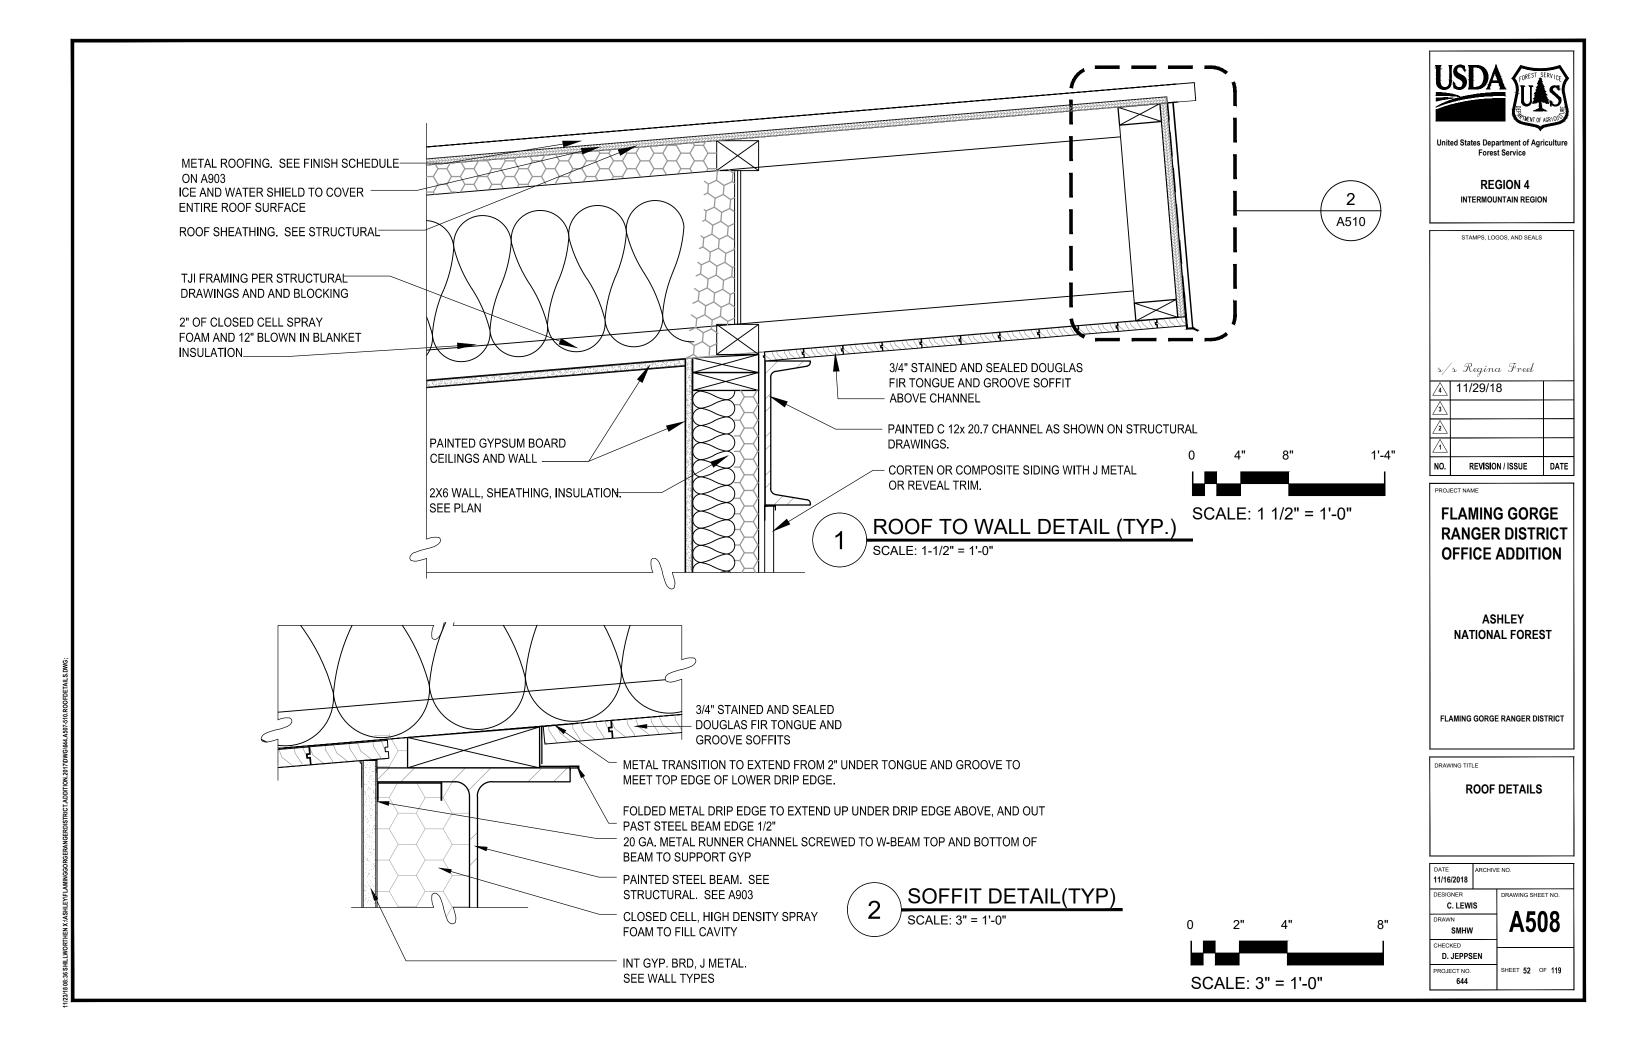

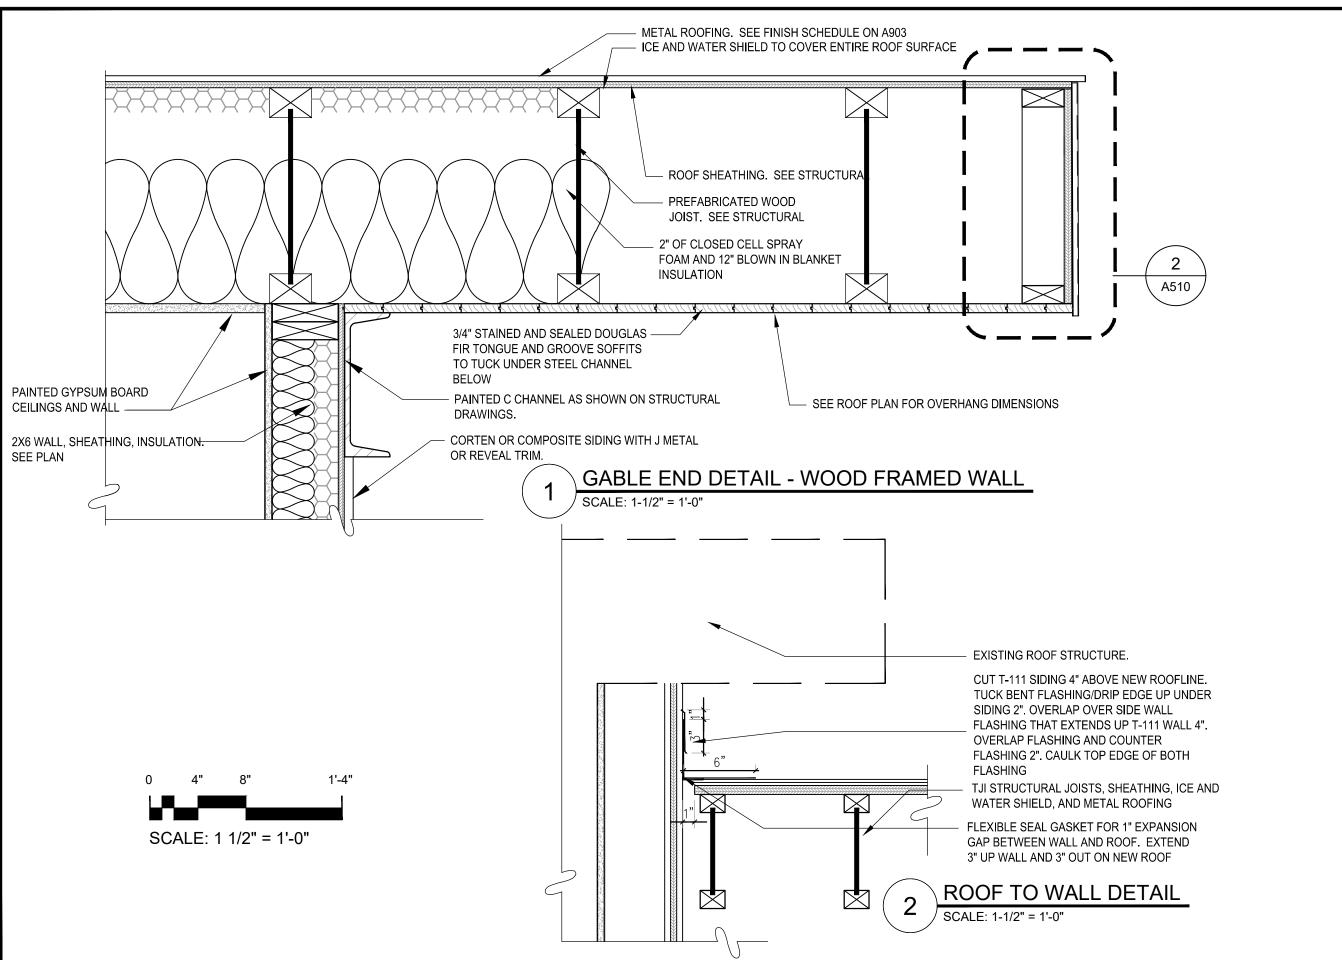



Forest Service

REGION 4
INTERMOUNTAIN REGION

stamps, logos, and seals

s/s Regina Freel

11/29/18

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NO. REVISION/ISSUE DATE

PROJECT NAME

FLAMING GORGE RANGER DISTRICT OFFICE ADDITION


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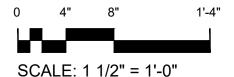
FLAMING GORGE RANGER DISTRICT


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ROOF DETAILS

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| DRAWN SMHW | | A509 |
| CHECKED D. JEPPS | EN | |
| PROJECT NO. | | SHEET 53 OF 119 |





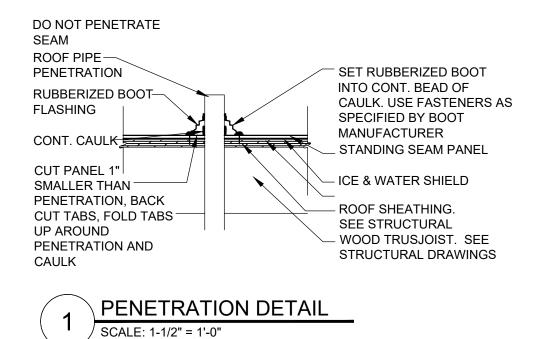

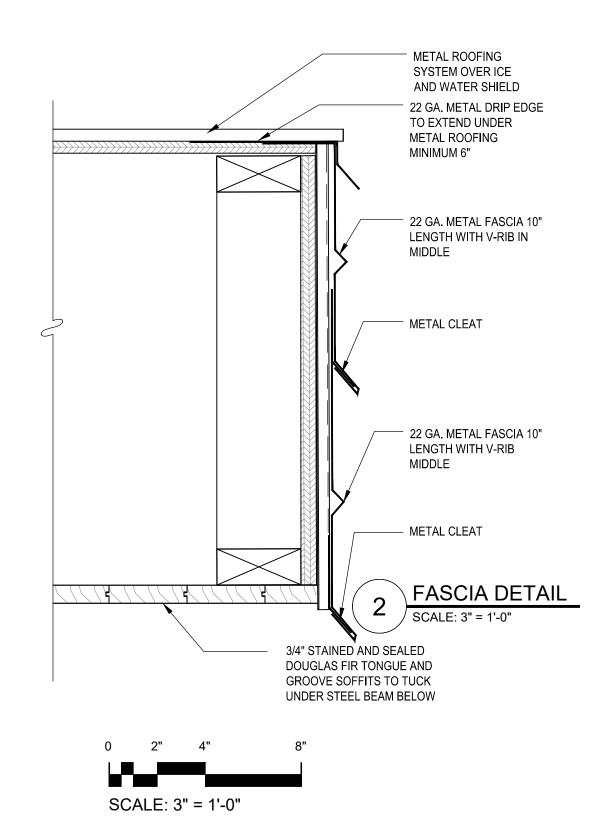

REGION 4
INTERMOUNTAIN REGION

STAMPS, LOGOS, AND SEALS

S/S Regina Freel

11/29/18

NO. REVISION/ISSUE DATE

PROJECT NAME

FLAMING GORGE RANGER DISTRICT OFFICE ADDITION


ASHLEY
NATIONAL FOREST

FLAMING GORGE RANGER DISTRICT


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ROOF DETAILS

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| DRAWN SMHW | A510 |
| CHECKED D. JEPPSE | EN |
| | SHEET 54 OF 119 |

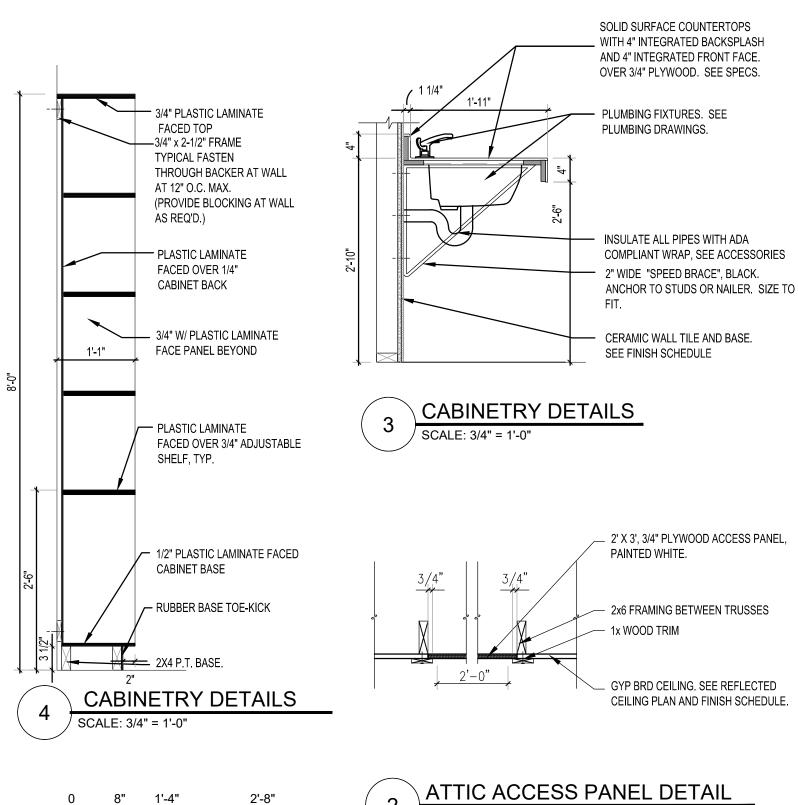

SCALE: 3/4" = 1'-0"

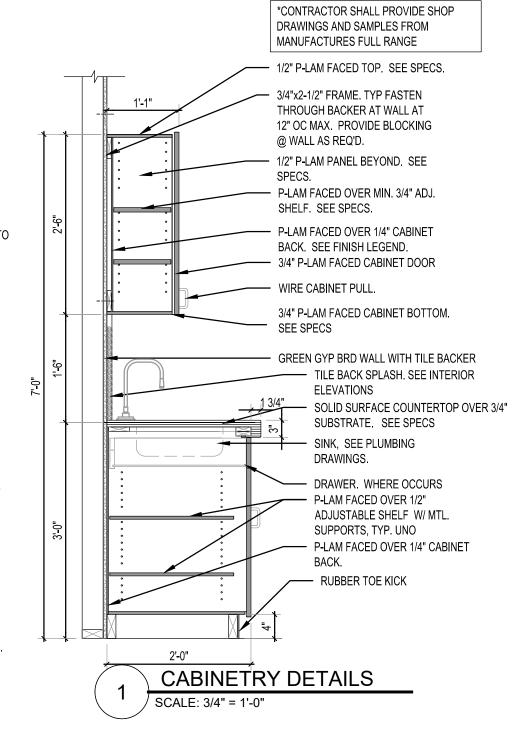

Forest Service

REGION 4 INTERMOUNTAIN REGION

STAMPS, LOGOS, AND SEALS

s/s Regina Freel <u>4</u> 11/29/18 NO. REVISION / ISSUE DATE

FLAMING GORGE RANGER DISTRICT **OFFICE ADDITION**

PROJECT NAME

ASHLEY NATIONAL FOREST

FLAMING GORGE RANGER DISTRICT


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DETAILS


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| DRAWN SMHW | | A: | 511 |
| D. JEPPSEN | | | |
| PROJECT NO. 644 | | SHEET 55 | OF 119 |

ATTIC ACCESS PANEL DETAIL

SCALE: 3/4" = 1'-0"

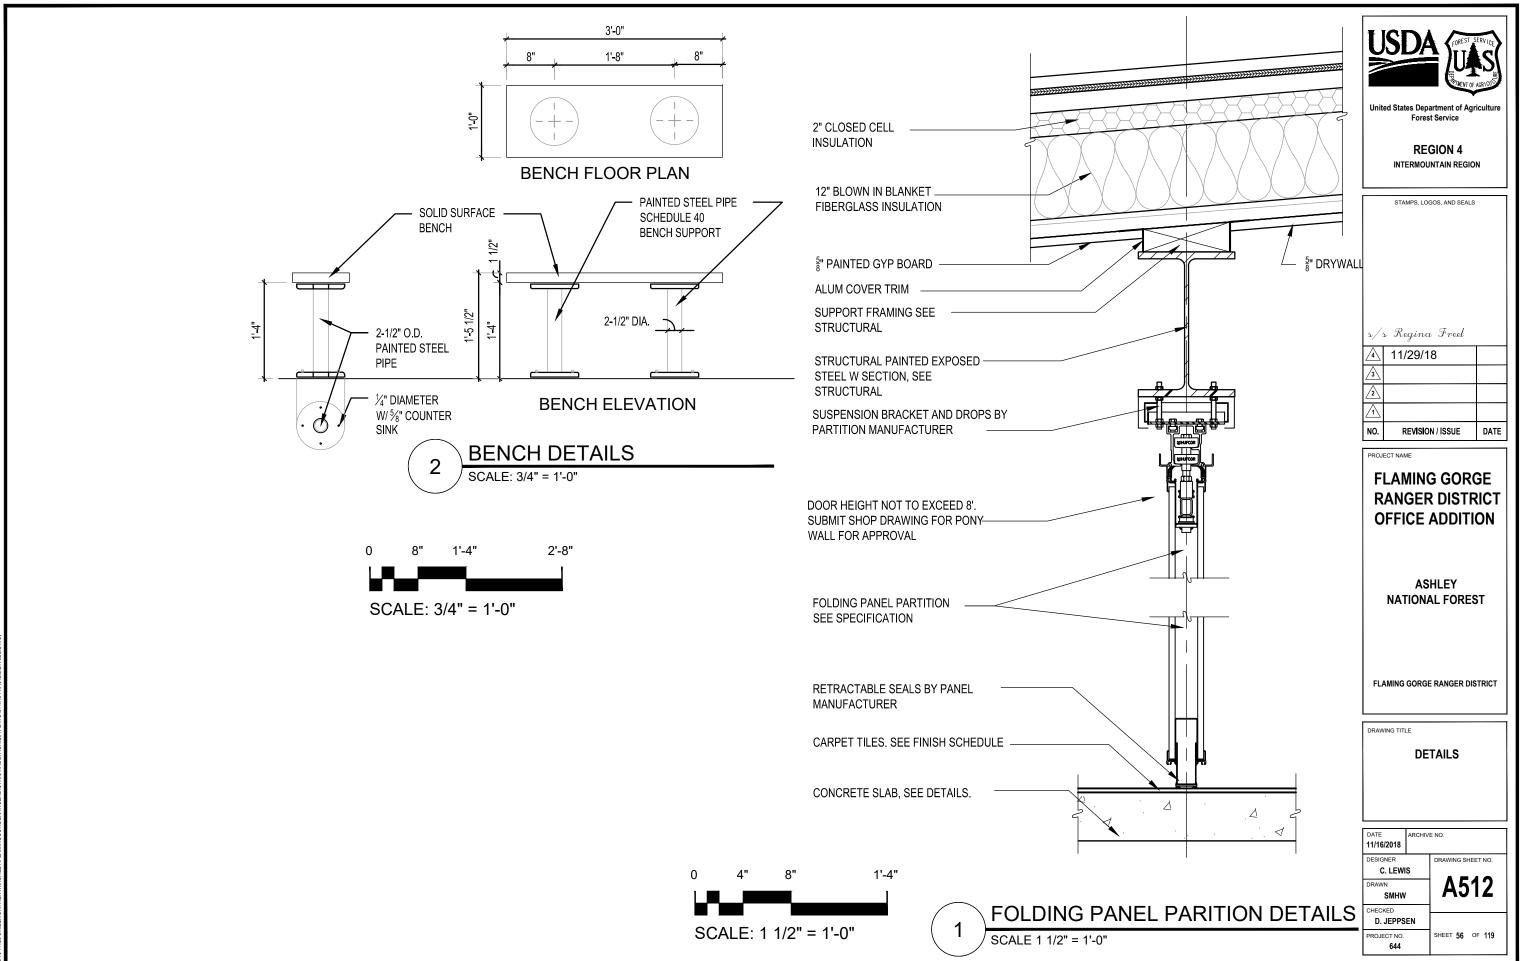

1/16/18 17:25 SHILLWORTHEN X:\ASHLEY\FLAMINGGORGERANGERDISTRICT.

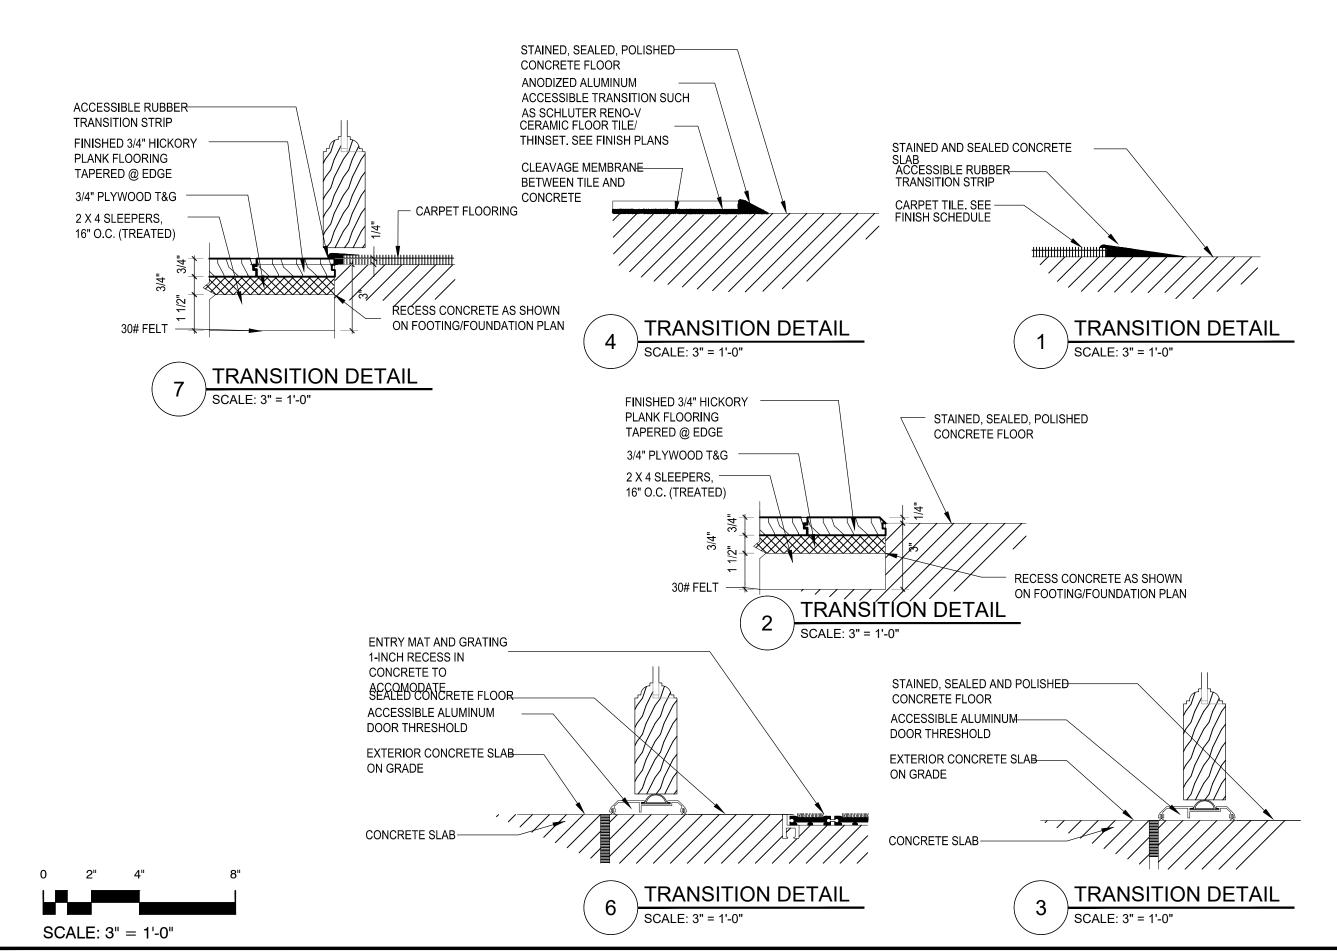



REGION 4
INTERMOUNTAIN REGION

STAMPS, LOGOS, AND SEALS

/s Regina Freel

| /3\ | 11/29/18 | |
|---------|------------------|------|
| <u></u> | | |
| 1 | | |
| NO. | REVISION / ISSUE | DATE |

PROJECT NAME

FLAMING GORGE RANGER DISTRICT OFFICE ADDITION

ASHLEY
NATIONAL FOREST

FLAMING GORGE RANGER DISTRICT

DRAWING TITLE

FLOORING TRANSITION DETAILS

| DATE 11/16/2018 | ARCHIV | E NO. |
|---------------------|--------|-------------------|
| DESIGNER C. LEWI | s | DRAWING SHEET NO. |
| DRAWN SMHW | 1 | A513 |
| CHECKED D. JEPPS | EN | |
| PROJECT NO. 644 | | SHEET 57 OF 119 |

WALL TYPES

WEATHERED/CORTEN STEEL SIDING

3/4" AIR GAP/ 1X 4 TREATED WOOD

EXTERIOR GRADE PLYWOOD

2x6 WOOD STUDS @ 16" O.C.

SHEATHING, SEE STRUCTURAL


2" HIGH DENSITY, CLOSED CELL-

VERTICALS

SEE STRUCT.

BUILDING WRAP. -

SEE STRUCTURAL DRAWINGS FOR ALL SHEAR WALL SHEATHING REQUIREMENTS WITH ALL WALL TYPES.

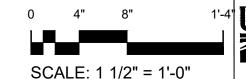

SCALE 1 ½"= 1'-0"

SCALE 1 ½"= 1'-0"

United States Department of Agricults Forest Service

> **REGION 4** INTERMOUNTAIN REGION

STAMPS, LOGOS, AND SEALS

s/s Regina Fred <u>/4</u> 11/29/18 NO. REVISION / ISSUE DATE

POLYURETHANE SPRAYFOAM INSULATION.

3 ½" THICK "BIBS" INSULATION. SEE SPECS

ALUMINUM STOREFORONT CURTAIN WALL

WITH COMPLETE THERMAL BREAK.

1" INSULATED GLASS UNITS, CLEAR

WITH LOW E COATING.

SCALE 1 ½"= 1'-0" PAINTED COMPOSITE FLAT SIDING, REVEAL TRIM 3/4" AIR GAP/ 1X 4 TREATED WOOD **VERTICALS** BUILDING WRAP. -EXTERIOR GRADE PLYWOOD SHEATHING, SEE STRUCTURAL 2x6 WOOD STUDS @ 16" O.C. SEE STRUCT. 2" HIGH DENSITY, CLOSED CELL, POLYURETHANE SPRAYFOAM INSULATION. $3\frac{1}{2}$ " THICK "BIBS" INSULATION. SEE SPECS 5/8" TYPE "X" GYP. BD. PAINT. SEE FINISH SCHEDULE. USE WP GYP. BD. IN RESTROOMS.

SCALE 1 ½"= 1'-0"

SCALE 1 ½"= 1'-0"

1 HOUR RATED ASSEMBLY IN AREAS SHOWN ON PLANS 5/8" TYPE "X" GYP. BD. BOTH SIDES UNLESS NOTED OTHERWISE ON PLAN. PAINT. SEE FINISH SCHEDULE. USE WP GYP. BD. IN RESTROOMS. 2x6 WOOD STUDS @ 16" O.C. 5-1/2" SOUND ATTENUATION BLANKETS, FULL HEIGHT OF WALL. NOTE: GYP. BD. REQ'D ONLY ONE SIDE AT PLUMBING CHASES OR COLUMN ENCLOSURES. SEE FRAMING PLAN FOR 1 HOUR FIRE SCALE 1 ½"= 1'-0" RATED LOCATIONS 5/8" TYPE "X" GYP. BD. BOTH SIDES UNLESS NOTED OTHERWISE ON PLAN. PAINT. SEE FINISH SCHEDULE. USE WP

GYP. BD. IN RESTROOMS. 2x4 WOOD STUDS @ 16" O.C. -3-1/2" SOUND ATTENUATION BLANKETS, FULL HEIGHT OF WALL.

NOTES: GYP. BD. REQ'D ONLY ONE SIDE AT PLUMBING CHASES OR COLUMN ENCLOSURES. ADDITION OF FRP IWAINSCOT N CUSTODIAL CLOSET 4' **HEIGHT**

SEE FRAMING PLAN FOR 1 HOUR FIRE RATED LOCATIONS

CERAMIC TILE (THINSET) OR GREENBOARD. SEE FINISH SCHEDULE AND ELEVATIONS

PRESSURE TREATED 2x4 WOOD STUD FRAMING @ 16" O.C.

CEMENTITIOUS BACKER BOARD UNDER TILE

3-1/2" SOUND ATTENUATION BLANKETS, FULL HEIGHT OF WALL

3-1/2" SOUND ATTENUATION BLANKETS, FULL HEIGHT OF WALL

2-1/2" AIR SPACE —

CEMENTITIOUS BACKER BOARD

SCHEDULE

CERAMIC TILE (THINSET). SEE FINISH

GYP. BD. REQ'D ONLY ONE SIDE AT PLUMBING CHASES OR COLUMN ENCLOSURES.

FLAMING GORGE RANGER DISTRICT OFFICE ADDITION


ASHLEY NATIONAL FOREST

FLAMING GORGE RANGER DISTRICT

DRAWING TITLE

WALL TYPES

CHIVE NO 11/16/2018 AWING SHEET NO. C. LEWIS A60² SMHW HECKED D. JEPPSEN ROJECT NO. SHEET 58 OF 119 644

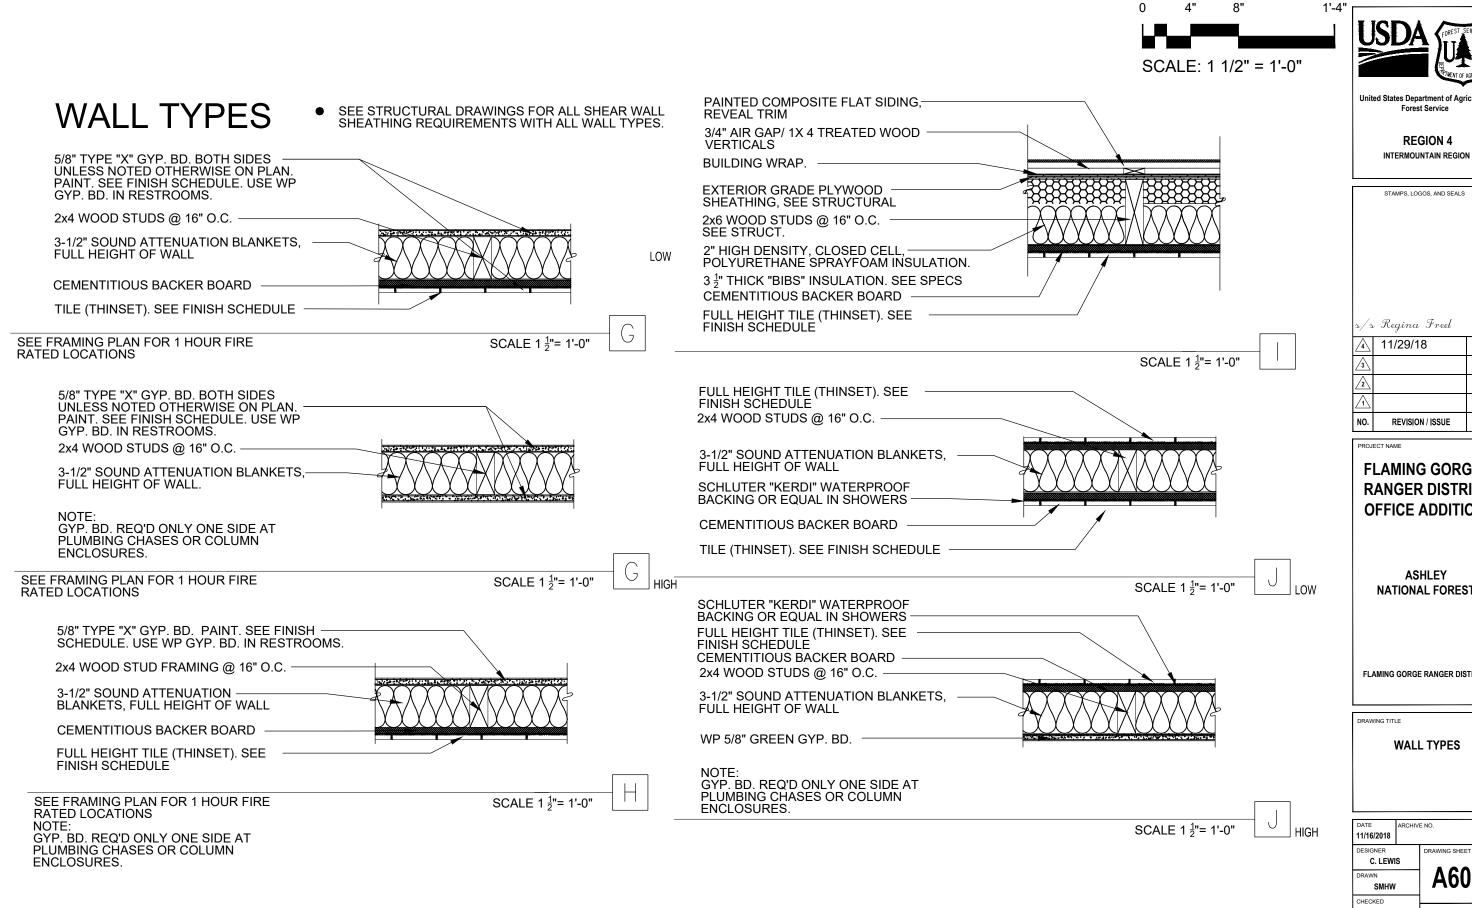

Inited States Department of Agricultu Forest Service

s/s Regina Freel DATE REVISION / ISSUE

> FLAMING GORGE RANGER DISTRICT OFFICE ADDITION

> > **ASHLEY NATIONAL FOREST**

FLAMING GORGE RANGER DISTRICT

WALL TYPES

AWING SHEET NO. A602 D. JEPPSEN SHEET 59 OF 119 ROJECT NO.

644

DOOR SCHEDULE ABBREV. WD WOOD STAIN НМ **HOLLOW METAL** PAINT ALUMINUM AN ANODIZED GENERAL DOOR/WINDOW NOTES ALL WOOD DOORS & FRAMES SHALL BE STAINED - SEE A903 2

PYROGUARD, CLEAR, TEMPERED, GLAZING

ALL HOLLOW METALS COMPONENTS SHALL BE PAINTED

3

ALL GLAZING ON FIRE RATED DOORS/SIDELITES TO BE 5/16", 20 MIN.


| | WINDOW TYPE NOTES / LEGEND: |
|---------|--|
| Α | ALL GLASS WITHIN 24" OF ANY DOOR SHALL BE TEMPERED. SEE IBC |
| В | ALL GLASS WITHIN 18" OF FIN. FLOOR SHALL BE TEMPERED SEE IBC |
| С | ALL HOLLOW METAL FRAMES SHALL BE PAINTED. |
| D | ALL HOLLOW METAL FRAMES SHALL BE FACTORY PRIMED |
| E | ALL WINDOW STOPS SHALL BE ROOM SIDE |
| <u></u> | INDICATES 1" INSULATED TEMPERED GLAZING |
| 12 | INDICATES 1/4" TEMPERED GLAZING |
| A | INDICATES 1" INSULATED GLAZING |
| | |
| | INDICATES HINGE. COORD. W/ PLAN AND DOOR SCHEDULE. |

DOOR SCHEDULE

| | | | | | | | | | 1 | | | | |
|-----|---------------------------|----------------|--------|----------|--------|--------|----------|--------|--------------------|--------------------|--------------------|----------|-------|
| | DOOR AND GLASS SIZE | (MIN) | | DOOR | | FR/ | AME | | FRAME | DETAILS | 3 | | DOOR |
| NO. | | FIRE RATING (A | TYPE | MATERIAL | FINISH | TYPE | MATERIAL | FINISH | HEAD | JAMB | THRESHOLD | HARDWARE | NOTES |
| 01 | 3'-0" x 7'-0" x 1 3/4" | _ | 1 | AL/WD | AN/ST | 1 | AL/WD | AN/WD | 8/ A505 | ^{9/} A505 | ^{6/} A513 | 01 | ① |
| 02 | 3'-0" x 7'-0" x 1 3/4" | _ | 1 | AL/WD | AN/ST | 3 | AL/WD | AN/WD | 8/ A505 | ^{9/} A505 | ^{3/} A513 | | 1 |
| 03 | 3'-0" x 7'-0" x 1 3/4" | 20 | 3 | WD | ST | 4 | НМ | PT | 7/ SIM A505 | 7/ SIM A505 | ^{7/} A513 | | 123 |
| 04 | 3'-0" x 7'-0" x 1 3/4" | - | 2 | WD | ST | 2 | НМ | PT | 7/ A505 | ^{7/} A505 | | 05 | 1 3 |
| 05 | 3'-0" x 7'-0" x 1 3/4" | 20 | 3 | WD | ST | 4 | НМ | PT | ^{7/} A505 | | | 04 | 123 |
| 06 | 3'-0" x 7'-0" x 1 3/4" | 20 | 3 | WD | ST | 4 | НМ | PT | 7/ A505 | | | | 123 |
| 07 | 3'-0" x 7'-0" x 1 3/4" | 20 | 3 | WD | ST | 4 | НМ | PT | ^{7/} A505 | | | | 123 |
| 80 | 3'-0" x 7'-0" x 1 3/4" | 20 | 4 | WD | ST | 4 | НМ | PT | 7/ A505 | | | | 123 |
| 09 | 3'-0" x 7'-0" x 1 3/4" | 20 | 4 | WD | ST | 4 | НМ | PT | ^{7/} A505 | | | | 123 |
| 10 | 3'-0" x 7'-0" x 1 3/4" | 20 | 4 | WD | ST | 4 | НМ | PT | 7/ A505 | ^{7/} A505 | | 06 | 123 |
| 11 | 3'-0" x 7'-0" x 1 3/4" | 20 | 4 | WD | ST | 4 | НМ | PT | ^{7/} A505 | | | 06 | 123 |
| 12 | 3'-0" x 7'-0" x 1 3/4" | 20 | 3 | WD | ST | 4 | НМ | PT | ^{7/} A505 | | - | 08 | 123 |
| 13 | 3'-0" x 7'-0" x 1 3/4" | _ | 3 | WD | ST | 4 | НМ | PT | ^{7/} A505 | | | 04 | ① ③ |
| 14 | 3'-0" x 7'-0" x 1 3/4" | - | 4 | WD | ST | 4 | НМ | PT | 7/ A505 | | | | 1 3 |
| 15 | 3'-0" x 7'-0" x 1 3/4" | _ | 3 | WD | ST | 4 | НМ | PT | ^{7/} A505 | | | | ① ③ |
| 16 | 3'-0" x 7'-0" x 1 3/4" | - | 3 | WD | ST | 4 | НМ | PT | 7/ A505 | | | 04 | 1 3 |
| 17 | (2)2'-6" x 7'-0" x 1 3/4" | _ | 5 | WD | ST | 5 | НМ | PT | ^{7/} A505 | | | 07 | ① ③ |
| 18 | FOLDING DOOR | SEE | SPECIF | ICATION | AND DE | ETAILS | | | ^{1/} A512 | | ^{1/} A512 | | |
| 19 | 3'-0" x 7'-0" x 1 3/4" | - | 4 | WD | ST | 4 | НМ | PT | 7/ A505 | ^{7/} A505 | - | 06 | 0 3 |

SEE SHEET A901 AND SPECS FOR MORE PRODUCT INFORMATION.

COORDINATE KEYING AND CYLINDER LOCK WITH COR. COORDINATE ELECTRONIC ACCESS LOCK WITH COR. SEE SHEET A703 FOR DOOR AND FRAME TYPE ELEVATIONS.

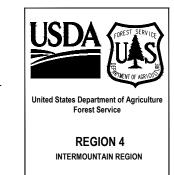

| | STAMPS, LOGOS, AND SEALS | |
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| 2/2 | Regina Freel | |
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FLAMING GORGE RANGER DISTRICT **OFFICE ADDITION**

> **ASHLEY** NATIONAL FOREST

FLAMING GORGE RANGER DISTRICT

DOOR SCHEDULE

| DATE 11/16/2018 | ARCHIV | E NO. |
|--------------------|--------|-------------------|
| DESIGNER C. LEWI | s | DRAWING SHEET NO. |
| DRAWN SMHW | , | A701 |
| CHECKED D. JEPPS | EN | |
| PROJECT NO. 644 | | SHEET 60 OF 119 |


DOOR HARDWARE SCHEDULE

| | DOOK HARDY | VARE SUI | | _ |
|-----|--------------------------------|-------------------------------------|-----------|--------------|
| QTY | ITEM | MODEL | FINISH | MANUFACTURER |
| | GROUP 01: | DOORS 1, 2, ENTRANCE | | |
| 3 | HINGE | 5BB1HW 4.5 x 4.5 NRP | 652/US26D | IVES |
| 1 | PANIC DEVICE | 22L | SP28 | VON DUPRIN |
| 1 | CREDENTIAL ACCESS LOCK | 5831 PIN/ FIPS SMART CARD (PACS) | US26D | KABA E-PLEX |
| 1 | RIM CYLINDER | PRIMUS 20-710 | 626 | SCHLAGE |
| 1 | SURFACE CLOSER | SC71A HD/PA | AL | FALCON |
| 1 | SEALS | 700SA | AL | NGP |
| 1 | DOOR SWEEP | C627A | AL | NGP |
| 1 | THRESHOLD | 425HD | AL | NGP |
| | GROUP 02: | DOORS 7, 15 | | |
| 3 | HINGE | 5BB1HW 4.5 x 4.5 NRP | 652/US26D | IVES |
| 1 | ENTRY/OFFICE LOCK | ND53PD/ F109/ RHODES | 626 | SCHLAGE |
| 1 | SURFACE CLOSER | SC71A RW/PA | AL | FALCON |
| 1 | SMOKE SEAL | 700SA | AL | NGP |
| 1 | DOOR SWEEP | C627A | AL | NGP |
| 1 | WALL STOP (DOORS 5, 7, AND 15) | WS407CCV | 626 | IVES |
| 1 | FLOOR STOP (DOOR 6) | FS17 | 626 | IVES |
| 3 | SILENCER | SR64 | GRY | IVES |
| | GROUP 03: | DOORS 8,9 BATHROOMS | | |
| 3 | HINGE | 5BB1HW 4.5 x 4.5 | 652 | IVES |
| 1 | PASSAGE LOCKSET | ND10S/F109/PHODES | 626 | IVES |
| 1 | SMOKE SEAL | 9800W | BLCK | NGP |
| 1 | SURFACE CLOSER | SC71A RW/PA | AL | FAL |
| 1 | KICK PLATE | 8400 10" x 2" LDW | 626 | IVES |
| 1 | WALL STOP | WS407CCV | 626 | IVES |
| 3 | SILENCER | SR64 | GRY | IVES |
| | GROUP 04: | DOORS 5,6,13, 16 | | |
| 3 | HINGE | 5BB1 4.5 x 4.5 | 652 | IVES |
| 1 | PASSAGE LOCKSET | ND10S/F109/PHODES | 626 | SCHLAGE |
| 1 | WALL STOP | WS407CCV | 626 | IVES |
| 3 | SILENCER | SR64 | GRY | IVES |
| 1 | SURFACE CLOSER | SC71A RW/PA | 689 | FALCON |
| 1 | SMOKE SEAL | 9800W | BLCK | NGP |
| | GROUP 05: | DOOR 4 | | |
| 3 | HINGE | 5BB1HW 4.5 x 4.5 | 652 | IVES |
| 1 | PULL/PUSH BAR COMBO | 9190 (8190 PULL+9100 PUSH) | 626 | IVES |
| 1 | KICK PLATE | 8400 10" x 34" | 626 | IVES |
| 1 | WALL STOP | WS407CCV | 626 | IVES |
| 3 | SILENCER | SR64 | GRY | IVES |
| 1 | SURFACE CLOSER | SC71A HD/PA | AL | FALCON |

DOOR HARDWARE SCHEDULE

| | DOONTIAND | | | _ |
|-----|------------------------|-------------------------------------|--------|--------------|
| QTY | ITEM | MODEL | FINISH | MANUFACTURER |
| | GROUP 06: | DOORS 10, 11, 14, 19 | | |
| 3 | HINGE | 5BB1 4.5 x 4.5 | 652 | IVES |
| 1 | STOREROOM LOCK | ND80PD/ F82/ RHODES | 626 | SCHLAGE |
| 1 | SURFACE CLOSER | SC71A RW/PA | AL | FALCON |
| 1 | KICK PLATE | 8400 10" x 2" LDW | 626 | IVES |
| 1 | WALL STOP | WS407CCV | 626 | IVES |
| 3 | SILENCER | SR64 | GRY | IVES |
| 1 | SMOKE SEAL | 9800W | BLCK | NGP |
| | GROUP 07: | DOOR 17 | | |
| 6 | HINGE | 5BB1 4.5 x 4.5 | 652 | IVES |
| 1 | PASSAGE LOCK | ND10PD/ F84/ RHODES | 626 | SCHLAGE |
| 1 | DUMMY TRIM | ND170/ RHODES | 626 | SCHLAGE |
| 2 | KICK PLATE | 8400 10" x 34" | 626 | IVES |
| 2 | FLOOR STOP | FS17 | 626 | IVES |
| 6 | SILENCER | SR64 | GRY | IVES |
| 2 | TOP/BOTTOM THRU BOLT | ESTATE 0626.150 | 626 | BALDWIN |
| | GROUP 08: | DOORS 3, 12 | | |
| 3 | HINGE | 5BB1HW 4.5 x 4.5 | 652 | IVES |
| 1 | CREDENTIAL ACCESS LOCK | 5831 PIN/ FIPS SMART CARD (PACS) | US26D | KABA E-PLEX |
| 1 | SURFACE CLOSER | SC71A RW/PA | AL | FALCON |
| 1 | WALL STOP | WS407CCV | 626 | IVES |
| 1 | SMOKE SEAL | 9800W | BLCK | NGP |

| DOOR KEYING: | |
|--|--|
| COORDINATE ALL DOOR KEYING GROUPS WITH COR | |

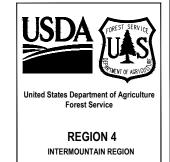

STAMPS, LOGOS, AND SEALS

| 2/2 | Regina Freel | |
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FLAMING GORGE RANGER DISTRICT OFFICE ADDITION

ASHLEY
NATIONAL FOREST


FLAMING GORGE RANGER DISTRICT

DRAWING TITL

HARDWARE SCHEDULE

| DATE 11/16/2018 | ARCHIV | E NO. |
|--------------------|--------|-------------------------------|
| DESIGNER C. LEWI | s | DRAWING SHEET NO. |
| DRAWN SMHW | , | A702 |
| D. JEPPS | EN | |
| PROJECT NO. 644 | | SHEET 61 OF 119 |

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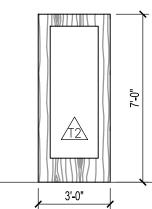


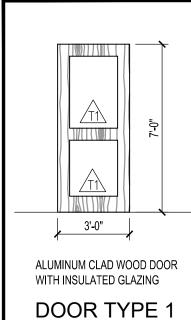JMINUM CLAD WOOD DOOR
ITH INSULATED GLAZING

5 PLY DOUGLAS FIR
TIMBERSTAND CORE WOOD
DOOR W/ SPLIT 3/4 LITE

OR TYPE 1 DOOR TYPE 2


SCALE: 1/4"= 1'-0" SCALE: 1/4"= 1'-0"



5 PLY DOUGLAS FIR TIMBERSTAND CORE WOOD DOOR W/ 3/4 LITE, FIRE GLAZING

DOOR TYPE 3

SCALE: 1/4"= 1'-0"

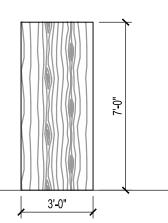


5 PLY DOUGLAS FIR TIMBERSTAND CORE WOOD DOOR

DOOR TYPE 4

SCALE: 1/4"= 1'-0"

A505

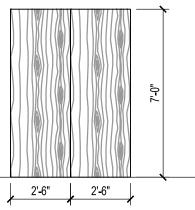

5 PLY DOUGLAS FIR TIMBERSTAND CORE WOOD DOOR

DOOR TYPE 5

SCALE: 1/4"= 1'-0"

9

A505

T1


INSULATED, TEMPERED 1-INCH GLASS UNITS

<u>/12</u>

TEMPERED, 1/4" GLASS

7:-2"

A505

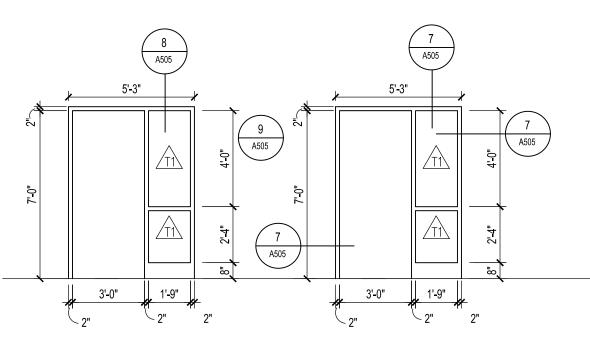

<u>/12\</u>

3'-0"

ALUMINUM CLAD WOOD DOOR FRAME

FRAME TYPE 1

SCALE: 1/4"= 1'-0"

PAINTED HOLLOW METAL DOOR/WINDOW FRAME

FRAME TYPE 2

SCALE: 1/4"= 1'-0"

ALUMINUM CLAD WOOD DOOR

3'-0"

FRAME TYPE 3

SCALE: 1/4"= 1'-0"

PAINTED HOLLOW METAL DOOR/WINDOW FRAME

3'-0"

A505

FRAME TYPE 4

SCALE: 1/4"= 1'-0"

PAINTED HOLLOW METAL DOOR/WINDOW FRAME

A505

FRAME TYPE 5

5'-0"

SCALE: 1/4"= 1'-0"

0 2' 4' 8'

A505

SCALE: 1/4" = 1'-0"



United States Department of Agriculture Forest Service

REGION 4
INTERMOUNTAIN REGION

STAMPS, LOGOS, AND SEALS

s/s Regina Freel

| NO. | REVISION / ISSUE | DATI |
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| 4 | 11/29/18 | |

PROJECT NAME

FLAMING GORGE RANGER DISTRICT OFFICE ADDITION


ASHLEY
NATIONAL FOREST

FLAMING GORGE RANGER DISTRICT


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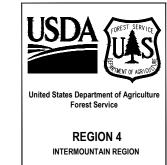
DOOR AND FRAME
TYPE ELEVATIONS

DATE 11/16/2018 ARCHIVE NO. 11/16/2018 DESIGNER C. LEWIS DRAWN SMHW
CHECKED D. JEPPSEN
PROJECT NO. 644 SACCHIVE NO. 11/16/2018 ARCHIVE NO

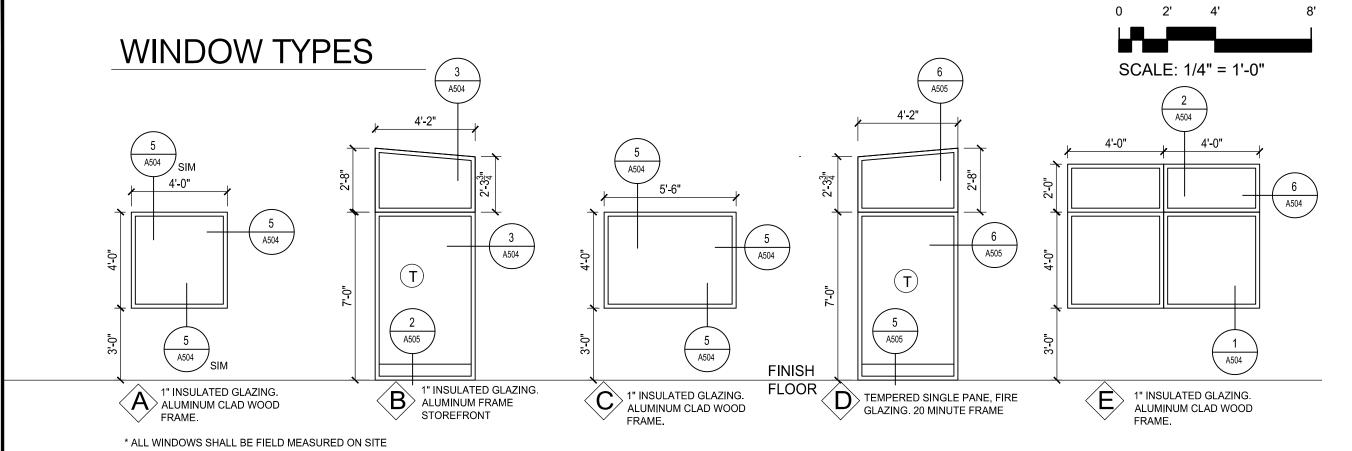

BEFORE FABRICATED.



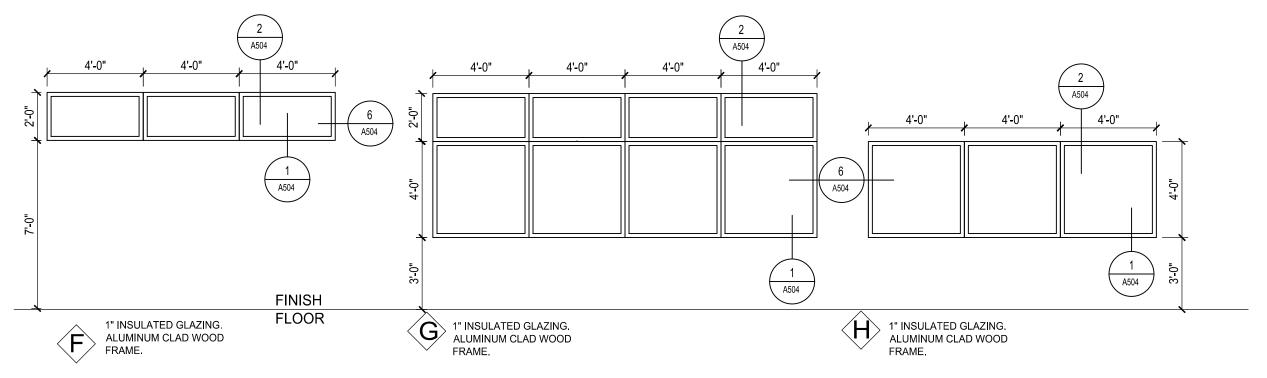

| | STAMPS, LOGOS, AND SEALS | 8 |
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| s/s | . Regina Freel | |
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FLAMING GORGE RANGER DISTRICT **OFFICE ADDITION**


> **ASHLEY** NATIONAL FOREST

FLAMING GORGE RANGER DISTRICT

DRAWING TITLE


WINDOW ELEVATIONS

| DATE 11/16/2018 | ARCHIVI | E NO. |
|---------------------|---------|-------------------|
| DESIGNER C. LEWI | S | DRAWING SHEET NO. |
| DRAWN SMHW | | A801 |
| D. JEPPS | EN | |
| PROJECT NO. 644 | | SHEET 63 OF 119 |

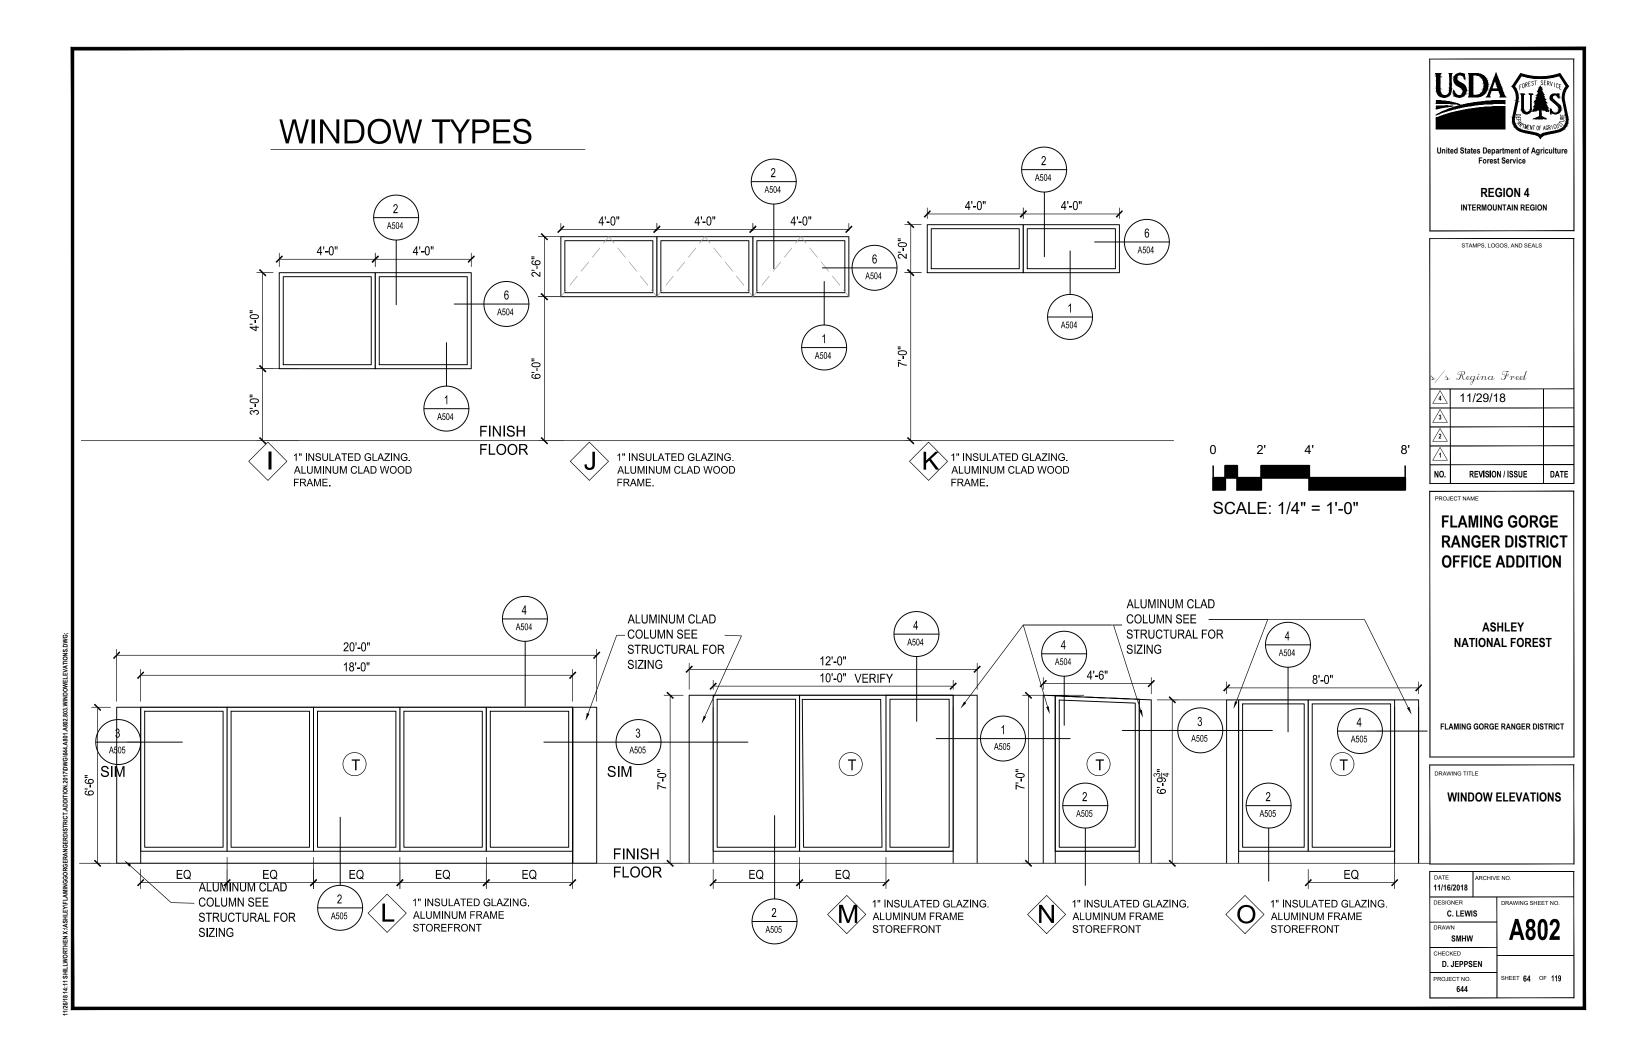

| SYMBOL | FINISH | NOTES (SEE ALSO ROOM FINISH NOTES) |
|--------|---|--|
| | FLOOR | |
| (CP1) | COMMERCIAL GRADE CARPET TILE | BASIS OF DESIGN: TANDUS FLOORING: DISTRICT #03500, COLOR SILVER PLATE #79005 OR APPROVED BY COR |
| (CT1) | CERAMIC TILE(MAIN FLOORS): 12" x 24" CERAMIC TILE(SHOWER FLOORS: 2" x 4" | BASIS OF DESIGN, DALTILE: GLAZED CERAMIC TILE, DALTILE: BALANS "BA32 GREY" OR AS SELECTED BY COR |
| CSC | STAINED, SEALED, AND POLISHED CONCRETE | CONCRETE FLOOR TO BE POLISHED AND SEALED W/ CONCRETE CHEMICAL HARDENDER, SEALER AND DENSIFIE SEE SPECIFICATIONS. |
| EM | ENTRY MAT SYSTEM | BASIS OF DESIGN: PAWLING CORP., SERIES RG-250-AA "DRAIN WELL - #519 NEAR BLACK |
| WF | WOOD FLOORING | 1" X 4" HICKORY, FACTORY FINIHSED WOOD FLOOR/ SEE SPEC. |
| | BASE | |
| СТВ | CERAMIC TILE: 12" x 24" | BASIS OF DESIGN, DALTILE: GLAZED CERAMIC TILE, DALTILE: BALANS "BA31 BEIGE" |
| RB1 | 6" RUBBER BASE | BASIS OF DESIGN: ROPPE - PINNACLE RUBBER BASE, STANDARD TOE, COLOR P194, BURNT UMBER OR AS SELECTED BY COR |
| WB | WOOD BASE | BASIS OF DESIGN: HICKORY 1" X 4" BASE, FACTORY FINISHED |
| | WALLS | |
| CWT | CERAMIC TILE(MAIN FLOORS): 4 X 12" | BASIS OF DESIGN, DALTILE: GLAZED CERAMIC TILE, DALTILE: BALANS "BA31 BEIGE" |
| | 6" TALL WALL ACCENT TILE: | BASIS OF DESIGN, DALTILE ENDEAVORS SERIES. COLOR: F158 MEDITATION |
| (GPW) | TYPE "X" GYPSUM BOARD WALLS. USE WATERPROOF GYP GREEN BRD IN BATHROOMS, AND CUSTODIAL. PAINT WHERE EXPOSED. | BASIS OF DESIGN: SHERWIN WILLIAMS - EIDER WHITE SW 7014 |
| FRP | FRP. (WHERE A WALL TYPE PROVIDES A GYP. BD. SUBSTRA PROVIDE P1 ABOVE & AROUND FRP) | ATE BASIS OF DESIGN "DYNAGLASS BY CHICAGO METALLIC, LITE GREY #405, TEXTURED" |
| | CEILINGS | |
| GPC | TYPE "X" GYPSUM BOARD CEILING. USE WATERPROOF GYP GREEN BRD IN BATHROOMS, AND CUSTODIAL. PAINT WHERE EXPOSED. | BASIS OF DESIGN: SHERWIN WILLIAMS - EIDER WHITE SW 7014 |
| TG | STAINED TONGUE & GROOVE | DOUGLAS FIR W/ SHERWIN WILLIAMS MW 411, BIRCHBARK |

| | PAINT LEGEND | |
|------|--|---|
| P1 | PAINT | BASIS OF DESIGN: SHERWIN WILLIAMS - SW7014 EIDER WHITE |
| | MILLWORK | |
| SF1 | SOLID SURFACE COUNTERTOPS AND SOLID SURFACE SEAT | CORIAN BY DUPONT, COLOR: SILVER BIRCH |
| TP | TOILET PARTITIONS | BASIS OF DESIGN: BOBRICK HIGH PRESSURE LAMINATE: COLOR SHADOW D96-60 |
| LC | HIGH PRESSURE LAMINATE CABINETRY | BASIS OF DESIGN: WILSONART: COCOA LINE Y0608 |
| | WOOD | |
| WS1> | ARCHITECTURAL WOOD DOORS | BASIS OF DESIGN: BIRCH W/ SHERWIN WILLIAMS BRAZILNUT SW 3130-B |
| WS2> | WOOD WINDOW FRAMES | BASIS OF DESIGN: BIRCH W/ SHERWIN WILLIAMS BRAZILNUT SW 3130-B |
| | WINDOW TREATMENT | |
| WDF | WINDOW SHADES | BASIS OF DESIGN: HUNTER DOUGLAS, ROLLER SHADE COLOR AS SELECTED BY COR. SEE SPECIFICATION |
| | EXTERIORS | |
| | PAINTED COMPOSITE SIDING PANELS | BASIS OF DESIGN: HARDIEPLANK "REVEAL" FLAT PANELS SYSTEM COLOR: "GRAY SLATE" PAINT AFTER INSTALLATION TO MATCH |
| | WEATHERING STEEL SIDING | BASIS OF DESIGN: CONCEALED FASTENER WEATHERING STEEL CORTEN PANELS, 0.04 IN. THICK, KOVACH OR APPROVED EQUAL. SEE SPECIFICATION |
| | ALUMINUM CLAD WOOD WINDOWS AND DOORS | COLOR: BRONZE |
| | ALUMINUM FRAME FIXED STOREFRONT | COLOR:BRONZE |
| | DOUG FIR TONGUE AND GROOVE | DOUGLAS FIR W/ SHERWIN WILLIAMS WEATHERED TEAK SW 3134-P |
| | STANDING SEAM METAL ROOFING | METAL ROOFING SEE SPEC., COLOR: WEATHERED GALVALUME OR APPROVED EQUAL |
| | METAL FLASHING | SEE SPEC., COLOR: BRONZE |

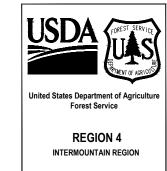

| | STAMPS, LOGOS, AND SEALS | 3 |
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| 5/5 <u>4</u> | Regina Freel | |
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| <u>4</u> | - | |
| <u>4</u> | - | DATE |

FLAMING GORGE RANGER DISTRICT OFFICE ADDITION


ASHLEY
NATIONAL FOREST

FLAMING GORGE RANGER DISTRICT

DRAWING TITLE

FINISH LEGEND

| DATE 11/16/2018 | ARCHIV | E NO. |
|--------------------|--------|-------------------|
| DESIGNER C. LEWIS | | DRAWING SHEET NO. |
| DRAWN SMHW | | A901 |
| CHECKED D. JEPPS | EN | |
| PROJECT NO. 644 | | SHEET 65 OF 119 |

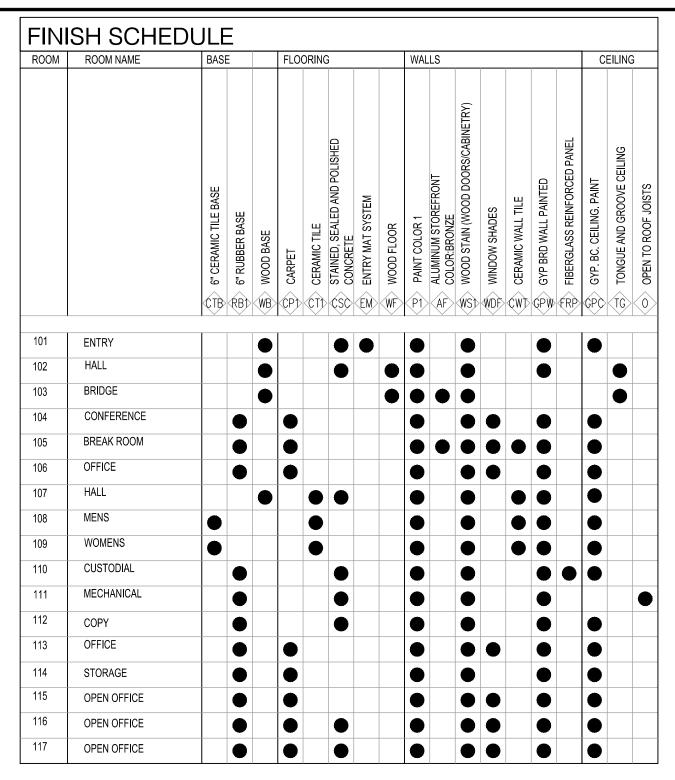

GENERAL NOTES:

SEE FINISH LEGEND ON A901.



United States Department of Agriculture Forest Service

REGION 4
INTERMOUNTAIN REGION

STAMPS, LOGOS, AND SEALS

s/s Regina Freel

| NO. | REVISION / ISSUE | DATE |
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PROJECT NAME

FLAMING GORGE RANGER DISTRICT OFFICE ADDITION

ASHLEY
NATIONAL FOREST

FLAMING GORGE RANGER DISTRICT

DRAWING TITLE

FINISH SCHEDULE

| 11/16/2018 | ARCHIVE NO. | |
|------------------|-------------|-------------------------------|
| DESIGNER C. LEWI | s | DRAWING SHEET NO. |
| DRAWN SMHW | | A 902 |
| D. JEPPS | EN | |
| PROJECT NO. 644 | | SHEET 66 OF 119 |

A: NOTE I IL LAIMINGGONG ENANGENDIO INIC I ADDI I ION. 20 I I DING 1044. ASOU, TINISHLEGENDASONEDOL

PROVIDE BLOCKING IN WALLS FOR ALL EQUIPMENT LISTED BELOW AND SHOWN ELSEWHERE IN DRAWINGS AS REQ'D BY MANUF. RECOMMENDATIONS. ALL ITEMS CONTRACTOR PROVIDED AND CONTRACTOR INSTALLED.

| ALL ITEMS CONTRACTOR PROVIDED AND CONTRACTOR INSTALLED | | | | |
|--|------------------|--------------------------|---------------------|--|
| ITEM | MODEL | ROOM NUMBERS | COMMENTS | |
| 36" STAINLESS STEEL | MODEL: | 108, 1 EA | BOBRICK | |
| GRAB BARS. | B-6806-36 | 109, 1 EA | OR EQUAL | |
| 42" STAINLESS STEEL | MODEL: | 108, 1 EA | BOBRICK | |
| GRAB BARS | B-6806-42 | 109, 1 EA | OR EQUAL | |
| 18" STAINLESS STEEL | MODEL: | 108, 1 EA | BOBRICK | |
| GRAB BARS | B-6806-18 | 109, 1 EA | OR EQUAL | |
| TOILET PAPER HOLDER - | MODEL: | 108, 1 EA | BOBRICK | |
| 1 PER TOILET | B-2888 | 109, 2 EA | OR EQUAL | |
| COUNTER MOUNTED SOAP DISPENSERS | MODEL: | 108, 1 EA | BOBRICK | |
| | B-823 | 109, 1 EA | OR EQUAL | |
| WALL MOUNTED TOWEL DISPENSER AND WASTE RECEPTACLE | MODEL: | 108, 1 EA | BOBRICK | |
| | B-3942 | 109, 1 EA | OR EQUAL | |
| SHOWER GRAB BAR | MODEL: | 108, 1 EA | BOBRICK | |
| (CORNER GRAB BAR) | B-58616 | 109, 1 EA | OR EQUAL | |
| SHOWER | MODEL: | 108, 1 EA | BOBRICK | |
| BENCH SEAT | B-5192 | 109, 1 EA | OR EQUAL | |
| SHOWER | MODEL: | 108, 1 EA | KOHLER | |
| BASKET | K-1896-S | 109, 1 EA | OR EQUAL | |
| 36 x36 STAINLESS STEEL | MODEL: | 108, 1 EA | BOBRICK | |
| MIRROR | B-290 3636 | 109, 1 EA | OR EQUAL | |
| 24 x48 STAINLESS STEEL | MODEL: | 108, 1 EA | BOBRICK | |
| MIRROR | B-290 2448 | 109, 1 EA | OR EQUAL | |
| STAINLESS STEEL ROBE HOOK | MODEL: | 108, 2 EA | BOBRICK | |
| | B-233 | 109, 2 EA | OR EQUAL | |
| STAINLESS STEEL | CUSTOM | 108, 1 EA | BUYRAILINGS.COM | |
| SHOWER CURTAIN ROD | MADE | 109, 1 EA | OR EQUAL | |
| STAINLESS STEEL | MODEL: | 108, 1 EA | BOBRICK | |
| SHOWER CURTAIN ROD | B-207 | 109, 1 EA | OR EQUAL | |
| SANITARY NAPKIN DISPOSAL | MODEL: B-254 | 109, 2 EA | BOBRICK OR EQUAL | |
| LAVATORY WRAP | MODEL:HANDY- | 108, 1 EA | PLUMEREX | |
| | SHIELD-MAXX | 109, 1 EA | OR EQUAL | |
| SHOWER CURTAINS & HOOKS | MODELS: 204-1 | 108, 1 EA, VERIFY W/ COR | BOBRICK | |
| | 204-2 | 109, 1 EA, VERIFY W/ COR | OR EQUAL | |
| SHOWER CURTAINS & HOOKS | MODELS: 1200-SHU | 108, 1 EA, VERIFY W/ COR | ASI AND BOBRICK | |
| FOR CUSTOM CURTAIN ROD | 204-3 | 109, 1 EA, VERIFY W/ COR | OR EQUAL | |
| TOILET SEAT COVER DISPENSER | MODEL: B-221 | 108, 1 EA 109, 2 EA | BOBRICK OR EQUAL | |
| STAINLESS MOP & BROOM | MODEL: | 110, 1 EA | BOBRICK | |
| HOLDER | B-223X 24 | | OR EQUAL | |
| HAND DRYER | MODEL:XLERATOR | 108, 1 EA | EXCEL DRYER | |
| | MODEL XL-SB | 109, 1 EA | OR EQUAL | |

APPLIANCE / EQUIPMENT SCHEDULE

SEE SPECIFICATIONS FOR MORE INFORMATION ON MODELS AND GUIDELINES FOR APPROVED EQUALS.


| - [| | | | | |
|-----|--------------|--|------------------------------|-----------|----------|
| | ITEM | MODEL | ROOM NUME | ERS | COMMENTS |
| | REFRIGERATOR | MODEL: Kenmore 51783, Energy Side-by-Side Refrigerator with Ice a Water Dispenser. Stainless Steel I | and | 105, 1 EA | |
| | MICROWAVE | MODEL: Sharp SMC1442CS, Cou Microwave Oven, Stainless Steel fi | intertop nish. 1.4 cu ft. | 105, 1 EA | |

ROOM SIGNAGE NOTES:


| | QTY. | NOTES: | ROOMS |
|--------|------|---|--|
| SIGN A | 1 | WALL MOUNTED SIGNAGE TO BE LOCATED ON LATCH SIDE OF DOOR CLEAR OF DOOR-SWING. MOUNT AT 60" TO CENTERLINE OF SIGN FROM FLOOR | 109 |
| SIGN B | 1 | WALL MOUNTED SIGNAGE TO BE LOCATED ON LATCH SIDE OF DOOR CLEAR OF DOOR-SWING. MOUNT AT 60" TO CENTERLINE OF SIGN FROM FLOOR | 108 |
| SIGN C | 2 | WALL MOUNTED SIGNAGE TO BE LOCATED ON LATCH SIDE OF DOOR CLEAR OF DOOR-SWING. MOUNT AT 60" TO CENTERLINE OF SIGN FROM FLOOR | 104, 105, 110, 111, 115, 114, 117 |
| SIGN D | 7 | WALL MOUNTED SIGNAGE TO BE LOCATED ON LATCH SIDE OF DOOR CLEAR OF DOOR-SWING. MOUNT AT 60" TO CENTERLINE OF SIGN FROM FLOOR | 106, 113 |

SIGNAGE SCHEDULE:

- 1. ALL INTERIOR SIGNAGE IS TO BE PROVIDED FOR EVERY ROOM & INSTALLED BY THE CONTRACTOR.
- ALL SIGNAGE SHALL MEET ADA REQUIREMENTS.
- 3. U.N.O. SIGNS SHALL BE INSTALLED ON THE WALL ADJACENT TO THE LATCH SIDE OF THE DOOR. IN THE EVENT THIS IS NOT POSSIBLE, NOTIFY CONTRACTING OFFICER AND AWAIT INSTRUCTIONS.
- 4. COLORS AND FONTS SELECTED BY CONTRACTING OFFICER.
- 5. SEE SITE PLAN FOR EXTERIOR SIGN REQUIREMENTS.
- 6. ROOM TITLES SHALL BE GIVEN AND VERIFIED BY CONTRACTING OFFICER.

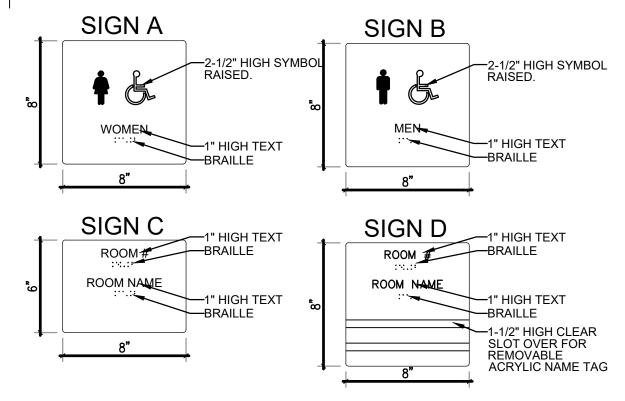



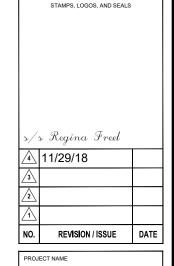

FLAMING GORGE RANGER DISTRICT OFFICE ADDITION

ASHLEY NATIONAL FOREST

FLAMING GORGE RANGER DISTRICT

ACCESSORY/APPLIANCE AND SIGNAGE SCHEDULE


| 11/16/2018 | ARCHIV | E NO. |
|-------------------|--------|-------------------------------|
| DESIGNER | | DRAWING SHEET NO. |
| C. LEWI | S | |
| DRAWN SMHW | | A903 |
| CHECKED D. JEPPS | EN | |
| PROJECT NO. 644 | | SHEET 67 OF 119 |
| | | |


STRUCTURAL NOTES:

A. GENERAL

- 1. THE STRUCTURAL NOTES ARE INTENDED TO COMPLEMENT THE PROJECT SPECIFICATIONS WHICH ARE PART OF THE CONSTRUCTION DOCUMENTS. SPECIFIC NOTES AND DETAILS ON THE DRAWINGS SHALL GOVERN OVER THE STRUCTURAL NOTES AND TYPICAL DETAILS.
- 2. THESE DRAWINGS (AND, WHERE APPLICABLE, ACCOMPANYING WRITTEN SPECIFICATIONS) ARE THE ONLY CONTRACT DOCUMENTS PROVIDED BY ARW ENGINEERS FOR THE PROJECT REPRESENTED HEREIN. NOTHING IN ANY DIGITAL MODEL OR DIGITAL FILE RELATED TO THIS PROJECT SHALL BE TAKEN TO SUPERSEDE ANY INFORMATION SHOWN IN THESE DRAWINGS (INCLUDING, BUT NOT LIMITED TO, DIMENSIONS, SIZES, ETC).
- 3. THE ARCHITECTURAL DRAWINGS ARE THE PRIME CONTRACT DRAWINGS. THE STRUCTURAL DRAWINGS ARE SUPPLEMENTARY TO AND MUST BE USED IN CONJUNCTION WITH THE ARCHITECTURAL DRAWINGS AND OTHER CONSULTANTS DRAWINGS. ALL OMISSIONS OR CONFLICTS BETWEEN THE VARIOUS ELEMENTS OF THE WORKING DRAWINGS AND/OR SPECIFICATIONS SHALL BE BROUGHT TO THE ATTENTION OF THE CONTRACTING OFFICER AND STRUCTURAL ENGINEER BEFORE PROCEEDING WITH ANY WORK INVOLVED. IN CASE OF CONFLICT, FOLLOW THE MOST STRINGENT REQUIREMENT AS DIRECTED BY THE ARCHITECT AT NO ADDITIONAL COST TO THE OWNER.
- 4. SEE SPECIFICATIONS FOR REQUIRED SUBMITTALS. SUBMITTALS SHALL BE MADE IN A TIMELY MANNER AS INDICATED IN SPECIFICATIONS. REVIEW OF SUBMITTALS BY ARW ENGINEERS IS FOR GENERAL COMPLIANCE ONLY AND IS NOT INTENDED AS APPROVAL. CONTRACTOR IS RESPONSIBLE FOR VERIFYING ALL SIZES, DIMENSIONS, AND ELEVATIONS ON SUBMITTALS AS RELATED TO DESIGN DOCUMENTS. PREPARATION OF SHOP DRAWINGS FOR STRUCTURAL ELEMENTS WILL REQUIRE INFORMATION (I.E. DIMENSIONS, ETC.) FOUND IN THE ARCHITECTURAL, STRUCTURAL, AND OTHER CONSULTANTS DRAWINGS.
- 5. THE CONTRACTOR SHALL VERIFY ALL CONDITIONS AND DIMENSIONS AT THE SITE. IF ACTUAL CONDITIONS DIFFER FROM THOSE SHOWN ON CONTRACT DOCUMENTS, CONTRACTOR SHALL NOTIFY CONTRACTING OFFICER PRIOR TO FABRICATION OR CONSTRUCTION OF ANY AFFECTED ELEMENTS.
- 6. THE CONTRACTOR SHALL COORDINATE AND VERIFY ALL LOCATIONS AND SIZES OF MECHANICAL EQUIPMENT OR OTHER EQUIPMENT BEFORE FABRICATING AND ERECTING STRUCTURAL ELEMENTS. SIZES AND LOCATIONS THAT DIFFER FROM THOSE SHOWN ON THE CONTRACT DOCUMENTS SHALL BE REPORTED TO THE CONTRACTING OFFICER.
- 7. THE CONTRACTOR SHALL SUBMIT A WRITTEN REQUEST TO THE CONTRACTING OFFICER FOR CONTRACTING OFFICER APPROVAL BEFORE PROCEEDING WITH ANY CHANGES, MODIFICATIONS, OR SUBSTITUTIONS.
- OBSERVATION VISITS TO THE SITE BY ARW ENGINEERS FIELD REPRESENTATIVES SHALL NEITHER BE CONSTRUED AS INSPECTION NOR APPROVAL OF CONSTRUCTION.
- 9. DURING AND AFTER CONSTRUCTION, BUILDER AND/OR OWNER SHALL KEEP LOADS ON STRUCTURE WITHIN THE LIMITS OF DESIGN LOADS AS NOTED IN THESE DOCUMENTS.
- 10. TYPICAL OR SIMILAR DETAILS AND SECTIONS SHALL APPLY WHERE SPECIFIC DETAILS ARE NOT SHOWN. TYPICAL OR SIMILAR DETAILS REFER TO THE CONDITION ADDRESSED AND ARE NOT NECESSARILY DETAILS LABELED "TYPICAL" OR "SIMILAR" IN THE PLANS AND DOCUMENTS.
- 11. DRAWINGS AND DETAILS HAVE BEEN PREPARED WITH THE INTENT TO VISUALLY REPRESENT INFORMATION PROVIDED IN SCALED FORM; HOWEVER CONTRACTOR/SUPPLIERS SHOULD NOT SCALE PLANS OR DETAILS FOR DIMENSIONAL INFORMATION.
- 12. THE CONTRACTOR SHALL PROVIDE ADEQUATE TEMPORARY SHORING AND BRACING FOR ALL STRUCTURAL ELEMENTS UNTIL THE ENTIRE STRUCTURAL SYSTEM IS COMPLETED. DESIGN OF ALL SHORING AND BRACING IS BY OTHERS AT NO ADDITIONAL COST TO THE OWNER.
- 13. ENGINEER SHALL NOT BE RESPONSIBLE FOR ACTIVITIES UNDER CONTROL OF THE CONTRACTOR SUCH AS CONSTRUCTION SITE SAFETY, MEANS, METHODS AND SEQUENCING OF CONSTRUCTION. ENGINEER SHALL NOT BE RESPONSIBLE FOR FABRICATION, ERECTION AND CONSTRUCTION REQUIREMENTS AS PRESCRIBED BY OSHA OR OTHER REGULATORY AGENCIES REGARDLESS OF INDICATIONS IN THESE DOCUMENTS.
- 14. NOTICE OF COPYRIGHT: THESE STRUCTURAL DRAWINGS ARE HEREBY COPYRIGHTED BY ARW ENGINEERS, ALL RIGHTS RESERVED. THESE DOCUMENTS DEFINE A STRUCTURE AND ARE INSTRUMENTS OF SERVICE, FOR ONE USE ONLY. REPRODUCTION AND DISTRIBUTION OF THESE DRAWINGS IS ONLY ALLOWED AS REQUIRED FOR REGULATORY AGENCIES AND FOR CONVEYANCE OF INFORMATION TO PARTIES INVOLVED IN THE CONSTRUCTION OF THIS PROJECT. THESE DOCUMENTS SHALL NOT BE REPRODUCED OR COPIED, IN PART OR WHOLE BY ANY PARTY FOR USE IN PREPARATION OF SHOP DRAWINGS OR OTHER SUBMITTALS.

| Structural Sheet Index | | |
|-------------------------|-----------------------------|--|
| SHEET NUMBER SHEET NAME | | |
| S001 | STRUCTURAL NOTES | |
| S002 | STRUCTURAL NOTES | |
| S003 | STRUCTURAL NOTES | |
| S004 | STRUCTURAL NOTES | |
| S005 | STRUCTURAL NOTES | |
| S006 | SCHEDULES | |
| S007 | SCHEDULES | |
| S008 | SCHEDULES | |
| S009 | SCHEDULES | |
| S010 | SCHEDULES | |
| S011 | SCHEDULES | |
| S012 | SCHEDULES | |
| S013 | SCHEDULES | |
| S014 | SCHEDULES | |
| S101 | FOOTING AND FOUNDATION PLAN | |
| S102 | ROOF FRAMING PLAN | |
| S201 | DETAILS | |
| S202 | DETAILS | |
| S203 | DETAILS | |
| S204 | DETAILS | |
| S205 | DETAILS | |
| S206 | DETAILS | |
| S207 | DETAILS | |
| S208 | DETAILS | |
| S209 | DETAILS | |
| S401 | SCHEMATIC REFERENCE | |

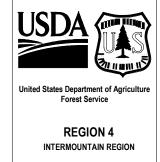

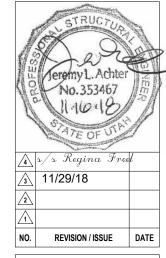

PROJECT NAME

FLAMING GORGE RANGER DISTRICT OFFICE ADDITION

ASHLEY
NATIONAL FOREST

FLAMING GORGE RANGER DISTRICT

STRUCTURAL NOTES

DRAWING TITLE

| 11/16/2018 | ARCHIVE NO. |
|------------------------|-------------------|
| DESIGNER JLA | DRAWING SHEET NO. |
| DRAWN RK | S001 |
| CHECKED | |
| PROJECT NO. 18037.A | SHEET 68 OF 119 |

B. STATEMENT OF SPECIAL INSPECTIONS AND SPECIAL INSPECTIONS

- 1. THE DESIGNATED SEISMIC/WIND SYSTEMS AND SEISMIC/WIND-FORCE-RESISTING SYSTEMS THAT ARE SUBJECT TO SPECIAL INSPECTIONS IN ACCORDANCE WITH IBC SECTION 1705.11 AND 1705.12 ARE IDENTIFIED ON THESE DOCUMENTS WITH A CIRCLE "L". ALL OTHER ITEMS REQUIRING SPECIAL INSPECTION ARE IDENTIFIED IN THE SPECIAL INSPECTIONS SCHEDULE ON SHEET S010-S014.
- SPECIAL INSPECTIONS AND TESTING ARE TO BE PROVIDED AS REQUIRED BY IBC SECTIONS
 1704 THROUGH 1705 AND OTHER APPLICABLE SECTIONS OF THE IBC. THE TYPE AND
 FREQUENCY OF TESTING AND SPECIAL INSPECTIONS SHALL BE AS NOTED IN THE SPECIAL
 INSPECTION SCHEDULE, JOB SPECIFICATIONS, AND ACCORDANCE WITH IBC SECTION 110 AND
 CHAPTER 17. CONTRACTOR SHALL COORDINATE AND COOPERATE WITH REQUIRED
 INSPECTIONS.
- 3. ALL TESTING AND SPECIAL INSPECTION SHALL BE PROVIDED BY A QUALIFIED INDEPENDENT SPECIAL INSPECTION AGENCY IN ACCORDANCE WITH IBC 1704 AND AS OUTLINED IN THE JOB SPECIFICATIONS. REPORTS OF FINDINGS OR DISCREPANCIES SHALL BE NOTED AND FORWARDED TO THE CONTRACTING OFFICER IN A TIMELY MANNER.
- . STRUCTURAL OBSERVATION VISITS SHALL BE PERFORMED BY A REPRESENTATIVE FROM ARW ENGINEERS IN ACCORDANCE WITH THE CONTRACT AS NEEDED TO OBSERVE THE CONSTRUCTION OF CRITICAL BUILDING ELEMENTS (I.E. FOOTINGS, BRACED FRAMES, MOMENT FRAMES, DRAG STRUTS AND THEIR CONNECTIONS, COLLECTORS, AND ROOF AND FLOOR DIAPHRAGMS). STRUCTURAL OBSERVATION REPORTS FOR EACH VISIT SHALL BE SENT DIRECTLY TO THE ARCHITECT FOR DISTRIBUTION TO THE CONTRACTOR AND BUILDING OFFICIAL. STRUCTURAL OBSERVATION VISITS SHALL NEITHER BE CONSTRUED AS SPECIAL INSPECTION NOR APPROVAL OF COMPLETED CONSTRUCTION.
- 5. IN ACCORDANCE WITH IBC 1704.4, THE CONTRACTOR SHALL SUBMIT A WRITTEN CONTRACTOR'S STATEMENT OF RESPONSIBILITY TO THE CONTRACTING OFFICER AND OWNER. THE STATEMENT SHALL BE SUBMITTED PRIOR TO THE CONSTRUCTION OF ANY SEISMIC/WIND-FORCE-RESISTING SYSTEM, DESIGNATED SEISMIC/WIND SYSTEM, OR COMPONENT IDENTIFIED IN THESE DOCUMENTS WITH A CIRCLE "L".

C. BASIS OF DESIGN

- 1. GOVERNING BUILDING CODE : INTERNATIONAL BUILDING CODE (IBC) 2015 RISK CATEGORY : II
- 2. FLOOR LOADS
 - a. LIVE LOAD = 100 PSF
 - b. DEAD LOAD = AS REQUIRED
- 3. ROOF LOADS
 - a. FLAT-ROOF SNOW LOAD, Pf: 30 PSF
 - 1. GROUND SNOW LOAD, Pa: 43 PSF
 - 2. SNOW EXPOSURE FACTOR, Ce: 1.0
 - 3. SNOW LOAD IMPORTANCE FACTOR, Is: 1.0
 - 4. THERMAL FACTOR, Ct: 1.0
 - b. LIVE LOAD = 20 PSF
 - c. DEAD LOAD = 20 PSF
- 4. WIND DESIGN
 - a. BASIC WIND SPEED (3 SECOND GUST): 115 MPH
 - b. WIND EXPOSURE: C
 - c. COMPONENT AND CLADDING DESIGN WIND PRESSURE SHALL BE AS REQUIRED PER ASCE 7-10.
- 5. SEISMIC DESIGN:
 - a. SEISMIC IMPORTANCE FACTOR, I_E: 1.0
 - b. SITE CLASS: D
 - c. MAPPED SPECTRAL RESPONSE ACCELERATIONS : $S_S = 0.310$, $S_1 = 0.102$
 - d. SPECTRAL RESPONSE COEFFICIENTS: S_{DS} = 0.321, S_{D1} = 0.162
 - e. SEISMIC DESIGN CATEGORY: C
 - f. BASIC SEISMIC-FORCE-RESISTING SYSTEM: LIGHT FRAMED WALLS SHEATHED W/ WOOD STRUCTURAL PANELS
 - g. DESIGN BASE SHEAR: $V_{N-S} = C_S X W$, $V_{E-W} = C_S X W$
 - h. SEISMIC RESPONSE COEFFICIENT, Cs: 6.05
 - i. RESPONSE MODIFICATION FACTOR, R: 6.5
 - j. ANALYSIS PROCEDURE: EQUIVALENT LATERAL FORCE PROCEDURE

D. FOUNDATION

- 1. DESIGN SOIL PRESSURE: 1500 PSF
- 2. SOILS REPORT BY: TODD TOUCHARD, P.E., USFS INTERMOUNTAIN REGION DATED: FEBRUARY 2, 2018
- 3. SOIL PREPARATION UNDER FOOTINGS AND SLABS-ON-GRADE SHALL BE IN ACCORDANCE WITH THE SOILS REPORT.
- 4. TOP OF FOOTING ELEVATIONS SHOWN ON THE FOOTING AND FOUNDATION PLAN ARE BASED ON PRELIMINARY GRADING INFORMATION AND MUST BE VERIFIED PRIOR TO CONSTRUCTION. STEPS WHERE SHOWN ARE AT APPROXIMATE LOCATIONS. ALL EXTERIOR FOOTINGS MUST BEAR A MINIMUM OF 30 INCHES BELOW LOWEST ADJACENT FINAL GRADE.
- 5. ALL WALLS (EXCEPT CANTILEVERED RETAINING WALLS) SHALL BE ADEQUATELY BRACED AGAINST LATERAL MOVEMENT PRIOR TO BACKFILLING. DESIGN AND ERECTION OF BRACING/SHORING IS THE RESPONSIBILITY OF THE GENERAL CONTRACTOR. BRACING SHALL REMAIN IN PLACE UNTIL SUPPORTING STRUCTURAL ELEMENTS ARE IN PLACE AND HAVE ATTAINED FULL STRENGTH.
- UNLESS NOTED OTHERWISE, ALL FOOTINGS AT COLUMNS TO BE CENTERED BELOW COLUMNS.
- 7. UNLESS NOTED OTHERWISE, ALL FOOTINGS SHALL HAVE VERTICAL FACES FORMED WITH STANDARD FORMING MATERIALS (WOOD, METAL, ETC.). WITH PRIOR APPROVAL OF CONTRACTING OFFICER, CONCRETE FOR FOOTINGS CAN BE PLACED IN EXCAVATED "SOIL" FORMS PROVIDED THAT THE DIMENSIONS ARE INCREASED 3" ON EACH SIDE.

E. CONCRETE


- 1. ALL CONCRETE MIX DESIGNS SHALL COMPLY WITH THE REQUIREMENTS LISTED BELOW:
 - a. FOOTINGS (EXPOSURE CATEGORY F0):
 - 1. 28 DAY COMPRESSIVE STRENGTH: 3000 PSI
 - b. FOUNDATION WALLS (EXPOSURE CATGEORY F1):
 - 1. 28 DAY COMPRESSIVE STRENGTH: 4500 PSI
 - 2. MAXIMUM W/C RATIO: 0.45
 - 3. MAXIMUM AGGREGATE SIZE : 1"
 4. AIR CONTENT : 4.5% +/- 1.5%
 - c. INTERIOR SLABS ON GRADE (EXPOSURE CATEGORY F0):
 - 1. 28 DAY COMPRESSIVE STRENGTH: 3000 PSI
 - d. EXTERIOR SLABS (DOCKS, ETC.) (EXPOSURE CATEGORY F1):
 - 1. 28 DAY COMPRESSIVE STRENGTH: 4500 PSI
 - 2. MAXIMUM W/C RATIO:
 - 3. MAXIMUM AGGREGATE SIZE: 1"
 - 4. MINIMUM AIR CONTENT: 4.5% +/- 1.5%
- 2. WATER USED IN MIXING CONCRETE SHALL CONFORM TO ASTM C1602.
- 3. NO PIPES, DUCTS, SLEEVES, ETC. SHALL BE PLACED IN STRUCTURAL CONCRETE UNLESS SPECIFICALLY DETAILED OR APPROVED BY THE STRUCTURAL ENGINEER. NO ALUMINUM PRODUCTS SHALL BE EMBEDDED IN CONCRETE. PENETRATIONS THRU STRUCTURAL CONCRETE ELEMENTS MUST BE APPROVED BY THE ENGINEER AND SHALL BE BUILT INTO THE ELEMENT PRIOR TO CONCRETE PLACEMENT.


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- 4. REFER TO ARCHITECTURAL DRAWINGS FOR MOLDS, GROOVES, ORNAMENTS, ETC. TO BE CAST IN TO CONCRETE, AND FOR EXTENT AND LOCATION OF DEPRESSIONS, CURBS, RAMPS, ETC.
- . UNLESS NOTED OTHERWISE, MINIMUM REINFORCING IN ALL CONCRETE WALLS SHALL BE AS FOLLOWS:

TOP &

THICKNESS BOTTOM BARS VERTICAL HORIZONTAL 8" (2) #5 #5 AT 12"O.C. #5 AT 12"O.C.



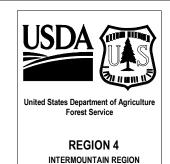

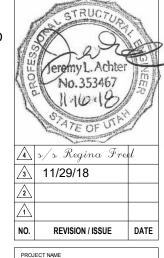FLAMING GORGE RANGER DISTRICT OFFICE ADDITION

ASHLEY
NATIONAL FOREST

FLAMING GORGE RANGER DISTRICT

DRAWING TITLE

STRUCTURAL NOTES

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| CHECKED JLA | |
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- 6. UNLESS NOTED OTHERWISE, CONCRETE SLABS ON EARTH SHALL BE REINFORCED AS FOLLOWS: 4" THICK UNREINFORCED
- REINFORCING SHALL BE CONTINUOUSLY SUPPORTED AT 36"O.C. MAXIMUM SPACING.
- 7. UNLESS NOTED OTHERWISE, FOR NON-DETAILED OPENINGS IN CONCRETE WALLS LARGER THAN 12" AND SMALLER THAN 24" IN ANY DIRECTION ADD (2) #5 BARS ON ALL SIDES IN ADDITION TO REGULAR WALL REINFORCING AND EXTEND 24" EACH WAY BEYOND OPENING. IF 24" IS NOT AVAILABLE ON EVERY SIDE, NOTIFY STRUCTURAL ENGINEER FOR FURTHER DIRECTION. OPENINGS SHALL HAVE A MINIMUM OF 12" OF CONCRETE ABOVE THE OPENING, TYP.
- 8. CONSTRUCTION JOINTS NOT SHOWN ON THE PLANS SHALL BE MADE AND LOCATED SO AS TO NOT IMPAIR THE STRENGTH OF THE STRUCTURE AND AS APPROVED BY THE STRUCTURAL ENGINEER. PROVIDE 2 X 4 (SHAPED) KEYWAY IN ALL VERTICAL AND HORIZONTAL JOINTS UNLESS NOTED OR DETAILED OTHERWISE. ALL STEEL REINFORCING SHALL BE CONTINUOUS THROUGH COLD JOINTS UNLESS NOTED OTHERWISE. SEE TYPICAL DETAILS FOR COLD/CONSTRUCTION JOINTS FOR SLABS ON GRADE.

F. ANCHOR BOLTS/EMBEDDED BOLTS

- 1. ALL ANCHOR BOLTS SHALL HAVE ASTM A-563 HEAVY HEX NUT AND ASTM F-436 WASHERS AT STANDARD OR OVERSIZED HOLES PER AISC SPECIFICATION TABLE J3.3. WHERE HOLE SIZES DO NOT COMPLY WITH THE LIMITATIONS FOR OVERSIZED HOLES THE STRUCTURAL ENGINEER SHALL BE NOTIFIED TO DETERMINE STEEL PLATE WASHER REQUIREMENTS. ANCHOR BOLTS SHALL COMPLY WITH THE FOLLOWING:
 - a. AT WOOD STUD WALLS ASTM A-307 GRADE HEADED BOLTS. ANCHOR BOLTS IN TREATED LUMBER SHALL BE GALVANIZED OR STAINLESS STEEL. SEE TIMBER NOTES FOR MORE INFORMATION.
 - b. AT ALL OTHER ANCHOR BOLTS (UNLESS NOTED OTHERWISE) ASTM F1554 GRADE 36 HEADED BOLTS. (ASTM A36 THREADED ROD MAY BE USED WITH DOUBLE NUT AND WASHER.)
- 2. SEE TYPICAL ANCHOR BOLT DETAIL FOR DEFINITIONS OF EMBEDMENT LENGTH, ETC.
- 3. FURNISH TEMPLATES AND OTHER DEVICES AS NECESSARY FOR PRESETTING ALL BOLTS PRIOR TO PLACING CONCRETE AND/OR GROUT.
- 4. IF THREADED RODS ARE USED AS PERMITTED ABOVE, THEY SHALL BE CLEAR OF SOIL AND DIRT.
- 5. WHERE REQUIRED FOR ERECTION, HOLES LARGER THAN OVERSIZED MAY BE PERMITTED WITH THE USE OF STEEL PLATE WASHERS AT THE DISCRETION OF THE STRUCTURAL ENGINEER.


G. ADHESIVE/MECHANICAL ANCHORS


- 1. ALL ADHESIVE/MECHANICAL ANCHORS SHALL BE INSTALLED, INCLUDING HOLE DRILLING AND PREPARATION, IN ACCORDANCE WITH AN APPROVED INDEPENDENT EVALUATION REPORT (ICC-ES, IAPMO, OR APPROVED EQUAL), AS INDICATED BELOW, AND IN ACCORDANCE WITH ALL MANUFACTURER'S PRINTED INSTALLATION INSTRUCTIONS (MPII).
- 2. ADHESIVE ANCHORS SHALL BE INSTALLED IN CONCRETE HAVING A MINIMUM AGE OF 21 DAYS AT TIME OF ANCHOR INSTALLATION. ADHESIVE ANCHORS SHALL NOT BE FULLY LOADED UNTIL CONCRETE HAS REACHED DESIGN STRENGTH.
- 3. UNLESS APPROVED BY THE ENGINEER OF RECORD, CONCRETE AND DRILLED ANCHOR HOLES SHALL BE DRY AND FREE OF WATER FOR 24 HOURS PRIOR TO ADHESIVE INSTALLATION. CONTACT THE ENGINEER OF RECORD FOR GUIDANCE IF THE CONTRACTOR CHOOSES TO INSTALL IN WET OR DAMP HOLES.
- 4. CONCRETE TEMPERATURE AT THE TIME OF INSTALLATION SHALL BE MONITORED BY THE CONTRACTOR. CONTRACTOR SHALL COMPLY WITH ALL MANUFACTURER'S PRINTED INSTALLATION INSTRUCTIONS (MPII) RELATIVE TO SUBSTRATE TEMPERATURE.
- 5. INSTALLATION OF ADHESIVE ANCHÓRS HORIZONTALLY OR UPWARDLY INCLINED TO SUPPORT SUSTAINED TENSION LOADS SHALL BE PERFORMED BY PERSONNEL CERTIFIED BY AN APPLICABLE CERTIFICATION PROGRAM. CERTIFICATION SHALL INCLUDE WRITTEN AND PERFORMANCE TESTS IN ACCORDANCE WITH THE ACI/CRSI ADHESIVE ANCHOR INSTALLER CERTIFICATION PROGRAM, OR EQUIVALENT IN ACCORDANCE WITH ACI 318-11 D.9.2.2. PROOF OF CURRENT CERTIFICATION SHALL BE SUBMITTED TO THE ENGINEER FOR APPROVAL PRIOR TO INSTALLATION. CONTINUOUS SPECIAL INSPECTION SHALL BE PROVIDED FOR THESE ANCHORS.

- 6. UNLESS NOTED OTHERWISE, ALL ADHESIVE ANCHORS INTO CONCRETE SHALL BE:
 - a. HILTI HIT-RE 500V3 (ESR-3814), OR HILTI HIT-HY 200 (ESR-3187).
- b. SIMPSON SET-XP (ESR-2508), OR AT-XP (ER-0263).
- c. DEWALT PURE 100+ (ESR-2322), OR AC100+ GOLD (ESR-2592-COLD WEATHER).
- 7. UNLESS NOTED OTHER WISE, ALL MECHANICAL ANCHORS INTO CONCRETE SHALL BE:
 - a. HILTI KWIK BOLT TZ (ESR-1917).
 - b. DEWALT POWER STUD+ SD2 (ESR-2502).
 - c. SIMPSON STRONG-BOLT 2 (ESR-3037).
- 8. UNLESS NOTED OTHERWISE, ALL SCREW ANCHORS INTO CONCRETE SHALL BE:
 - a. SIMPSON TITEN HD (ESR-2713).
 - b. DEWALT SCREWBOLT+ (ESR-2526).
 - c. HILTI KWIK HUS-EZ (ESR-3027).
- 9. THE TESTING LABORATORY WILL PERFORM VISUAL INSPECTION OF ANCHORS AND DOWELS AS SPECIFIED IN THE SPECIAL INSPECTION SCHEDULE AND THE APPROVED INDEPENDENT EVALUATION REPORT. TENSION TESTING CAN BE REQUIRED AT THE DIRECTION OF THE STRUCTURAL ENGINEER OF RECORD OR THE SPECIAL INSPECTOR.
- 10. IF REINFORCEMENT IS ENCOUNTERED DURING DRILLING, ABANDON THAT HOLE AND SHIFT THE ANCHOR LOCATION TO AVOID THE REINFORCEMENT. PROVIDE A MINIMUM SPACE OF (2) ANCHOR HOLE DIAMETERS OR 1 INCH, WHICH EVER IS LARGER, OF SOUND CONCRETE/MASONRY BETWEEN THE ANCHOR AND THE ABANDONED HOLE. FILL THE ABANDONED HOLE WITH NON-SHRINK GROUT. AT CONTRACTORS OPTION, LOCATE EXISTING REINFORCMENT PRIOR TO DRILLING/CORING. IF THE ANCHOR OR DOWEL CANNOT BE SHIFTED AS NOTED ABOVE, THE ENGINEER WILL DETERMINE A NEW LOCATION.
- 11. LOCATE REINFORCEMENT AND CONFIRM FINAL ANCHOR LOCATIONS PRIOR TO FABRICATING PLATES, MEMBERS, OR OTHER STEEL ASSEMBLIES ATTACHED WITH MECHANICAL ANCHORS.
- 12. SUBSTITUTION REQUESTS FOR ALTERNATE PRODUCTS SHALL BE APPROVED IN WRITING BY THE STRUCTURAL ENGINEER OF RECORD PRIOR TO USE. SUBSTITUTION REQUESTS SHALL INCLUDE AN ICC ESR OR IAPMO REPORTAND SUPPORTING CALCULATIONS INDICATING COMPLIANCE WITH DESIGN INTENT.

H. REINFORCING STEEL

- 1. REINFORCING BAR STRENGTH REQUIREMENTS:
 - a. ALL REINFORCING BARS SHALL CONFORM TO ASTM STANDARD A-615 GRADE 60 AND ALL WELDED WIRE FABRIC SHALL CONFORM TO ASTM STANDARD A-1064 AND SHALL BE SUPPLIED IN FLAT SHEETS. ADEQUATELY TIE AND SUPPORT ALL REINFORCING STEEL AS SPECIFIED BY ACI 117, TO MAINTAIN EXACT REQUIRED POSITION.
- 2. STEEL DISCONTINUOUS FIBER REINFORCEMENT SHALL BE DEFORMED AND CONFORM TO ASTM A820 AND SHALL HAVE A LENGTH TO DIAMETER RATIO NOT SMALLER THAN 50 AND NOT GREATER THAN 100.
- 3. HEADED DEFORMED BARS SHALL CONFORM TO ASTM A970. OBSTRUCTIONS OR INTERRUPTIONS OF THE BAR DEFORMATIONS, IF ANY, SHALL NOT EXTEND MORE THAN 2 BAR DIAMETERS FROM THE BEARING FACE OF THE HEAD.
- I. ALL FIELD BENT DOWELS SHALL BE GRADE 40 WITH SPACING INDICATED REDUCED BY 1/3.
- 5. UNLESS NOTED OTHERWISE, REINFORCEMENT SHALL HAVE THE FOLLOWING CONCRETE COVERAGE:
- a. CAST AGAINST AND PERMANENTLY EXPOSED TO EARTH 3"
- D. EXPOSED TO EARTH OR WEATHER:
 - 1. #6 & LARGER 2"
- 2. #5 & SMALLER1-1/2"
- c. NOT EXPOSED TO WEATHER OR EARTH:
 - 1. SLABS, WALLS, JOISTS, #11 & SMALLER 3/4"
 - 2. BEAMS, COLUMNS: MAIN REINFORCING OR TIES 1-1/2"
- d. SLAB ON GRADE:
 - 1. PLACE REINFORCING AT CENTER OF SLAB UNLESS INDICATED OTHERWISE.
- 6. EXCEPT WHERE NOTED ON PLANS OR DETAILS CONTINUOUS REINFORCEMENT SHALL BE SPLICED AT POINTS OF MINIMUM STRESS BY LAPPING PER THE REBAR LAP SCHEDULE.

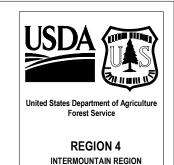

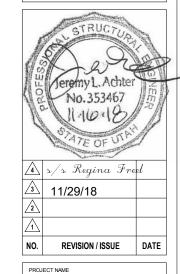

FLAMING GORGE RANGER DISTRICT OFFICE ADDITION

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- 7. REINFORCING STEEL MAY BE SPLICED WITH MECHANICAL COUPLERS THAT HAVE A TENSION CAPACITY OF AT LEAST 125% OF THE STRENGTH OF THE BAR. MECHANICAL COUPLERS SHALL BE A POSITIVE CONNECTING TYPE COUPLER, AND SHALL BE INSTALLED IN ACCORDANCE WITH AN APPROVED ICC RESEARCH REPORT. WHERE THESE ARE USED, SPLICES ON ADJACENT BARS SHALL BE STAGGERED AT LEAST 24 INCHES ALONG THE LENGTH OF THE BARS.
- 8. ALL VERTICAL REINFORCING IN STRUCTURAL ELEMENTS ABOVE SHALL BE SPLICED WITH MATCHING DOWELS EMBEDDED WITHIN THE FOOTINGS OR STRUCTURE BELOW. SPLICE LENGTHS SHALL COMPLY WITH REBAR LAP SCHEDULE. DOWELS INTO FOOTINGS SHALL TERMINATE WITH A STANDARD HOOK, AND SHALL EXTEND TO WITHIN 4" OF THE BOTTOM OF THE FOOTING, BUT NEED NOT EXTEND MORE THAN 20" INTO FOOTING.
- 9. DO NOT WELD REINFORCING EXCEPT AS NOTED ON PLANS, WHERE REINFORCING IS WELDED, USE ASTM A-706 REINFORCING.
- 10. REINFORCING BARS, TIES, AND TENDONS SHALL BE SUPPORTED BY NYLON CONES, PLASTIC-COATED TIE-WIRES, OR PLASTIC-COATED CHAIRS. REINFORCING IN FOOTINGS IS PERMITTED TO BE SUPPORTED ON CONCRETE DOBIES.
- 11. UNLESS NOTED OTHERWISE, HOOKS, STIRRUPS, TIES, AND OTHER BENDS IN REINFORCING STEEL SHALL MEET THE STANDARDS SET FORTH IN ACI 318/318R-14. UNLESS OTHERWISE PERMITTED BY THE ENGINEER, ALL REINFORCEMENT SHALL BE BENT COLD. REINFORCEMENT PARTIALLY EMBEDDED IN CONCRETE SHALL NOT BE FIELD BENT, EXCEPT AS SHOWN ON THESE DRAWINGS OR OTHERWISE PERMITTED BY THE ENGINEER.
- 12. UNLESS SPECIFICALLY NOTED AND/OR DETAILED IN THE STRUCTURAL DRAWINGS CONDUIT SHALL NOT BE IN CONTACT WITH REINFORCING STEEL.

I. STRUCTURAL STEEL

- STRUCTURAL STEEL SHALL BE FABRICATED AND ERECTED IN ACCORDANCE WITH THE LATEST EDITION OF THE FOLLOWING:
 - a. ANSI/AISC 360-10 "SPECIFICATION FOR STRUCTURAL STEEL BUILDINGS", WITH "COMMENTARY" AND "SUPPLEMENTS" AS REQUIRED BY BUILDING CODE.
 - b. AISC 303-10 "CODE OF STANDARD PRACTICE FOR STEEL BUILDINGS AND BRIDGES" EXCLUDING THE FOLLOWING SECTIONS: 4.4, 4.4.1, AND 4.4.2.
 - c. AISI "SPECIFICATIONS FOR THE DESIGN OF COLD-FORMED STEEL STRUCTURAL MEMBERS".
 - d. AISC "SPECIFICATION FOR STRUCTURAL JOINTS USING ASTM A325 OR A490 BOLTS"
 - e. AWS D1.1 AND 1.3, "STRUCTURAL WELDING CODE" (EXCEPT SPECIFIC ITEMS DO NOT APPLY IF THEY CONFLICT WITH AISC).
 - f. ANSI/AISC 341-10 "SEISMIC PROVISIONS FOR STRUCTURAL STEEL BUILDINGS".
- 2. STRUCTURAL STEEL SHALL COMPLY WITH THE FOLLOWING:
 - a. WIDE FLANGE SHAPES AND WT SHAPES ASTM A992
 - b. OTHER SHAPES AND PLATES ASTM A-36 (UNO)
 - c. TUBES (TS) AND HOLLOW STRUCTURAL SECTIONS (HSS) ASTM A-500, GRADE B (SQUARE AND RECTANGULAR SHAPES FY = 46 KSI AND ROUND SHAPES FY = 42 KSI)
 - d. PIPE COLUMNS ASTM A-53, GRADE B TYPE E OR S
 - e. STAINLESS STEEL SHAPES, PLATES, AND FASTENERS ASTM 304
 - f. DEFORMED BAR ANCHORS (DBA) ASTM A-496, WELDED IN ACCORDANCE WITH AWS D1.1
 - g. HEADED STUD ANCHORS (HSA) ASTM A-108, GRADE 1015 STEEL AND WELDED IN ACCORDANCE WITH AWS D1.1 FOR TYPE "B". USE 3/4" DIAMETER STUDS, UNLESS NOTED OTHERWISE.
 - h. THREADED ROD ASTM A-449.
 - NON-SHRINK GROUT ASTM C110. NON-SHRINK GROUT SHALL BE PRE-PACKAGED, NON-METALLIC, WITH A 28-DAY COMPRESSIVE STRENGTH OF 6,000 PSI.
- CONNECTIONS SHALL COMPLY WITH THE STRUCTURAL DRAWINGS UNLESS WRITTEN APPROVAL TO CHANGE IS GIVEN BY THE STRUCTURAL ENGINEER.
- 4. ALL SHOP FABRICATIONS SHALL BE PERFORMED BY AN APPROVED FABRICATOR IN ACCORDANCE WITH SECTIONS 1702 AND 1704 OF THE IBC OR WITH SHOP INSPECTION BY AN INDEPENDENT AGENCY IN ACCORDANCE WITH SECTION 1704.2.5 OF THE IBC.

5. WELDING


- a. ALL WELDING AND CUTTING SHALL BE PERFORMED BY AWS QUALIFIED WELDERS IN ACCORDANCE WITH ANSI/AWS D1.1 (LATEST EDITION).
- b. USE E-70XX ELECTRODES UNLESS NOTED OTHERWISE.
- E. ALL INTERSECTING STEEL SHAPES WHICH ARE NOT CONNECTED WITH BOLTS SHALL BE WELDED TOGETHER WITH A FILLET WELD ALL AROUND UNLESS NOTED OTHERWISE. WHERE WELD SIZES ARE NOT SHOWN USE THE FOLLOWING:
- 1. WHERE ALL CONNECTED PARTS ARE THICKER THAN 1/4", WELD IS 1/16" LESS THAN THE THICKNESS OF THE THINNEST PART.
- 2. WHERE ANY OF THE CONNECTED PARTS IS LESS THAN 1/4" THICK, WELD IS SAME AS THICKNESS OF THE THINNEST PART.
- d. WELDING OF HSA'S AND DBA'S SHALL CONFORM TO THE MANUFACTURER'S SPECIFICATIONS.
- e. WHEREVER POSSIBLE, WELDS SHALL BE SHOP WELDS. SPECIAL CONSIDERATIONS, SUCH AS ITEMS WHICH MAY NEED ADJUSTMENT AT THE SITE, REQUIRE THAT SOME WELDS BE FIELD WELDS. WHERE QUESTIONS OR DISCREPANCIES OCCUR THE CONTRACTOR SHALL COORDINATE THE WORK BETWEEN THE SHOP FABRICATOR AND THE STEEL ERECTOR.


6. BOLTING

- a. UNLESS NOTED OTHERWISE, ALL STRUCTURAL STEEL TO STEEL CONNECTIONS SHALL USE HIGH STRENGTH BOLTS CONFORMING TO ASTM A-325.
- b. UNLESS NOTED OTHERWISE, ALL BOLTING IS CLASSIFIED AS NON-SLIP CRITICAL BEARING TYPE CONNECTIONS WITH THREADS INCLUDED IN SHEAR PLANE. TIGHTEN BOLTS TO A SNUG TIGHT CONDITION, WITH ALL PLIES OF THE JOINT IN FIRM CONTACT.
- c. WHERE OVERSIZED OR SLOTTED HOLES OCCUR IN THE OUTER PLY, AN ASTM F436 WASHER OR 5/16" THICK COMMON PLATE WASHER SHALL BE USED AS REQUIRED TO COMPLETELY COVER THE HOLE.
- d. BOLTS SHALL BE CENTERED IN SLOTTED HOLES, UNLESS NOTED OTHERWISE.
- e. WHERE A STEEL BEAM TO BEAM CONNECTION IS NOT SHOWN, PROVIDE AN AISC STANDARD FRAMED CONNECTION SIZED FOR 1/2 OF THE TOTAL LOAD CAPACITY OF THE BEAM FOR THE SPAN AND STEEL SPECIFIED.
- 7. UNLESS NOTED OTHERWISE, WHERE STEEL BEAMS SUPPORT WOOD FRAMING OR WOOD SHEATHING, PROVIDE A CONTINUOUS SINGLE 3x NAILER PLATE ON THE TOP OF THE BEAM THAT EXTENDS AT LEAST THE FULL WIDTH OF THE BEAM FLANGE. ATTACH NAILER PLATES TO WIDE-FLANGE BEAMS WITH 1/2" DIAMETER THRU BOLTS AT 24"O.C. STAGGERED. COUNTERSINK HEAD OF BOLTS INTO TOP OF NAILER PLATE TO PROVIDE A FLUSH BEARING SURFACE.
- 8. ALL COLUMNS ADJACENT TO OR EMBEDDED IN WOOD STUD WALLS SHALL HAVE (1) 1/2" DIAMETER X 3-1/2" THREADED STEEL ROD SHOP-WELDED TO THE FACE OF THE COLUMN AT 24" O.C. AND EXTENDING EACH WAY INTO THE ADJACENT STUD WALLS. ATTACH ADJACENT WOOD WALL STUDS TO STEEL COLUMN WITH STANDARD NUT AND WASHER AS REQUIRED.
- 9. PROVIDE FULL DEPTH WEB STIFFENER PLATES AT EACH SIDE OF STEEL BEAMS AT ALL BEARING (EXCEPT SECONDARY FRAMING) POINTS. STIFFENER PLATES SHALL BE THICKNESS SHOWN UNLESS NOTED OTHERWISE AND SHALL BE WELDED BOTH SIDES WITH FILLET WELDS ALL AROUND.

FLANGE WIDTH STIFFENER THICKNESS WELD THICKNESS < 8 1/4" 1/4" 3/16" 3/16" 8 1/4" < BF < 12 1/2" 3/8" 1/4" 1/2" 5/16"

- 10. FABRICATORS AND SUPPLIERS SHALL COORDINATE PAINT/FINISHES WITH REQUIREMENTS FOR DIRECT APPLIED INSULATION, FIREPROOFING, ETC. AS NOTED IN THE PROJECT SPECIFICATIONS.
- 11. WHEN DETERMINING THE FIRE RESISTANCE OF ASSEMBLIES, USE THE FOLLOWING: STEEL ROOF MEMBERS ARE CONSIDERED UN-RESTRAINED AND STEEL FLOOR FRAMING MEMBERS ARE CONSIDERED RESTRAINED.
- 12. UNLESS NOTED OTHERWISE, ALL HORIZONTAL FRAMING MEMBERS SHALL BE ERECTED WITH THE NATURAL CROWN UP.
- 13. UNLESS OTHERWISE SHOWN OR DETAILED IN THE PLANS, ALL STEEL COLUMNS, BEAMS, BRACES, STRUTS, ETC. SHALL BE CONTINUOUS BETWEEN CONNECTIONS OR SUPPORTS. SPLICES IN MEMBERS SHALL NOT BE PERMITTED WITHOUT WRITTEN APPROVAL BY THE ENGINEER OF RECORD.

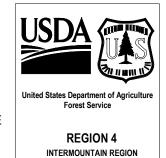

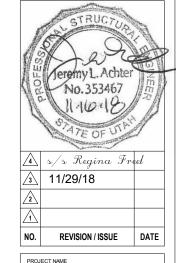

FLAMING GORGE RANGER DISTRICT OFFICE ADDITION

ASHLEY
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FLAMING GORGE RANGER DISTRICT

STRUCTURAL NOTES

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| JLA | | DRAWING SHEET NO. | |
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J. TIMBER

- 1. WOOD GRADES (UNLESS NOTED OTHERWISE)
 - a. ALL FRAMING LUMBER SHALL BE DOUGLAS FIR/LARCH CLEARLY MARKED WITH A STAMP BY WWPA APPROVED AGENCY AND SHALL BE GRADED AS FOLLOWS:
 - 1. HORIZONTAL MEMBERS: JOISTS & RAFTERS: NO. 2, BEAMS & STRINGERS: NO. 2.
 - 2. VERTICAL MEMBERS: POST & TRIMMERS: NO. 1, STUDS: NO. 2.
 - ALL FRAMING IN CONTACT WITH FOOTINGS, FOUNDATIONS OR SLABS ON GRADE SHALL BE PRESSURE TREATED OR TIMBERSTRAND LSL TREATED LUMBER WITH EQUIVALENT STRESS GRADES TO TYPICAL FRAMING MEMBERS.
 - UNLESS NOTED OTHERWISE, ALL ENGINEERED LUMBER SHALL BE FURNISHED BY TRUS-JOIST CORPORATION OR APPROVED EQUAL AND SHALL HAVE THE FOLLOWING MINIMUM PROPERTIES: MODULUS OF ELASTICITY FLEXURAL STRESS **RATING**

LVL: 2,000,000 PSI 2.600 PSI PSL: 2,000,000 PSI 2,900 PSI LSL: 1.500.000 PSI 2.250 PSI

- ALL WOOD "I" JOISTS AND BRIDGING SHALL BE FURNISHED BY TRUS-JOIST CORPORATION OR APPROVED EQUAL.
- 2. SHEATHING SHALL BE APA RATED SHEATHING, EXPOSURE I, EXTERIOR GLUE AND PANEL INDEX RATING AS NOTED BELOW UNLESS NOTED OTHERWISE:

PANEL INDEX LOCATION THICKNESS WALLS: 15/32" 24/0

ROOFS: 19/32" 32/16

- 3. ALL EXTERIOR WOOD WALLS SHALL BE FRAMED W; 2x6 STUDS @ 16"o.c. U.N.O.
- 4. INDIVIDUAL PIECES OF SHEATHING AT ROOF AND SHEAR WALLS SHALL NOT BE SMALLER THAN 24" IN EITHER DIRECTION AND SHALL SPAN A MINIMUM OF TWO FRAMING SPACES. UNO.
- 5. CONNECTIONS, FASTENERS, AND ADHESIVE
 - a. ALL BOLTS THRU WOOD SHALL BE ASTM A307 AND SHALL HAVE HARDENED WASHERS UNDER ASTM A563 HEAVY HEX NUT AND BOLT HEADS.
 - b. UNLESS NOTED OTHERWISE. 10d COMMON NAILS SHALL BE USED TO FASTEN ALL PLYWOOD SHEATHING TO SUPPORTING TRUSSES, JOISTS, LEDGERS OR BLOCKING
 - BOUNDARY NAILING "BN": 6"O.C. AT ALL ROOF AND FLOOR SHEATHING INTO BEARING WALLS, SHEAR WALLS, AND BLOCKING.
 - PANEL EDGE NAILING "EN": 6"O.C. AT ALL OTHER PLYWOOD PANEL EDGES.
 - PANEL FIELD NAILING "FN": 12"O.C. AT INTERIOR SUPPORTS IN FIELD OF PANEL
 - NAILS SHALL BE GALVANIZED OR STAINLESS STEEL AT EXPOSED LOCATIONS OR IN TREATED WOOD (SEE NOTE BELOW FOR FASTENERS CONNECTED TO OR IN CONTACT WITH TREATED WOOD). THE HEAD OF ALL NAILS SHALL BE DRIVEN FLUSH WITH THE SURFACE OF THE SHEATHING.
 - c. ALL NAILS SHALL HAVE THE FOLLOWING MINIMUM PROPERTIES:

| MIN | PENETRATION | |
|----------|-------------|--|
| IVIII N. | | |

SUPPORT MEMBER

| COMMON NAIL SIZE | SHANK DIAMETER | INTO |
|------------------|----------------|-------|
| 6d | 0.113" | 1.25" |
| 8d | 0.131" | 1.375 |
| 10d | 0.148" | 1.50" |
| 12d | 0.148" | 1.50" |
| 16d | 0.162" | 1.62" |
| | | |

- A CONTINUOUS BEAD OF PERMANENT BOND TIMBER/WOOD ADHESIVE COMPOUND SHALL BE USED TO FASTEN ALL PLYWOOD FLOOR SHEATHING TO FLOOR JOISTS IN ACCORDANCE WITH MANUFACTURERS' SPECIFICATIONS.
- ALL FRAMING ANCHORS, POST CAPS, HOLD DOWNS, COLUMN BASES ETC. TO BE PROVIDED BY SIMPSON OR APPROVED EQUAL AND SHALL BE ATTACHED IN ACCORDANCE WITH MANUFACTURER'S PUBLISHED DATA, UNLESS NOTED OTHERWISE.
- UNLESS NOTED OTHERWISE, ALL WALL BOTTOM PLATES TO BE ANCHORED TO FOUNDATIONS OR FOOTINGS WITH 3/4" DIAMETER ANCHOR BOLTS AT 32"O.C. WITH 8" MINIMUM EMBEDMENT. THERE SHALL BE A MINIMUM OF (2) ANCHOR BOLTS PER PLATE WITH ONE BOLT LOCATED NOT MORE THAN 12" AND NOT LESS THAN 4" FROM EACH END OF EACH PIECE.

- FASTENERS CONNECTED TO OR IN CONTACT WITH PRESERVATIVE-TREATED AND/OR FIRE-RETARDANT-TREATED WOOD (EXCEPT FOR TIMBERSTRAND LSL TREATED LUMBER AND BORATE BASED TREATMENTS) SHALL BE OF G-185 HOT-DIP GALVANIZED STEEL OR 304 OR 316 STAINLESS STEEL. STAINLESS STEEL AND GALVANIZED STEEL SHALL NEVER BE USED IN CONTACT WITH EACH OTHER.
- 6. PROVIDE SOLID 2" (NOMINAL) FULL DEPTH BLOCKING AT ENDS AND SUPPORT LOCATIONS FOR ALL JOISTS AND RAFTERS. BLOCKING SHALL BE ATTACHED TO SUPPORT FRAMING WITH A MINIMUM OF (1) SIMPSON A35 FRAMING ANCHOR BETWEEN JOISTS UNLESS NOTED OTHERWISE.
- 7. VERIFY THE STUD SPACING WITH THE ANCHOR BOLT LAY-OUT. WHERE STUDS INTERFERE WITH ANCHOR BOLTS, PROVIDE AN ADDITIONAL FULL-HEIGHT STUD TO ENSURE THAT THE FULL CROSS-SECTIONAL AREA OF THE STUD IS IN CONTACT WITH THE
- EXCEPT WHERE NOTED OTHERWISE, THE NUMBER AND SIZE OF NAILS CONNECTING WOOD MEMBERS SHALL NOT BE LESS THAN THAT SET FORTH IN IBC TABLE 2304.10.1. CONNECTIONS FOR MULTIPLE PIECES OF ENGINEERED LUMBER PIECES SHALL BE IN ACCORDANCE WITH THE MANUFACTURERS SPECIFICATIONS.
- a. UNLESS NOTED OTHERWISE, ALL HORIZONTAL FRAMING MEMBERS SHALL BE INSTALLED WITH THE NATURAL CROWN UP.

K. DEFERRED SUBMITTALS


- 1. DEFERRED SUBMITTALS ARE COMPLETE PACKAGES TO BE SUBMITTED FOR REVIEW THAT INCLUDE DRAWINGS AND CALCULATIONS FOR ALL ELEMENTS AND CONNECTIONS OF ITEMS LISTED BELOW. DEFERRED SUBMITTALS SHALL BEAR THE STAMP AND SIGNATURE OF THE DESIGN PROFESSIONAL RESPONSIBLE FOR THE DESIGN.
- DEFERRED SUBMITTAL COMPONENTS SHALL NOT BE INSTALLED UNTIL APPROVED BY THE CONTRACTING OFFICER.
- DEFERRED SUBMITTALS SHALL INCLUDE, BUT ARE NOT LIMITED TO:
 - a. SEISMIC BRACING OF ALL ARCHITECTURAL, MECHANICAL, PLUMBING, AND ELECTRICAL ITEMS WHERE REQUIRED BY ASCE 7-10 AND THE PROJECT CONTRACT DOCUMENTS.

L. EXISTING BUILDING NOTES

- 1. ARW ENGINEERS EXPRESSLY DISCLAIMS RESPONSIBILITY FOR ANY PORTION OF THE EXISTING BUILDING NOT SPECIFICALLY ADDRESSED IN THESE DRAWINGS.
- DRAWINGS AND DETAILS HAVE BEEN PREPARED TO REFLECT THE EXISTING CONDITIONS AND CONFIGURATIONS OF STRUCTURAL ELEMENTS. HOWEVER, THE CONTRACTOR IS ULTIMATELY RESPONSIBLE FOR VERIFYING ALL EXISTING CONDITIONS AND ALERTING THE ENGINEER OF ANY DISCREPANCIES FOUND PRIOR TO FABRICATING OR INSTALLING STRUCTURAL ELEMENTS.
- 3. THE CONTRACTOR IS RESPONSIBLE FOR MAKING SURE THAT THE BUILDING AND ELEMENTS WITHIN THE BUILDING REMAIN STABLE UNTIL CONSTRUCTION IS COMPLETE. AT NO ADDITIONAL COST TO THE OWNER. THE CONTRACTOR SHALL BE RESPONSIBLE FOR PROVIDING SHORING OR OTHER TEMPORARY SUPPORT OF STRUCTURAL MEMBERS UNTIL THE FINAL CONFIGURATION HAS BEEN COMPLETED.



INTERMOUNTAIN REGION

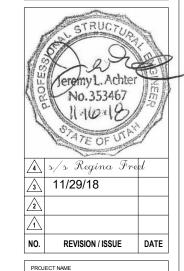

FLAMING GORGE RANGER DISTRICT OFFICE ADDITION

ASHLEY NATIONAL FOREST

FLAMING GORGE RANGER DISTRICT

DRAWING TITLE

STRUCTURAL NOTES

| 11/16/2018 | NOTIVE NO. |
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| DESIGNER JLA | DRAWING SHEET NO. |
| DRAWN RK | S005 |
| JLA | |
| PROJECT NO. 18037.A | SHEET 72 OF 119 |

LEGEND OF SYMBOLS AND ABBREVIATIONS

FOOTING MARK AΒ = ANCHOR BOLT ABV = ABOVE TOP OF FOOTING ELEV. ARCH = ARCHITECT BLW = BELOW SECTION MARK BN = BOUNDRY NAILING BRB = BUCKLING RESTRAINED BRACE SHEET NUMBER **BRBF** = BUCKLING RESTRAINED BRACE FRAME CJP = COMPLETE JOINT PENETRATION TOP OF FOUNDATION WALL OR CL COLUMN PIER ELEV. = CENTERLINE CMU = CONCRETE MASONRY UNIT —S —— FOOTING STEP COL = COLUMN CONC = CONCRETE CP = CONCRETE PIER DEPRESS FDN./WALL AND POUR DC = DEMAND CRITICAL FLOOR SLAB OVER AT MASONRY DIA / Ø DIAMETER **FOUNDATION WALL** = DBA DEFORMED BAR ANCHOR DBE = DECK BEARING ELEVATION DEPRESS FDN./WALL AND POUR **ELEV ELEVATION** = FLOOR SLAB OVER AT CONCRETE ΕN = **EDGE NAILING FOUNDATION WALL** EOD = EDGE OF DECK FDN = FOUNDATION MASONRY BEAM FTG = FOOTING FFE = FINISHED FLOOR ELEVATION CONCRETE BEAM GB = CONCRETE GRADE BEAM HSA = HEADED STUD ANCHOR ELEVATION JBE **= JOIST BEARING ELEVATION** KΒ = KICKER BRACE FRAMING ANGLE SEE TYPICAL DETAIL MAX = MAXIMUM MB = MASONRY BEAM FRAMING CHANNEL SEE TYPICAL MC = MASONRY COLUMN **DETAIL** MECH = MECHANICAL MEZZ = MEZZANINE ITEMS, DETAILS, & SYSTEMS WHICH MIN = MINIMUM ARE PART OF THE LATERAL FORCE MJ = MASONRY JAMB RESISTING SYSTEM. MW = MASONRY WALL

KICKER BRACE

NS. FS

OAF

OPP

PAF PL

REINF

REQ'D

SIM

SSH

SSJ

SSS

SSW

TOB

TOC

TOF

TOG

TOM

TOS

TYP

UNO

= NEAR SIDE, FAR SIDE

= OPPOSITE

= REQUIRED

= SIMILAR

= TYPICAL

= REINFORCING

= PLATE

= OR APPROVED EQUAL

= STEEL STUD HEADER

= TOP OF BEAM ELEVATION

= TOP OF CONCRETE SLAB

= TOP OF GIRDER ELEVATION

= TOP OF STEEL ELEVATION

= UNLESS NOTED OTHERWISE

= STEEL STUD JAMB

= STEEL STUD WALL

= TOP OF FOOTING

= TOP OF MASONRY

= STEEL STUD SILL

= POWDER ACTUATED FASTENER



REGION 4

INTERMOUNTAIN REGION

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PROJECT NAME

FLAMING GORGE RANGER DISTRICT OFFICE ADDITION

ASHLEY
NATIONAL FOREST

FLAMING GORGE RANGER DISTRICT

DRAWING TITLE

| | DATE 11/16/2 | 018 | ARC | HIVE NO. |
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| | DESIGNER | JLA | | DRAWING SHEET NO. |
| | DRAWN RK | | | S006 |
| | CHECKED | JLA | | |
| | PROJECT N | | | SHEET 73 OF 119 |

SPECIAL INSPECTION SCHEDULE 1,2

ESTABLISHED PER 2015 IBC SECTION 110 AND CHAPTER 17

| ITEM | continuous ³ | PERIODIC ³ | REFERENCE | | COMMENTS |
|------------------------------------|-------------------------|-----------------------|-------------------------------------|------------|---|
| PRE-FAB CONSTRUCTION (IBC 1704.2) | | | REFERENCE NOTES P1 & P2 | P1. | SPECIAL INSPECTION IS NOT REQUIRED WHERE THE WORK IS DONE ON THE PREMISES OF A FABRICATOR REGISTERED AND APPROVED TO PERFORM SUCH WORK WITHOUT SPECIAL INSPECTION, PROVIDED THE FABRICATOR COMPLIES WITH IBC. INSPECTION FOR PREFABRICATED CONSTRUCTION SHALL BE THE SAME AS IF THE MATERIAL USED IN THE CONSTRUCTION TOOK PLACE ON SITE. SPECIAL INSPECTION WILL NOT BE REQUIRED DURING PREFABRICATION IF THE APPROVED AGENCY CERTIFIES THE CONSTRUCTION AND FURNISHES EVIDENCE OF COMPLIANCE. (SEE NOTE 2). |
| CONCRETE CONSTRUCTION (IBC 1705.3) | | | SEE IBC TABLE 1705.3 - REF. NOTE C1 | C1. | SPECIAL INSPECTION IS NOT REQUIRED FOR CONC. ISOLATED SPREAD |
| REINFORCING STEEL PLACEMENT | | • | | | FOOTINGS, CONTINUOUS FOOTINGS, NON-STRUCTURAL SLABS, FOUNDATION WALLS, PATIOS, DRIVEWAYS, AND SIDEWALKS PROVIDED THE REQUIREMENTS |
| WELDING OF REINFORCING STEEL | • | • | REFERENCE NOTE C2 | | OF IBC 1705.3 ARE MET. |
| EMBEDDED BOLTS & PLATES | • | | | C2. | PERIODIC SPECIAL INSPECTION IS ALLOWED FOR VERIFICATION OF THE WELDABILITY OF REINFORCING STEEL RESISTING FLEXURAL AND AXIAL FORCES |
| VERIFYING REQUIRED DESIGN MIX | | • | | | IN INTERMEDIATE AND SPECIAL MOMENT FRAMES, BOUNDARY ELEMENTS OF |
| CONCRETE PLACEMENT / SAMPLING | • | | REFERENCE NOTE C3 | | SPECIAL REINFORCED CONCRETE SHEAR WALLS, AND SHEAR REINFORCEMENT. PERIODIC SPECIAL INSPECTION IS ALLOWED FOR WELDING |
| CURING TEMPERATURE / TECHNIQUES | | • | | | OF OTHER ASTM A 706 REINFORCING STEEL NOT INCLUDED IN THE CONTINOUS |
| EPOXY / EXPANSION ANCHOR PLACEMENT | • | • | REFERENCE NOTE C5 | C3. C4. | SPECIAL INSPECTION REQUIREMENTS NOTED ABOVE. PERFORM AIR, SLUMP AND TEMP. TESTS WHEN CONCRETE SAMPLES ARE CAST. PERIODIC SPECIAL INSPECTION IS REQUIRED FOR VERIFICATION OF IN-SITU CONCRETE STRENGTH FOR POST-TENSIONED CONCRETE PRIOR TO TENSIONING TENDONS OR REMOVING SHORING OR FORMS. EPOXY AND EXPANSION ANCHORS INTO MASONRY OR CONCRETE MAY BE USED |
| | | | | | ONLY WHEN APPROVED BY ARCHITECT. AND/OR ENGINEER USING AN APPROVED PRODUCT WITH CURRENT PUBLISHED ICC RESEARCH REPORT NUMBERS. COORDINATE CONTINUOUS/PERIODIC SPECIAL INSPECTION REQUIREMENTS WITH ICC REPORT. |
| WOOD (IBC 1705.5) | | | | W 1. | WOOD STRUCTURAL PANEL SHEATHING SHALL BE INSPECTED TO ASCERTAIN |
| SITE-BUILT ASSEMBLIES | | • | | | THAT GRADE AND THICKNESS ARE IN COMPLIANCE WITH APPROVED BUILDING PLANS. NOMINAL SIZE OF FRAMING MEMBERS AT ADJOINING PANEL |
| DIAHRAGM NAILING | | • | | | EDGES, THE NAIL OR STAPLE DIAMETER AND LENGTH, THE NUMBER OF |
| DRAG STRUTS | | • | | | FASTENER LINES, AND SPACING BETWEEN FASTENERS IN EACH LINE AND AT EDGE MARGINS SHALL ALSO BE INSPECTED AND VERIFIED FOR COMPLIANCE |
| GLUING OPERATIONS | • | | | W 2. | WITH APPROVED BUILDING PLANS. SPECIAL INSPECTION IS NOT REQUIRED FOR WOOD SHEAR WALLS, WOOD DIAPHRAGMS, INCLUDING NAILING, & BOLTING, AND OTHER FASTENING TO OTHER COMPONENTS WHERE THE SPACING OF THE SHEATHING FASTENERS IS GREATER THAN 4"o.c. |


GENERAL SPECIAL INSPECTION NOTES:

- THE ITEMS MARKED WITH A "O" IN THE SPECIAL INSPECTION SCHEDULE SHALL BE INSPECTED IN ACCORDANCE WITH IBC CHAPTER 17 BY A CERTIFIED SPECIAL INSPECTOR FROM AN ESTABLISHED TESTING AGENCY. FOR MATERIAL SAMPLING AND TESTING REQUIREMENTS, REFER TO THE MATERIAL SAMPLING AND TESTING SECTION, THE PROJECT SPECIFICATIONS, AND THE SPECIFIC GENERAL NOTES SECTIONS. THE TESTING AGENCY SHALL SEND COPIES OF ALL STRUCTURAL TESTING AND INSPECTION REPORTS DIRECTLY TO THE ARCHITECT, ENGINEER, CONTRACTOR, AND BUILDING OFFICIAL. ANY ITEMS WHICH FAIL TO COMPLY WITH THE APPROVED CONSTRUCTION DOCUMENTS SHALL IMMEDIATELY BE BROUGHT TO THE ATTENTION OF THE CONTRACTOR FOR CORRECTION. IF DISCREPANCIES ARE NOT CORRECTED, THEY SHALL BE BROUGHT TO THE ATTENTION OF THE BUILDING OFFICIAL, ARCHITECT, AND ENGINEER PRIOR TO COMPLETION OF THAT PHASE OF WORK. SPECIAL INSPECTION TESTING REQUIREMENTS APPLY EQUALLY TO ALL BIDDER DESIGNED COMPONENTS.
- ANY CONSTRUCTION OR MATERIAL THAT HAS FAILED INSPECTION SHALL BE SUBJECT TO REMOVAL AND REPLACEMENT.
- CONTINUOUS SPECIAL INSPECTION MEANS THE FULL-TIME OBSERVATION OF WORK REQUIRING SPECIAL INSPECTION BY AN APPROVED SPECIAL INSPECTOR WHO IS PRESENT IN THE AREA WHERE THE WORK IS BEING PERFORMED. PERIODIC SPECIAL INSPECTION MEANS THE PART-TIME OR INTERMITTENT OBSERVATION OF WORK REQUIRING SPECIAL INSPECTION BY AN APPROVED SPECIAL INSPECTOR WHO IS PRESENT IN THE AREA WHERE THE WORK HAS BEEN OR IS BEING PERFORMED AND AT THE COMPLETION OF THE WORK. (IBC SECTION 1702)



Forest Service

REGION 4 INTERMOUNTAIN REGION

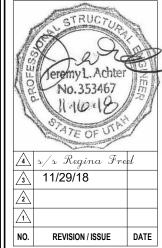

PROJECT NAME

FLAMING GORGE RANGER DISTRICT OFFICE ADDITION

ASHLEY NATIONAL FOREST

FLAMING GORGE RANGER DISTRICT

DRAWING TITLE


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| | PROJECT NO. 18037.A | SHEET 74 OF 119 |
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ARCHIVE NO.

2015 IBC CONC. REBAR LAP SPLICE SCHEDULE

FOR CONCRETE APPLICATIONS (ACI 318 - 14)



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|--|------|------------|----|----|-----|----|----|-----|------|-------|-------|------|--------|--------|------|---------|-----|----|----|-----|----|----------------|----|-----|----|-----|----------|
| DAD LOCATION | COI | NCRETE | | | | | | | | | | | ВА | R SIZI | Ξ | | | | | | | | | | | | |
| BAR LOCATION | TYPE | STRENGTH | | #3 | | | #4 | | | #5 | | | #6 | | | #7 | | | #8 | | # | ! 9 | # | 10 | # | 11 | COMMENTS |
| | ''' | OTALINOTTI | ld | ls | ldh | ld | ls | ldh | ld | ls | ldh | ℓd | ls | ldh | ℓd | ls | ldh | ℓd | ls | ℓdh | ℓd | ldh | ℓd | ldh | ℓd | ldh | |
| VERT. WALL BARS, FILL ON METAL DECK | NWC | 3000 PSI | 17 | 22 | 8 | 22 | 29 | 8 | 28 | 36 | 10 | 33 | 43 | 12 | 48 | 62 | 13 | 55 | 72 | 15 | 62 | 17 | 69 | 19 | 76 | 30 | |
| HORIZ. WALL BARS, FOOTING TOP BARS | NWC | 3000 PSI | 17 | 22 | 8 | 22 | 29 | 8 | 28 | 36 | 10 | 33 | 43 | 12 | 48 | 62 | 13 | 55 | 72 | 15 | 62 | 17 | 69 | 19 | 76 | 30 | |
| BEAM BOTTOM BARS, COLUMN BARS | NWC | 3000 PSI | 17 | 22 | 8 | 22 | 29 | 11 | 28 | 36 | 14 | 33 | 43 | 16 | 48 | 62 | 19 | 55 | 72 | 22 | 62 | 25 | 69 | 27 | 76 | 30 | |
| FOOTING BOTTOM BARS | NWC | 3000 PSI | 12 | 16 | 8 | 14 | 18 | 8 | 17 | 22 | 10 | 20 | 26 | 12 | 29 | 38 | 13 | 33 | 43 | 15 | 37 | 17 | 42 | 19 | 46 | 30 | |
| BEAM TOP BARS | NWC | 3000 PSI | 22 | 29 | 8 | 29 | 38 | 11 | 36 | 47 | 14 | 43 | 56 | 16 | 63 | 82 | 19 | 72 | 94 | 22 | 81 | 25 | 90 | 27 | 98 | 30 | |
| SLAB ON GRADE | NWC | 3000 PSI | 12 | 16 | 8 | 14 | 18 | 8 | 17 | 22 | 10 | 20 | 26 | 12 | 32 | 42 | 13 | 42 | 55 | 15 | 53 | 17 | 69 | 19 | 76 | 30 | |

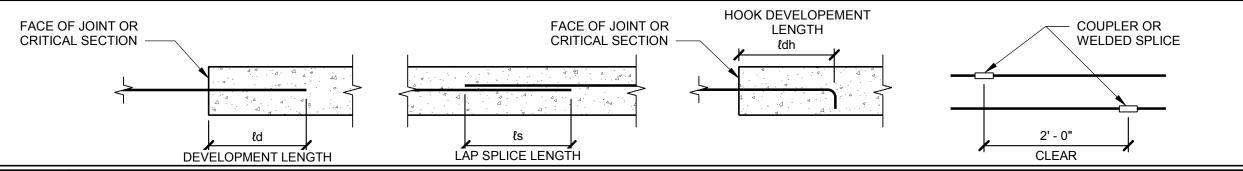
| | | | | | | | | | | CONC | RETE | REIN | FORCI | NG & | SPLIC | E LEN | IGTHS | (IN) | | | | | | | | | |
|--|------|----------|----|----|-----|----|----|-----|----|------|------|------|-------|--------|-------|-------|-------|------|----|-----|----|-----|----|-----|----|-----|----------|
| DAD LOCATION | CON | NCRETE | | | | | | | | | | | ВА | R SIZI | Ε | | | | | | | | | | | | |
| BAR LOCATION | TYPE | STRENGTH | | #3 | | | #4 | | | #5 | | | #6 | | | #7 | | | #8 | | # | ŧ9 | # | 10 | # | 11 | COMMENTS |
| | | OTTENOTT | ℓd | ls | ldh | ℓd | ls | ldh | ℓd | ls | ldh | ℓd | ls | ldh | ℓd | ls | ldh | ℓd | ls | ldh | ℓd | ldh | ℓd | ldh | ld | ldh | |
| VERT. WALL BARS, FILL ON METAL DECK | NWC | 4500 PSI | 14 | 18 | 7 | 18 | 23 | 6 | 23 | 30 | 8 | 27 | 35 | 9 | 40 | 52 | 11 | 45 | 59 | 13 | 51 | 14 | 56 | 16 | 62 | 25 | |
| HORIZ. WALL BARS, FOOTING TOP BARS | NWC | 4500 PSI | 14 | 18 | 7 | 18 | 23 | 6 | 23 | 30 | 8 | 27 | 35 | 9 | 40 | 52 | 11 | 45 | 59 | 13 | 51 | 14 | 56 | 16 | 62 | 25 | |
| BEAM BOTTOM BARS, COLUMN BARS | NWC | 4500 PSI | 14 | 18 | 7 | 18 | 23 | 9 | 23 | 30 | 11 | 27 | 35 | 13 | 40 | 52 | 16 | 45 | 59 | 18 | 51 | 20 | 56 | 22 | 62 | 25 | |
| FOOTING BOTTOM BARS | NWC | 4500 PSI | 12 | 16 | 7 | 12 | 16 | 6 | 14 | 18 | 8 | 17 | 22 | 9 | 24 | 31 | 11 | 27 | 35 | 13 | 31 | 14 | 34 | 16 | 37 | 25 | |
| BEAM TOP BARS | NWC | 4500 PSI | 18 | 23 | 7 | 24 | 31 | 9 | 30 | 39 | 11 | 35 | 46 | 13 | 51 | 66 | 16 | 59 | 77 | 18 | 66 | 20 | 73 | 22 | 80 | 25 | |
| SLAB ON GRADE | NWC | 4500 PSI | 12 | 16 | 7 | 12 | 16 | 6 | 14 | 18 | 8 | 17 | 22 | 9 | 27 | 35 | 11 | 34 | 44 | 13 | 44 | 14 | 56 | 16 | 62 | 25 | |

NOTES:

- 1. MECHANICAL COUPLERS MAY BE USED IN LIEU OF LAP SPLICES SHOWN. SEE STRUCTURAL NOTES FOR MINIMUM COUPLER CAPACITY. WHERE MECHANICAL COUPLERS ARE USED, STAGGER ADJACENT SPLICES A MINIMUM OF 24" AS INDICATED ABOVE.
- 2. DEVELOPMENT LENGTHS SHALL BE INCREASED BY 50% FOR STRAIGHT BAR DEVELOPMENT AND 20% FOR HOOKED BARS WHERE EPOXY COATING IS USED.
- 3. WHEN SPLICING BARS OF DIFFERENT SIZES, USE LAP SPLICE LENGTH OF LARGER BARS UNO.
- 4. SPLICE BARS LARGER THAN #11 USING MECHANICAL COUPLERS.



INTERMOUNTAIN REGION

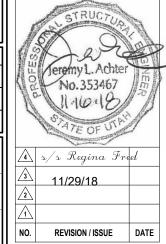

PROJECT NAME

FLAMING GORGE RANGER DISTRICT OFFICE ADDITION

ASHLEY
NATIONAL FOREST

FLAMING GORGE RANGER DISTRICT

DRAWING TITLE


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| | FOOTING SCHEDULE | | | | | | | | | | | | | | |
|-------|------------------|--------|-------|---------|------------|------|----------|-------|---------|--|--|--|--|--|--|
| MADIC | MIDTH | LENGTH | TUICK | LENGTHW | ISE REINF. | CROS | SSWISE R | EINF. | DEMARKS | | | | | | |
| MARK | WIDTH | LENGTH | THICK | NO. | SIZE | NO. | SIZE | SPA. | REMARKS | | | | | | |
| FC2 | 2'-0" | CONT. | 12" | (2) | #5 | | | | | | | | | | |
| | | | | | | | | | | | | | | | |
| F3 | 3'-0" | 3'-0" | 12" | (3) | #5 | (3) | #5 | | | | | | | | |
| F4 | 4'-0" | 4'-0" | 12" | (4) | #5 | (4) | #5 | | | | | | | | |
| | | | | | | | | | | | | | | | |
| | | | | | | | | | | | | | | | |
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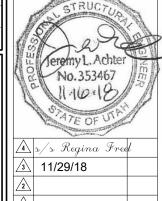


TYP. FOOTING SECTION



United States Department of Agriculture Forest Service

REGION 4
INTERMOUNTAIN REGION

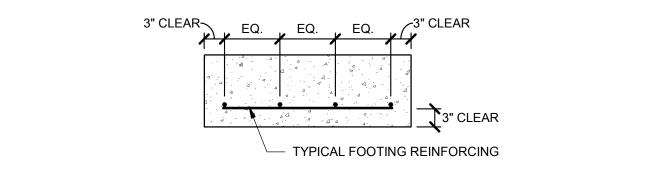

PROJECT NAME

FLAMING GORGE RANGER DISTRICT OFFICE ADDITION

NO. REVISION / ISSUE DATE

ASHLEY
NATIONAL FOREST

FLAMING GORGE RANGER DISTRICT

DRAWING TITLE

| DATE 11/16/2018 | ARCH | HIVE NO. |
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| PROJECT NO. 18037.A | | SHEET 76 OF 119 |

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STRUCTURAL STEEL SPECIAL INSPECTION SCHEDULE

ESTABLISHED PER 2015 IBC SECTION 1705.2.1

| INSPECTION TASKS PRIOR TO WELDING (TABLE N5.4-1) | FABRICA QUALITY CO | | SPECIAL INS | _ | |
|---|-----------------------|----------|-------------|----------|---|
| , | CONTINUOUS | PERIODIC | CONTINUOUS | PERIODIC | |
| WELDING PROCEDURE SPECIFICATIONS (WPSs) AVAILABLE | • | | • | | Τ |
| MANUFACTURER CERTIFICATIONS FOR WELDING CONSUMABLES AVAILABLE | • | | • | | |
| MATERIAL IDENTIFICATION (TYPE / GRADE) | | • | | • | 1 |
| WELDER IDENTIFICATION SYSTEM 1 | | • | | • | |
| FIT-UP OF FILLET WELDS | | | | | 1 |
| * DIMENSIONS (ALIGNMENT, GAPS AT ROOT) | | • | | | |
| * CLEANLINESS (CONDITION OF STEEL SURFACES) | | | | | l |
| * TACKING (TACK WELD QUALITY AND LOCATION) | 1 | | | | |
| CHECK WELDING EQUIPMENT | | • | | | |


THE FABRICATOR OR ERECTOR, AS APPLICABLE, SHALL MAINTAIN A SYSTEM BY WHICH A WELDER WHO HAS WELDED A JOINT OR MEMBER CAN BE IDENTIFIED. STAMPS, IF USED, SHALL BE THE LOW-STRESS TYPE.

NOTES

- PERIODIC OBSERVE THESE ITEMS ON A RANDOM BASIS. OPERATIONS NEED NOT BE DELAYED PENDING THESE INSPECTIONS.
- 2. CONTINUOUS PERFORM THESE TASKS FOR EACH WELDED JOINT OR MEMBER.
- 3. QUALITY CONTROL (QC) SHALL BE PROVIDED BY THE FABRICATOR AND ERECTOR.
- QUALITY ASSURANCE (QA) SHALL BE PROVIDED BY OTHERS WHEN REQUIRED BY THE AUTHORITY HAVING JURISDICTION (AHJ), APPLICABLE BUILDING CODE (ABC), PURCHASER, OWNER, OR ENGINEER OF RECORD (EOR). NONDESTRUCTIVE TESTING (NDT) SHALL BE PERFORMED BY THE AGENCY OR FIRM RESPONSIBLE FOR QUALITY ASSURANCE, EXCEPT AS PERMITTED IN ACCORDANCE WITH SECTION N7.
- . QC AND QA INSPECTORS SHALL BE QUALIFIED IN ACCORDANCE WITH AISC 360-10 CHAPTER N4.
- 6. NONDESTRUCTIVE TESTING PERSONNEL SHALL BE QUALIFIED IN ACCORDANCE WITH AISC 360-10 CHAPTER N4.3.
- 7. NONDESTRUCTIVE TESTING OF WELDED JOINTS SHALL COMPLY WITH AISC 360-10 CHAPTER N5a AND b.
- 8. OBSERVATION OF WELDING OPERATIONS AND VISUAL INSPECTION OF IN-PROCESS AND COMPLETED WELDS SHALL BE THE PRIMARY METHOD TO CONFIRM THAT THE MATERIALS, PROCEDURES AND WORKMANSHIP ARE IN CONFORMANCE WITH THE CONSTRUCTION DOCUMENTS. FOR STRUCTURAL STEEL, ALL PROVISIONS OF AWS D1.1 / D1.1M STRUCTURAL WELDING CODE STEEL FOR STATICALLY LOADED STRUCTURES SHALL APPLY.



REGION 4
INTERMOUNTAIN REGION

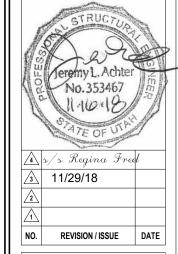

PROJECT NAME

FLAMING GORGE RANGER DISTRICT OFFICE ADDITION

ASHLEY
NATIONAL FOREST

FLAMING GORGE RANGER DISTRICT

DRAWING TITLE

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STRUCTURAL STEEL SPECIAL INSPECTION SCHEDULE (CONT.)


ESTABLISHED PER 2015 IBC SECTION 1705.2.1

| INSPECTION TASKS DURING WELDING (TABLE N5.4-2) | FABRICATOR QUALITY CONTROL CONTINUOUS PERIODIC | SPECIAL INSPECTOR QUALITY ASSURANCE CONTINUOUS PERIODIC | | NOTES | | | | |
|---|--|---|------------|---|--|--|--|--|
| USE OF QUALIFIED WELDERS | • | • | - | ERMALLY CUT SURFACES OF ACCESS HOLES SHALL BE TESTED | | | | |
| CONTROL AND HANDLING OF WELDING CONSUMABLES | | | | QA USING MT OR PT, WHEN THE FLANGE THICKNESS EXCEEDS N. (50mm) FOR ROLLED SHAPES, OR WHEN THE WEB THICKNESS | | | | |
| * PACKAGING | • | • | EX | CEEDS 2 IN. (50mm) FOR BUILT-UP SHAPES. ANY CRACK SHALL | | | | |
| * EXPOSURE CONTROL | | | | DEEMED UNACCEPTABLE REGARDLESS OF SIZE OR LOCATION. HEN REQUIRED BY APPENDIX 3, TABLE A-3.1, WELDED JOINTS | | | | |
| NO WELDING OVER CRACKED TACK WELDS | • | • | RE(| QUIRING WELD SOUNDNESS TO BE ESTABLISHED BY | | | | |
| ENVIRONMENTAL CONDITIONS | | | | RADIOGRAPHICS OR ULTRASONIC INSPECTION SHALL BE TESTED BY QA AS PRESCRIBED. REDUCTION IN THE RATE OF UT IS | | | | |
| * WIND SPEED WITHIN LIMITS | • | • | PR | OHIBITED. | | | | |
| * PRECIPITATION AND TEMPERATURE | | | | DUCTION OF RATE OF ULTRASONIC TESTING - THE RATE OF UT ONLY PERMITTED TO BE REDUCED IF APPROVED BY THE EOR | | | | |
| WPS FOLLOWED | | | | D THE AHJ PER AISC 360-10 CHAPTER N5e. R STRUCTURES IN RISK CATEGORY II, WHERE THE INITIAL RATE | | | | |
| * SETTINGS ON WELDING EQUIPMENT | | | | R STRUCTURES IN RISK CATEGORY II, WHERE THE INITIAL RATE R UT IS 10%, THE NDT RATE FOR AN INDIVIDUAL WELDER OR | | | | |
| * TRAVEL SPEED | | | | ELDING OPERATOR SHALL BE INCREASED TO 100% SHOULD THE JECT RATE, THE NUMBER OF WELDS CONTAINING | | | | |
| * SELECTED WELDING MATERIALS | • | • | UN. | IACCEPTABLE DEFECTS DIVIDED BY THE NUMBER OF WELDS | | | | |
| * SHIELDING GAS TYPE / FLOW RATE | | | | COMPLETED, EXCEEDS 5% OF THE WELDS TESTED FOR THE WELDER OR WELDING OPERATOR. A SAMPLING OF AT LEAST 20 | | | | |
| * PREHEAT APPLIED | | | co | MPLETED WELDS FOR A JOB SHALL BE MADE PRIOR TO | | | | |
| * INTERPASS TEMPERATURE MAINTAINED (MIN. / MAX) | | | | PLEMENTING SUCH AN INCREASE. WHEN THE REJECT RATE FOR E WELDER OR WELDING OPERATOR, AFTER A SAMPLING OF AT | | | | |
| * PROPER POSITION (F, V, H, OH) | | | LE/ | AST 40 COMPLETED WELDS, HAS FALLEN TO 5% OR LESS, THE | | | | |
| WELDING TECHNIQUES | | | | TE OF UT SHALL BE RETURNED TO 10%. FOR EVALUATING THE SECT RATE OF CONTINUOUS WELDS OVER 3 FT (1M) IN LENGTH | | | | |
| * INTERPASS AND FINAL CLEANING | | | | HERE THE EFFECTIVE THROAT IS 1 IN. (25mm) OR LESS, EACH 12 | | | | |
| * EACH PASS WITHIN PROFILE LIMITATIONS | • | • | CO | (300mm) INCREMENT OR FRACTION THEREOF SHALL BE ONSIDERED AS ONE WELD. FOR EVALUATING THE REJECT RATE | | | | |
| * EACH PASS MEETS QUALITY REQUIREMENTS | | | EFF (15 | ON CONTINUOUS WELDS OVER 3 FT (1M) IN LENGTH WHERE THE EFFECTIVE THROAT IS GREATER THAN 1 IN. (25mm), EACH 6 IN. (150mm) OF LENGTH OR FRACTION THEREOF SHALL BE CONSIDERED ON WELD. | | | | |



Forest Service

REGION 4
INTERMOUNTAIN REGION

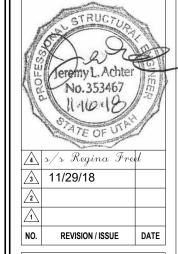

PROJECT NAME

FLAMING GORGE RANGER DISTRICT OFFICE ADDITION

ASHLEY
NATIONAL FOREST

FLAMING GORGE RANGER DISTRICT

DDAWING TITLE

| 11/16/2018 | ARCHIVE NO. | | | |
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| DESIGNER JLA | DRAWING SHEET NO. | | | |
| DRAWN RK | S011 | | | |
| CHECKED JLA | | | | |
| PROJECT NO. | SHEET 78 OF 119 | | | |
| 18037.A | | | | |
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-18037 - Flaming Gorge Ranger Office Addition-2018_jasonr@arwengineers.com.

STRUCTURAL STEEL SPECIAL INSPECTION SCHEDULE (CONT.)

ESTABLISHED PER 2015 IBC SECTION 1705.2.1

| | FABRICATOR QUALITY CONTROL | | SPECIAL INSPECTOR QUALITY ASSURANCE | | NOTES |
|--|-------------------------------|-----------|-------------------------------------|----------|---|
| INSPECTION TASKS AFTER WELDING (TABLE N5.4-3) | CONTINUOUS | PERIODIC | CONTINUOUS | PERIODIC | |
| WELDS CLEANED | | • | | • | 13. ALL NDT PERFORMED SHALL BE DOCUMENTED. FOR SHOP |
| SIZE, LENGTH AND LOCATION OF WELDS | • | | • | | FABRICATION, THE NDT REPORT SHALL IDENTIFY THE TESTED WELD |
| WELDS MEET VISUAL ACCEPTANCE CRITERIA | | | | | BY PIECE MARK AND LOCATION IN THE PIECE. FOR FIELD WORK, THE NDT REPORT SHALL IDENTIFY THE TESTED WELD BY LOCATION IN THE |
| * CRACK PROHIBITION | | | | | STRUCTURE, PIECE MARK, AND LOCATION IN THE PIECE. WHEN A |
| * WELD / BASE-METAL FUSION | | | | | WELD IS REJECTED ON THE BASIS OF NDT, THE NDT RECORD SHALL INDICATE THE LOCATION OF THE DEFECT AND THE BASIS OF |
| * CRATER CROSS SECTION | | | | | REJECTION. |
| * WELD PROFILES | | | | | |
| * WELD SIZE | | | | | |
| * UNDERCUT | | | | | |
| * POROSITY | | | | | |
| ARC STRIKES | • | | • | | |
| K-AREA 1 | • | | • | | |
| BACKING REMOVED AND WELD TABS REMOVED (IF REQUIRED) | • | | • | | |
| REPAIR ACTIVITIES | • | | • | | |
| DOCUMENT ACCEPTANCE OR REJECTION OF WELDED JOINT OR MEMBER | • | | • | | |
| 1 WHEN WELDING OF DOUBLER PLATES, CONTINUITY PLATES OR STIFFENERS VISUALLY INSPECT THE WEB K-AREA FOR CRACKS WITHIN 3 IN. (75mm) OF T | | FORMED II | N THE K-AREA, | | |



REGION 4
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| PROJECT NO. 18037.A | SHEET 79 OF 119 | | | |
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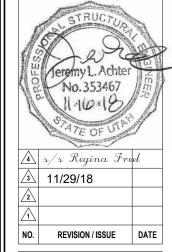
STRUCTURAL STEEL SPECIAL INSPECTION SCHEDULE (CONT.)

ESTABLISHED PER 2015 IBC SECTION 1705.2.1

| INSPECTION TASKS PRIOR TO BOLTING (TABLE N5.6-1) | CONTINUOUS | PERIODIC | CONTINUOUS | PERIODIC | NOTES |
|--|------------|----------|------------|----------|---|
| MANUFACTURER'S CERTIFICATIONS AVAILABLE FOR FASTENER MATERIALS | | • | • | | 1. PERIODIC - OBSERVE THESE ITEMS ON A RANDOM BASIS. |
| FASTENERS MARKED IN ACCORDANCE WITH ASTM REQUIREMENTS | | • | | • | OPERATIONS NEED NOT BE DELAYED PENDING THESE INSPECTIONS. |
| PROPER FASTENERS SELECTED FOR THE JOINT DETAIL (GRADE, TYPE, BOLT LENGTH IF THREADS ARE TO BE EXCLUDED FROM SHEAR PLANE) | | • | | • | CONTINUOUS - PERFORM THESE TASKS FOR EACH BOLTED CONNECTION. QUALITY CONTROL (QC) SHALL BE PROVIDED BY THE |
| PROPER BOLTING PROCEDURES SELECTED FOR JOINT DETAIL | | • | | • | FABRICATOR AND ERECTOR. |
| CONNECTING ELEMENTS, INCLUDING THE APPROPRIATE FAYING SURFACE CONDITION AND HOLE PREPARATION, IF SPECIFIED, MEET APPLICABLE REQUIREMENTS | | • | | • | QUALITY ASSURANCE (QA) SHALL BE PROVIDED BY OTHERS WHEN REQUIRED BY THE AUTHORITY HAVING JURISDICTION (AHJ), APPLICABLE BUILDING CODE (ABC), PURCHASER, OWNER, OR ENGINEER OF RECORD (EOR). NONDESTRUCTIVE |
| PRE-INSTALLATION VERIFICATION TESTING BY INSTALLATION PERSONNEL OBSERVED AND DOCUMENTED FOR FASTENER ASSEMBLIES AND METHODS USED | • | | | • | TESTING (NDT) SHALL BE PERFORMED BY THE AGENCY OR FIRM RESPONSIBLE FOR QUALITY ASSURANCE, EXCEPT AS PERMITTED IN ACCORDANCE WITH SECTION N7. |
| PROPER STORAGE PROVIDED FOR BOLTS, NUTS, WASHERS AND OTHER FASTENER COMPONENTS | | • | | • | 5. FOR SNUG-TIGHT JOINTS, PRE-INSTALLATION VERIFICATION TESTING AS SPECIFIED IN TABLE N5.6-1 AND MONITORING OF THE INSTALLATION PROCEDURES AS SPECIFIED IN TABLE N5.6-2 ARE NOT APPLICABLE. THE QCI AND QAI NEED NOT BE |
| INSPECTION TASKS DURING BOLTING (TABLE N5.6-2) | CONTINUOUS | PERIODIC | CONTINUOUS | PERIODIC | PRESENT DURING THE INSTALLATION OF FASTENERS IN SNUG-TIGHT JOINTS. |
| FASTENER ASSEMBLIES, OF SUITABLE CONDITION, PLACED IN ALL HOLES AND WASHERS (IF REQUIRED) ARE POSITIONED AS REQUIRED | | • | | • | 6. FOR PRETENSIONED JOINTS AND SLIP-CRITICAL JOINTS, WHEN THE INSTALLER IS USING THE TURN-OF-NUT METHOD WITH MATCHMARKING TECHNIQUES, THE DIRECT-TENSION- |
| JOINT BROUGHT TO THE SNUG-TIGHT CONDITION PRIOR TO THE PRETENSIONING OPERATION | | • | | • | INDICATOR METHOD, OR THE TWIST-OFF-TYPE TENSION CONTROL BOLT METHOD, MONITORING OF BOLT PRETENSIONING PROCEDURES SHALL BE AS SPECIFIED IN |
| FASTENER COMPONENT NOT TURNED BY THE WRENCH PREVENTED FROM ROTATING | | • | | • | TABLE N5.6-2. THE QCI AND QAI NEED NOT BE PRESENT DURING THE INSTALLATION OF FASTENERS WHEN THESE |
| FASTENERS ARE PRETENSIONED IN ACCORDANCE WITH THE RCSC SPECIFICATION, PROGRESSING SYSTEMATICALLY FROM THE MOST RIGID POINT TOWARD THE FREE EDGES | | • | | • | METHODS ARE USED BY THE INSTALLER. 7. FOR PRETENSIONED JOINTS AND SLIP-CRITICAL JOINTS, WHEN THE INSTALLER IS USING THE CALIBRATED WRENCH METHOD OR THE TURN-OF-NUT METHOD WITHOUT MATCHMARKING, MONITORING OF BOLT PRETENSIONING |
| INSPECTION TASKS AFTER BOLTING (TABLE N5.6-3) | CONTINUOUS | PERIODIC | CONTINUOUS | PERIODIC | PROCEDURES SHALL BE AS SPECIFIED IN TABLE N5.6-2. THE QCI AND QAI SHALL BE ENGAGED IN THEIR ASSIGNED |
| DOCUMENT ACCEPTANCE OR REJECTION OF BOLTED CONNECTIONS | • | | • | | INSPECTION DUTIES DURING INSTALLATION OF FASTENERS WHEN THESE METHODS ARE USED BY THE INSTALLER. |
| | | | | | 8. OBSERVATION OF BOLTING OPERATIONS SHALL BE THE PRIMARY METHOD USED TO CONFIRM THAT THE MATERIALS, PROCEDURES AND WORKMANSHIP INCORPORATED IN CONSTRUCTION ARE IN CONFORMANCE WITH THE CONSTRUCTION DOCUMENTS AND THE PROVISIONS OF THE RCSC SPECIFICATION. |



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FLAMING GORGE RANGER DISTRICT

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STRUCTURAL STEEL SPECIAL INSPECTION SCHEDULE (CONT.)


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GENERAL STEEL SPECIAL INSPECTION NOTES:

- QUALITY ASSURANCE (QA) INSPECTION OF FABRICATED ITEMS SHALL BE MADE AT THE FABRICATOR'S PLANT. THE QUALITY ASSURANCE INSPECTOR (QAI) SHALL SCHEDULE THIS WORK TO
 MINIMIZE INTERRUPTION TO THE WORK OF THE FABRICATOR.
- 2. QA INSPECTION OF THE ERECTED STEEL SYSTEM SHALL BE MADE AT THE PROJECT SITE. THE QAI SHALL SCHEDULE THIS WORK TO MINIMIZE INTERRUPTION TO THE WORK OF THE ERECTOR.
- 3. WHERE A TASK IS NOTED TO BE PERFORMED BY BOTH QC AND QA, IT IS PERMITTED TO COORDINATE THE INSPECTION FUNCTION BETWEEN THE QCI AND QAI SO THAT THE INSPECTION FUNCTIONS ARE PERFORMED BY ONLY ONE PARTY. WHERE QA RELIES UPON INSPECTION FUNCTIONS PERFORMED BY QC, THE APPROVAL OF THE CONTRACTING OFFICER IS REQUIRED.
- 4. THE FABRICATOR'S QCI SHALL INSPECT THE FABRICATED STEEL TO VERIFY COMPLIANCE WITH THE DETAILS SHOWN ON THE SHOP DRAWINGS, SUCH AS PROPER APPLICATION OF JOINT DETAILS AT EACH CONNECTION. THE ERECTOR'S QCI SHALL INSPECT THE ERECTED STEEL FRAME TO VERIFY COMPLIANCE WITH THE DETAILS SHOWN ON THE ERECTION DRAWINGS, SUCH AS BRACES, STIFFENERS, MEMBER LOCATIONS AND PROPER APPLICATION OF JOINT DETAILS AT EACH CONNECTION.
- 5. THE QAI SHALL BE ON THE PREMISES FOR INSPECTION DURING THE PLACEMENT OF ANCHOR RODS AND OTHER EMBEDMENTS SUPPORTING STRUCTURAL STEEL FOR COMPLIANCE WITH THE CONSTRUCTION DOCUMENTS. AS A MINIMUM, THE DIAMETER, GRADE, TYPE AND LENGTH OF THE ANCHOR ROD OR EMBEDDED ITEM, AND THE EXTENT OR DEPTH OF EMBEDMENT INTO THE CONCRETE, SHALL BE VERIFIED PRIOR TO PLACEMENT OF THE CONCRETE.
- 6. THE QAI SHALL INSPECT THE FABRICATED STEEL OR ERECTED STEEL FRAME, AS APPROPRIATE, TO VERIFY COMPLIANCE WITH THE DETAILS SHOWN ON THE CONSTRUCTION DOCUMENTS, SUCH AS BRACES, STIFFENERS, MEMBER LOCATIONS AND PROPER APPLICATION OF JOINT DETAILS AT EACH CONNECTION.
- 7. QUALITY ASSURANCE (QA) INSPECTIONS, EXCEPT NONDESTRUCTIVE TESTING (NDT), MAY BE WAIVED WHEN THE WORK IS PERFORMED IN A FABRICATING SHOP OR BY AN ERECTOR APPROVED BY THE AUTHORITY HAVING JURISDICTION (AHJ) TO PERFORM THE WORK WITHOUT QA. NDT OF WELDS COMPLETED IN AN APPROVED FABRICATOR'S SHOP MAY BE PERFORMED BY THAT FABRICATOR WHEN APPROVED BY THE AHJ. WHEN THE FABRICATOR PERFORMS THE NDT, THE QA AGENCY SHALL REVIEW THE FABRICATOR'S NDT REPORTS.
- 8. AT COMPLETION OF FABRICATION, THE APPROVED FABRICATOR SHALL SUBMIT A CERTIFICATE OF COMPLIANCE TO THE AHJ STATING THAT THE MATERIALS SUPPLIED AND WORK PERFORMED BY THE FABRICATOR ARE IN ACCORDANCE WITH THE CONSTRUCTION DOCUMENTS. AT COMPLETION OF ERECTION, THE APPROVED ERECTOR SHALL SUBMIT A CERTIFICATE OF COMPLIANCE TO THE AHJ STATING THAT THE MATERIALS SUPPLIED AND WORK PERFORMED BY THE ERECTOR ARE IN ACCORDANCE WITH THE CONSTRUCTION DOCUMENTS.
- 9. IDENTIFICATION AND REJECTION OF MATERIAL OR WORKMANSHIP THAT IS NOT IN CONFORMANCE WITH THE CONSTRUCTION DOCUMENTS, SHALL BE PERMITTED AT ANY TIME DURING THE PROGRESS OF THE WORK. HOWEVER, THIS PROVISION SHALL NOT RELIEVE THE OWNER OR THE INSPECTOR OF THE OBLIGATION FOR TIMELY, IN-SEQUENCE INSPECTIONS. NONCONFORMING MATERIAL AND WORKMANSHIP SHALL BE BROUGHT TO THE IMMEDIATE ATTENTION OF THE FABRICATOR OR ERECTOR. AS APPLICABLE.
- 10. NONCONFORMING MATERIAL OR WORKMANSHIP SHALL BE BROUGHT INTO CONFORMANCE, OR MADE SUITABLE FOR ITS INTENDED PURPOSE AS DETERMINED BY THE ENGINEER OF RECORD.
- 11. CONCURRENT WITH THE SUBMITTAL OF SUCH REPORTS TO THE CONTRACTING OFFICER, THE QA AGENCY SHALL SUBMIT TO THE FABRICATOR AND ERECTOR:
 - (1) NONCONFORMANCE REPORTS
 - (2) REPORTS OF REPAIR, REPLACEMENT OR ACCEPTANCE OF NONCONFORMING ITEMS.



REGION 4
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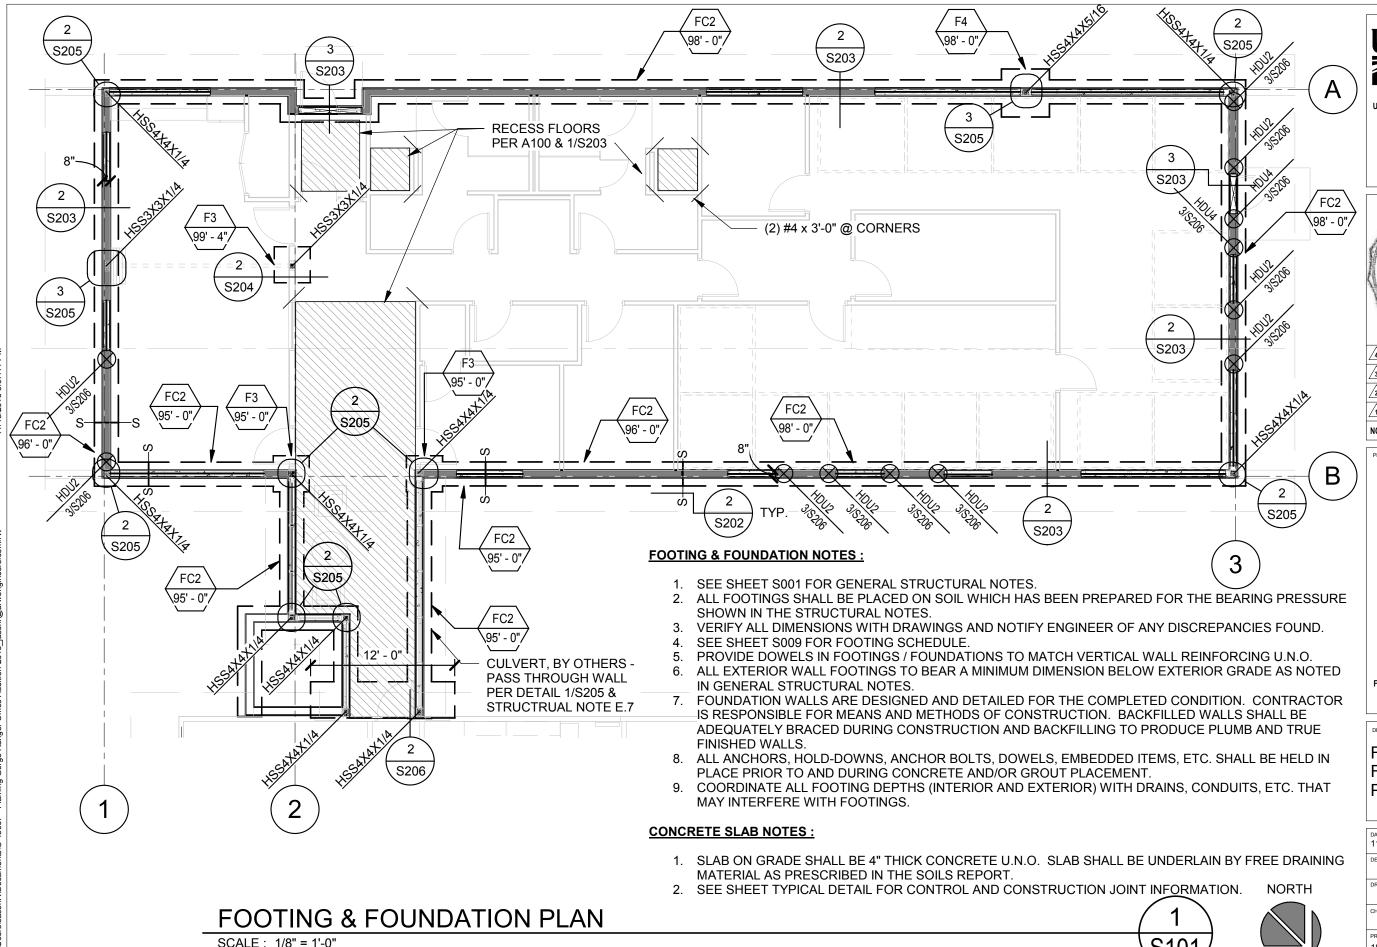
PROJECT NAME

FLAMING GORGE RANGER DISTRICT OFFICE ADDITION

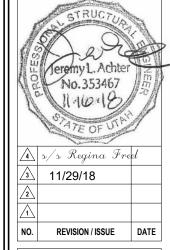ASHLEY
NATIONAL FOREST


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SCHEDULES



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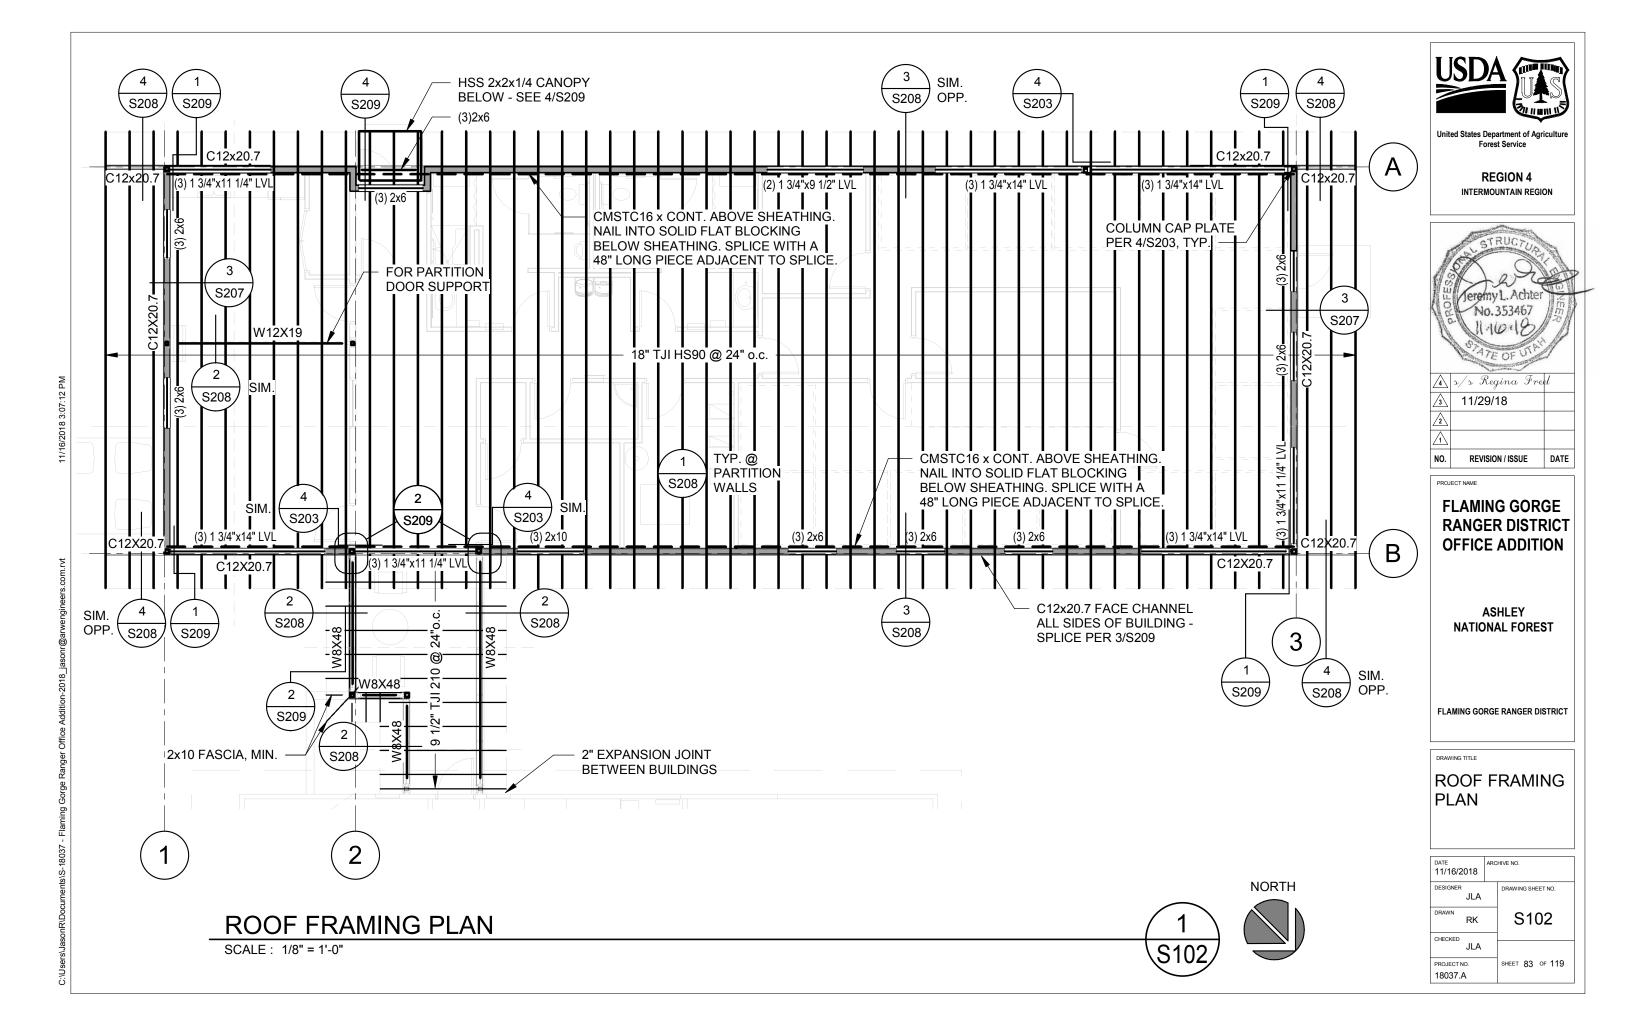
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FLAMING GORGE RANGER DISTRICT

DRAWING TITLE

FOOTING AND FOUNDATION PLAN

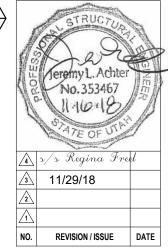
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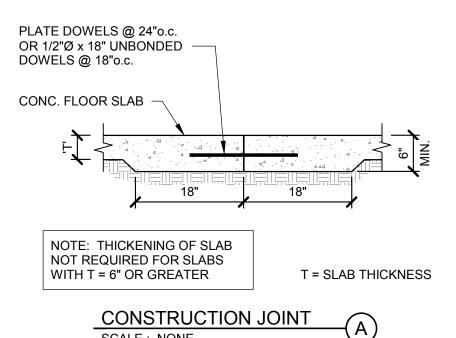








- 1. JOINTS SHALL OCCUR AT MAIN COLUMN/GRID LINES W/ 10'-0" MAX. SPACING BETWEEN JOINTS @ 4" SLABS.
- 2. SEE PLAN FOR SLAB THICKNESS 'T' AND REINFORCING SIZE AND SPACING.

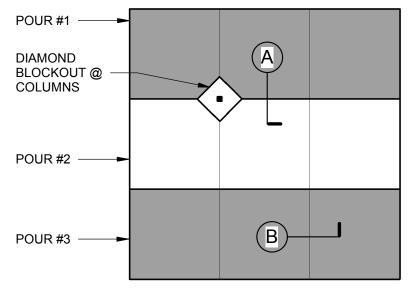

SCALE: NONE


SAWN OR FORMED JOINT CONC. FLOOR SLAB T = SLAB THICKNESS

CONTROL JOINT

(B)SCALE: NONE

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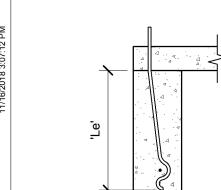
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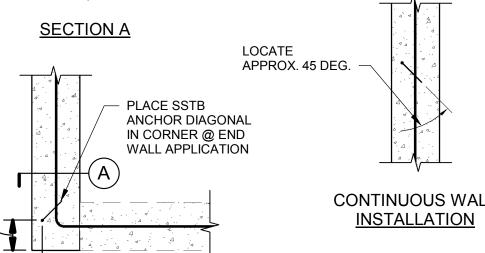
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TYPICAL CONCRETE SLAB JOINTS

SCALE: NONE

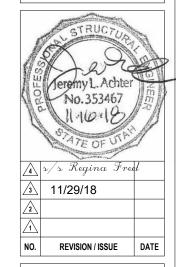

| | HOLDOWN SIZE | ANCHOR SIZE | MIN. EMBEDMENT DEPTH "Le" | |
|------|-----------------|----------------|------------------------------|--|
| | HDU2 | SSTB16 | 12-5/8" | |
| | HDU4 | SSTB20 | 16-5/8" | |
| Ш | | | | |
| - 11 | | | | |



HOLDOWN EMBED SCHEDULE

CONTINUOUS WALL CORNER / END WALL INSTALLATION

(2) #6 DOWELS (@ CONCRETE FOUND. WALLS ONLY) \ 30" 24" TYP. FOUNDATION REINFORCEMENT T = FOOTING THICKNESS H = FOOTING STEP HEIGHT TYP. FOUNDATION REINFORCEMENT FOOTING REINF. (TOP STEEL WHERE OCCURS) 2 x 'H' **FOOTING OUTLINE** NOTES: FOUNDATION REINFORCING NOT SHOWN FOR CLARITY. SEE FOOTING SCHEDULE FOR FOOTING WIDTH AND

REINFORCING SIZE AND LOCATION. ALL FOOTING REINFORCING REFERENCED IN THE SCHEDULE OR SHOWN IN THE DETAILS MUST RUN CONTINOUS

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DETAILS


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TYPICAL STEPPED FOOTING

THROUGH THE FOOTING STEP.

SCALE: NONE

SCALE: NONE



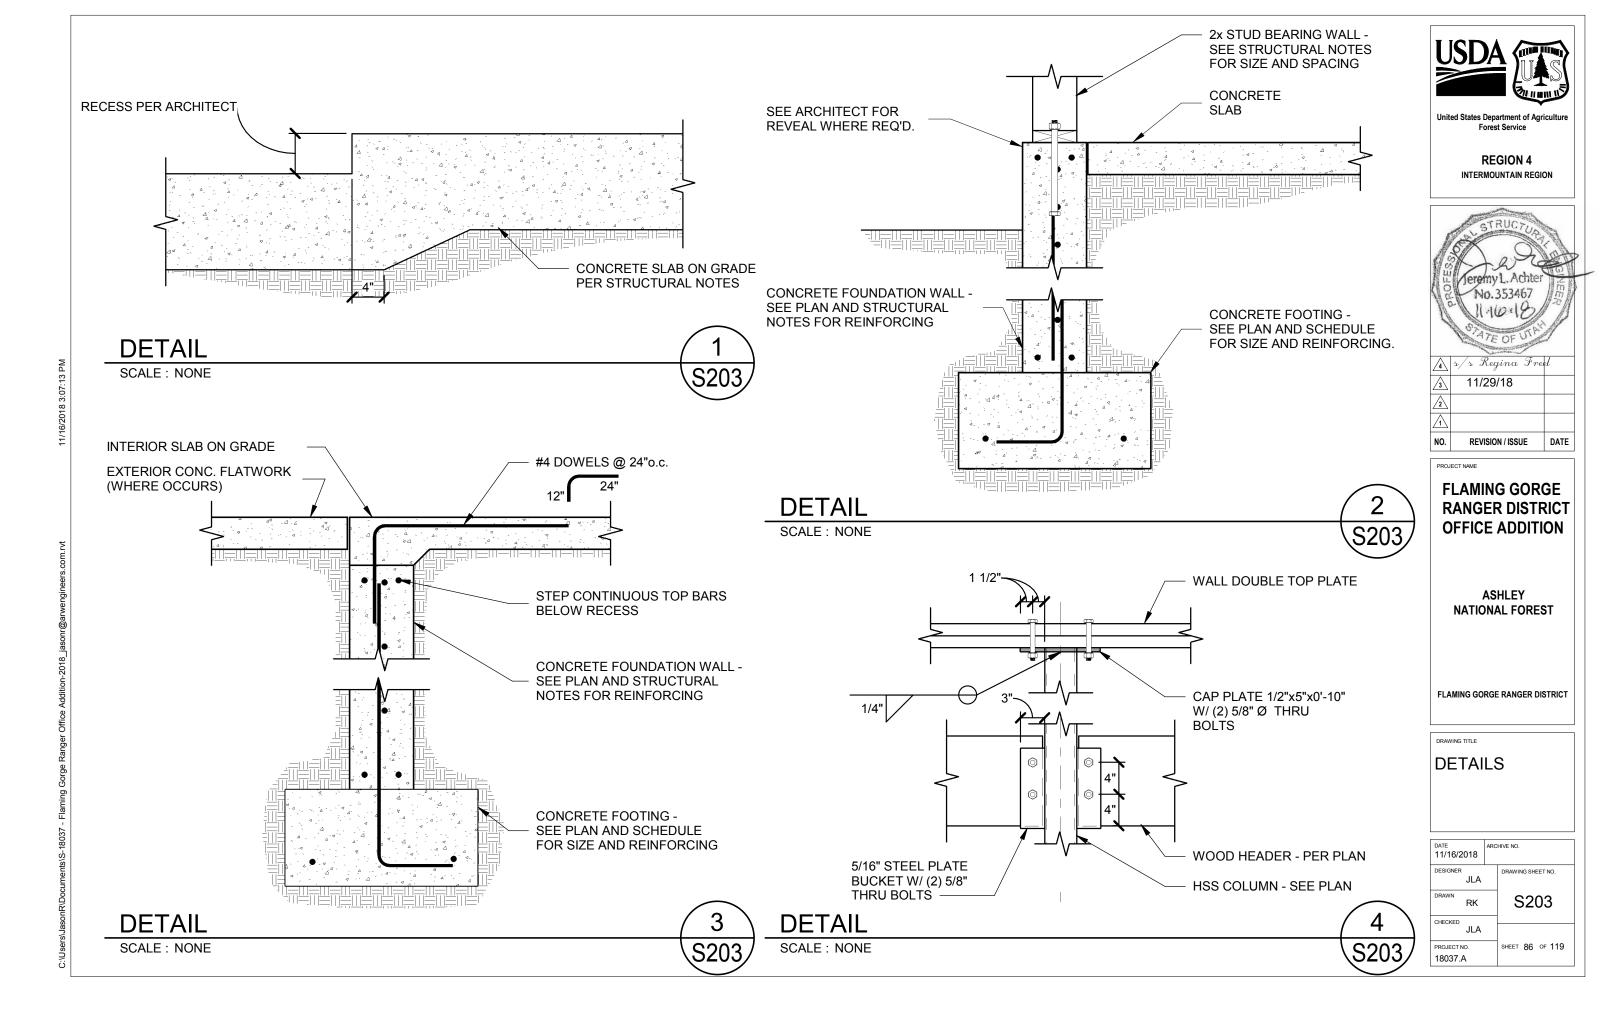



INTERSECTION

INTERSECTION



ls = LAP SPLICE LENGTH - SEE REBAR LAP

THIS DETAIL IS APPLICABLE AT ALL FOOTINGS AND

CORNER

CORNER

VERTICAL BARS NOT SHOWN


FOUNDATION WALLS

SCHEDULE

DOUBLE MAT

ALTERNATE BENDS, TYP.

SINGLE MAT

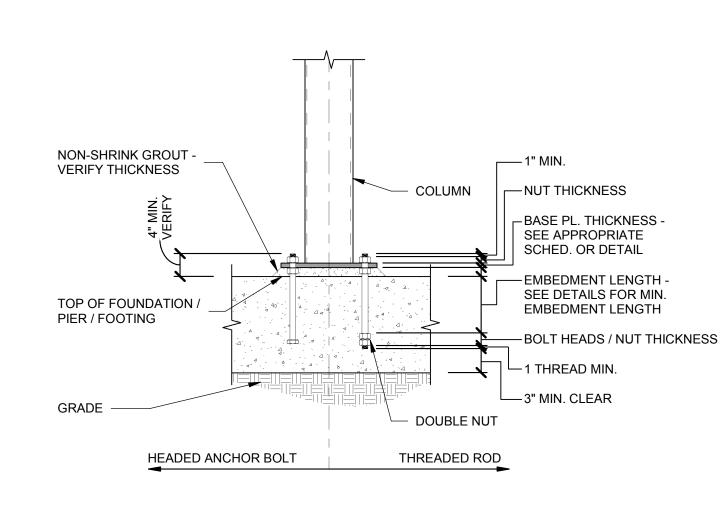




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REGION 4
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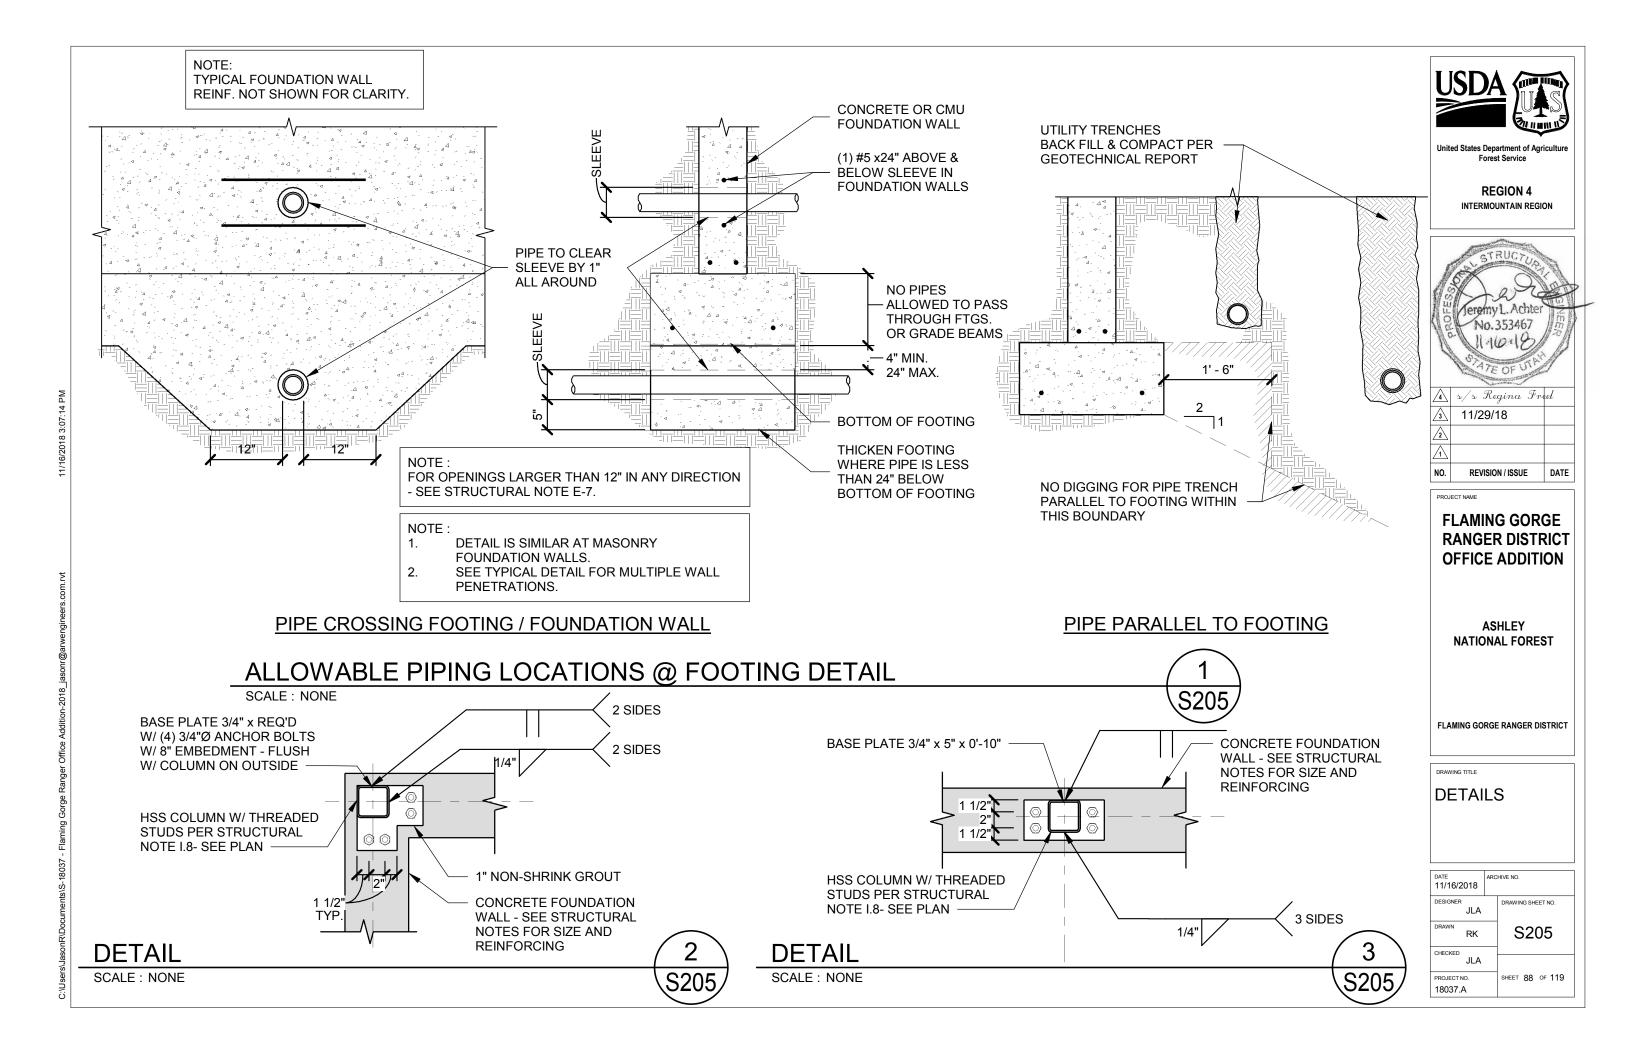
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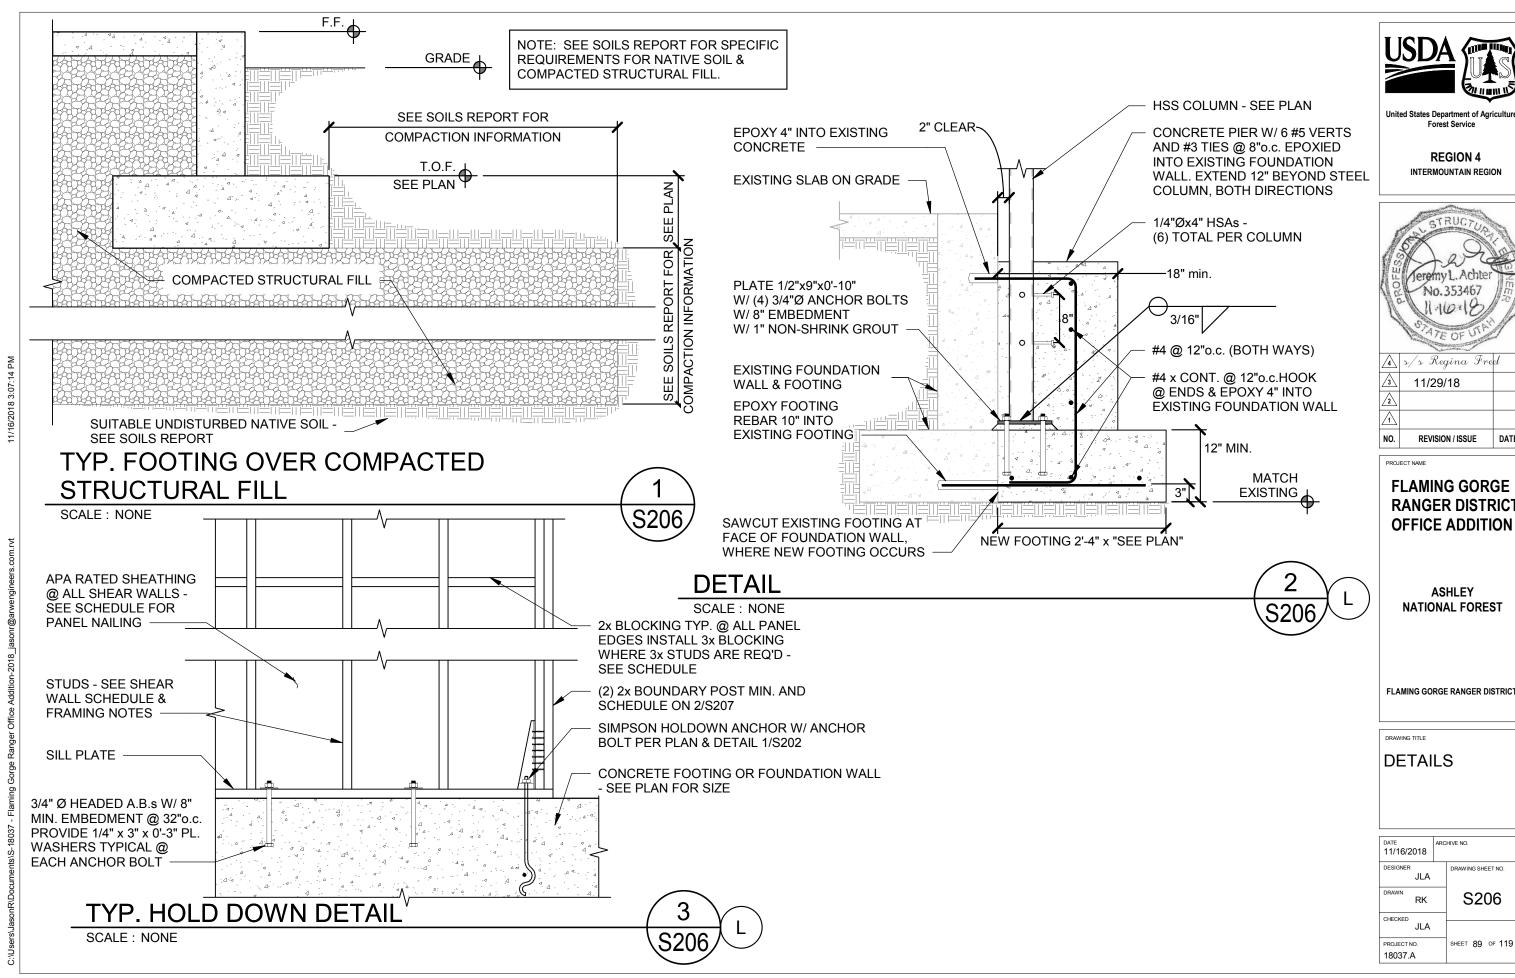
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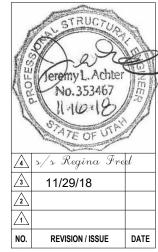
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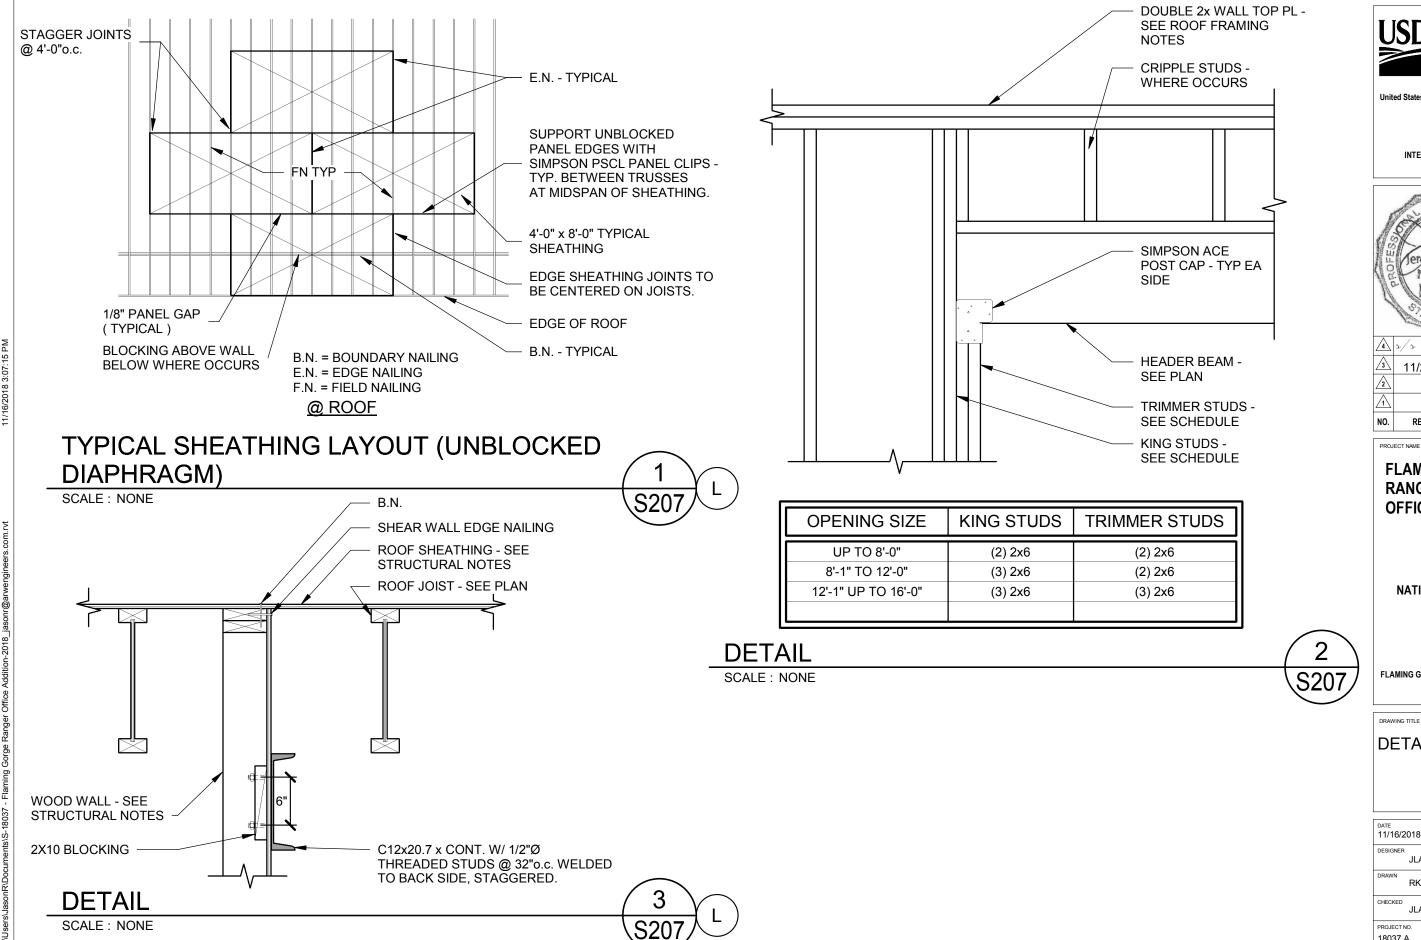


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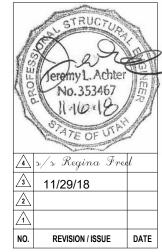
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FLAMING GORGE RANGER DISTRICT

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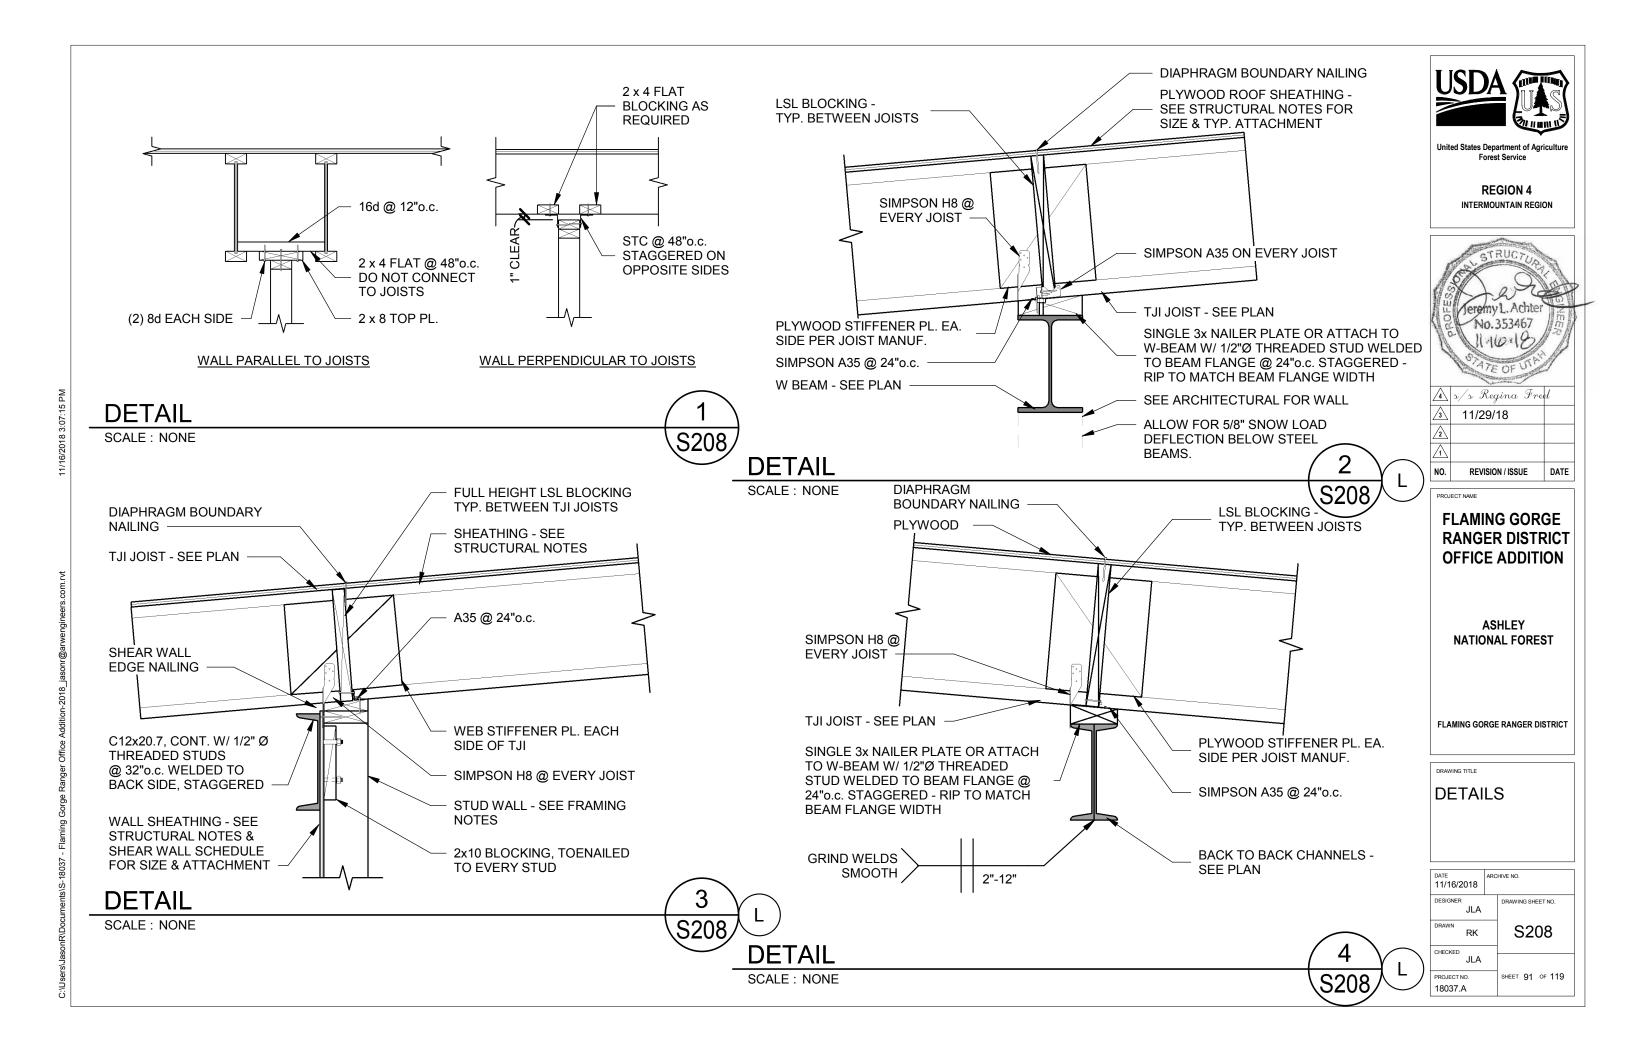
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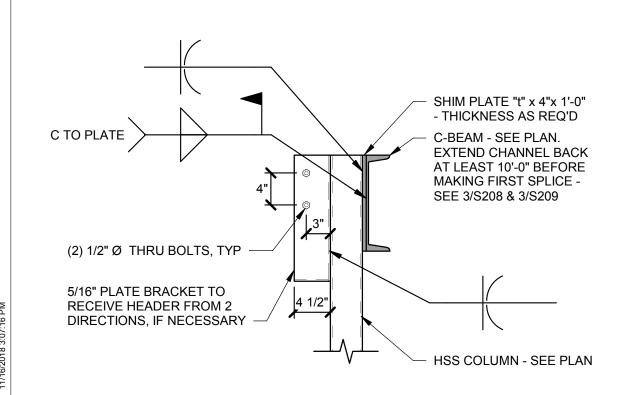
ASHLEY NATIONAL FOREST

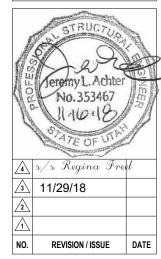
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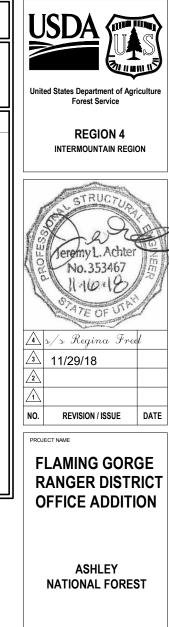
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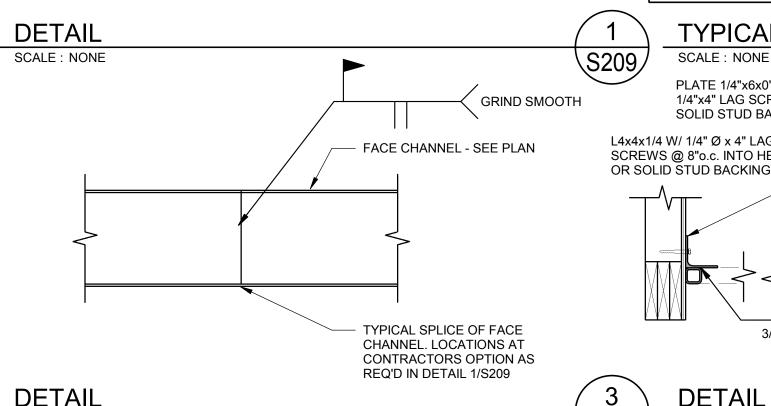
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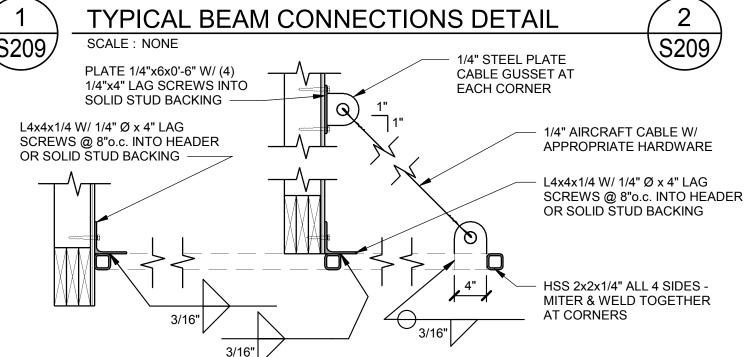




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SCALE: NONE

SCALE: NONE

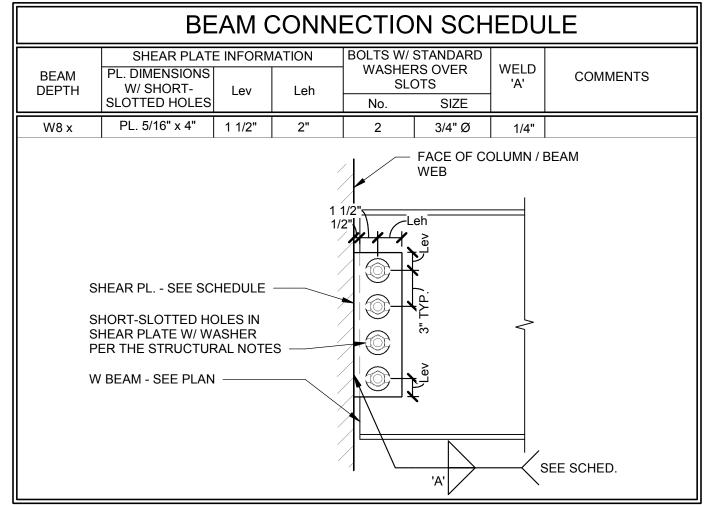


FLAMING GORGE RANGER DISTRICT

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FLAMING GORGE RANGER DISTRICT

DRAWING TITLE

SCHEMATIC REFERENCE

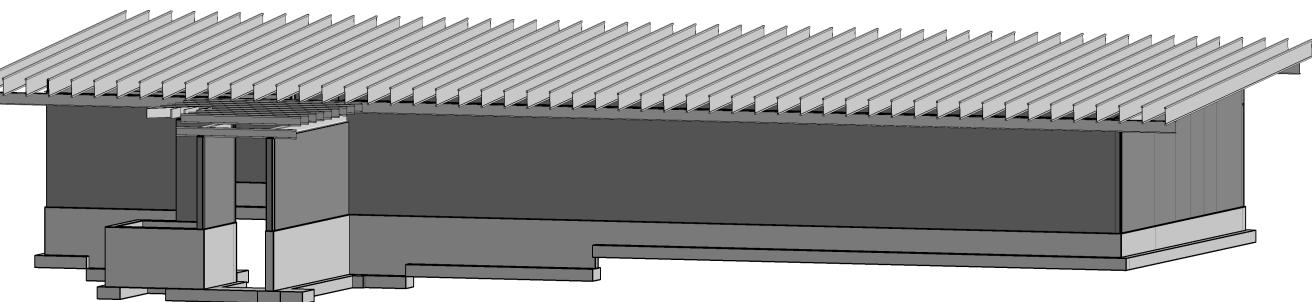
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| CHECKED JLA | |
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NOTE: THIS VIEW REPRESENTS A SCHEMATIC RENDERING ONLY AND IS NOT INTENDED TO CONVEY CONSTRUCTION INFORMATION. ALL CONSTRUCTION SHALL COMPLY WITH SPECIFIC NOTES AND DETAILS WITHIN THE STRUCTURAL DRAWINGS.

| PLUMBING LEGEND | | | | | |
|---|---|--|--|--|--|
| SYMBOL | DESCRIPTION | | | | |
| SYMBOL DCW DHW VPSSCBB PROBL RECTALLABI XX-1 ABV | DESCRIPTION DOMESTIC COLD WATER PIPING (DCW) DOMESTIC HOT WATER PIPING (DHW) VENT PIPING PROPANE GAS SANITARY SEWER PIPING CONDENSATE DRAIN BACKFLOW PREVENTOR WATER HAMMER ARRESTOR CHECK VALVE STRAINER WITH BLOWDOWN BALL VALVE PRESSURE REDUCING VALVE (PRV) CONCENTRIC REDUCER FLOOR CLEANOUT BLIND FLANGE OR CAP PIPING TEE DOWN PIPING UP PIPING TEE DOWN UNION OR FLANGE THERMOMETER PRESSURE GAUGE FLOOR DRAIN OR FLOOR SINK ROOF DRAIN PUMP WALL CLEANOUT HOSE BIBB DETAIL CALLOUT PLUMBING FIXTURE CALLOUT ABOVE | | | | |
| AFF CO COTG (E) FCO | ABOVE FINISH FLOOR CLEANOUT CLEANOUT TO GRADE EXISTING FLOOR CLEANOUT | | | | |
| N.I.C. VTR WCO | NOT IN CONTRACT VENT THRU ROOF WALL CLEANOUT | | | | |

PLUMBING GENERAL NOTES

- 1) THE CONTRACTOR SHALL NOT SHUT-OFF (PUT OUT OF SERVICE) ANY SYSTEM'S SERVICES WITHOUT FIRST COORDINATING ALL DOWNTIME WITH THE OWNER'S PERSONNEL. UTILITY INTERRUPTIONS REQUIRED TO ACCOMMODATE NEW CONNECTIONS MAY REQUIRE ODD HOUR WORK.
- 2) PIPE ROUTING IS APPROXIMATE, DIAGRAMMATIC, AND IS NOT TO BE SCALED. WHERE ALTERNATE ROUTING, OFFSETS AND TRANSITIONS ARE REQUIRED FOR COORDINATION OF ALL WORK, THE CONTRACTOR SHALL MAKE CHANGES WITHOUT ADDITIONAL COSTS.
- 3) THE CONTRACTOR SHALL CLOSELY COORDINATE NEW PLUMBING WITH ALL ELECTRICAL, MECHANICAL, ARCHITECTURAL, AND STRUCTURAL MEMBERS.
- 4) ALL PIPING AND PLUMBING SYSTEMS SHALL BE INSTALLED IN ACCORDANCE WITH THE LATEST EDITION OF THE INTERNATIONAL PLUMBING CODE, NATIONAL FIRE CODE, AND INTERNATIONAL FUEL GAS CODE.
- 5) WHEN CONNECTING NEW PIPING TO EXISTING, CONTRACTOR TO MATCH EXISTING PIPING MATERIAL UNLESS OTHERWISE INDICATED.
- 6) PRIME & PAINT ALL EXPOSED PIPES AND PIPE SUPPORTS.
- 7) ALL EXTERIOR SUPPORTS, BRACES, ANCHORS, ETC. W/ OPEN ENDS TO BE CAPPED & SEALED WEATHERTIGHT.
- 8) ROOF FLASHING MATERIALS: UNLESS NOTED ELSEWHERE, PROVIDE ROOF FLASHING AS REQUIRED / RECOMMENDED BY ROOFING AND/OR PIPING MANUFACTURERS.
- 9) PROVIDE ACCESS PANELS FOR SERVICING OF WALL HYDRANT, TRAP PRIMERS, AND WATER HAMMER ARRESTORS.

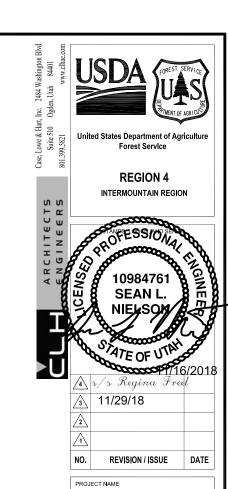

FLAMING GORGE RANGER DISTRICT OFFICE ADDITION

ASHLEY NATIONAL FOREST

FLAMING GORGE RANGER DISTRICT

DRAWING TITLE

PLUMBING LEGEND

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| | WATER HAMMER ARRESTER SCHEDULE | | | | | | | | | | |
|---------|--------------------------------|------------------|----------------------|----------------|--------------|----------------|--|--|--|--|--|
| MARK | MANUF. & MODEL | FIXTURE UNITS | PIPE SIZE (IN) | HEIGHT (IN) | DIA. (IN) | REMARKS | | | | | |
| WHA-A | J.R. SMITH 5005 | 1-11 | 3/4" | 2.62" | 3.25" | PROVIDE ACCESS | | | | | |
| WHA-B | J.R. SMITH 5010 | 12-32 | 1" | 2.97" | 3.25" | PROVIDE ACCESS | | | | | |
| WHA-C | J.R. SMITH 5020 | 33-60 | 1" | 3.59" | 3.25" | PROVIDE ACCESS | | | | | |
| NOTE: A | LL WATER HAMMEI | R ARRESTERS | S LISTED IN | SCHEDULE M | IAY NOT AP | PEAR ON | | | | | |


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REGION 4 INTERMOUNTAIN REGION



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FLAMING GORGE RANGER DISTRICT OFFICE **ADDITION**

ASHLEY NATIONAL FOREST

FLAMING GORGE RANGER DISTRICT
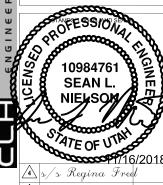
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PLUMBING NOTES AND **SCHEDULES**


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| | GAS WATER HEATER SCHEDULE | | | | | | | | | | | |
|------|---------------------------|------------------|---------------------------|--------|--------------------|----------------------------------|-----------------|---------------------|-------------------------------|-----------------|--------------------------|--|
| MARK | MANUFACTURER & MODEL | SYSTEM SERVED | TANK CAPACITY (GAL) | | OUTPUT (BTU/HR) | RECOVERY @ 90°F RISE (GPH) | VOLTS/ PHASE | GAS CONN (IN) | MAX. GAS PRESSURE ("WC) | WEIGHT (LBS) | DIMENSIONS HxWxD (IN) | NOTES |
| WH 1 | AO SMITH GPDT-50 (LP) | RESTROOMS | 50 | 45,000 | - | 50 | 120 / 1 | 1/2 | 14" | 576 | 68 x 22 | 2" CONCENTRIC VENT, 2 GAL. EXPANSION TANK. |

| | PIPING AND EQUIPMENT INSULATION SCHEDULE | | | | | | | | | |
|---------------|--|-------------------------|--------|-------------------------|--------|-------|--|--|--|--|
| SYMBOL SYSTEM | INDO | OOR | OUTE | OOR | NOTES | | | | | |
| STWIDOL | STSTEIN | MATERIAL | JACKET | MATERIAL | JACKET | NOTES | | | | |
| DCW DHW | DOMESTIC WATER | FLEXIBLE ELASTOMERIC | - | FLEXIBLE ELASTOMERIC | - | | | | | |
| L&S | REFRIGERANT LINES | FLEXIBLE ELASTOMERIC | - | FLEXIBLE ELASTOMERIC | PAINT | | | | | |

| | MINIMUM PIPE INSULATION THICKNESS TABLE | | | | | | | | | |
|-------------------------------|---|-----------------------------------|---------------------------|---------------------------------|---------------|---------------|-----------|------|--|--|
| FLUID DESIGN | VAPOR BARRIER | | | NOMINAL PIPE OR TUBE SIZE (in.) | | | | | | |
| OPERATING TEMP. RANGE (°F) | RATING (PERMS) | CONDUCTIVITY Btu·in/(h·ft².°F) | MEAN RATING TEMP. (°F) | <1" | 1" TO <1 1/2" | 1 1/2" TO <4" | 4" TO <8" | ≥ 8" | | |
| 105-140 | - | 0.22-0.28 | 100 | 1.0 | 1.0 | 1.5 | 1.5 | 1.5 | | |
| 40-60 | <0.05 | 0.21-0.27 | 75 | 0.5 | 0.5 | 1.0 | 1.0 | 1.0 | | |
| <40 | <0.02 | 0.20-0.26 | 50 | 0.5 | 1.0 | 1.0 | 1.0 | 1.5 | | |



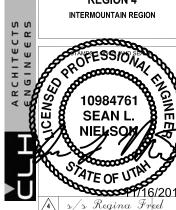

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PROJECT NAME

FLAMING GORGE RANGER DISTRICT OFFICE ADDITION

ASHLEY NATIONAL FOREST

FLAMING GORGE RANGER DISTRICT

DRAWING TITLE

PLUMBING SCHEDULES

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| | | PLUM | BING | FIXTU | JRE S | CHED | ULE | |
|-------------|--|---|--------------|--------|-------|-------------|-------------|--|
| MARK | DESCRIPTION | MANUFACTURER | GPM | | CONN | ECTIONS | ī | - REMARKS |
| | | & MODEL | 0 | CW | HW | WASTE | VENT | |
| BFP-1 | BACKFLOW PREVENTER | WATTS ULF007M1QTS | | 1 1/2" | | | | DOUBLE CHECK VALVE ASSEMBLY, LEAD FREE, STRAINER, UNIONS, QUARTER TURN BALL VALVES |
| EWC-1 | DRINKING FOUNTAIN REFRIGERATED | ELKAY EZSTLG8WS | 8 GPH | 3/8" | | 1 1/4" | | ADA, WALL HUNG, BI-LEVEL, CONTROLS ON FRONT & SIDES, 115V/1"Ø HARD WIRED ELECTRICAL CONNECTION, INCLUDE EZH2O BOTTLE FILLING STATION, ON LOWER BOWL. |
| <u>FCO</u> | FLOOR CLEANOUT | J. R. SMITH 4020 SERIES | | | | | | MATCH CLEANOUT SIZE TO PIPE IT SERVES, NICKEL TOP. |
| <u>FD-1</u> | ROUND HEAD FLOOR DRAIN | J. R. SMITH 2005Y-A-NB | | | | 2" | 1 1/2" | ROUND HEAD, NICKEL BRONZE STRAINER, PRIMER CONNECTION WHERE APPLICABLE. |
| <u>FD-2</u> | SQUARE HEAD FLOOR DRAIN | J. R. SMITH 2005Y-B-NB | | I | | 2" | 1 1/2" | SQUARE HEAD, NICKEL BRONZE STRAINER, PRIMER CONNECTION WHERE APPLICABLE. |
| FWH-1 | BOX TYPE FREEZELESS WALL HYDRANT | WOODFORD B67 SERIES | | 3/4" | | | | AUTOMATIC DRAINING WITH BACKFLOW PROTECTED, LOCKABLE BOX, MOUNT 30" ABOVE FINISH GRADE ROUGH BRONZE FINISH |
| LAV-1 | DROP IN COUNTER MOUNT LAVATORY | AMERICAN STANDARD 0476.028 SINK 6114.116.002 FAUCET | 0.5 | 3/8" | 3/8" | 1 1/2" | 1 1/4" | ADA WRAP ON PIPES. |
| <u>MS-1</u> | MOP SINK W/ FAUCET | AMERICAN STANDARD 7741.000 SINK 8344.012 FAUCET | | 1/2" | 1/2" | 2" | 1 1/2" | PROVIDE SINK RIM GUARD, FAUCET HAS BACKFLOW PREVENTOR, WALL BRACE, 3/4" HOSE END THREADS, RUBBER HOSE, AND WALL HOOK. |
| <u>MV-1</u> | MIXING VALVE | ACCORN ST70 | | 3/8" | 3/8" | | | |
| <u>S-1</u> | KITCHEN SINK w/ DISPOSAL | AMERICAN STANDARD 4147.001.075 ELKAY ELUHAD311855PD INSINKERATOR BADGER 5XP | 1.5 | 1/2" | 1/2" | 1 1/2" | 1 1/2" | UNDERMOUNT DOUBLE BOWL STAINLESS STEEL, SINGLE HANDLE, SINGLE HOLE FAUCET, LESS ESCUTCHEN PLATE & SPRAYER, FOOD DISPOSAL. |
| <u>SH-1</u> | SHOWER ADA W/ HAND SHOWER | AMERICAN STANDARD #1662-601 | 1.5 | 1/2" | 1/2" | 2" | | AMERICAN STANDARD 1662.601F15 HANDSHOWER ON GRAB BAR, PRESSURE BALANCING MIXING VALVE, BRASS DRAIN. |
| <u>TP-1</u> | TRAP PRIMER CLOSET PRIMER | PRECISION PLUMBING PRODUCTS WCP-1 | | 5/8" | | | | |
| <u>UR-1</u> | WALL HUNG URINAL | AMERICAN STANDARD #6590.001 SLOAN #8186-0.125-OR | 0.125 GPF | 3/4" | | 2" | 1 1/2" | BATTERY POWERED SENSOR VALVE w/OVERRIDE BUTTON |
| <u>WB-1</u> | WATER BOX | SIOUX CHIEF 696-1010MF | | 1/2" | | | | ICE MAKER OUTLET BOX, PROVIDE STAINLESS STEEL HOSE. |
| <u>WC-1</u> | WATER CLOSET | AMERICAN STANDARD 211CA.104 | 1.28 GPF | 1/2" | | 3" | SEE PLAN | FLOOR MOUNTED, ELONGATED HET TOILET, OPEN FRONT SEAT, HANDLE ON WIDE SIDE. |
| <u>WC-2</u> | WATER CLOSET | AMERICAN STANDARD 211AA.104 | 1.28 GPF | 1/2" | | 3" | SEE PLAN | FLOOR MOUNTED, ELONGATED HET TOILET, OPEN FRONT SEAT, HANDLE ON WIDE SIDE, ADA HEIGHT. |
| wco | WALL CLEANOUT | J. R. SMITH 4472T | | | | (LINE SIZE) | | PROVIDE W/ WALL ACCESS COVER |

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United States Department of Agriculture
Forest Service

REGION 4

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PROJECT NAME

FLAMING GORGE RANGER DISTRICT OFFICE ADDITION

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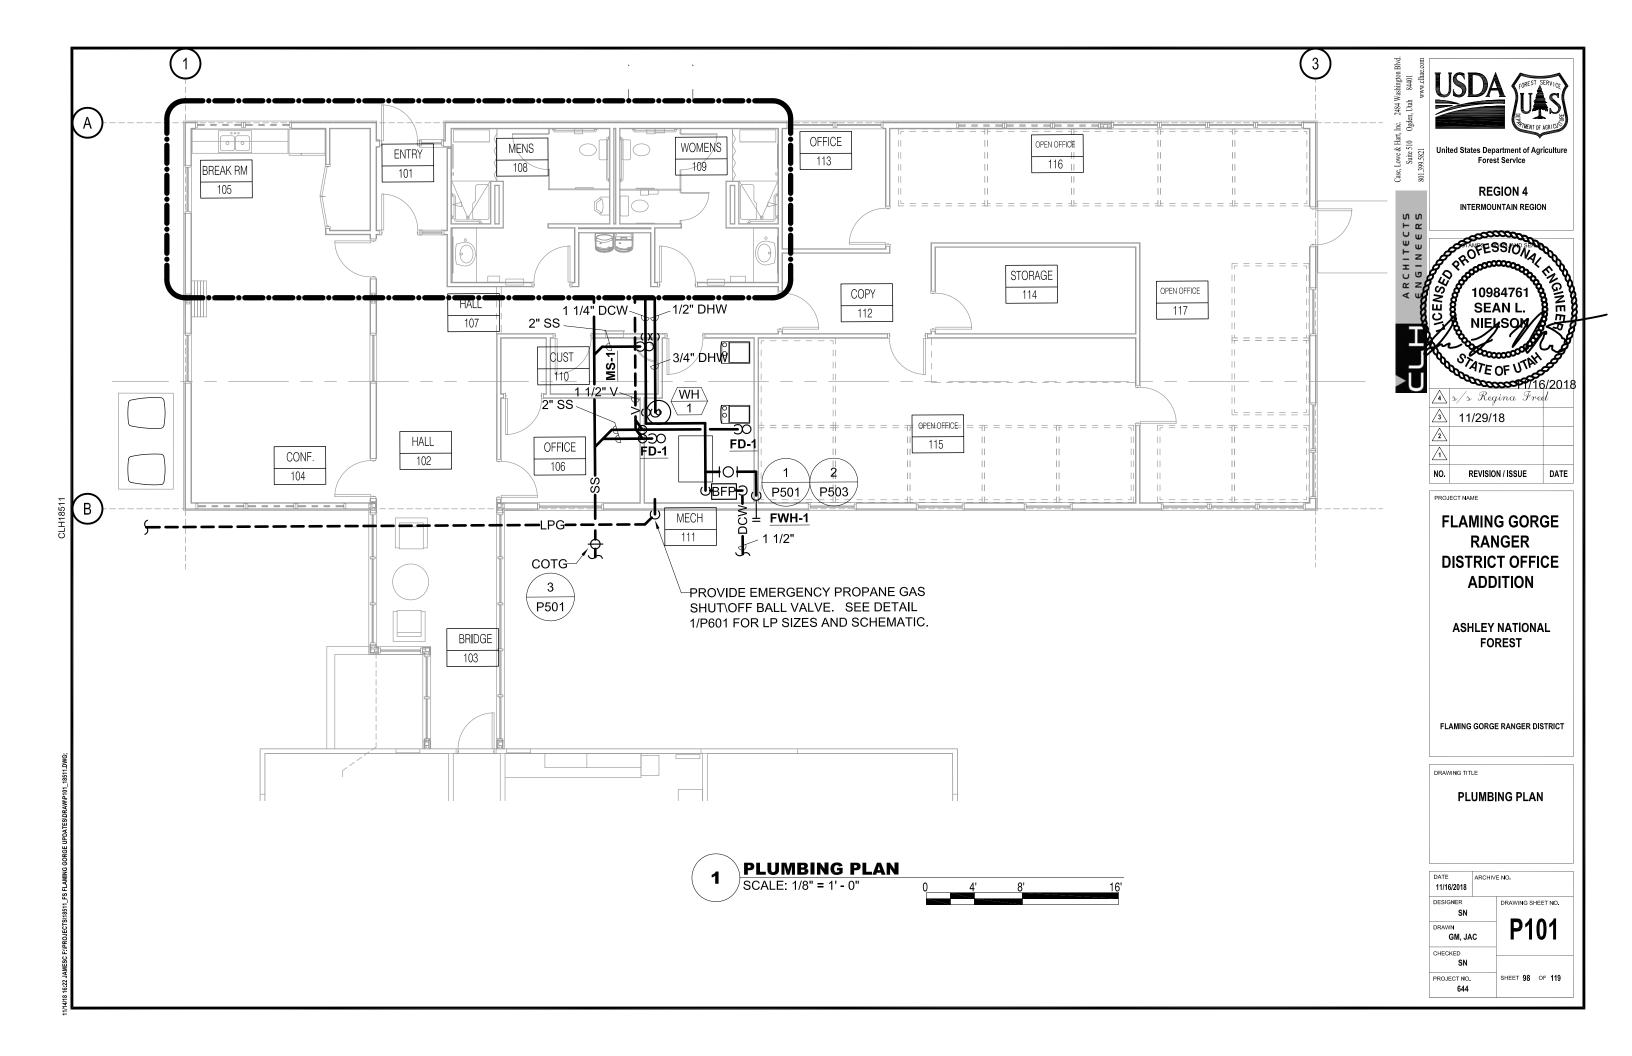
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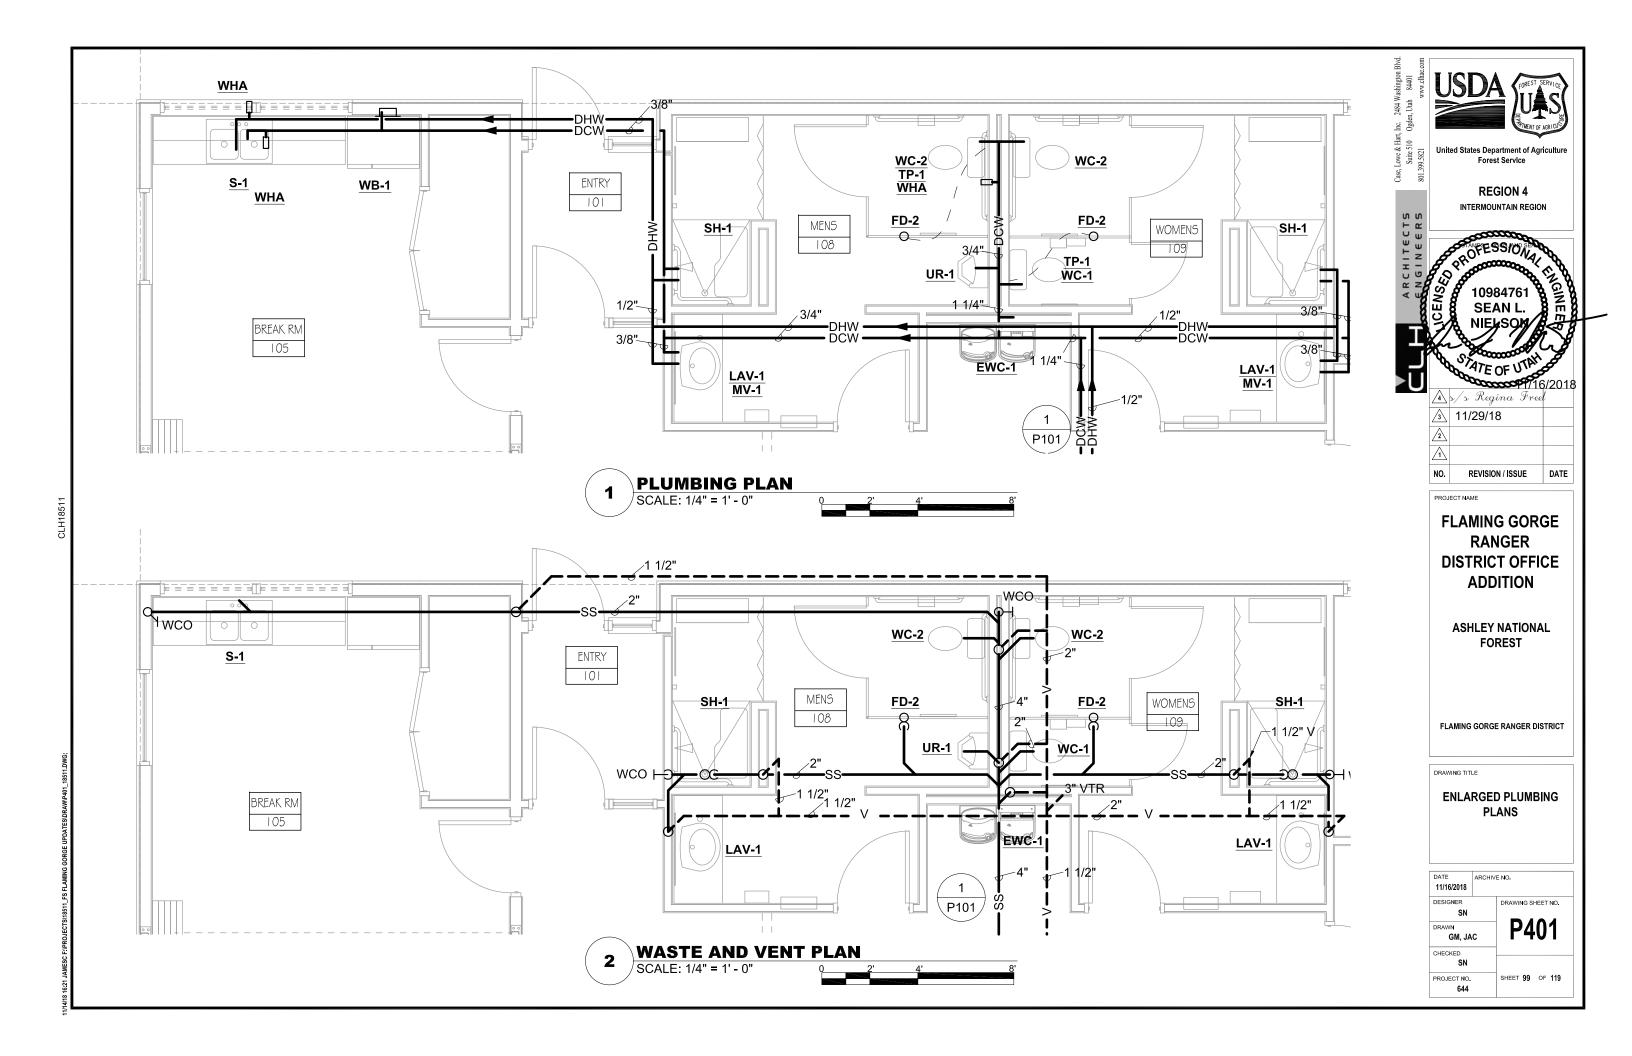
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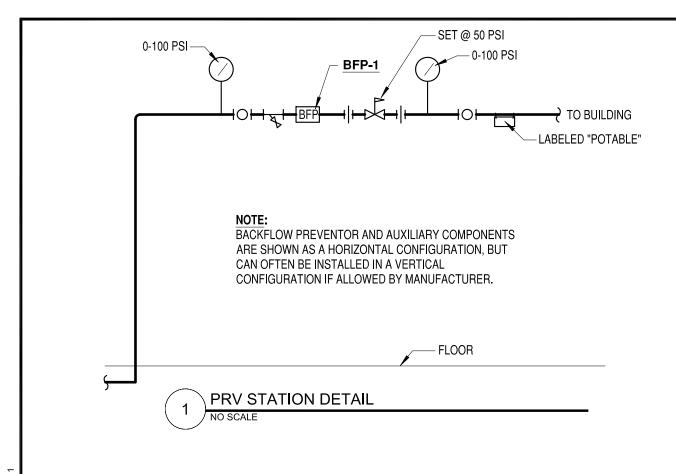
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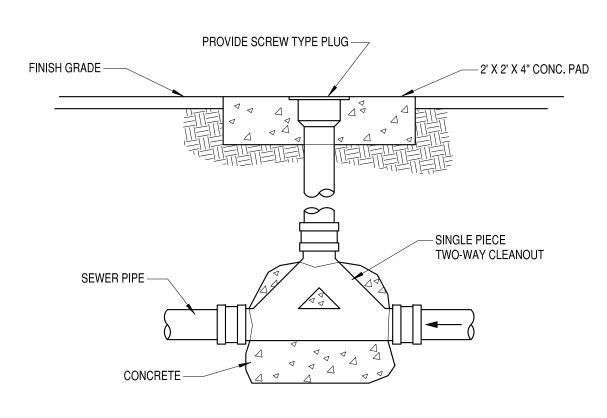
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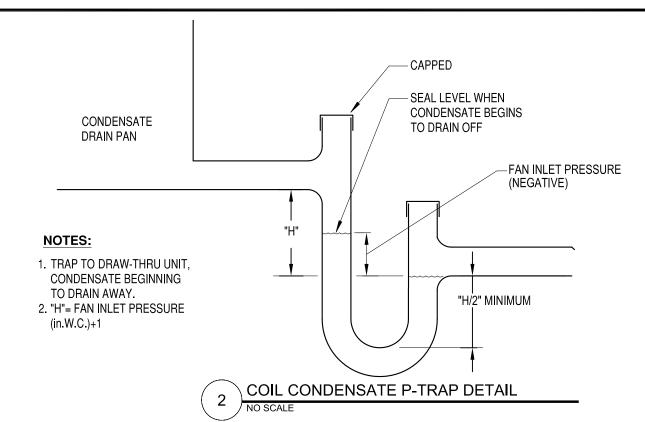










TWO-WAY (BAFFLE) CLEANOUT TO GRADE



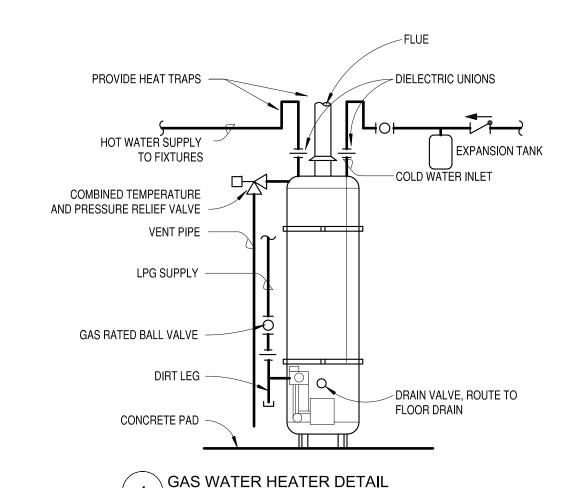

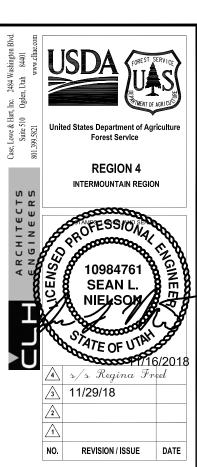


FLAMING GORGE
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United States Department of Agriculture Forest Service **REGION 4** INTERMOUNTAIN REGION

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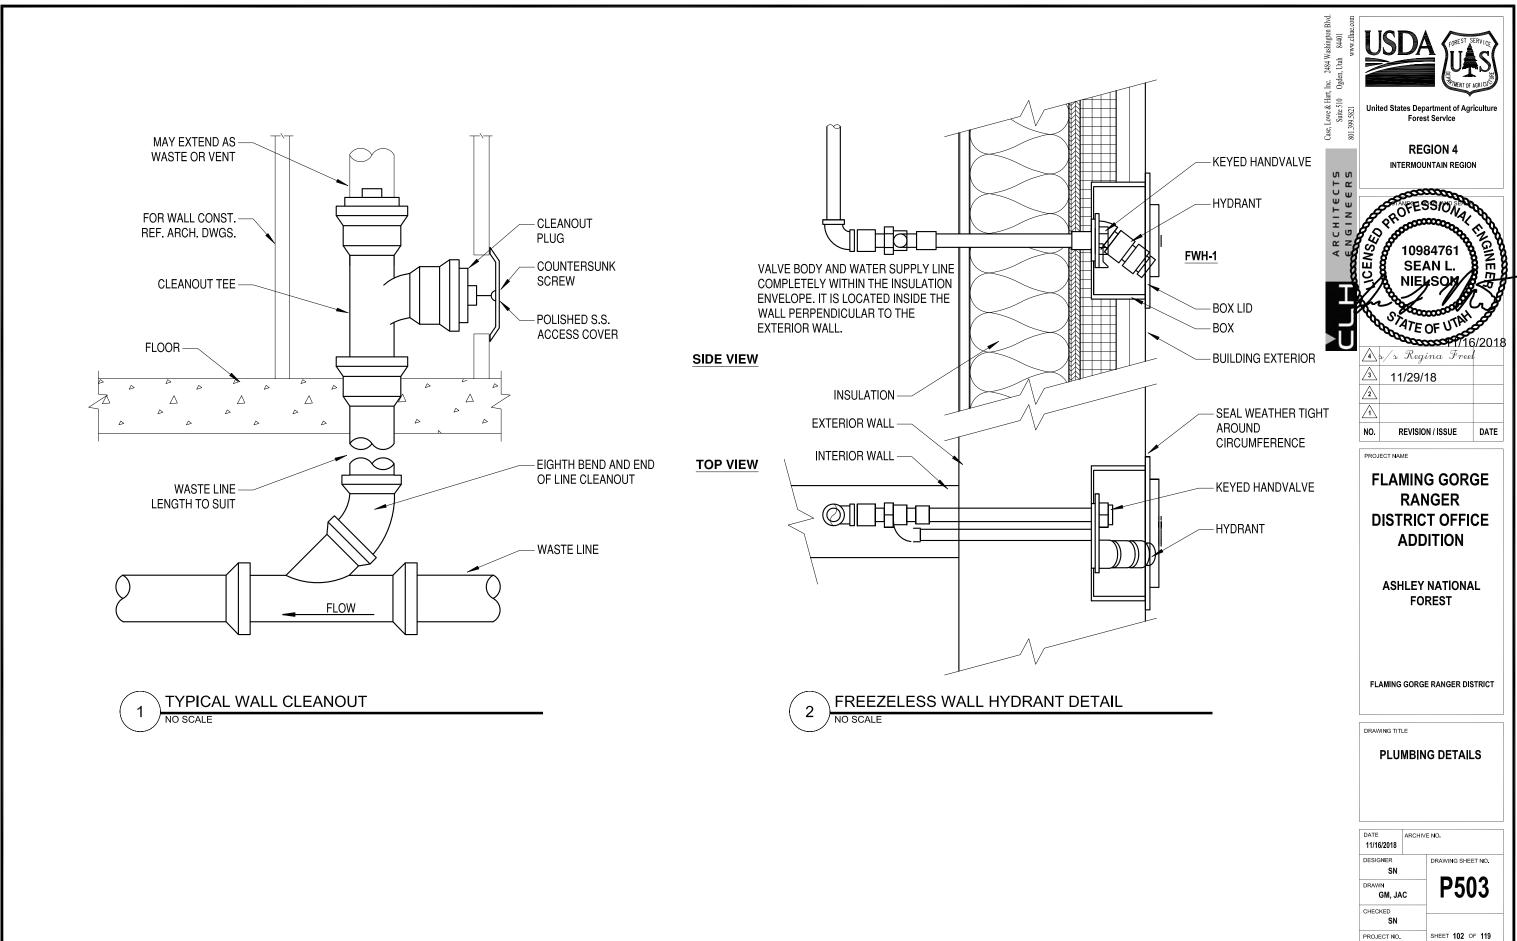
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FLAMING GORGE RANGER DISTRICT

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EXCAVATED TRENCH WIDTH

PLASTIC PIPE SHOULD ALWAYS BE BURIED IN STRICT ACCORDANCE WITH THE ASTM STANDARD RELEVANT TO THE TYPE OF PLASTIC PIPING SYSTEM BEING INSTALLED. THOSE STANDARDS ARE:

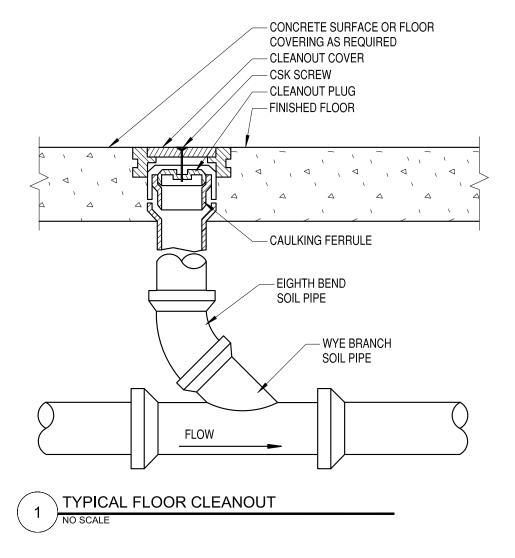ASTM D2321 STANDARD PRACTICE FOR UNDERGROUND INSTALLATION OF THERMOPLASTIC PIPE FOR SEWERS AND OTHER GRAVITY-FLOW APPLICATIONS.

ASTM D2774 STANDARD PRACTICE FOR UNDERGROUND INSTALLATION OF THERMOPLASTIC PRESSURE PIPING.

NOTE: IN ADDITION TO THESE STANDARDS, PIPE SHOULD ALWAYS BE INSTALLED IN ACCORDANCE WITH ALL LOCAL CODE REQUIREMENTS.

RECOMMENDATIONS FOR UNDERGROUND INSTALLATION OF PLASTIC DRAINAGE PIPE:

- 1. THE MINIMUM WIDTH OF THE TRENCH SHOULD BE THE PIPE OD (OUTSIDE DIAMETER) PLUS 16 INCHES OR THE PIPE OUTSIDE DIAMETER TIMES 1.25 PLUS 12 INCHES. THIS WILL ALLOW ADEQUATE ROOM FOR JOINING THE PIPE, SNAKING THE PIPE IN THE TRENCH TO ALLOW FOR EXPANSION AND CONTRACTION WHERE APPROPRIATE AND SPACE FOR BACKFILLING AND COMPACTION OF BACKFILL. THE SPACE BETWEEN THE PIPE AND TRENCH WALL MUST BE WIDER THAN THE COMPACTION EQUIPMENT USED TO COMPACT THE BACKFILL.
- PROVIDE A MINIMUM OF 4 INCHES OF FIRM, STABLE AND UNIFORM BEDDING MATERIAL IN THE TRENCH BOTTOM.
 IF ROCK OR UNYIELDING MATERIAL IS ENCOUNTERED, A MINIMUM OF 6 INCHES OF BEDDING SHALL BE USED.
 BLOCKING SHOULD NOT BE USED TO CHANGE PIPE GRADE OR TO INTERMITTENTLY SUPPORT PIPE OVER
 LOW SECTIONS IN THE TRENCH.
- 3. THE PIPE SHOULD BE SURROUNDED WITH AN AGGREGATE MATERIAL WHICH CAN BE EASILY WORKED AROUND THE SIDES OF THE PIPE. BACKFILLING SHOULD BE PERFORMED IN LAYERS OF 6 INCHES WITH EACH LAYER BEING SUFFICIENTLY COMPACTED TO 85% TO 95% COMPACTION.
- 4. A MECHANICAL TAMPER IS RECOMMENDED FOR COMPACTING SAND AND GRAVEL. THESE MATERIALS CONTAIN FINE-GRAINS, SUCH AS SILT AND CLAY. IF A TAMPER IS NOT AVAILABLE, COMPACTING SHOULD BE DONE BY HAND.
- 5. THE TRENCH SHOULD BE COMPLETELY FILLED. THE BACKFILL SHOULD BE PLACED AND SPREAD IN UNIFORM LAYERS TO PREVENT ANY UNFILLED SPACES OR VOIDS. LARGE ROCKS, STONES, FROZEN CLODS, OR OTHER LARGE DEBRIS SHOULD BE REMOVED. STONE BACKFILL SHALL PASS THROUGH AN 1-1/2" SIEVE. ROCK SIZE SHOULD BE ABOUT ONE-TENTH OF THE PIPE OUTSIDE DIAMETER. HEAVY TAMPERS OR ROLLING EQUIPMENT SHOULD ONLY BE USED TO CONSOLIDATE THE FINAL BACKFILL.
- 6. TO PREVENT DAMAGE TO THE PIPE AND DISTURBANCE TO PIPE EMBEDMENT, A MINIMUM DEPTH OF BACKFILL ABOVE THE PIPE SHOULD BE MAINTAINED. PIPE SHOULD ALWAYS BE INSTALLED BELOW THE FROST LEVEL. TYPICALLY, IT IS NOT ADVISABLE TO ALLOW VEHICULAR TRAFFIC OR HEAVY CONSTRUCTION EQUIPMENT TO TRAVERSE THE PIPE TRENCH.



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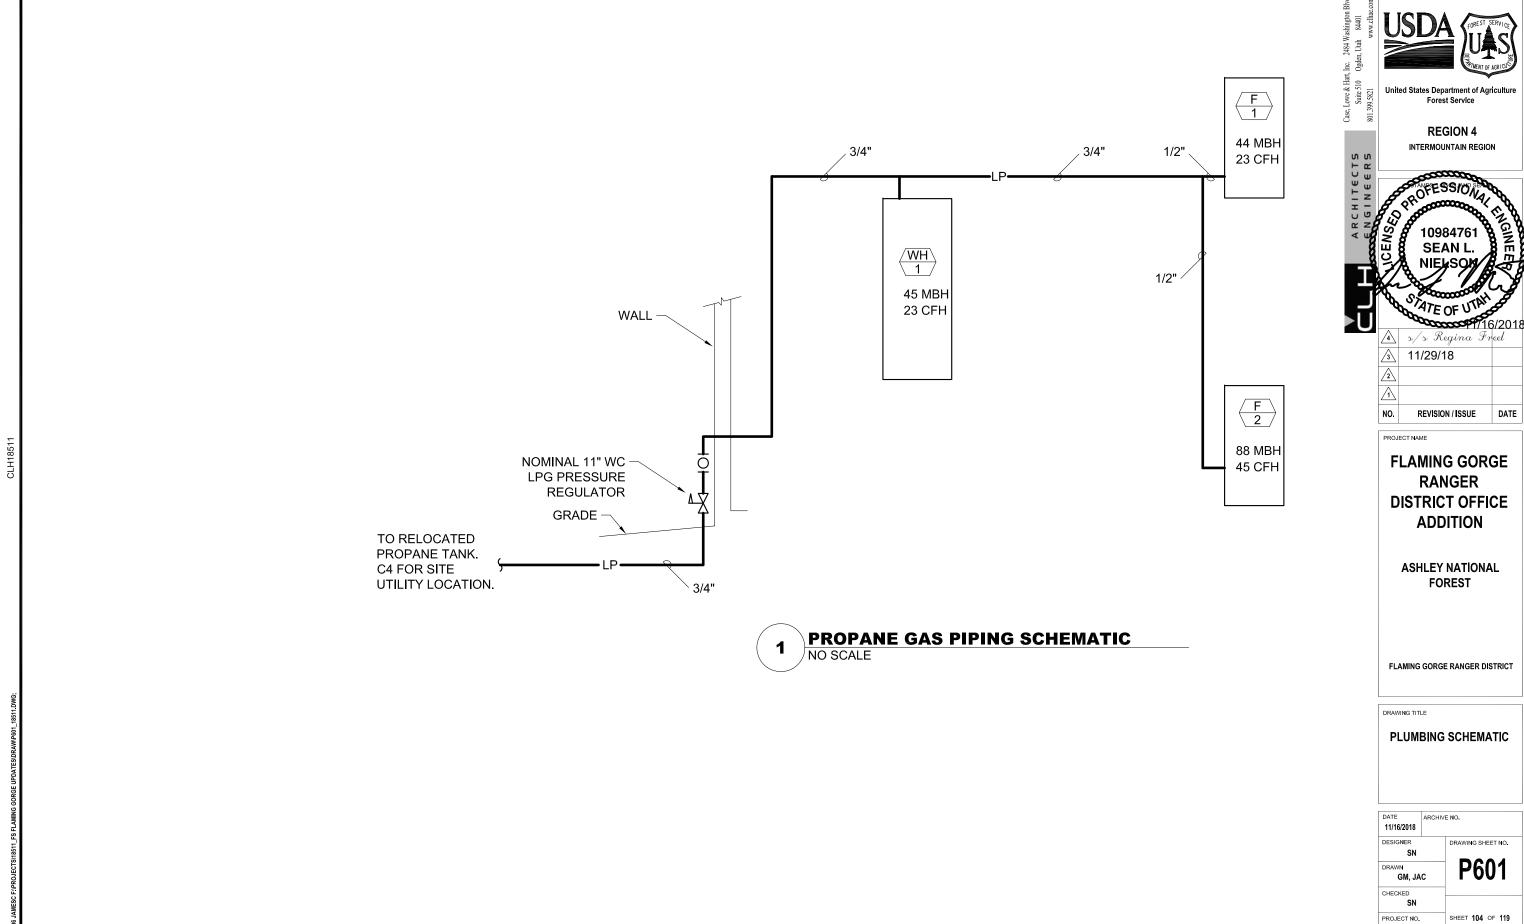
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1 UNDERGROUND PLASTIC SANITARY SEWER DETAIL NO SCALE

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PROJECT NO. 644

FURNACE & AIR CONDITIONER SYSTEM (F-1,2, CC-1,2, CU-1,2)

THE FURNACE SHALL BE PROVIDED WITH ELECTROMECHANICAL CONTROLS FROM THE MANUFACTURER. AND SHALL ENABLE THE FURNACE AND CONDENSING UNIT AS DEMANDED BY THE THERMOSTAT. THE FURNACE CONTROLLER SHALL INTERFACE WITH A CONTRACTOR PROVIDED THERMOSTAT (VENSTAR T4900 OR EQUAL). THE THERMOSTAT SHALL INCLUDE AN OUTDOOR TEMPERATURE SENSOR. FURNACE 1 SHALL BE PROVIDED WITH AN ADDITIONAL TEMPERATURE SENSOR IN THE CONFERENCE ROOM THAT WILL AVERAGE TEMPERATURES OF THE SPACES.

THE THERMOSTAT WILL BE EQUIPPED WITH A LOCAL OVERRIDE SWITCH FOR OCCUPANCY CONTROL.

THE THERMOSTAT WILL DETERMINE THE OCCUPANCY BASED ON A SCHEDULE. THE THERMOSTAT SHALL ADJUST THE DAILY START TIME OF THE UNIT TO BRING EACH SPACE TO DESIRED OCCUPIED TEMPERATURE IMMEDIATELY PRIOR TO SCHEDULED OCCUPANCY (ENABLE VENMAR COMFORT RECOVERY). WHEN OCCUPIED, THE SUPPLY FAN TO RUN CONTINUOUSLY (ENABLE VENSTAR SMART FAN). COOLING OR HEATING SHALL BE ENABLED TO MAINTAIN OCCUPIED TEMPERATURE SETPOINT. STAGING AND FAN SPEED SHALL BE CONTROLLED BY THE FURNACE CONTROLLER. WHEN UNOCCUPIED, THE SUPPLY FAN TO RUN INTERMITTENTLY WHEN COOLING OR HEATING IS ENABLED TO MAINTAIN UNOCCUPIED TEMPERATURE SETPOINT.

ENERGY RECOVERY VENTILATOR (ERV-1)

THE ERV SHALL BE INTERLOCKED WITH A THERMOSTAT TO RUN DURING OCCUPIED PERIODS. THE SUPPLY FAN SPEED SHALL BE CONSTANT AND SET TO 650 CFM VIA POTENTIOMETER ON THE EC MOTOR CONTROLLER DURING THE TEST AND BALANCE.

ECONOMIZER

THE ERV ECONOMIZER "STOP WHEEL" SHALL BE ENABLED UPON A SIGNAL FROM THE THERMOSTAT (AUX OUTPUT: ECONOMIZER, TEMP CONTROL). ECONOMIZING MODE SHALL BE ENABLED WHEN OUTSIDE AIR TEMPERATURE IS LESS THAN 70°F AND THERE IS A CALL FROM COOLING. THE CONTROLS CONTRACTOR WILL ALSO HAVE TO PROVIDE AN INTERLOCK TO ONLY ALLOW ECONOMIZER MODE WHEN COOLING IS ENABLED.


BUILDING PRESSURE CONTROL

THE EXHAUST FAN SPEED SHALL MODULATE TO MAINTAIN TO MAINTAIN BUILDING PRESSURE SETPOINT OF 0.05" WC (ADJ.). A STANDALONE CONTROLLER (HONEYWELL T775U2016) & PRESSURE SENSOR (HONEYWELL P7650A1018) WILL SEND A 0-10V SIGNAL TO THE EXHAUST FAN TO VARY THE FAN SPEED.

MECHANICAL GENERAL NOTES

- 1. ALL EQUIPMENT SHALL BE INSTALLED IN ACCORDANCE WITH THE 2015 EDITION OF THE INTERNATIONAL MECHANICAL CODE AND SMACNA.
- 2. MECHANICAL PLANS ARE DIAGRAMMATIC ONLY.
 CONTRACTOR SHALL COORDINATE THEIR WORK WITH
 OTHER TRADES, AND ACTUAL JOB SITE CONDITIONS.
 CONTRACTOR TO FIELD VERIFY QUANTITIES AND
 DIMENSIONS.
- 3. CONTRACTOR TO PROVIDE ALL NECESSARY MATERIALS, DUCTWORK, HANGERS, FITTINGS, OFFSETS, INSULATION AND ACCESSORIES LOGICALLY REQUIRED FOR A COMPLETE FUNCTIONAL AIR DELIVERY SYSTEM.
- 4. DUCT DIMENSIONS ON DRAWINGS ARE INSIDE DIMENSIONS.
- CONTRACTOR SHALL COORDINATE ALL SUPPLY DIFFUSEF PLACEMENTS.
- 6. ALL SQUARE ELBOWS IN SUPPLY AND RETURN DUCTWORK SHALL HAVE SINGLE THICKNESS TURNING VANES.
- 7. CONNECTIONS TO SUPPLY DIFFUSERS TO BE MADE WITH A RIDGED CONNECTION SO THAT CLEAR AND UNOBSTRUCTED AIRFLOW IS ACHIEVED.
- 8. MOUNT BOTTOM OF THERMOSTAT 48 INCHES ABOVE FINISHED FLOOR.
- 9. CONTRACTOR TO FURNISH FILTERS.
- 10. REMOTE CONCEALED CEILING CABLE REGULATOR REQUIRED FOR ALL MANUAL VOLUME DAMPERS AND HARD LID CEILING APPLICATIONS.
- 11. ALL EXPOSED DUCTWORK TO HAVE ALL LABELS AND MARKINGS REMOVED PRIOR TO INSTALLATION.

| LE | EGEND |
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| SYMBOL | DESCRIPTION |
| CD | CONDENSATE DRAIN |
| | DIRECTION OF FLOW |
| | BALL VALVE |
| | PIPING UP |
| | PIPING TEE DOWN |
| | UNION OR FLANGE |
| © | ROOF DRAIN |
| • | POINT OF CONNECTION |
| | POINT OF DISCONNECTION |
| OR 🔀 | EXHAUST AIR DUCT - UP / DOWN |
| OR 🖊 | RETURN AIR DUCT - UP / DOWN |
| OR 🔀 | SUPPLY AIR DUCT - UP / DOWN |
| | MITERED ELBOW W/ TURNING VANES |
| T | THERMOSTAT |
| | EQUIPMENT SYMBOL |
| DET | DETAIL SYMBOL |
| > | AIRFLOW DIRECTION |
| (E) | EXISTING |
| L/S | LIQUID /SUCTION REFRIGERANT LINES |
| L/S | LIQUID /SUCTION REFRIGERANT LINES |

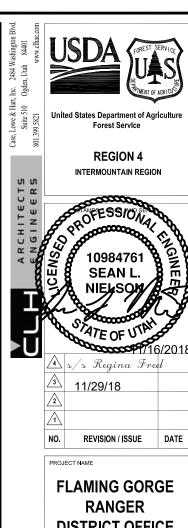

RANGER
DISTRICT OFFICE
ADDITION

ASHLEY NATIONAL FOREST

FLAMING GORGE RANGER DISTRICT

DRAWING TITLE

MECHANICAL LEGEND, NOTES, AND SEQUENCE OF OPERATIONS

| 11/16/2018 | ARCHIV | E NO. |
|-----------------|--------|--------------------------------|
| DESIGNER | | DRAWING SHEET NO. |
| SN | | B # 6 6 4 |
| DRAWN GM, JA | .c | M001 |
| CHECKED SN | | |
| PROJECT NO. 644 | | SHEET 105 OF 119 |

| | | | | | /ARIA | BLE S | PEED | GAS | FURI | NACI | E SCH | IEDULE | | |
|-------------------|---------------------------|---|-------------------|------------|-------|--|----------------------------|-------------------------------|------|------|---------------------------|--------------------------|-----------------|--|
| MARK | MANUFACTURER & MODEL # | DESCRIPTION | AREA SERVED | MAX CFM | | EXT. STATIC PRESS. (in. w.c.) | GAS TYPE 11" w.c. | HTG. CAP INPUT (MBH) | AFUE | | TRICAL VOLTS/ PHASE | DIMENSIONS HxWxD (IN) | WEIGHT (lbs) | REMARKS |
| \longrightarrow | LENNOX EL296UH045XV36B | CONDENSING GAS FURNACE TWO STAGE HEAT | SOUTHWEST | 1200 | 300 | 0.40 | LP | 44 | 96.0 | 15 | 120 / 1 | 33 x 18 x 28 | | UP-FLOW UNIT, PROVIDE HIGH ALTITUDE PRESSURE SWITCH KITS, PROVIDE FILTER BOX, CONCENTRIC VENT KIT. |
| F 2 | LENNOX EL296UH090XV60C | CONDENSING GAS FURNACE TWO STAGE HEAT | NORTHWEST | 1800 | 300 | 0.40 | LP | 88 | 96.0 | 20 | 120 / 1 | 33 x 21 x 28 | | UP-FLOW UNIT, PROVIDE HIGH ALTITUDE PRESSURE SWITCH KITS, PROVIDE FILTER BOX, CONCENTRIC VENT KIT. |
| ALL F | PERFORMANCE BASED C | N SITE ELEVATION (| OF 6360 FT. ABOVE | SEA LEVE | EL. | | - | | - | | | | | |

| | | | | AIR (| COOLED | COND | ENSIN | G UNI | T SC | HEDU | LE | |
|---|---------------------------|--------------------|---|---------|---------|-----------------|-------|-------|---------|-----------------|--------|---|
| MARK | MANUFACTURER | DESCRIPTION | SYSTEM | REFRIG. | NOMINAL | SOUND | 0000 | ELE | ECTRIC. | | WEIGHT | REMARKS |
| IVIARK | & MODEL# | DESCRIPTION | SERVED | TYPE | TONNAGE | RATING (dBa) | SEER | МОСР | N/H · Δ | VOLTS/ PHASE | (lbs) | REWARRS |
| CU 1 | LENNOX EL16XC1-030-230 | CONDENSING UNIT | $\left\langle \begin{array}{c} CC \\ 1 \end{array} \right\rangle$ | R-410A | 2.5 | 71 | 15.5 | 25 | 17 | 230 / 1 | 187 | PROVIDE LINE SETS 3/8" L 5/8" S, TXV, FILTER/ DRIER & SIGHT GLASS, CRANK CASE HEATER, LOW AMBIENT KIT, COMPRESSOR HARD START KIT |
| $\begin{pmatrix} CU \\ 2 \end{pmatrix}$ | LENNOX EL16XC1-047-230 | CONDENSING UNIT | $\left\langle \begin{array}{c} CC \\ 2 \end{array} \right\rangle$ | R-410A | 4 | 72 | 15.1 | 35 | 21.9 | 230 / 1 | 284 | PROVIDE LINE SETS 3/8" L 5/8" S, TXV, FILTER/ DRIER & SIGHT GLASS, CRANK CASE HEATER, LOW AMBIENT KIT, COMPRESSOR HARD START KIT |

| | COOLING COIL SCHEDULE | | | | | | | | | |
|---------|--------------------------|--|------|------------|-----------------|--------------------------|-----------------|--|--|--|
| MARK | MANUFACTURER & MODEL# | SYSTEM SERVED | CFM | NOM MBH | REFRIG. TYPE | DIMENSIONS HxWxD (in) | WEIGHT (lbs) | REMARKS | | |
| CC 1 | LENNOX CX35-36B-F | (F) | 1200 | 3 | R-410A | 25 x 18 x 21 | <u> </u> | FOR UP-FLOW UNIT, 3/4" CONDENSATE CONNECTIONS | | |
| CC 2 | LENNOX CX35-60C-F | $\left\langle \begin{array}{c} F \\ 2 \end{array} \right\rangle$ | 1800 | 4 | R-410A | 26 x 22 x 21 | h() | FOR UP-FLOW UNIT, 3/4" CONDENSATE CONNECTIONS | | |

| | ENERGY RECOVERY VENTILATOR UNIT SCHEDULE | | | | | | | | | | | | |
|----------|--|-------------|-------|-------|------------------|-----|------------------|------|--------|-----------------|--------------|--------|--|
| MARK | MANUFACTURER | AREA | TYPE | OA/SI | JPPLY | | URN/ AUST | Е | LECTRI | CAL | DIMENSIONS | WEIGHT | DEMARKS |
| IVIARK | & MODEL | SERVED | 1166 | CFM | STATIC PRESS. | | STATIC PRESS. | MCA | MOP | VOLTS/ PHASE | HxWxD (IN) | (LBS) | REMARKS |
| ERV 1 | GREENHECK ERV-10-20L-VG | OUTSIDE AIR | WHEEL | 650 | 0.25 | 600 | 0.25 | 21.9 | 25 | 208 / 1 | 29 x 47 x 34 | 308 | ELECTRIC PREHEATER FOR FROST CONTROL, CLASS 1A DAMPERS, 2" MERV 8 FILTERS, STOP WHEEL ECONOMISER CONTROL, HINGED ACCESS, EC MOTORS. |



FLAMING GORGE RANGER DISTRICT OFFICE

ADDITION

REVISION / ISSUE DATE

NO.

PROJECT NAME

ASHLEY NATIONAL

FOREST

FLAMING GORGE RANGER DISTRICT

DRAWING TITLE

MECHANICAL SCHEDULES

| 11/16/2018 | ARCHIV | ARCHIVE NO. | | | | | | |
|------------------|--------|-------------------|--|--|--|--|--|--|
| DESIGNER | | DRAWING SHEET NO. | | | | | | |
| SN | | | | | | | | |
| DRAWN GM, JAC | | M002 | | | | | | |
| CHECKED SN | | | | | | | | |
| PROJECT NO. 644 | | SHEET 106 OF 119 | | | | | | |
| | | | | | | | | |

| DUCT SEALING & INSULATION R-VALUE SCHEDULE | | | | | | | | |
|--|--------------------------------|--------|-------------------|------------|--|--|--|--|
| | | SMACNA | | | | | | |
| DUCT TYPE | DUCT TYPE EXTERIOR UNCONDITION | | CONDITIONED SPACE | SEAL CLASS | | | | |
| SUPPLY | R-12 | R-6 | NONE | А | | | | |
| RETURN | R-12 | R-6 | NONE | А | | | | |
| EXHAUST | NONE | NONE | NONE | А | | | | |


NOTES:

NOMINAL R-VALUES ARE FOR THE INSULATION AS INSTALLED AND DO NOT INCLUDE AIR FILM RESISTANCE.

PRESSURE SENSITIVE TAPE SHALL NOT BE USED AS THE PRIMARY SEALANT, UNLESS IT HAS BEEN CERTIFIED TO COMPLY WITH UL-181A OR UL-181B BY AN INDEPENDENT TESTING LAB AND THE TAPE IS USED IN ACCORDANCE WITH THAT CERTIFICATION.

SMACNA SEAL CLASS A: SEAL TRANSVERSE JOINTS, LONGITUDINAL SEAMS, & DUCT WALL PENETRATIONS.

| | | F | REGISTE | R, GRIL | LE & DII | FUSER S | CHE | ULE | | | | |
|------|-------------------------|-------------------------------|----------|----------|------------------|------------------|------------|-------------|---------------------|--------------|----------------|--|
| MARK | MANUFACTURER & MODEL | DESCRIPTION | MATERIAL | FINISH | FRAME | DAMPER | MAX. NC | MAX. CFM | MAX APD ("WC) | NECK SIZE | MODULE SIZE | REMARKS |
| S-1 | TITUS ML38 | LINEAR SLOT DIFFUSER | ALUMINUM | WHITE | DUCT MOUNT | | 20 | 185 | 0.05 | | 2'-0" | 2 SLOTS, 3/4" WIDTH, PROVIDE WITH EQUALIZING GRID |
| S-2 | TITUS TMR | ROUND DIFFUSER | STEEL | ALUMINUM | DUCT MOUNT | | 17 | 150 | 0.11 | 6"Ø | | 2 SLOTS, 3/4" WIDTH, PROVIDE WITH EQUALIZING GRID |
| S-3 | TITUS ML37 | LINEAR SLOT DIFFUSER | ALUMINUM | WHITE | SURFACE MOUNT | - | 22 | 125 | 0.03 | 8" OVAL | 2'-0" | 2 SLOTS, 1/2" WIDTH, PROVIDE WITH LOW PROFILE MPI-37 INSULATED PLENUM ADAPTER |
| S-4 | TITUS ML38 | LINEAR SLOT DIFFUSER | ALUMINUM | ALUMINUM | DUCT MOUNT | | 24 | 300 | 0.06 | | 3'-0" | 2 SLOTS, 3/4" WIDTH, PROVIDE WITH ALUMINUM STRAIGHTENING GRID |
| R-1 | TITUS 45F | SIGHTPROOF EGGCRATE GRILLE | ALUMINUM | WHITE | SURFACE MOUNT | | <15 | 100 | 0.01 | 10"x10" | | 2 SLOTS, 3/4" WIDTH, PROVIDE WITH ALUMINUM STRAIGHTENING GRID |
| E-1 | TITUS 45F | SIGHTPROOF EGGCRATE GRILLE | ALUMINUM | WHITE | SURFACE MOUNT | OPPOSED BLADE | 21 | 250 | 0.05 | 10"x10" | | |
| E-2 | TITUS RX301F | SINGLE DEFLECTION GRILLE | ALUMINUM | WHITE | SURFACE MOUNT | BUTTERFLY | <15 | 50 | 0.01 | 6"Ø | | |
| T-1 | TITUS 350RL | FIXED BLADE GRILLE | STEEL | WHITE | SURFACE MOUNT | | <15 | 370 | 0.02 | 14"x14" | | 35° BLADE DEFLECTION, 3/4" BLADE SPACING |
| T-2 | TITUS 45F | SIGHTPROOF EGGCRATE GRILLE | ALUMINUM | WHITE | SURFACE MOUNT | | 21 | 250 | 0.05 | 10"x10" | | PROVIDE WITH RUSKIN GSV 10"x10" |
| T-3 | TITUS 350RL | FIXED BLADE GRILLE | STEEL | WHITE | SURFACE MOUNT | | <15 | 1630 | 0.04 | 36"x18" | | 35° BLADE DEFLECTION, 3/4" BLADE SPACING |
| T-4 | TITUS 350RL | FIXED BLADE GRILLE | STEEL | WHITE | SURFACE MOUNT | | <15 | 125 | 0.01 | 6"x14" | | 35° BLADE DEFLECTION, 3/4" BLADE SPACING |
| | - | <u> </u> | | | | — TAG | | | | | | |

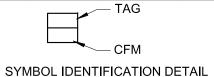

Case, Lowe & Hart, Inc. 2484 Washington Blvd.

Sinte 510 Ogden, Utah 84401

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United States Department of Agriculture Forest Service

REGION 4

INTERMOUNTAIN REGION

10984761

SEAN L.

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FLAMING GORGE RANGER DISTRICT OFFICE ADDITION

ASHLEY NATIONAL FOREST

FLAMING GORGE RANGER DISTRICT

DRAWING TITLE

MECHANICAL SCHEDULES

| 11/16/2018 | ARCHIV | E NO. | | | | | |
|--------------------|--------|-------------------|--|--|--|--|--|
| DESIGNER SN | | DRAWING SHEET NO. | | | | | |
| DRAWN GM, JA | c | M003 | | | | | |
| CHECKED SN | | | | | | | |
| PROJECT NO. 644 | | SHEET 107 OF 119 | | | | | |

| | LOUVER SCHEDULE | | | | | | | | | |
|------|-------------------------|------------------|-----|---------------------------|----------------------|------------------------|--------------------------|----------|-----------|--|
| MARK | MANUFACTURER & MODEL | SYSTEM SERVED | CFM | FACE VELOCITY (FPM) | FREE AREA (SF) | PRESSURE DROP ("WC) | DIMENSIONS WxHxD (IN) | MATERIAL | FINISH | NOTES |
| | GREENHECK EVH-501 | ERV-1 INTAKE | 650 | 681 | 1.0 | 0.08 | 14x26x5 | ALUMINUM | 50% KYNAR | PROVIDE INSECT SCREEN, MATCH COLOR TO BUILDING EXTERIOR. |

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Sinc. 510 Ogden, Utah & 4401

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<u>3</u> 11/<u>29/18</u>

FLAMING GORGE RANGER DISTRICT OFFICE ADDITION

REVISION / ISSUE DATE


ASHLEY NATIONAL FOREST


FLAMING GORGE RANGER DISTRICT

DRAWING TITLE


MECHANICAL SCHEDULES


| 11/16/2018 | ARCHIV | E NO. | | |
|-----------------|--------|-------------------|--|--|
| DESIGNER SN | | DRAWING SHEET NO. | | |
| DRAWN GM, JA | .c | M004 | | |
| CHECKED SN | | | | |
| PROJECT NO. 644 | | SHEET 104 OF 119 | | |

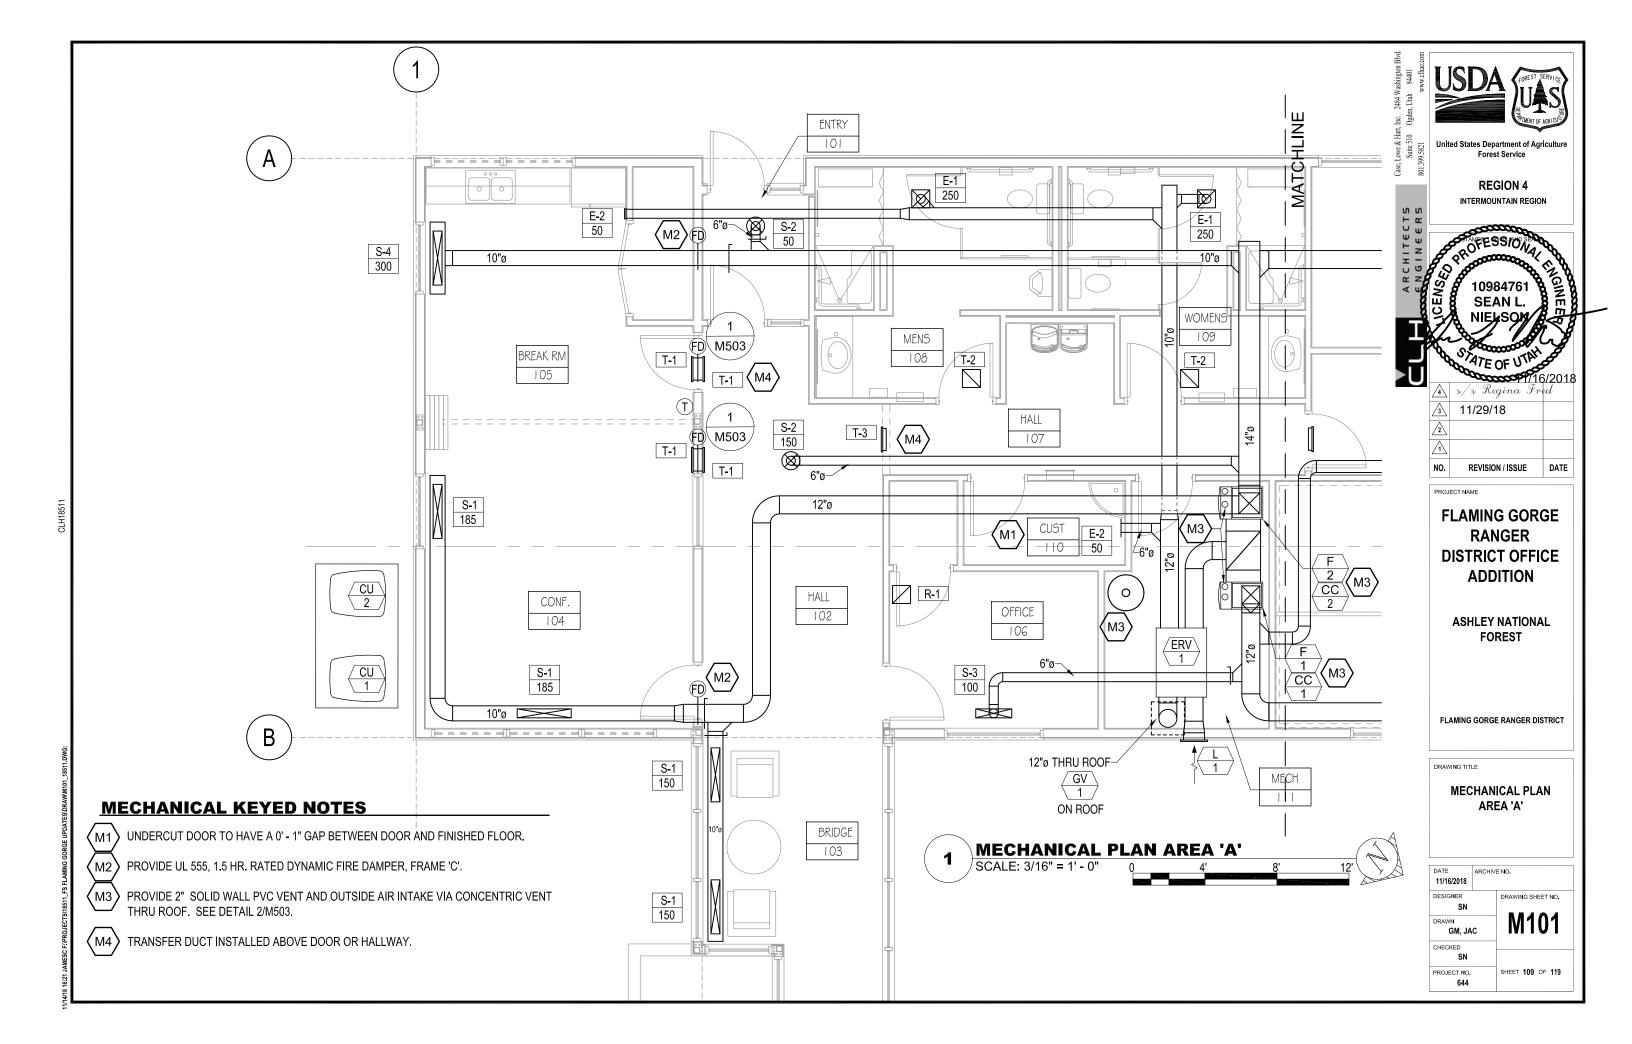

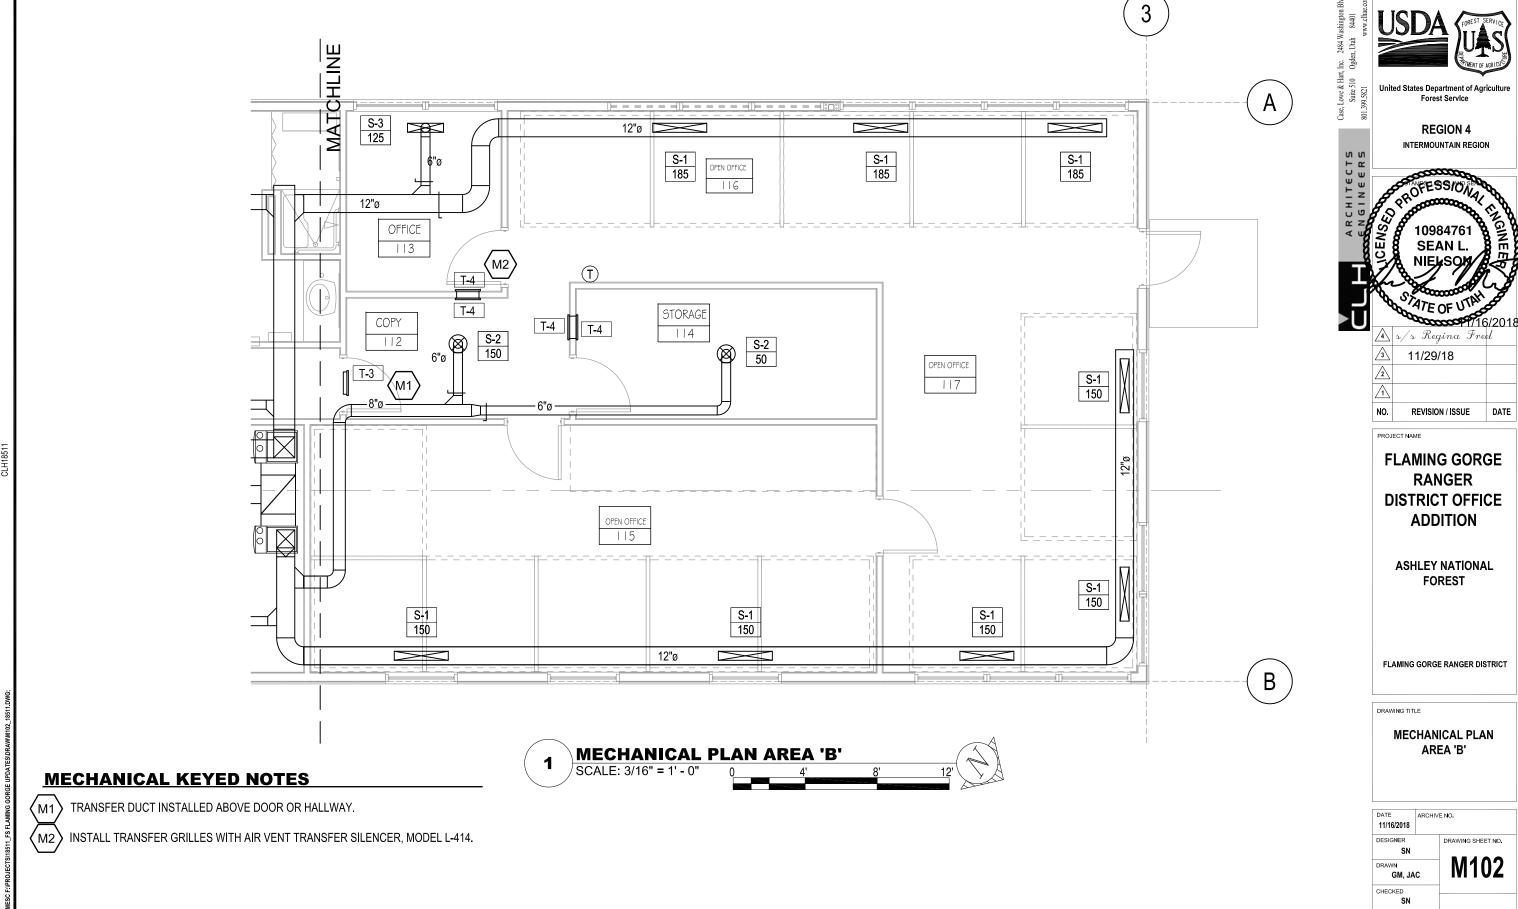

SHEET 110 OF 119 PROJECT NO.

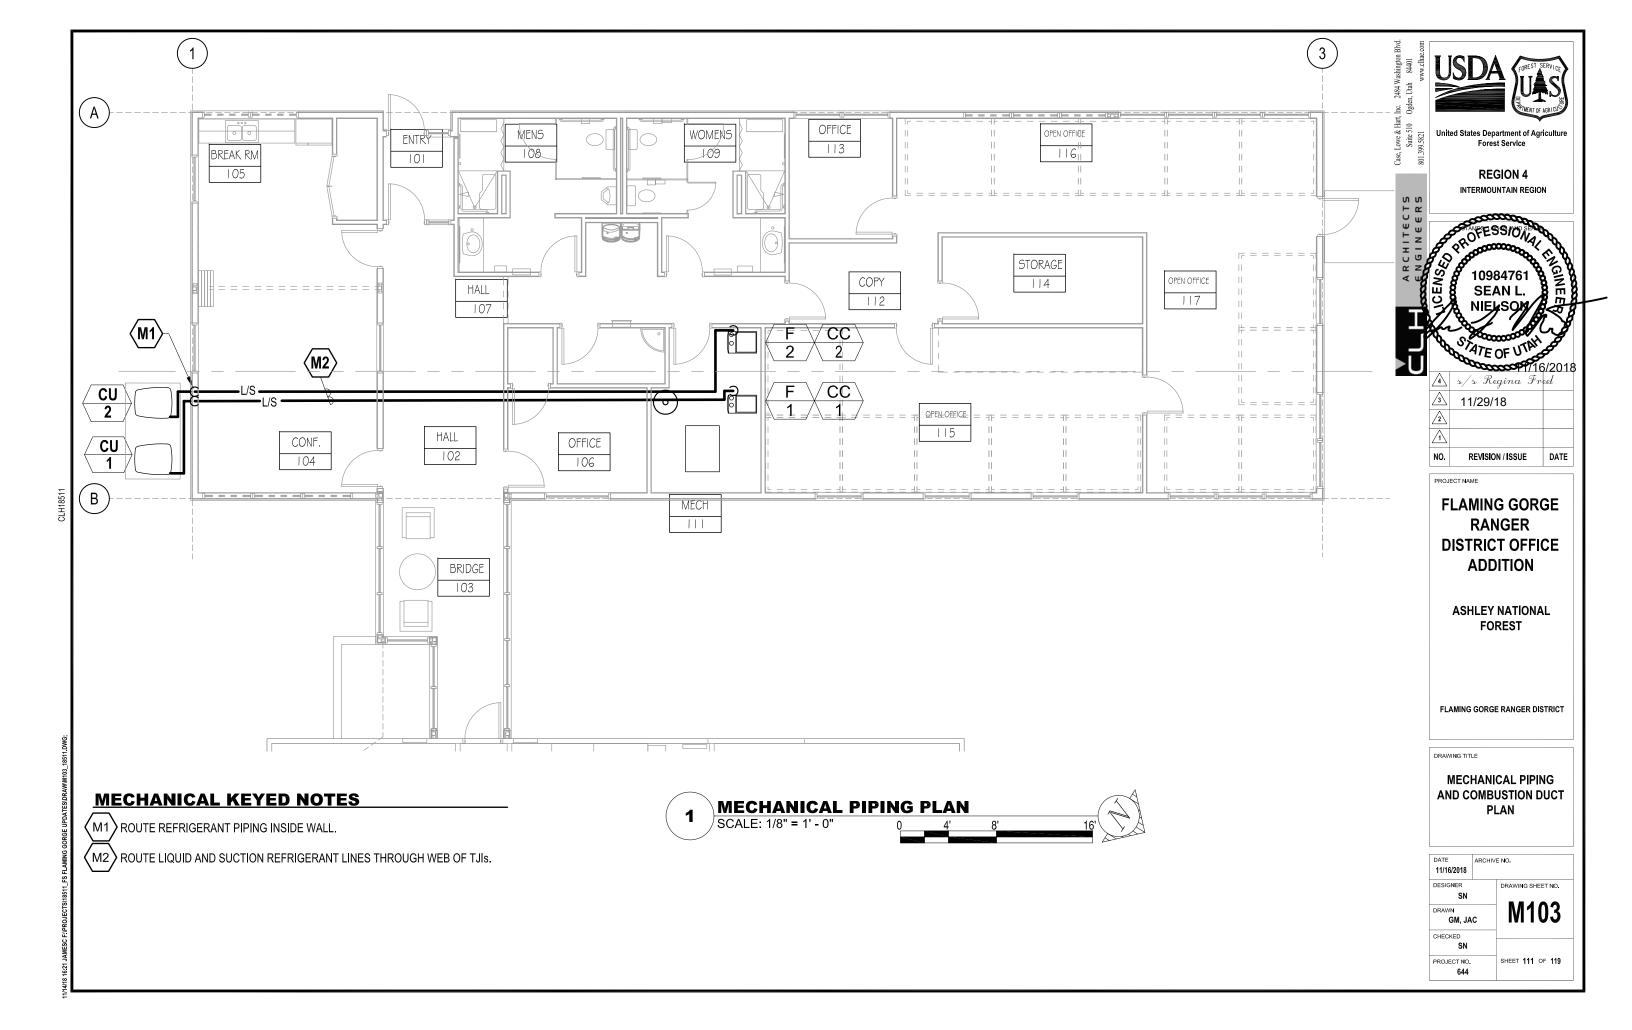

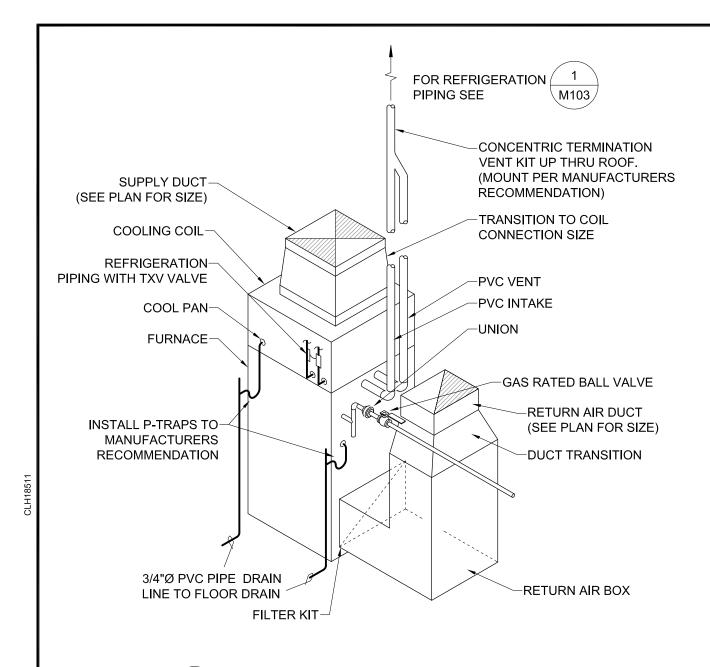

DIRECTION OF AIRFLOW
TOWARDS WINDOWS

DIRECTION OF
AIRFLOW INTO ROOM

NOTE:
INSTALLING CONTRACTOR TO ADJUST AIRFLOW AS SHOWN BEFORE

FURNACE INSTALLATION DETAIL
SCALE: NONE

DUCT MOUNTED DIFFUSER DETAIL
SCALE: NONE

BALANCING.

United States Department of Agriculture Forest Service

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111/29/18

FLAMING GORGE RANGER DISTRICT OFFICE ADDITION

REVISION / ISSUE DATE

ASHLEY NATIONAL FOREST

FLAMING GORGE RANGER DISTRICT

DRAWING TITLE

NO.

PROJECT NAME

MECHANICAL DETAILS

DATE 11/16/2018 ARCHIVE NO.

DESIGNER SN

DRAWN GM, JAC


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PROJECT NO. 644

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DRAWING SHEET NO.

SHEET 112 OF 119




1. HANGER RODS TO BE 3/8"ø MIN FOR 18"ø AND SMALLER DUCT. HANGER RODS TO BE 1/2"ø MIN FOR LARGER THAN 18"ø DUCT. HANGER STRAPS TO BE 18 GA, 1" MIN. WIDTH, COMPLETELY WRAP AROUND DUCT. SIZES PER SMACNA HVAC DUCT CONSTRUCTION STANDARDS.

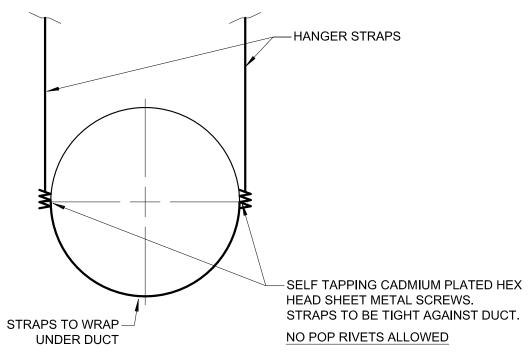2. SEE STRUCTURAL NOTES FOR DEFERRED SUBMITTAL FOR SEISMIC BRACING.

ROUND DUCT HANGER

HANGER SIZES FOR RECTANGULAR DUCT HORIZONTAL **HORIZONTAL** MAX. MAX. SUPPORT ANGLE | SPACING SIDE SUPPORT ANGLE 30" NONE REQUIRED 10'-0" 1" WIDE 18 GA. STRAP 1 1/2" x 1 1/2" x 1/8" 8'-0" 36" 1/4" ROUND ROD 8'-0" 48" 1/4" ROUND ROD 2" x 2" x 1/8" 5/16" ROUND ROD 8'-0" 60" 2" x 2" x 1/8" 8'-0" 84" 3/8" ROUND ROD 2" x 2" x 1/8"

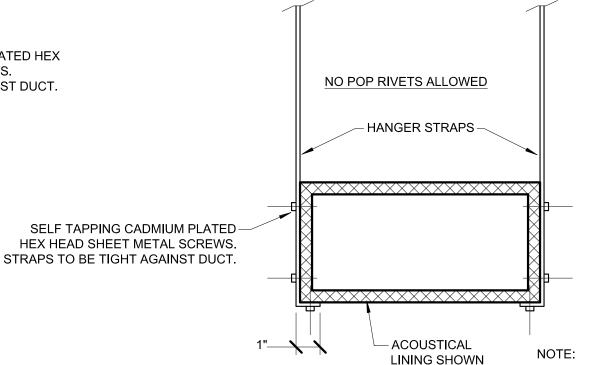

SEE STRUCTURAL NOTES FOR DEFERRED SUBMITTAL FOR SEISMIC BRACING.

DUCT STRAP HANGER DETAIL

United States Department of Agriculture Forest Service **REGION 4** INTERMOUNTAIN REGION SEAN L. 🔼 s/s Regina Freel <u>3</u> 11/29/18 NO. REVISION / ISSUE DATE PROJECT NAME **FLAMING GORGE RANGER**

> **ASHLEY NATIONAL FOREST**

DISTRICT OFFICE


ADDITION

FLAMING GORGE RANGER DISTRICT

DRAWING TITLE

MECHANICAL DETAILS

| 11/16/2018 | ARCHIVE NO. |
|-----------------|-------------------|
| DESIGNER SN | DRAWING SHEET NO. |
| DRAWN GM, JA | .c M502 |
| CHECKED SN | |
| PROJECT NO. | SHEET 113 OF 119 |

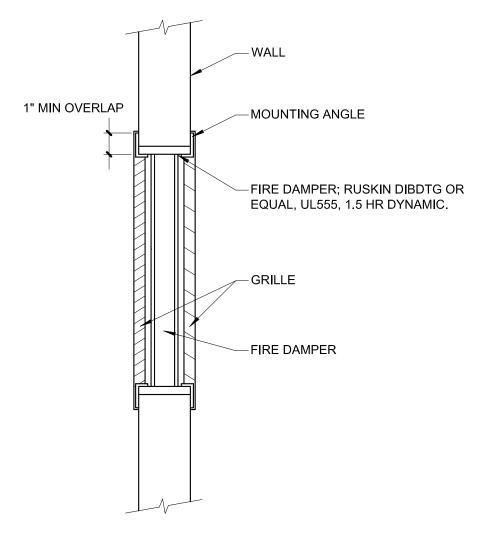

FIRE RATED TRANSFER GRILL DETAIL
NO SCALE

1 INLINE ERV DETAIL
NO SCALE

ARCHITECTS
Suite 510 Oggen, Unit of States Department of Agriculture
Suite 510 Oggen, Unit of Agriculture
Suite 510 Oggen, Unit of Agriculture
Forest Service

REGION 4
INTERMOUNTAIN REGION

10984761
SEAN L.

FLAMING GORGE RANGER DISTRICT OFFICE ADDITION

PROJECT NAME

ASHLEY NATIONAL FOREST

FLAMING GORGE RANGER DISTRICT

DRAWING TITLE

MECHANICAL DETAILS

DATE 11/16/2018 ARCHIVE NO.

DESIGNER SN

DRAWN GM, JAC

CHECKED SN

PROJECT NO. 644

ARCHIVE NO.

DRAWING SHEET NO.

DRAWING SHEET NO.

SHEET 114 OF 119

3 17:11 JAMESC F.IPROJECTS(18511_FS FLAMING GORGE UPDATES)DRAW(100% IFC 20181114)DWG WITHOUT STAMP(MSU3_185)

MESC ENBROTECTS 18611 ES EL AMING GOBGE LIBBATES DE AMAGOS.

RECEPTACLE, GFCI


RECEPTACLE, GFCI WITH WEATHERPROOF COVER RECEPTACLE, QUAD OR TWO DUPLEX RECEPTACLE, SPECIAL. CONNECTION POINT FOR SYSTEMS FURNITURE RECEPTACLE IN FLOOR BOX OF TYPE INDICATED DATA OUTLET, 2-PORT UNLESS NOTED WITH A NUMBER WHICH INDICATES DIFFERING NUMBER OF DATA OUTLET, FLOOR MOUNTED ▽ CIRCUIT TAG: "X" INDICATES PANEL, AND "#" IS THE X-# CIRCUIT NUMBER BRANCH CIRCUIT: o - INDICATES GROUND, LONG LINE 0|1 - "NEUTRAL" OR "GROUNDED CONDUCTOR" AND THE

SHORT LINE - "HOT" OR "LINE" CONDUCTORS

INDICATES UNUSUAL MOUNTING HEIGHT

GENERAL NOTES

- FAMILIARIZATION WITH BUILDING FINISHES AND CONSTRUCTION IS
- ELECTRICAL INSTALLATION WILL REQUIRE COORDINATION IN ALL STAGES OF BUILDING, INCLUDING:
- UNDER SLAB FEEDS.
- WALL EMBEDDED CIRCUITS AND COMMUNICATIONS.
- CEILING EMBEDDED CIRCUITS.
- A CONCRETE ENCASED ELECTRODE SHALL BE INSTALLED IN NEW ADDITIONS FOOTINGS AND BONDED TO EQUIPMENT GROUND IN PANEL D. NO NEUTRAL BOND ALLOWED AT THIS LOCATION.

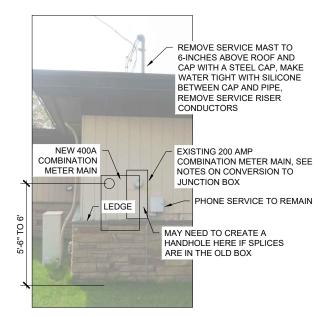

EXISTING ELECTRICAL SERVICE

SERVICE REPLACEMENT NOTES

- THE EXISTING SERVICE IS A 200 AMP COMBINATION METER MAIN. COORDINATE WITH BRIDGER VALLEY ELECTRICAL ASSOCIATION (VAL CROOK 307-786-2800) FOR CHANGES. THE CONTRACTOR SHALL BE RESPONSIBLE FOR ALL CONNECTION RELATED FEES. EXISTING, RENTED YARD LIGHT AND POLE ON NORTH SIDE OF YARD WILL BE REMOVED BY THE POWER COMPANY, SEE SHEET E2.
- NEW SERVICE SHALL BE 400 AMP BURIED LATERAL FROM A NEW POLE SET BY BRIDGER VALLEY WITH BRIDGER VALLEY BRINGING THE SERVICE WITH CONDUIT INTO THE NEW COMBINATION METER
- CONVERT EXISTING SERVICE EQUIPMENT INTO A JUNCTION BOX BY GUTTTING AND REMOVING DEAD FRONT, PROVIDING A PERMANENT BLANK FOR THE METER LOCATION. INSTALL PERMANENT EQUIPMENT GROUNDING BOND TO THE BOX. NIPPLE EXISTING CIRCUITS INTO NEW PANEL THROUGH DOOR OF OLD PANEL
- 3.1. IF EXISTING CIRCUITS ARE ALL LONG ENOUGH TO EXTEND INTO THE NEW PANEL WITHOUT SPLICES UNTIL WELL WITHIN THE NEW PANEL, NO ACCESS IS REQUIRED INTO THE OLD PANEL.
- IF EXISTING CIRCUITS NEED SPLICING BEFORE THE NEW PANEL, MANUFACTURE, GASKETED, FLAT, SCREW ATTACHED, STEEL ACCESS PLATE INTO THE OLD DOOR. THIS ACCESS PLATE SHALL PROVIDE 4-INCHES WIDE BY 12-INCHES TALL INTO THE DOOR OF THE PANEL WITH THE ACCESS HOLE BEING FREE FROM METAL BURRS LOCATE WITHIN 1-INCH FROM THE RIGHT EDGE OF THE DOOR. MOUNT THE NEW SERVICE PARTIALLY IN FRONT OF THE OLD PANEL AS SHOWN.
- 3.3. NO SPLICES ARE ALLOWED IN CONDUIT.
- 4. PROVIDE AND INSTALL NEW COMBINATION METER MAIN WITH UNISTRUT MOUNTING PROVIDED TO PLACE PANEL BEYOND LEDGE FOR A STRAIGHT CONDUIT INTO THE BOTTOM OF THE PANEL. 4.1. UNISTRUT SHALL NOT EXTEND BEYOND PANEL EDGES
- 5. PAINT NEW SERVICE, MOUNTING AND ANY NEW ACCESS PLATE TO
- MATCH THE BUILDINGS EXTERIOR SIDING.
- 6. INSTALL EXISTING CIRCUITS AND NEW FEEDER AS CALLED FOR



INTERMOUNTAIN REGION

STAMPS, LOGOS, AND SEALS s/s Regina Freel <u>/</u>4\11/29/18 REVISION / ISSUE DATE NO.

PROJECT NAME


FLAMING GORGE RANGER DISTRICT OFFICE ADDITION

ASHLEY NATIONAL FOREST

FLAMING GORGE RANGER DISTRICT

RAWING TITLE


ELECTRICAL LEGEND AND SERVICE REPLACEMENT

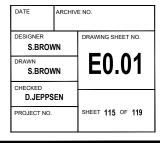

| | PAN | EL A | (SE | RVIC | ;E) \$ | SCHED | ULE | | |
|----------------------------------|---|---|--|---|---|---|---|--|--|
| | | | | | | L PROVIDED | BY | GROUNDING: NEW #2 CU GRD TO WATER PIPES, AND EXISTING GROUND ROD AND NEW SUPPLEMENTAL GROUNDING. | #6 ND |
| LOAD DESCRIPTION | BREAKER AWG LOAD (WATTS) A B | AWG | AWG LOAD (| | AWG | BREAKER | WATTS | LOAD DESCRIPTION | CKT |
| | | | | | | | | | |
| MAIN POWER FOR BUILDING, PANEL B | CH2100 | FX | | | | CH260 | | COMPUTER ROOM, PANEL C | 2 |
| | 0.12.00 | | | | | | | · · | 4 |
| COMPLITER ROOM AIR CONDITIONER | CH230 | FV | | | EX | CH120 | | COMPUTER ROOM INDOOR AC UNIT (MAYBE UNUSED?) | 6 |
| COMPONENT NOOM ANY CONDITIONER | | L^ | | | EX | CH120 | | COPIER IN THE SOUTH OFFICE | 8 |
| ? MAY BE UNUSED | CH120 | EX | | | EX | CH120 | | PLUGMOLD IN THE COPIER ROOM | 10 |
| SPRINKLER | CH120 | EX | | | | | | | 12 |
| | | | | | | | | | 14 |
| | | | | | | | | | 16 |
| | | | | | | | | | 18 |
| | | | | | | | | | 20 |
| | | | | | | | | | 22 |
| | | | | | | | | | 24 |
| | MILBANK [M400-UG-APS-LC WITH CUTLER-HAMMER H CIRCUIT BREAKERS] LOAD DESCRIPTION MAIN POWER FOR BUILDING, PANEL B COMPUTER ROOM AIR CONDITIONER ? MAY BE UNUSED SPRINKLER | MILBANK [M400-UG-APS-LC WITH CUTLER-HAMMER H CIRCUIT BREAKERS] LOAD DESCRIPTION BREAKER MAIN POWER FOR BUILDING, PANEL B COMPUTER ROOM AIR CONDITIONER CH230 MAY BE UNUSED CH120 | MILBANK [M400-UG-APS-LC WITH CUTLER-HAMMER H CIRCUIT BREAKERS] LOAD DESCRIPTION MAIN POWER FOR BUILDING, PANEL B COMPUTER ROOM AIR CONDITIONER CH230 EX MAY BE UNUSED CH120 EX CH2100 EX | MILBANK [M400-UG-APS-LC WITH CUTLER-HAMMER FEEDER: NEW BRIDGER VALLE LOAD DESCRIPTION BREAKER AWG LOAD (A A MAIN POWER FOR BUILDING, PANEL B CH2100 EX COMPUTER ROOM AIR CONDITIONER CH230 EX ? MAY BE UNUSED CH120 EX | MILBANK [M400-UG-APS-LC WITH CUTLER-HAMMER FEEDER: NEW SERVICE BRIDGER VALLEY ELECT LOAD DESCRIPTION BREAKER AWG A B MAIN POWER FOR BUILDING, PANEL B CH2100 EX COMPUTER ROOM AIR CONDITIONER CH230 EX ? MAY BE UNUSED CH120 EX | MILBANK [M400-UG-APS-LC WTH CUTLER-HAMMER FEEDER: NEW SERVICE LATERA BRIDGER VALLEY ELECTRIC LOAD DESCRIPTION BREAKER AWG A B EX EX COMPUTER ROOM AIR CONDITIONER CH230 EX EX EX ? MAY BE UNUSED CH120 EX EX EX EX EX EX EX E | MILBANK [M400-UG-APS-LC WTH CUTLER-HAMMER FEEDER: NEW SERVICE LATERAL PROVIDED BRIDGER VALLEY ELECTRIC LOAD DESCRIPTION BREAKER AWG LOAD (WATTS) AWG BREAKER MAIN POWER FOR BUILDING, PANEL B CH2100 EX EX CH260 COMPUTER ROOM AIR CONDITIONER CH230 EX EX CH120 ? MAY BE UNUSED CH120 EX EX CH120 EX CH120 CH120 | BRIDGER VALLEY ELECTRIC | MILBANK [M400-UG-APS-LC WITH CUTLER-HAMMER H CIRCUIT BREAKERS] FEEDER: NEW SERVICE LATERAL PROVIDED BY BRIDGER VALLEY ELECTRIC GROUNDING: NEW #2 CU GRD TO WATER PIPES, AND EXISTING GROUND ROD AND NEW SUPPLEMENTAL GRO |

"EX" - MEANS THE CIRCUIT AND WIRING EXISTS AND SHALL BE REWORKED INTO NEW SERVICE.

| | | | P | ANE | L D | SCHI | EDU | LE | | | |
|-------|---|---|---------|-------|----------|----------|--------|---------|-------|--|---------------|
| TYPE: | SQUARE D [Q014252L200G WITH Q0C42US] | 120/240 1 PHASE A.I.C.: 10 SURFACE | 0,000 | FEEDE | R: SZ 2. | .5C, 3#3 | /0&1#2 | GND | | GROUNDING: #2 CU GRD TO CONCRETE ENCASED E SPECIFICATIONS | LECTRODE, SEE |
| СКТ | LOAD DESCRIPTION | | BREAKER | AWG | | | AWG | BREAKER | WATTS | LOAD DESCRIPTION | СКТ |
| 1 | RECEPTACLES-HALL/MECHANICAL/JANITOR/EXTERIOR | 1260 | Q0120 | 12 | 4160 | В | | | 2900 | | 2 |
| 3 | RECEPTACLES-OPEN OFFICES GENERAL USE/STORAGE | 1440 | Q0120 | 12 | | 4340 | - 8 | Q0250 | 2900 | AIR CONDITIONER-WEST "CU2" | 4 |
| 5 | RECEPTACLES-BREAK AREA SOUTH COUNTER AND UNDER SINK | 360 | Q0120 | 12 | 360 | | | | | | 6 |
| 7 | RECEPTACLES-BREAK AREA NORTH COUNTER AND FRIDGE | 980 | Q0120 | 12 | | 980 | 1 | | | | 8 |
|) | RECEPTACLES-BREAK AREA MICROWAVE | 1500 | Q0120 | 12 | 3150 | | 10 | Q0225 | 1650 | AIR CONDITIONER-EAST "CU1" | 10 |
| 1 | RECEPTACLES-CONFERENCE ROOM | 1440 | Q0120 | 12 | | 3090 | 710 | Q0225 | 1650 | AIR CONDITIONER-EAST COT | 12 |
| 3 | RECEPTACLES-SOUTHEAST OFFICE AND CLOSET | 900 | Q0120 | 12 | 900 | | | | | | 14 |
| 5 | RECEPTACLES-RESTROOMS | 360 | Q0120 | 12 | | 360 | | | | | 16 |
| | RECEPTACLES-NORTHEAST OFFICE AND PRINT AREA | 1080 | Q0120 | 12 | 2580 | | 12 | Q0120 | 1500 | FURNACE-WEST "F2" | 18 |
| - | RECEPTACLES-NE OPEN OFFICE, SOUTHWEST CUBICLES | 1620 | Q0120 | 12 | | 1620 | | | | | 20 |
| | RECEPTACLES-NE OPEN OFFICE, NORTHWEST CUBICLES | 1080 | Q0120 | 12 | 2280 | | 14 | Q0115 | 1200 | FURNACE-EAST "F1" | 22 |
| | RECEPTACLES-NE OPEN OFFICE, NORTH AND EAST CUBICLES | 2160 | Q0120 | 12 | | 2830 | 14 | 4 Q0215 | | ERV UNIT | 24 |
| | RECEPTACLES-NE OPEN OFFICE, COUNTER | 720 | Q0120 | 12 | 1390 | | 1 | | 670 | | 26 |
| | RECEPTACLES-WEST OPEN OFFICE, NORTH CUBICLES | 1620 | Q0120 | 12 | | 2820 | 14 | Q0115 | 1200 | HEATER-VESTIBULE | 28 |
| | RECEPTACLES-WEST OPEN OFFICE, SOUTH CUBICLES | 1620 | Q0120 | 12 | 2460 | | 14 | Q0115 | 840 | LIGHTS-SOUTH AND PRINT AREA | 30 |
| | RECEPTACLE-WATER HEATER AND CIRCULATING PUMP | 200 | Q0115 | 14 | | 1105 | 14 | Q0115 | 905 | LIGHTS-NORTH | 32 |
| 33 | | | | | 268 | | 14 | Q0115 | 268 | LIGHTS-PARKING | 34 |
| 35 | | | | | | | | | | | 36 |
| 37 | | | | | | | | | | | 38 |
| 39 | | | | | | | | | | | 40 |
| 41 | | | | | | | | | | | 42 |

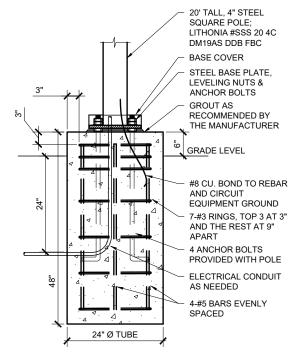

LIGHT POLE CONCRETE **BASE DETAIL**

- LIGHT POLE NOTES
- SEE SITE PLAN FOR POLE LOCATIONS. ENSURE ELECTRICAL CONDUIT IS INSTALLED WITHIN CONCRETE BASE.
- 3- FACTORY SUPPLIED TEMPLATE MUST BE USED WHEN SETTING ANCHOR BOLTS.
 4- ALL REBAR TO HAVE A MINIMUM 3" CLEARANCE FROM THE EDGE OF THE CONCRETE. TIE REBAR AT EVERY CROSSING\INTERSECTION.
- 5- COMPACT SUBGRADE TO REQUIRED ELEVATION BEFORE PLACING THE CONCRETE FOOTING.
- 6- CONCRETE REQUIREMENTS:
 - 3750 PSI CONCRETE @ 28 DAYS MINIMUM
 - CLASS A CONCRETE:
 - 6.5 BAGS/CY MINIMUM
 MAXIMUM WATER/CEMENT RATIO 5.5 GAL/BAG
 - COARSE AGGREGATE SIZE RANGE 1-1/2" TO #4 STANDARD OR 1" TO #4 ALTERNATIVE SLUMP RANGE: 1" TO 3" FOR STANDARD COARSE AGGREGATE AND 2" TO 4" FOR
- ALTERNATIVE AGGREGATE
 - REQUIRED ENTRAINED AIR: 4% TO 6%
- POUR CONCRETE AT TEMPERATURE ABOVE 35° FAHRENHEIT KEEP CONCRETE
- TEMPERATURE OVER 50° FOR 5 DAYS.
- 8- BACKFILL AREA AROUND FOOTING WITH CRUSHED AGGREGATE BASE MATERIAL AND COMPACT TO AT LEAST 95% MAXIMUM DENSITY.
 9- INSTALL WITH LIGHTING, MOUNTING DEVICES AND ALL OTHER NEEDED EQUIPMENT AS CALLED FOR. SEE LUMINAIRE LEGEND AND ALSO SHEETS C4 OR C3 ITEMS 15.

| | | | LUMI | NAIRE SC | CHEDULE | | |
|------|---------------------|--------------|--|---------------|-------------------|-----|---|
| TYPE | DESCRIPTION | MANUFACTURER | MODEL # | LAMPS | MOUNTING | Qty | NOTES: |
| A(1) | LINEAR I/D | PEERLESS | BRM9L VARIES MSL8 80CRI 35K ID800LMF 10/90 MIN1 ZT 120 SCT VARIES F2/SLP OJB 48A (OR VARIES) C210 | LED | CABLE/CEILING | 46 | SEE NOTES AND SPECS FOR CONTROLS, (1) STYLE ARE SWITCH CONTROLLED DIMMING WITHOUT DAYLIGHT DIMMING SENSOR ALL OTHER SHALL HAVE BUILT-IN DIMMING LIGHT HARVESTING SET PER LIGHTING NOTES, QUANTITY IS PER 4-FT SECTION |
| В | 1X4 LED | LITHONIA | LBL2LP835 | 32W LED | SURFACE/CEILING | 10 | |
| С | DOWN LIGHT | GOTHAM | EVO 35/10 6 DFAMF MVOLT | LED | RECESSED/CEILING | 2 | |
| CE | DOWN LIGHT | LITHONIA | LDN6 35/10 LO6 WR LSS MVOLT ELR | 11.8W LED | RECESSED/CEILING | 1 | MOUNT REMOTE TEST SWITCH ABOUT 6-INCH ABOVE INTERIOR DOOR |
| D | CYLINDER | LITHONIA | LDN6CYL 35/05 LO6 WR LSS MVOLT WM DWHG | 7.6W LED | SURFACE/WALL | 1 | |
| OC . | CYLINDER | LITHONIA | LDN6CYL 35/10 LO6 BR LSS MVOLT WM WL DDB | 12.6W LED | SURFACE/WALL | 2 | |
| E | EMERGENCY LIGHT | LITHONIA | EU2 LED M12 | (2) 1W LED | SURFACE/WALL/BACK | 2 | |
| F | SECURITY FLOODLIGHT | LITHONIA | OLF 2RH 40K 120 MO BZ | (2) 12.5W LED | SURFACE/WALL | 1 | |
| G(S) | LINEAR I/D | PEERLESS | BRM9L S VARIES 80CRI 35K 750LMF MIN1 ZT 120 SCT VARIES C210 | LED | SURFACE/CEILING | 6 | SEE NOTES AND SPECS FOR CONTROLS, (S) STYLE IS DAYLIGHT DIMMING SECURTIY LUMINARE DIMMING WITHOUT DAYLIGHT DIMMING SENSOR ALL OTHE SHALL HAVE BUILT—IN DIMMING LIGHT HARVESTING SET PER LIGHTING NOTES QUANTITY IS PER 4-FT SECTION |
| X | EXIT SIGN | LITHONIA | ECG LED M6 | LED | SURFACE/WALL/BACK | 4 | |
| ΚH | EXIT SIGN | LITHONIA | ECG LED HO M6 | LED | SURFACE/WALL/SIDE | 3 | POWERS LOCAL REMOTE HEADS |
| <2 | EXIT SIGN | LITHONIA | ECG LED M6 | LED | SURFACE/SIDE/WALL | 1 | DUAL FACE |
| RI | REMOTE LAMP | LITHONIA | ELA LED M12 | 1W LED | SURFACE/WALL | 1 | |
| RE | REMOTE LAMP | LITHONIA | ELA LED WP M12 | 1W LED | SURFACE/WALL | 2 | |
| S2 | LED AREA LUMINAIRE | LITHONIA | CSX1 LED 60C 40K TM3 MVOLT SPA DDBXD | 134W LED | POLE | 2 | SEE DETAIL FOR POLE, DLL127F 1.5 JU PHOTOCELL, ON TIMER |



REGION 4 INTERMOUNTAIN REGION

| | STAMPS, LOGOS, AND SEALS | |
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| NO. | REVISION / ISSUE | DATE |
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PROJECT NAME

FLAMING GORGE RANGER DISTRICT OFFICE **ADDITION**


ASHLEY NATIONAL FOREST

FLAMING GORGE RANGER DISTRICT

DRAWING TITLE

PANEL SCHEDULES AND LIGHT POLE DETAIL

| DATE | ARCHIV | E NO. |
|--------------------|--------|-------------------|
| DESIGNER S.BROV | /N | DRAWING SHEET NO. |
| DRAWN S.BROV | /N | E0.02 |
| CHECKED D.JEPPS | EN | |
| PROJECT NO. | | SHEET 116 OF 119 |

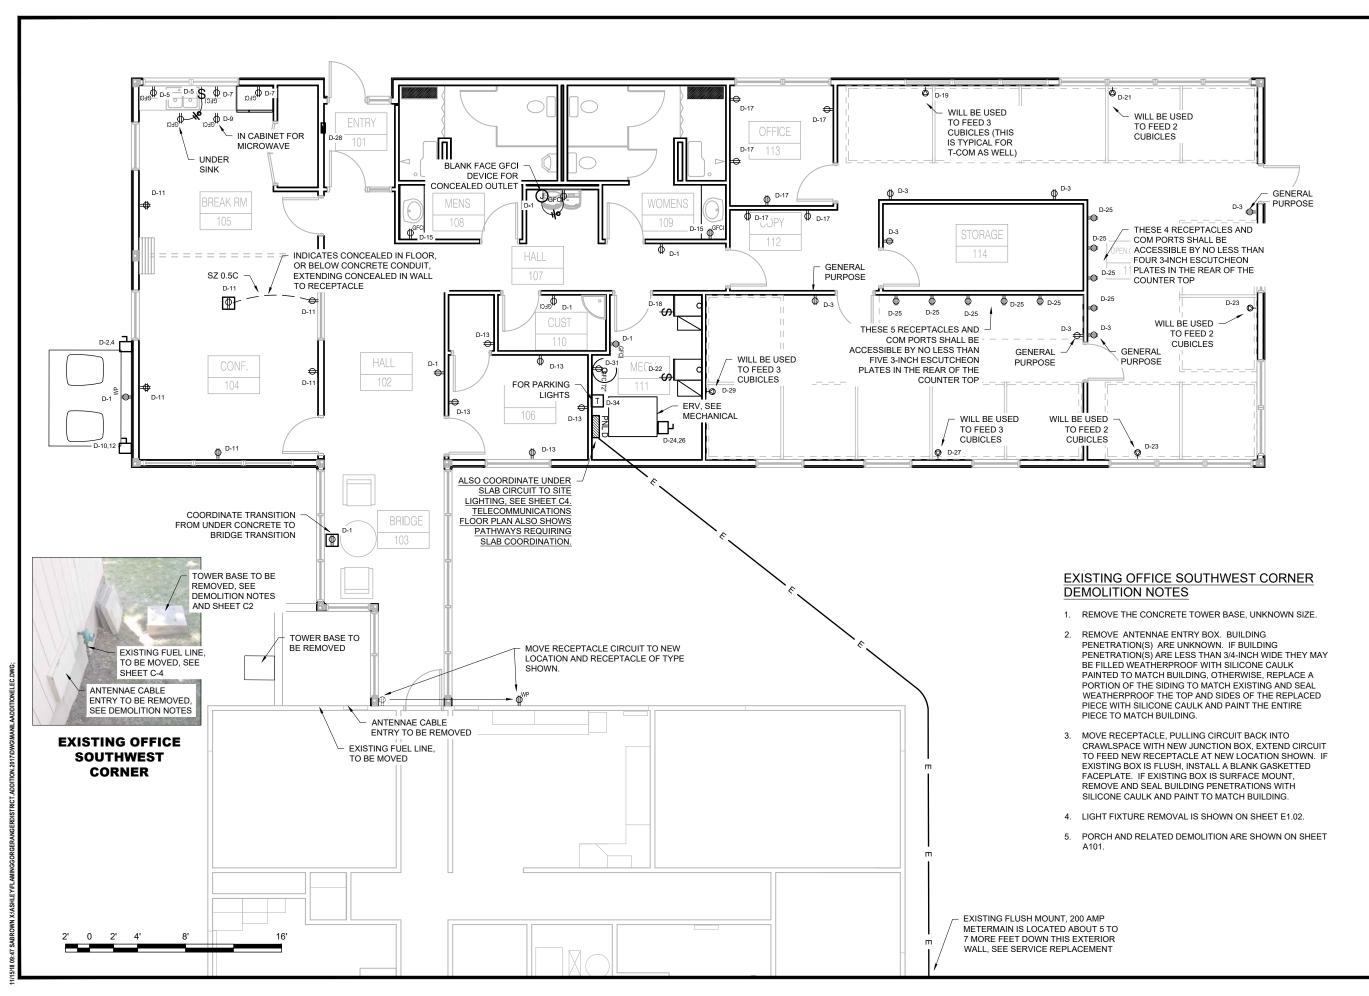



REGION 4
INTERMOUNTAIN REGION

STAMPS, LOGOS, AND SEALS

2 Regina Freel

11/29/18

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NO. REVISION/ISSUE DATE

PROJECT NAME

FLAMING GORGE RANGER DISTRICT OFFICE ADDITION


ASHLEY
NATIONAL FOREST

FLAMING GORGE RANGER DISTRICT

DRAWING TITLE

POWER AND RECEPTACLE FLOOR PLAN

| DATE | ARCHIV | E NO. |
|--------------------|--------|-------------------|
| DESIGNER S.BROV | /N | DRAWING SHEET NO. |
| DRAWN S.BROV | /N | E1.01 |
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| PROJECT NO. | | SHEET 117 OF 119 |

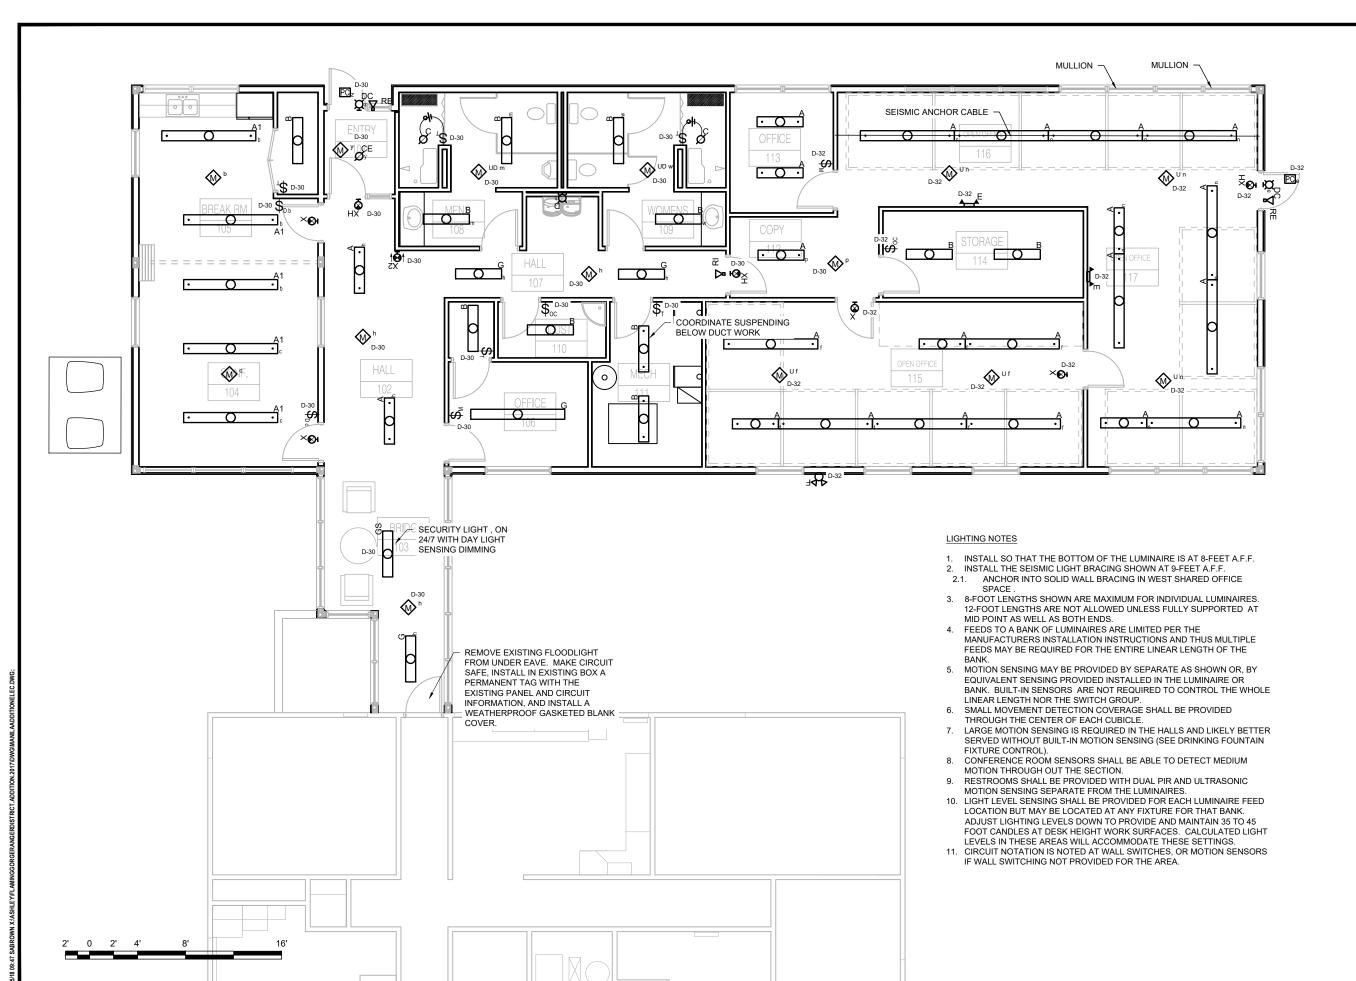



Forest Service

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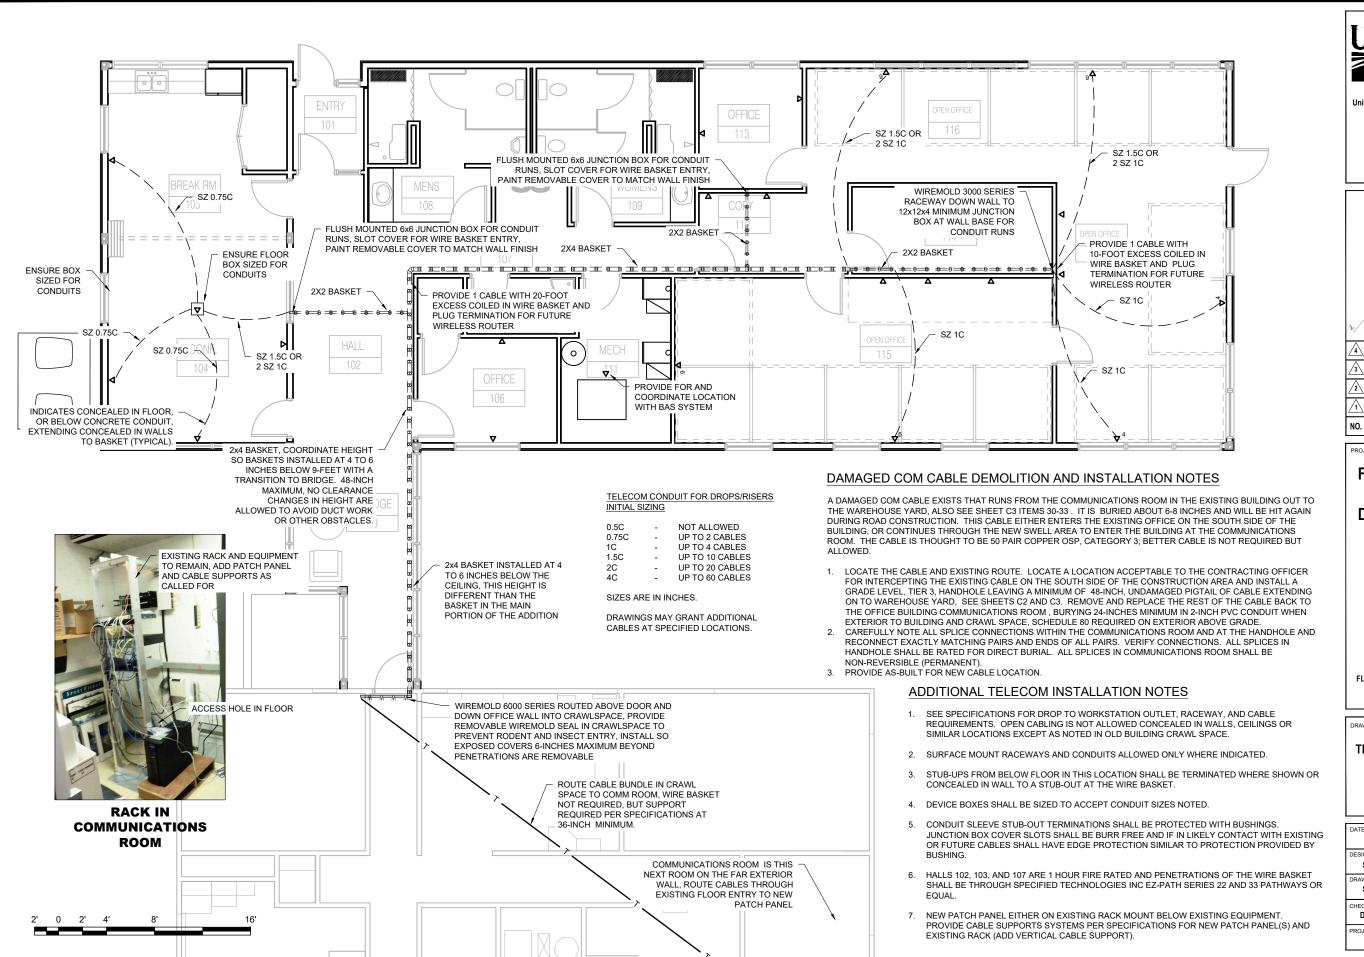
ASHLEY
NATIONAL FOREST

FLAMING GORGE RANGER DISTRICT

DRAWING TITLE

LIGHTING FLOOR PLAN

| DATE ARCHIVE | | E NO. | | |
|--------------------|----|-------------------|--|--|
| DESIGNER S.BROV | /N | DRAWING SHEET NO. | | |
| DRAWN S.BROWN | | E1.02 | | |
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| PROJECT NO. | | SHEET 118 OF 119 | | |



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FLAMING GORGE RANGER DISTRICT OFFICE ADDITION

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FLAMING GORGE RANGER DISTRICT

DRAWING TITLE

TELECOMMUNICATIONS FLOOR PLAN

DATE ARCHIVE NO.

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DRAWN S.BROWN
CHECKED D.JEPPSEN
PROJECT NO.

ARCHIVE NO.
DRAWING SHEET NO.
DRAWING SHEET NO.
SHEET 119 OF 119