PROJECT DESCRIPTION		LEGAL DESCRIPTI	ON
- INTERIOR RENOVATION OF 1,615 SQ.FT. OF DINING AREA. RENOVATION FINISHES, TRANSACTION COUNTER, MILLWORK, ELECTRICAL, SPRINK - NEW 200 SQ.FT. PATIO SEATING INCLUDING NEW CONCRETE PAD AND INFILL OF EXISTING DRIVE-THRU WINDOW - EXTERIOR PAINTING - NO WORK DONE AT KITCHEN AND BACK OF HOUSE - NO NEW PLUMBING - EXISTING RESTROOMS TO REMAIN. NEW FINISHES. DEFERRED SUBMITTALS GC TO PROVIDE DEFERRED SUBMITTAL FOR MECHANICAL, ELECTRICAL FIRE SPRINKLER WORK BY SEPARATE PERMIT SIGNAGE UNDER SEPARATE PERMIT	KLERS AND LIGHTING. D METAL RAILING.	PROJECT ADDRESS: PARCEL RECORD: ZONING: OCCUPANCY CLASSIFICATION: SPINKLERED: BUILDING SQ.FT.: AREA OF WORK: EXISTING USE: PROPOSED USE: PARKING PROVIDED: NEW ADDITION AREA: STORIES:	1869 E MURRAY HOLLADAY RD HOLLADAY, UT 84117 22092270710000 C-2 ASSEMBLY GROUP A-2 - NO CHANGE YES 3,200 SQ.FT. 1,815 SQ.FT. COMMERCIAL - RESTAURANT COMMERCIAL - RESTAURANT EXISTING - NO CHANGE NO ADDITIONAL SQ.FT. 1
DDO IECT DIDECTORY		QUEET INIDEY	
PROJECT DIRECTORY OWNER: TONY VALDEZ 8870 SOUTH 540 EAST SANDY, UT 84070 PHONE: 801.946.5241 ARCHITECT: OFFICE DFK 333 W. PEIRPONT AVE. #4 SALT LAKE CITY, UT 84101 PHONE: 801.447.5101 CELL: 419.575.0411 EMAIL: BRANDON@OFFICE-DFK.COM CONTACT: BRANDON BROADSTONE CONTRACTOR: COOK BUILDERS PO BOX 684 380 SOUTH MAIN STREET CENTERVILLE, UT 84014 PHONE: 801.295.3060 EMAIL: NATE@COOKBUILDER.COM		ARCHITECTURAL A0.10 PROJECT DATA A0.20 ABBREV, SYMBOLS & LEGEN A0.30 TYPICAL NOTES A0.40 PROPOSED SUBDIVISION SH A1.20 SITE & ROOF PLAN A1.30 EXITING PLAN A1.40 DEMOLITION PLAN A1.50 CONSTRUCTION PLAN A1.60 POWER AND COMMUNICATI A1.70 REFLECTED CEILING PLAN A1.80 FINISH PLAN A4.10 INTERIOR ELEVATIONS A4.11 INTERIOR ELEVATIONS A5.00 CONSTRUCTION DETAILS A5.10 CABINETRY DETAILS	HEETS ——ON PLAN
SCOPE OF WORK	VICINITY MAP		
DINING AREA (INTERIOR RENOVATION): 1,615 SQ.FT. NEW PATIO 200 SQ.FT. TOTAL SCOPE OF WORK: 1,815 SQ.FT. APPLICABLE CODES 2012 INTERNATIONAL BUILDING CODE 2012 INTERNATIONAL PLUMBING CODE 2012 INTERNATIONAL PLUMBING CODE 2012 INTERNATIONAL PLUMBING CODE 2012 INTERNATIONAL MECHANICAL CODE 2012 INTERNATIONAL ENERGY CONSERVATION CODE (COMMERCIAL) 2012 INTERNATIONAL FIRE CODE	E 4705 S E 4705 S Recreation Center Xfinity Store by Relations Park Big Cottonwood Regional Park Colony Dr Redescreation Center Xfinity Store by Reference of Recreation Center E 4945 S	SUNCREST PARK SUNCREST PARK Crestmand To States of Postal Service of Postal Servic	E MURRAY HOLLADAY RD LADAY, UT 841117 Manage Control Contr

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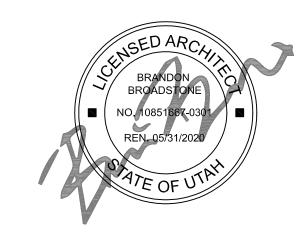
CONSULTANTS:

STRUCTURAL ENGINEERS

CONTRACTOR

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ABBREVIATIONS

7RRKE /	VIATIONS		
	ANGLE	MAX	MAXIMUM
)	AT	MB	MACHINE BOLT
В	ANCHOR BOLT	MC	MEDICINE CABINET
BV	ABOVE	MECH	MECHANICAL
С	AIR CONDITION	MET	METAL
D	AREA DRAIN	MICRO	MICROWAVE OVEN
DDL	ADDITIONAL	MIN	MINIMUM
DJ	ADJUSTABLE	MISC	MISCELLANEOUS
LUM PPVL	ALUMINUM APPROVAL	MLDG MO	MOLDING MASONRY OPENING
SPH	ASPHALT	MTD	MOUNTED
	,		
D	BOARD	(N)	NEW
LDG	BUILDING	NIC	NOT IN CONTRACT
LKG	BLOCKING	NO.	NUMBER
M	BEAM	NOM	NOMINAL
N OT	BOUNDRY NAILING BOTTOM	NTS	NOT TO SCALE
01	BOTTOM	0/	OVER
AB	CABINET	OBS	OBSCURE
В	CATCH BASIN	OC	ON CENTER
EM	CEMENT	OD	OUTSIDE DIMAMETER
ER	CERAMIC	OPG	OPENING
	CAST IRON	OPP	OPPOSITE
J	CEILING JOIST	O/S	OUTSIDE
L	CENTER LINE	DANI	DANITON
LG LOS	CEILING CLOSET	PAN PL	PANTRY PLATE
LOS LR	CLEAR	PLAS	PLASTIC
NTR	COUNTER	PLAS LAM	PLASTIC LAMINATE
OMB ANC	COMBINATION ANCHOR	PLYWD	PLYWOOD
OMP	COMPRESSOR	PR	PAIR
ONC	CONCRETE	PT	POINT
ONN	CONNECTION		
ONT	CONTINUOUS	R	RISER
RN	CROWN	RAD	RADIUS
TSK	COUNTER SUNK	RD	ROOF DRAIN
	DDVCD	REF	REFRIGERATOR
DI	DRYER	REG	REGISTER
BL EMO	DOUBLE DEMOLISH/DEMOLITION	REINF	REINFORCED
ET	DETAIL	REQD	REQUIRED
IA	DIAMETER	RESIL RJ	RESILIENT
IM	DIMENSION	RM	ROOF JOIST ROOM
N	DOWN	RO	ROUGH OPENING
Р	DEEP	RR	ROOF RAFTER
R	DOOR		
S	DOWNSPOUT	SB	SHEAR BOLT
W	DISHWASHER	SC	SOLID CORE
WG	DRAWING DRAWER	SD	SMOKE DETECTOR
WR	DRAWER	SEC OPG	SECURITY OPENING
Ξ)	EXISTING	SECT	SECTION
-, Д	EACH	SH	SHELF
LEC	ELECTRIC	SH & DP	SHELF & DOUBLE POLE
N	EDGE NAILING	SHT SHTG	SHEET SHEATHING
NCL	ENCLOSURE	SHWR	SHOWER
Q	EQUAL	SIM	SIMILAR
QUIP	EQUIPMENT EACH WAY	SL	SLIDING
W XIST	EXISTING	SPEC	SPECIFICATION
XT	EXTERIOR	SPL	SPLASH
· 、	ZXI ZXI ZXI	SQ	SQURE
ΑU	FORCED AIR UNIT	ST STL	STAINLESS STEEL
)	FLOOR DRAIN	STD STL	STANDARD STEEL
G	FUEL GAS	STOR	STORAGE
GL N	FIXED GLASS FINISH	SUSP	SUSPENDED
N J	FLOOR JOIST	SYM	SYMMETRICAL
_	FLOOR LINE		
- _R	FLOOR	T	TREAD
LUOR	FLUORESCENT	T&G	TONGUE & GROOVE
ND	FOUNDATION	TA	TENSION ANCHOR
C	FACE OF CONCRETE	TC	TRASH COMPACTOR
OF	FACE OF FINISH	TOC	TOP OF CURB
OS -	FACE OF STUD	TEL TER	TELEPHONE TERRAZZO
Γ	FIREPLACE FOOT OR FEET	THK	THICK
ι ΓG	FOOTING	TD	TOP OF DRAIN
JRR	FURRING	TP	TOP PLATE
ZR	FREEZER	TPV	TOP OF PAVING
		TV	TELEVISION
Α	GAUGE	TW	TOP OF WALL
ALV	GALVANIZED	TYP	TYPICAL
D I	GARBAGE DISPOSAL GALVANIZED IRON	UNF	UNFINISHED
ı L	GLASS	UNF	UNLESS OTHERWISE NOTED
LB	GLUE LAMINATED BEAM	JUIN	THE TOTAL PROPERTY OF THE PROP
R	GRADE	VERT	VERTICAL
WB	GYPSUM WALL BOARD		
R	HOSE BID	W	WASHER
B C	HOSE BIB HOLLOW CORE	W/	WITH
D	HOLDDOWN	WC	WATER CLOSET
ORIZ	HORIZONTAL	WD WH	WOOD WATER HEATER

HARDWARE

HRDWD

WATER HEATER

WITHOUT

SYMBOLS / LEGEND

DETAIL NO. A0.0 SHEET NO.	DETAIL
SECTION NO. A0.0 SHEET NO.	BUILDING SECTION
1 ELEVATION NO. SHEET NO.	EXTERIOR ELEVATION
C (A0.0) A	INTERIOR ELEVATION
·	TRUE NORTH
<u></u>	PROJECT NORTH
0'-0"	NEW DIMENSION
(0'-0")	EXISTING DIMENSION
00	WINDOW NO.
00	DOOR NO.
1	REVISION NO.
1)	FIXTURE NO.
·_·_	PROPERTY LINE
	PROJECTION OR SOFFIT
	CUT LINE
======	TO BE REMOVED
	EXISTING WALL
	NEW WALL

MATERIAL LEGEND

	ACOUSTICAL TILE
	AGGREGATED BASE
	ALUMINUM
	BATT INSULATION
	CERAMIC TILE (SECTION)
4. 4. 4.	CONCRETE
	CONCRETE BLOCK
	GLASS (PLAN/SECTION)
	GLASS (ELEVATION)
	GYPSUM BOARD
	LIGHTWEIGHT CONCRETE
	MARBLE/GRANITE
mm	METAL LATH
	MILLWORK
	PLASTER
	PLASTIC LAMINATE
	PLYWOOD
	QUARRY TILE
	RIGID INSULATION
	SHEET METAL (ELEVATION)
	SHEET METAL (SECTION)
	SOIL
	STEEL

WOOD BLOCKING

WOOD FRAMING

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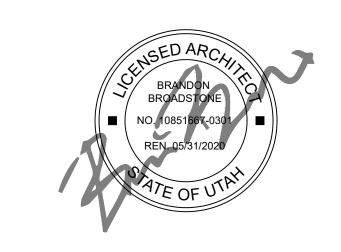
CONSULTANTS: STRUCTURAL ENGINEERS

CLIENT:

CONTRACTOR

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ABBREVIATIONS, SYMBOLS & **LEGENDS**

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GENERAL NOTES

- COMPLY WITH CODES, LAWS, ORDINANCES, RULES, AND REGULATIONS OF PUBLIC AUTHORITIES GOVERNING THE WORK.
- 2. OBTAIN AND PAY FOR PERMITS AND INSPECTIONS REQUIRED BY PUBLIC AUTHORITIES GOVERNING THE WORK.
- 3. REVIEW DOCUMENTS, VERIFY DIMENSIONS AND FIELD CONDITIONS AND CONFIRM THAT WORK IS BUILDABLE AS SHOWN. REPORT ANY CONFLICTS OR OMISSIONS TO THE ARCHITECT FOR CLARIFICATION PRIOR TO PERFORMING ANY WORK IN QUESTION.
- 4. SUBMIT REQUESTS FOR SUBSTITUTIONS, REVISIONS, OR CHANGES TO ARCHITECT FOR REVIEW PRIOR TO PURCHASE, FABRICATION OR INSTALLATION.
- 5. COORDINATE WORK WITH THE OWNER, INCLUDING SCHEDULING TIME AND LOCATIONS FOR DELIVERIES, BUILDING ACCESS, USE OF BUILDING SERVICES AND FACILITIES, AND USE OF ELEVATORS.
 MINIMIZE DISTURBANCE OF BUILDING FUNCTIONS AND OCCUPANTS.
- 6. OWNER WILL PROVIDE WORK NOTED "BY OTHERS" OR "NIC" UNDER SEPARATE CONTRACT. INCLUDE SCHEDULE REQUIREMENTS IN CONSTRUCTION PROGRESS SCHEDULE AND COORDINATE TO ASSURE ORDERLY SEQUENCE OF INSTALLATION
- . COORDINATE TELECOMMUNICATIONS, DATA AND SECURITY SYSTEM INSTALLATIONS.
- 8. MAINTAIN EXITS, EXIT LIGHTING, FIRE PROTECTIVE DEVICES, AND ALARMS IN CONFORMANCE WITH CODES AND ORDINANCES.
- 9. PROTECT AREA OF WORK AND ADJACENT AREAS FROM DAMAGE.
- 10. MAINTAIN WORK AREAS SECURE AND LOCKABLE DURING CONSTRUCTION. COORDINATE WITH TENANT AND LANDLORD TO ENSURE SECURITY.
- 11. DO NOT SCALE DRAWINGS. WRITTEN DIMENSIONS GOVERN. IN CASE OF CONFLICT, CONSULT THE ARCHITECT.
- 12. PARTITIONS ARE DIMENSIONED FROM FINISH FACE TO FINISH FACE, UNLESS OTHERWISE NOTED. MAINTAIN DIMENSIONS MARKED "CLEAR". ALLOW FOR THICKNESS OF FINISHES.
- 13. COORDINATE AND PROVIDE BACKING FOR ITEMS ATTACHED OR MOUNTED TO WALLS.
- 14. GENERAL CONTRACTOR SHALL EXERCISE EXTREME CARE DURING ALL PHASES OF CONSTRUCTION SO AS NOT TO DAMAGE OR DISRUPT UTILITIES WHICH MIGHT PASS THROUGH THIS SPACE TO SERVICE OTHER TENANTS. GENERAL CONTRACTOR BEAR SOLE EXPENSE FOR ANY SUCH DAMAGE OR DISRUPTIONS.
- 15. ACCESS PANELS MUST BE PROVIDED FOR ALL LANDLORD SERVICEABLE EQUIPMENT WHICH IS ABOVE ANY HARD CEILING AREAS. SUPPLY VENTS AND RETURN VENTS ARE ALLOWED AS A MEANS OF ACCESS. UNITS ABOVE HARD CEILINGS MUST HAVE A WORK PLATFORM CONSTRUCTED ABOVE THE CEILING FOR UNIT SERVICING. IF A WORK PLATFORM IS NOT CONSTRUCTED, A LETTER MUST BE SUBMITTED UPON JOB CLOSEOUT STATING THAT THE CEILING IS RATED TO WITHSTAND ALL ASSOCIATED WEIGHT WHILE SERVICING THE EQUIPMENT ABOVE.
- 16. THIS SET OF PLANS SHOULD BE FORWARDED TO GENERAL CONTRACTOR AND MUST BE ON SITE AT TIME OF PRE-CONSTRUCTION MEETING.

DISABLED ACCESS NOTES

- THE HEIGHT OF THE WATER CLOSET (TOP OF SEAT) SHALL BE BETWEEN 17" AND 19".
- 2. MOUNT FLUSH VALVE CONTROL NO MORE THAN 44" ABOVE THE FLOOR, ON THE SIDE OF THE TOILET WITH THE GREATEST SEPARATION FROM ADJACENT WALL OR OTHER SURFACE.
- 3. PROVIDE GRAB BARS ON EACH SIDE, OR ONE SIDE AND BACK OF WATER CLOSET.
- 3.1. GRAB BARS TO BE 33" ABOVE AND PARALLEL TO THE FLOOR
- 3.2. SIDE BARS TO BE 42" LONG AND PROJECT 24" IN FRONT OF WATER CLOSET STOOL. GRAB BAR AT BACK TO BE 36" LONG. 3.3. DIAMETER OF GRAB BARS TO BE 1-1/4" TO 1-1/2".
- 3.4. PROVIDE 1-1/2" CLEARANCE BETWEEN GRAB BARS AND WALL.
- 3.5. GRAB BARS (INCLUDING CONNECTORS, FASTENERS, SUPPORT
- BACKING, ETC.) SHALL SUPPORT A 250 POUND LOAD.

 3.6. GRAB BARS SHALL NOT ROTATE WITHIN THEIR FITTINGS.
- 3.7. GRAB BARS AND ANY ADJACENT SURFACE SHALL BE FREE OF SHARP OR ABRASIVE ELEMENTS.
- 3.8. EDGES SHALL HAVE A MINIMUM RADIUS OF 1/8".
- 4. PROVIDE A CLEAR FLOOR SPACE 30" X 48" IN FRONT OF LAVATORY TO PERMIT A FORWARD APPROACH.
- 5. MOUNT LAVATORIES WITH A MINIMUM CLEARANCE OF 29" FROM THE FLOOR TO THE BOTTOM OF THE APRON. PROVIDE KNEE CLEARANCE UNDER THE FRONT LIP EXTENDING A MINIMUM OF 30" IN WIDTH WITH 8" MINIMUM WIDTH, AND SHALL BE A MINIMUM OF 9" HIGH FROM THE FLOOR A MINIMUM OF 17" DEEP FROM THE FRONT OF THE LAVATORY.
- 6. FAUCET CONTROLS AND OPERATING MECHANISMS SHALL BE OPERABLE WITH ONE HAND AND SHALL NOT REQUIRE TIGHT GRASPING, PINCHING OR TWISTING OF THE WRIST. THE FORCE REQUIRED TO ACTIVATE CONTROLS SHALL BE NO GREATER THAN 5 POUNDS. LEVER OPERATED, PUSH TYPE AND ELECTRONICALLY CONTROLLED MECHANISMS ARE EXAMPLES OF ACCEPTABLE DESIGNS. SELF CLOSING ARE ALLOWED IF THE FAUCET REMAINS OPEN FOR AT LEAST 10 SECONDS.
- 7. INSULATE OR OTHERWISE COVER HOT WATER AND DRAIN PIPES UNDER LAVATORIES.
- 8. THERE SHALL BE NO SHARP OR ABRASIVE SURFACES UNDER LAVATORIES.

DISABLED ACCESS NOTES

- 1. IN BUILDINGS AND FACILITIES, FLOORS OF A GIVEN STORY SHALL BE A COMMON LEVEL THROUGHOUT, OR SHALL BE CONNECTED BY PEDESTRIAN RAMPS, PASSENGER ELEVATORS OR SPECIAL ACCESS LIFTS.
- 2. FLOOR SURFACES SHALL BE SLIP-RESISTANT
- 3. EVERY CORRIDOR AND AISLE SERVING AN OCCUPANT LOAD OF 10 OR MORE SHALL BE NOT LESS THAN 44" IN WIDTH.
- 4. ABRUPT CHANGES IN LEVEL ALONG ANY ACCESSIBLE ROUTE SHALL NOT EXCEED 1/2" IN HEIGHT. LEVEL CHANGES NOT EXCEEDING 1/4" MAY BE VERTICAL. BEVEL OTHERS WITH A SLOPE NO GREATER THAN 1:2
- 5. LATCHING AND LOCKING DOORS THAT ARE HAND ACTIVATED AND WHICH ARE IN A PATH OF TRAVEL SHALL BE OPERABLE WITH A SINGLE EFFORT BY LEVER TYPE HARDWARE, PANIC BARS, PUSH-PULL ACTIVATING BARS, OR OTHER HARDWARE DESIGNED TO PROVIDE PASSAGE WITHOUT REQUIRING THE ABILITY TO GRASP THE OPENING HARDWARE. MOUNT DOOR OPENING HARDWARE BETWEEN 30" AND 44" ABOVE FLOOR FINISH.
- CENTER HAND ACTIVATED DOOR OPENING HARDWARE BETWEEN 30" AND 44" ABOVE THE FLOOR.
- 7. MAXIMUM PULL OR PUSH EFFORT TO OPERATE DOORS SHALL NOT EXCEED 8.5 POUNDS FOR EXTERIOR DOORS AND 5 POUNDS FOR INTERIOR DOORS, MEASURED AT RIGHT ANGLES TO HINGED DOORS AND AT CENTER PLANE OF SLIDING OR FOLDING DOORS. CORRESPONDING DEVICES OR AUTOMATIC DOOR OPERATORS MAY BE UTILIZED TO MEET THE ABOVE STANDARDS. MAXIMUM EFFORT TO OPERATE REQUIRED FIRE DOORS MAY BE INCREASED NOT TO EXCEED 15 POUNDS.
- 8. THE BOTTOM 10" OF ALL DOORS (EXCEPT SLIDING AND AUTOMATIC) SHALL HAVE A SMOOTH UNINTERRUPTED SURFACE TO ALLOW THE DOOR TO BE OPENED BY A WHEELCHAIR FOOTREST WITHOUT CREATING A TRAP OR HAZARDOUS CONDITION. PROVIDE A 10" HIGH SMOOTH PANEL ON THE PUSH SIDE OF NARROW FRAME DOORS.
- 9. EVERY REQUIRED ENTRANCE OR PASSAGE DOORWAY SHALL BE NOT LESS THAN 3' IN WIDTH AND NOT LESS THAN 6'-8" IN HEIGHT. DOORS SHALL BE CAPABLE OF OPENING AT LEAST 90 DEGREES AND SHALL BE SO MOUNTED THAT THE CLEAR WIDTH OF THE DOORWAY IS NOT LESS THAN 32".
- 10. WHERE A PAIR OF DOORS IS UTILIZED, AT LEAST ONE OF THE DOORS SHALL PROVIDE A CLEAR, UNOBSTRUCTED OPENING WIDTH OF 32" WITH THE LEAF POSITIONED AT AN ANGLE OF 90 DEGREES FROM ITS CLOSED POSITION.
- 11. IDENTIFY ACCESSIBLE ENTRANCES WITH AT LEAST ONE STANDARD SIGN AND WITH ADDITIONAL DIRECTIONAL SIGNS, AS REQUIRED, VISIBLE FROM APPROACHING PEDESTRIAN WAYS.
- 12. THE FLOOR OR LANDING ON EACH SIDE OF AN ENTRANCE OR PASSAGE DOOR SHALL BE LEVEL AND CLEAR. THE LEVEL AND CLEAR AREA SHALL HAVE A LENGTH IN THE DIRECTION OF DOOR SWING OF AT LEAST 60" AND THE LENGTH OPPOSITE THE DIRECTION OF DOOR SWING OF 44" AS MEASURED AT RIGHT ANGLES TO THE PLANE OF THE DOOR IN ITS CLOSED POSITION.
- 13. FLOORS OR LANDINGS SHALL BE NOT MORE THAN 1/2" LOWER THAN THE THRESHOLD OF THE DOORWAY. CHANGE IN LEVEL BETWEEN 1/4" AND 1/2" SHALL BE BEVELED WITH A SLOPE NO GREATER THAN 1:2.
- 14. TO ALERT THE VISUALLY IMPAIRED, MARK THE UPPER APPROACH AND THE LOWER TREAD OF EACH INTERIOR STAIR WITH A STRIP OF CLEARLY CONTRASTING COLOR AT LEAST 2" WIDE, PLACED PARALLEL TO AND NOT MORE THAN 1" FROM THE NOSE OF THE STEP OR LANDING. THE STRIP SHALL BE OF A MATERIAL THAT IS AT LEAST AS SLIP RESISTANT AS THE OTHER TREADS OF THE STAIR.
- 15. CENTER ELECTRICAL RECEPTACLE OUTLETS NOT LESS THAN 15" ABOVE THE FLOOR OR WORKING PLATFORM.
- 16. SANITARY FACILITIES LOCATED ON AN ACCESSIBLE FLOOR OF A BUILDING SHALL BE ACCESSIBLE TO THE PHYSICALLY HANDICAPPED.
- 17. ENTRY TO SANITARY FACILITIES:
- 17.1. A. 44" CLEAR AISLES OR CORRIDORS WHERE OCCUPANT LOAD IS 10 OR MORE.
- 17.2. DOORWAYS TO HAVE A 32" CLEAR OPENING.
- 17.3. ON APPROACH SIDE, PROVIDE A 60" CLEAR LEVEL SPACE WHEN DOOR SWINGS TOWARD APPROACH AND 44" SPACE WHEN DOOR SWINGS AWAY FROM APPROACH.
- 18. TOILET ROOM ACCESSORIES
- 18.1. MOUNT BOTTOM EDGE OF MIRRORS NO HIGHER THAN 40" FROM THE FLOOR.
- 18.2. MOUNT TOILET TISSUE DISPENSERS WITHIN 12" FROM THE FRONT EDGE OF THE TOILET SEAT.
- 18.3. MOUNT DISPENSING AND DISPOSAL FIXTURES (TOWEL, SANITARY NAPKINS, WASTE, COIN SLOTS, ETC.) WITH OPERATING PARTS NO HIGHER THAN 40" FROM THE FLOOR.
- 19. SINGLE ACCOMMODATION TOILET FACILITY
- 19.1. WATER CLOSET TO HAVE A 28" CLEARANCE FROM A FIXTURE AND 32" FROM A WALL.
- 19.2. MINIMUM CLEAR SPACE IN FRONT OF WATER CLOSET TO BE 48".
- 19.3. A SPACE 36" X 48" IS PERMITTED IN FRONT OF EXISTING WATER CLOSET ACCESSIBLE TO THE HANDICAPPED.

CLIENT:

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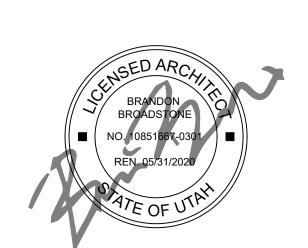
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TYPICAL NOTES

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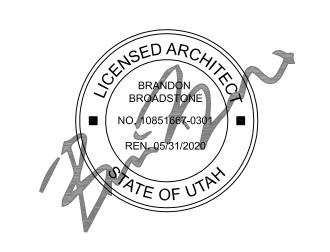
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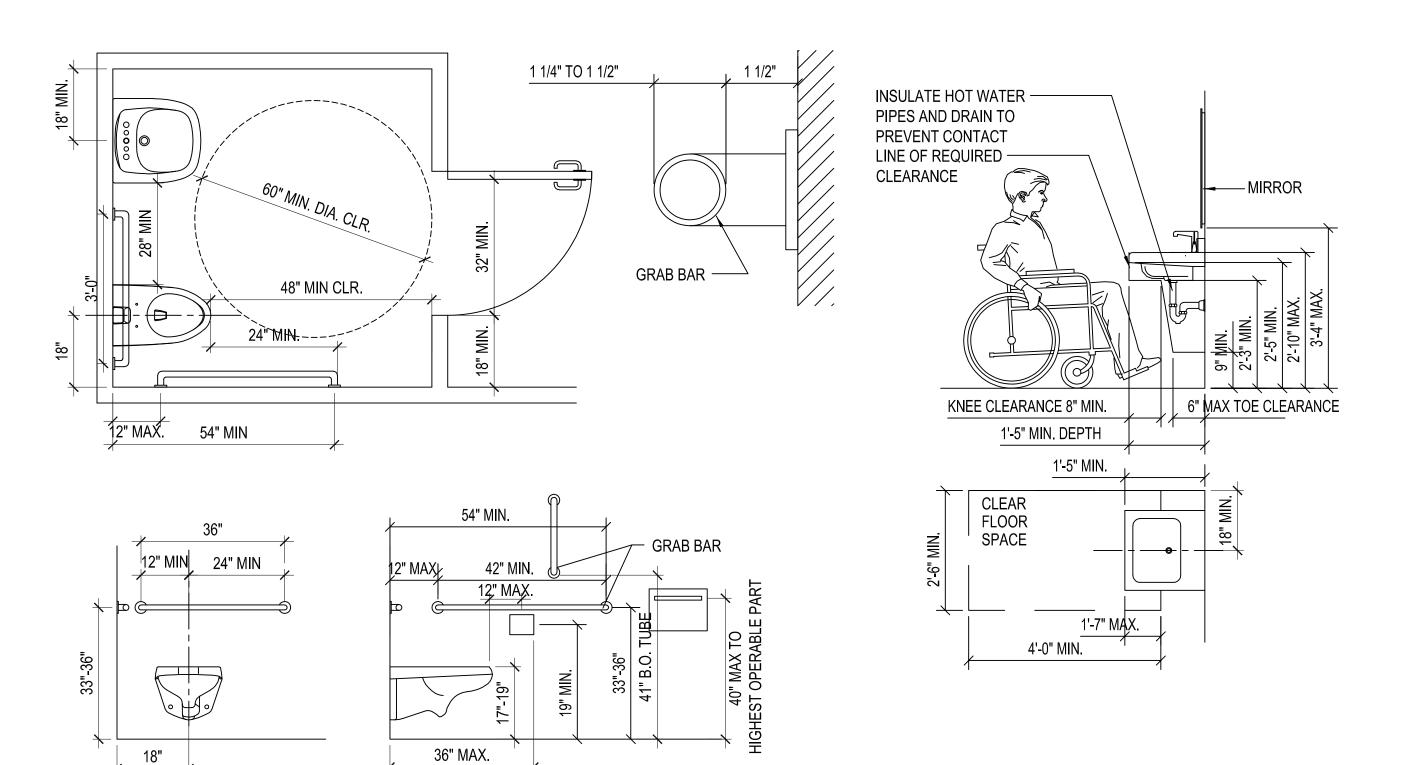
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ACCESSIBILITY DIAGRAMS

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SINGLE USER TOILET

PLUMBING FIXTURE CALCULATIONS

OCCUPANTS PER A1.30 EXITING PLAN = 108 TOTAL

108 / 2 = 54 MALE, 54 FEMALE

(PER TABLE 403.1 ASSEMBLY A-2 RESTAURANT) REQUIRED MALE WATER CLOSETS = 1 PER 75 = 1 REQUIRED REQUIRED FEMALE WATER CLOSETS = 1 PER 75 = 1 REQUIRED

SINK OR VANITY


REQUIRED MALE LAVATORIES = 1 PER 200 = 1 REQUIRED REQUIRED FEMALE LAVATORIES = 1 PER 200 = 1 REQUIRED


MALE WATER CLOSETS PROVIDED = 1 FEMALE WATER CLOSET PROVIDED = 1

MALE LAVATORIES PROVIDED = 1 FEMALE LAVATORIES PROVIDED = 1

GENERAL NOTES

EXISTING RESTROOMS TO REMAIN.

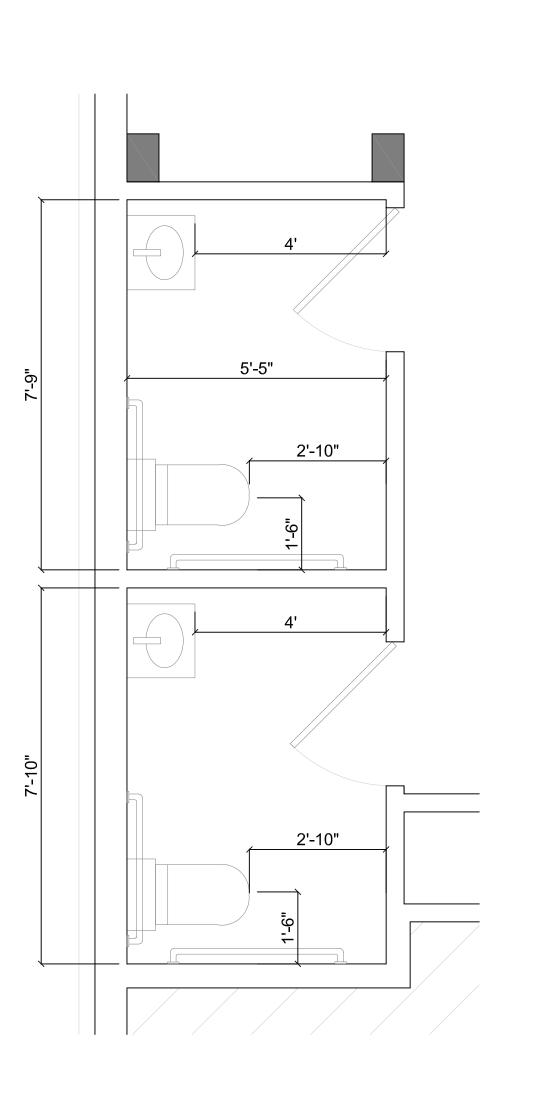

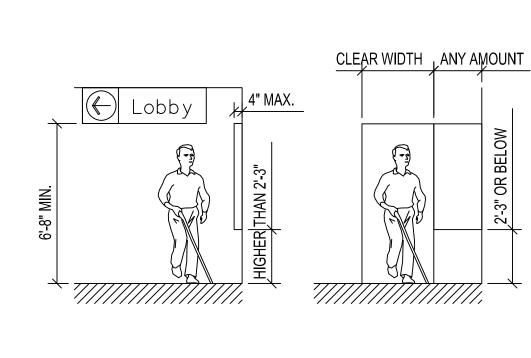

10" MAX.

REACH RANGES

4'-0"

PROTRUDING OBJECTS

THRESHOLDS

NOTE: X = 1'-0" IF DOOR HAS BOTH A CLOSER AND A LATCH

NOTE: X =3'-0" MIN. IF Y=5'-0"; X= 3'-6" MIN. IF Y=4'-6".

NOTE: Y= 4'-0" MIN.; Y=4'-6" MIN. IF DOOR HAS A CLOSER

NOTE: Y= 3'-6" MIN.; Y=4'-0" MIN. IF DOOR HAS A CLOSER

NOTE: Y= 3'-6" MIN.;

Y=4'-0" MIN. IF DOOR HAS A CLOSER

CLEARANCES

4'-0" MIN.

ENLARGED EXISTING RESTROOMS

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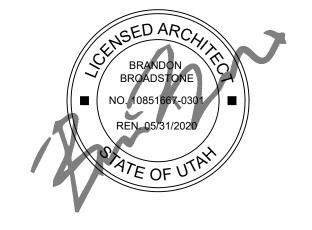
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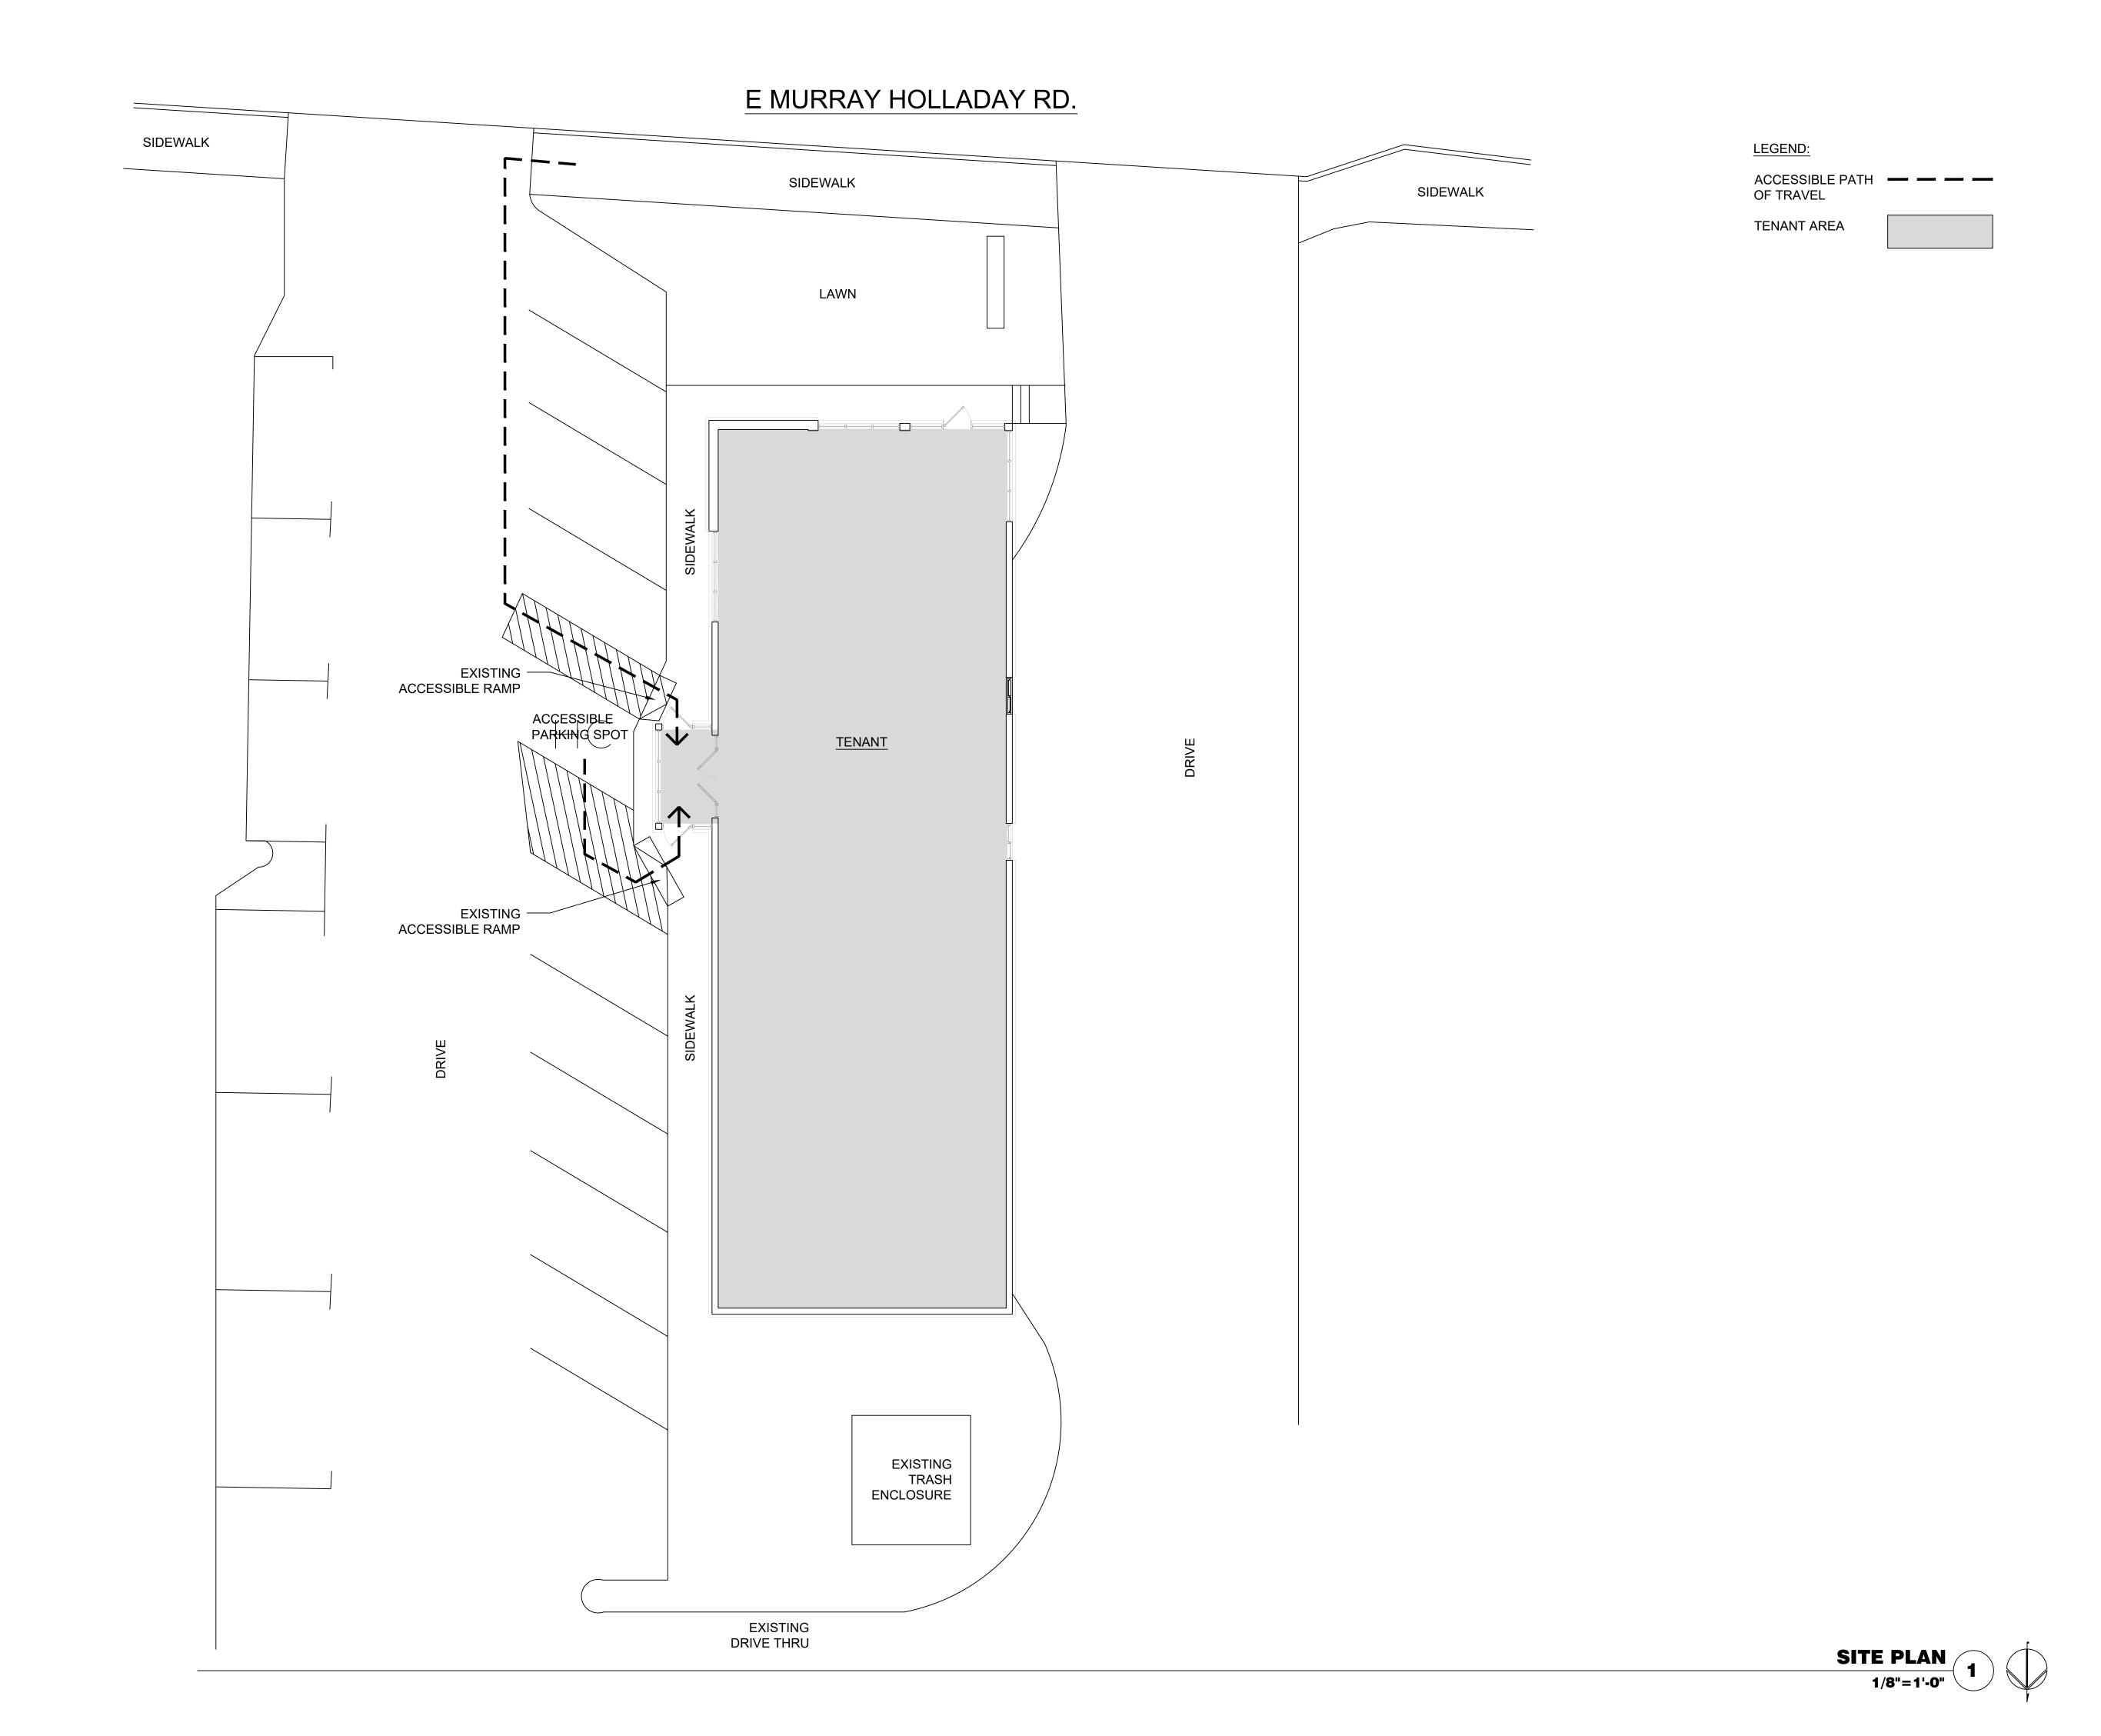
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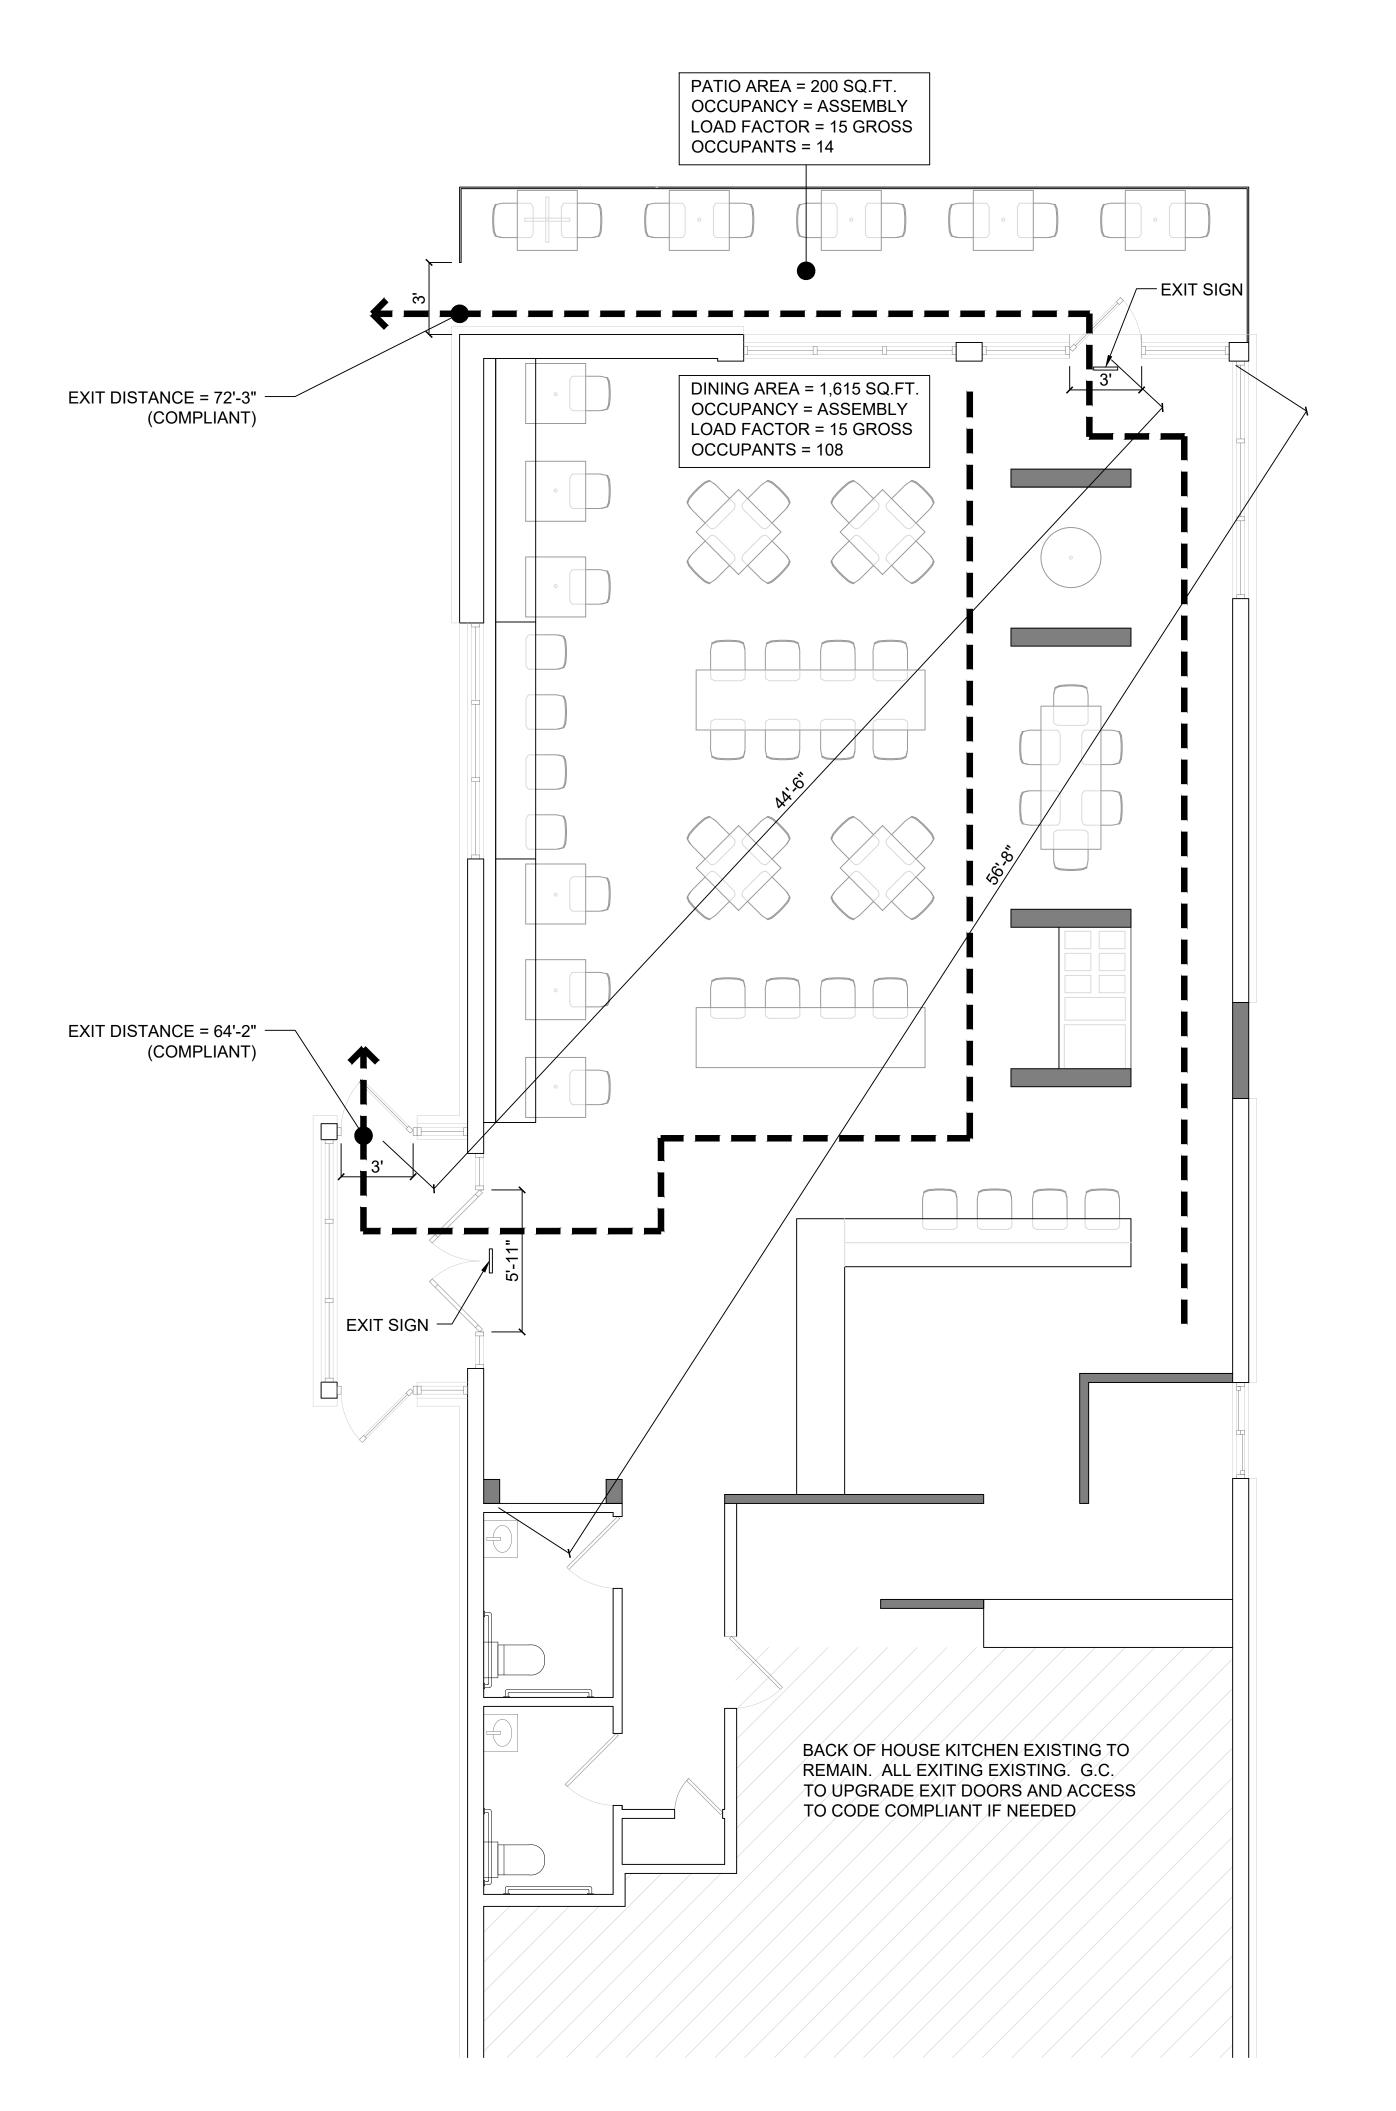
sheet title:

SITE PLAN

drawn by: job number:

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EXIT PATH OF TRAVEL

EXISTING WALLS

NOT IN SCOPE (BACK OF HOUSE)

NEW WALLS

NEW CONCRETE PATIO

OCCUPANT LOAD CALCULATION

DINING AREA = 1,615 SQ.FT. MINIMUM FLOOR AREA ALLOWANCE PER OCCUPANT = 15 GROSS (PER ASSEMBLY UNCONCENTRATED (TABLES AND CHAIRS ON TABLE 1004.1.2)

1,615 / 15 = 108 OCCUPANTS

PATIO AREA = 200 SQ.FT. MINIMUM FLOOR AREA ALLOWANCE PER OCCUPANT = 15 GROSS (PER ASSEMBLY UNCONCENTRATED (TABLES AND CHAIRS ON TABLE 1004.1.2)

200 / 15 = 14 OCCUPANTS

EXITING CALCULATION

EGRESS WIDTH PER PERSON SERVED = .2" PER OCCUPANT

0.2" X 108 OCCUPANTS = 21.6" EGRESS WIDTH REQUIRED TOTAL

EGRESS WIDTH PROVIDED = 34" CLR. AT EACH DOOR MIN.

NUMBER OF EXITS REQUIRED = 2

MAX DISTANCE BETWEEN EXITS = 56'-8" / 3 = 18'-11"

44'-6" SEPARATION PROVIDED > 18'-11" = COMPLIANT

GENERAL NOTES

DINING AREA EXIT DOORS EXISTING TO REMAIN. ALL EXITING EXISTING. G.C. TO UPGRADE EXIT DOORS AND ACCESS TO CODE COMPLIANT IF NEEDED

EXITING PLAN

CLIENT:

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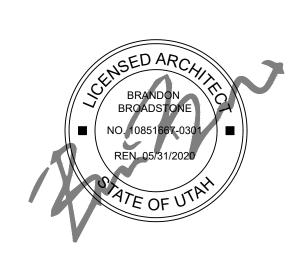
CONSULTANTS:

STRUCTURAL ENGINEERS

CONTRACTOR

PROJECT INFORMATION:

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EXITING PLAN

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<u>NOTES</u>

TO BE DEMOLISHED — — — — EXISTING WALLS

NOT IN SCOPE (BACK OF HOUSE)

- (1) REMOVE EXISTING WINDOW AND FRAME
- 2 REMOVE EXISTING PARTITION. PATCH FLOOR AS NEEDED
- REMOVE EXISTING COUNTER. PATCH FLOOR AS
- 4 REMOVE EXISTING CEILING THROUGH DINING AREA. CEILING IN BACK OF HOUSE TO REMAIN.
- 5 SCRAPE EXISTING CONCRETE FLOOR CLEAN. PREP FOR FINISH.
- 6 PATCH WALL AT DEMOLISHED PARTITION. PREP FOR FINISH.

GENERAL NOTES

- COMPLY WITH APPLICABLE LOCAL, STATE AND FEDERAL CODES AND REGULATIONS PERTAINING TO SAFETY OF PERSONS, PROPERTY AND ENVIRONMENTAL PROTECTION.
- 2. PROVIDE AND MAINTAIN BARRICADES, LIGHTING, AND GUARDRAILS AS REQUIRED BY APPLICABLE CODES AND REGULATIONS TO PROTECT OCCUPANTS OF BUILDING AND WORKERS.
- 3. ERECT AND MAINTAIN DUSTPROOF PARTITIONS AS REQUIRED TO PREVENT SPREAD OF DUST, FUMES, AND SMOKE, ETC. TO OTHER PARTS OF THE BUILDING. ON COMPLETION, REMOVE PARTITIONS AND REPAIR DAMAGED SURFACES TO MATCH ADJACENT SURFACES.
- 4. IF DEMOLITION IS PERFORMED IN EXCESS OF THAT REQUIRED, RESTORE EFFECTED AREAS AT NO COST TO THE OWNER.
- 5. REMOVE FROM SITE DAILY AND LEGALLY DISPOSE OF REFUSE, DEBRIS, RUBBISH, AND OTHER MATERIALS RESULTING FROM DEMOLITION OPERATIONS.
- 6. REMOVE DESIGNATED PARTITIONS, COMPONENTS, BUILDING EQUIPMENT, AND FIXTURES AS REQUIRED FOR NEW WORK.
- REMOVE EXISTING FLOOR FINISHES AND PREPARE SUBFLOOR AS REQUIRED FOR NEW FLOOR FINISHES.

DEMOLITION PLAN

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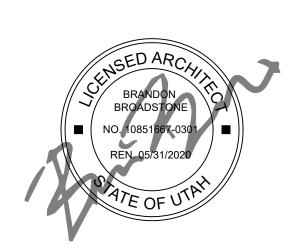
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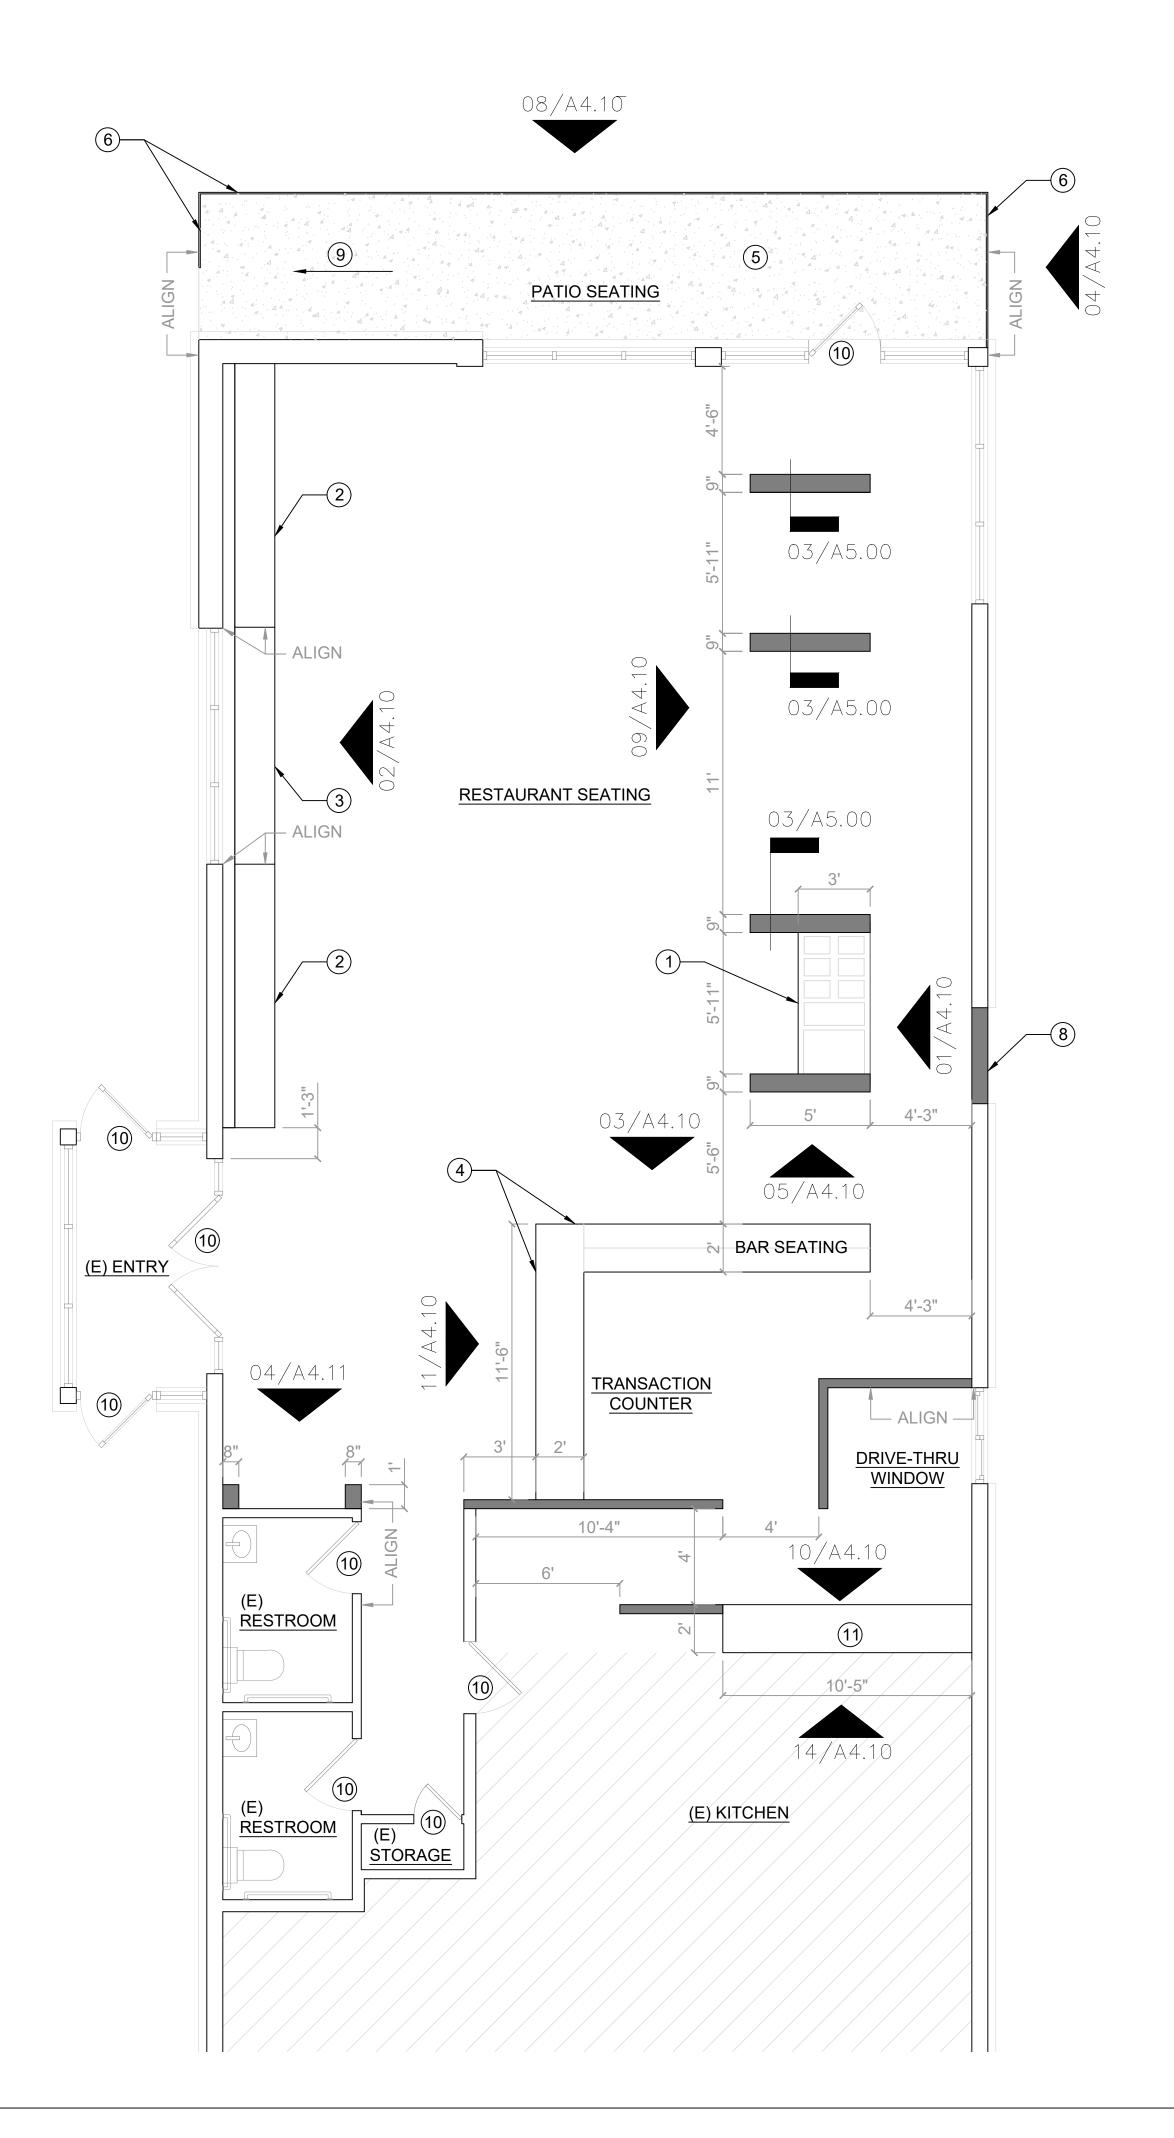
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DEMOLITION PLAN

review set

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LEGEND:	
OBJECTS ABOVE	
EXISTING WALLS	
NEW WALLS (PARTITION TAG)	1
NOT IN SCOPE (BACK OF HOUSE)	
NEW CONCRETE PATIO	A A A A A A A A A A A A A A A A A A A

<u>NOTES</u>

- (1) NEW MILLWORK SALSA BAR.
- 2 NEW MILLWORK BANQUETTE.
- (3) NEW MILLWORK COUNTER
- 4 NEW MILLWORK COUNTER, BAR AND TRANSACTION COUNTER.
- 5 NEW CONCRETE PATIO. G.C. TO PROVIDE NEW SLAB AS REQUIRED. COORDINATE WITH EDGE OF EXISTING SIDEWALK.
- (6) NEW METAL GUARDRAIL.
- (7) NEW SERVICE COUNTER AND MILLWORK.
- 8 NEW INFILL WALL AT DEMOLISHED WINDOW. MATCH EXISTING ADJACENT CONSTRUCTION.
- 9 SLOPE NEW CONCRETE PAD TO ADJACENT SIDEWALK. MAX SLOPE 1:20.
- 10 EXISTING DOOR TO REMAIN.
- (11) NEW SERVICE COUNTER.

GENERAL NOTES

GC TO COORDINATE WITH OWNER FOR CUT OUTS NEEDED FOR SALSA BAR CONTAINERS AND LOCATION. PROVIDE HEATING/COOLING?

GC TO REPAIR EXISTING DOOR/FRAME/HARDWARE AS NEEDED.

REPAIR DRIVE THRU WINDOW TO LIKE-NEW CONDITION AS REQUIRED.

CONSTRUCTION PLAN

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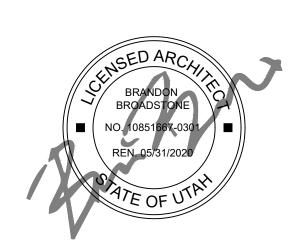
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CONSTRUCTION PLAN

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EXISTING WALLS NEW WALLS NOT IN SCOPE (BACK OF HOUSE) **DUPLEX OUTLET +** QUAD OUTLET DEDICATED CIRCUIT **GROUND FAULT** GFI

INTERRUPTION OUTLET

<u>NOTES</u>

DATA PORT

- PROVIDE GROMMET AS NEEDED IN COUNTERTOP FOR POWER/DATA AT POS SYSTEMS. COORDINATE WITH OWNER FOR EXACT LOCATION.
- GC TO CONFIRM ELECTRICAL REQUIREMENTS FOR SALSA BAR HEATING AND COOLING.
- GC TO CONFIRM DATA AND POWER NEEDS FOR OWNER POS STATIONS.

GENERAL NOTES

 FURNITURE SHOWN FOR ILLUSTRATION PURPOSES ONLY. OWNER TO COORDINATE WITH GC FOR FINAL LOCATION

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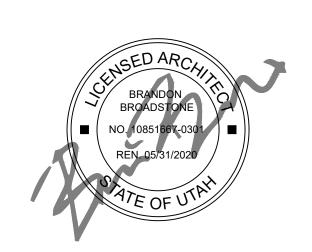
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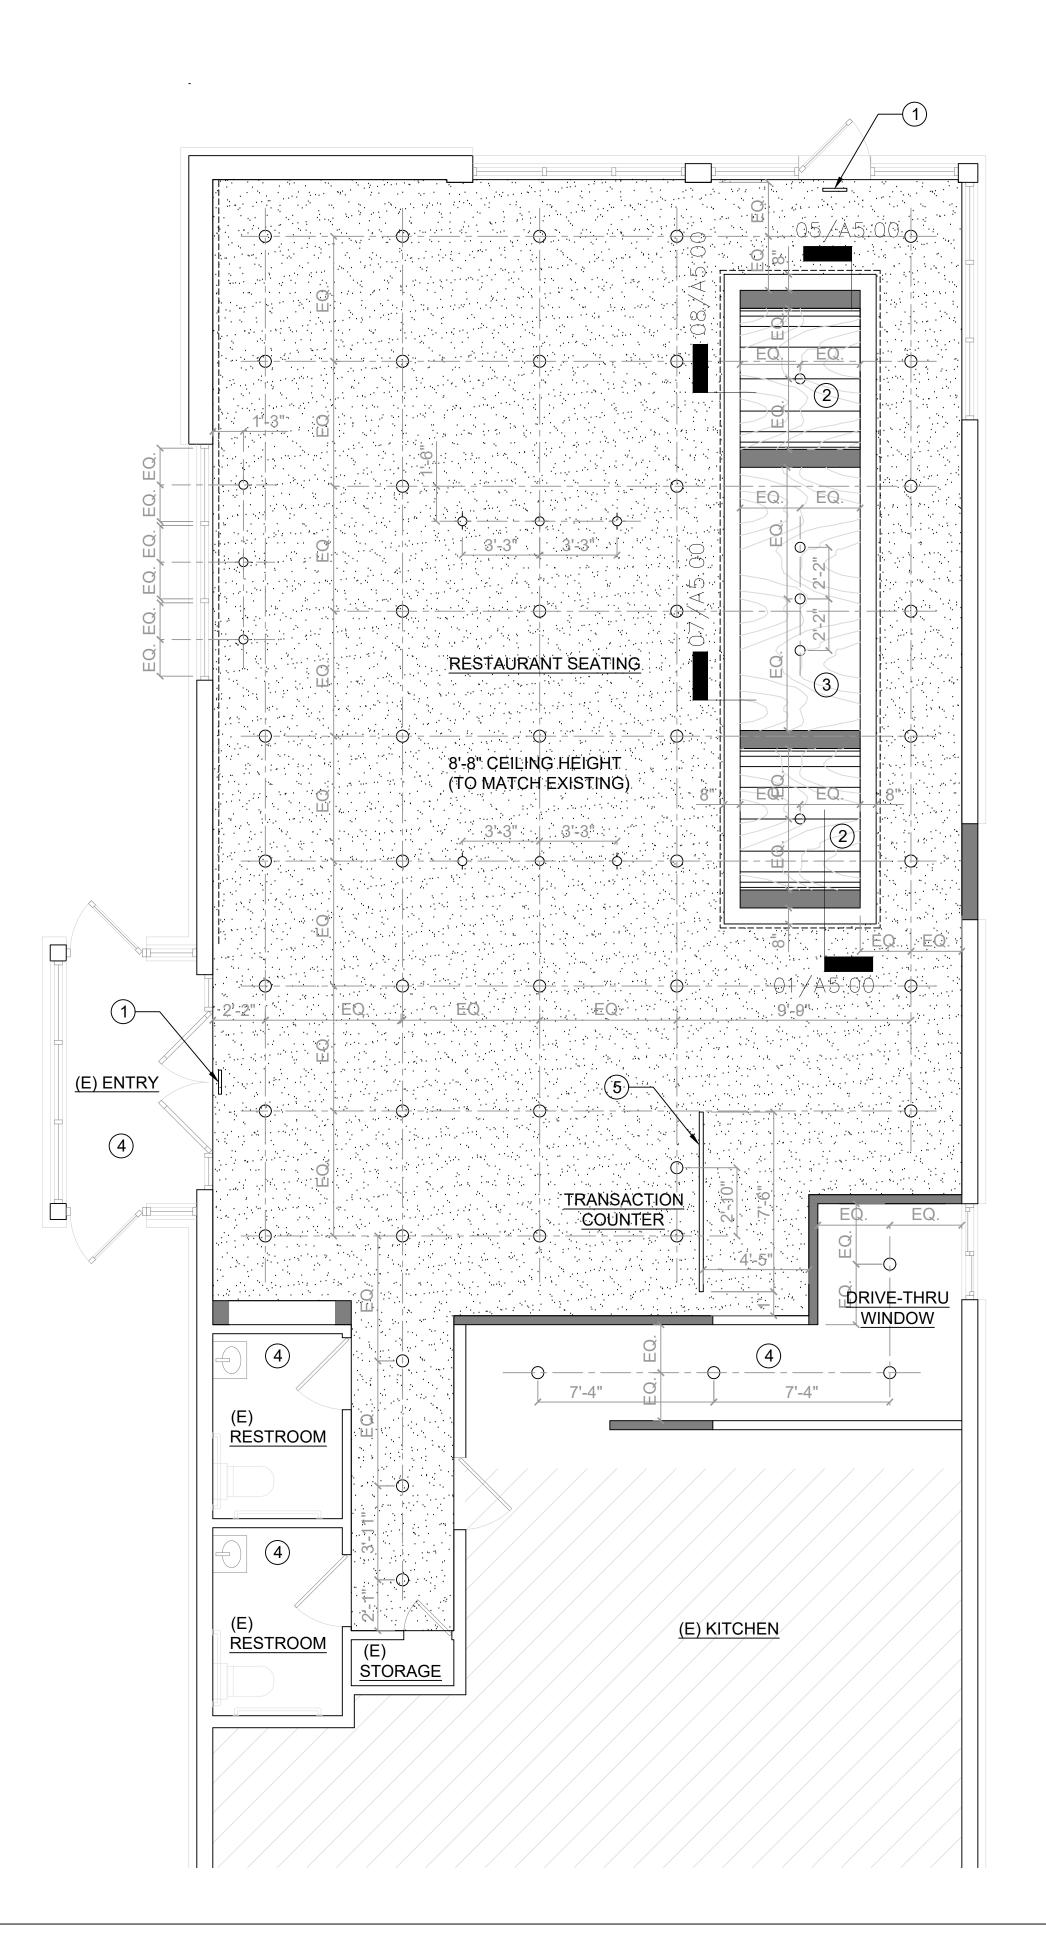
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POWER AND COMMUNICATION **PLAN**

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A1.60

POWER AND COMMUNICATION PLAN



EXISTING WALLS

NEW WALLS

NOT IN SCOPE (BACK OF HOUSE)

6" SURFACE MOUNTED DOWNLIGHT

PENDANT FIXTURE

HARDLID CEILING (PAINTED)

PLYWOOD CEILING

 \circ

NOTES

- (1) CEILING MOUNTED EXIT SIGN.
- ARCHED PLYWOOD OPENING. SEE ELEVATION AND DETAILS.
- PLYWOOD OPENING. SEE ELEVATIONS AND DETAILS.
- EXISTING CEILING TO REMAIN. REPAIR AS NEEDED.
- PLYWOOD MENU BOARD ATTACHED TO CEILING.

GENERAL NOTES

- ALL NEW FIXTURES TO BE LED ON DIMABLE SWITCH.
- 2. GC TO COORDINATE SWITCH LOCATION WITH OWNER.

REFLECTED CEILING PLAN

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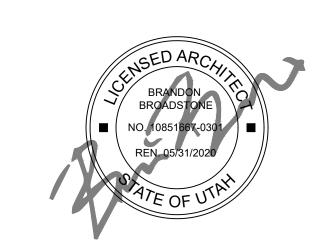
CONSULTANTS:

STRUCTURAL ENGINEERS

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REFLECTED **CEILING PLAN**

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PT-4 PATIO SEATING PLY-1 PT-5 B-1 $\langle T-1 \rangle$ PLY-1 PT-1 B-1 PLY-1 PT-1 PLY-1 PT-5 B-1 PLY-1 PT-1 B-1 PLY-1 PT-1 B-1 (CNC-1) FLOORING THROUGHOUT DINING PLY-1 PT-1 PLY-1 PT-5 B-1 RESTAURANT SEATING PLY-1 PT-1 B-1 PLY-1 PT-1 B-1 PT-2 B-2 PAINT AND BASE THROUGHOUT PLY-1 PT-1 PLY-1 PT-5 B-1 U.O.N __(SS-2_) PLY-1 PT-1 B-1 (PT-3) CEILING PAINT AT DRYWALL PLY-1 PT-5 B-1 PLY-1 PT-1 B-1 BAR SEATING (E) ENTRY SS-1 T-2 TRANSACTION PLY-1 PT-1 COUNTER DRIVE-THRU WINDOW T-2 RÉSTROOM (SS-2) (E)
RESTROOM (E) KITCHEN STORAGE

LEGEND:

EXISTING WALLS

NEW WALLS

NOT IN SCOPE (BACK OF HOUSE)

<u>NOTES</u>

INFILL WINDOW OPENING TO MATCH EXISTING ADJACENT FINISH.

GENERAL NOTES

- 1. ENSURE SURFACES TO RECEIVE FINISHES ARE CLEAN, TRUE, AND FREE OF IRREGULARITIES. DO NOT PROCEED WITH WORK UNTIL UNSATISFACTORY CONDITIONS HAVE BEEN CORRECTED.
- REPAIR EXISTING SURFACES TO REMAIN AS REQUIRED FOR APPLICATION OF NEW FINISHES.
- 3. EXISTING WINDOW FRAMES TO REMAIN. CLEAN AND REPAIR AS NEEDED.

EINIGH SCHEDHI E

FINISH SCHEDULE				
SYMBOL	DESCRIPTION	MANUF.	SPEC	NOTES
PLY-1	3/4" PLYWOOD	N/A	N/A	
PT-1	PLYWOOD SEALER			
PT-2	WALL PAINT			EGGSHELL FINISH
PT-3	CEILING PAINT	TBD	TBD	MATTE FINISH
PT-4	EXTERIOR PAINT	TBD	TBD	
PT-5	PLYWOOD STAIN	TBD	TBD	
SS-1	SOLID SURFACE	TBD	TBD	
SS-2	STAINLESS COUNTER	TBD	TBD	
B-1	PLYWOOD BASE	TBD	TBD	4' HIGH
B-2	RUBBER BASE	TBD	TBD	4" HIGH
CNC-1	CONCRETE FLOOR	N/A	N/A	MATTE FINISH
T-1	WALL TILE	TBD	TBD	FULL HEIGHT
T-2	WALL TILE	TBD	TBD	FULL HEIGHT

FINISH PLAN
1/4"=1'-0"

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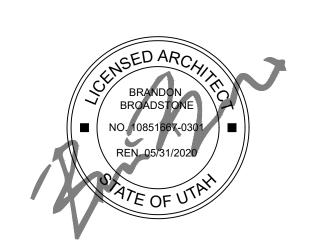
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STRUCTURAL ENGINEERS

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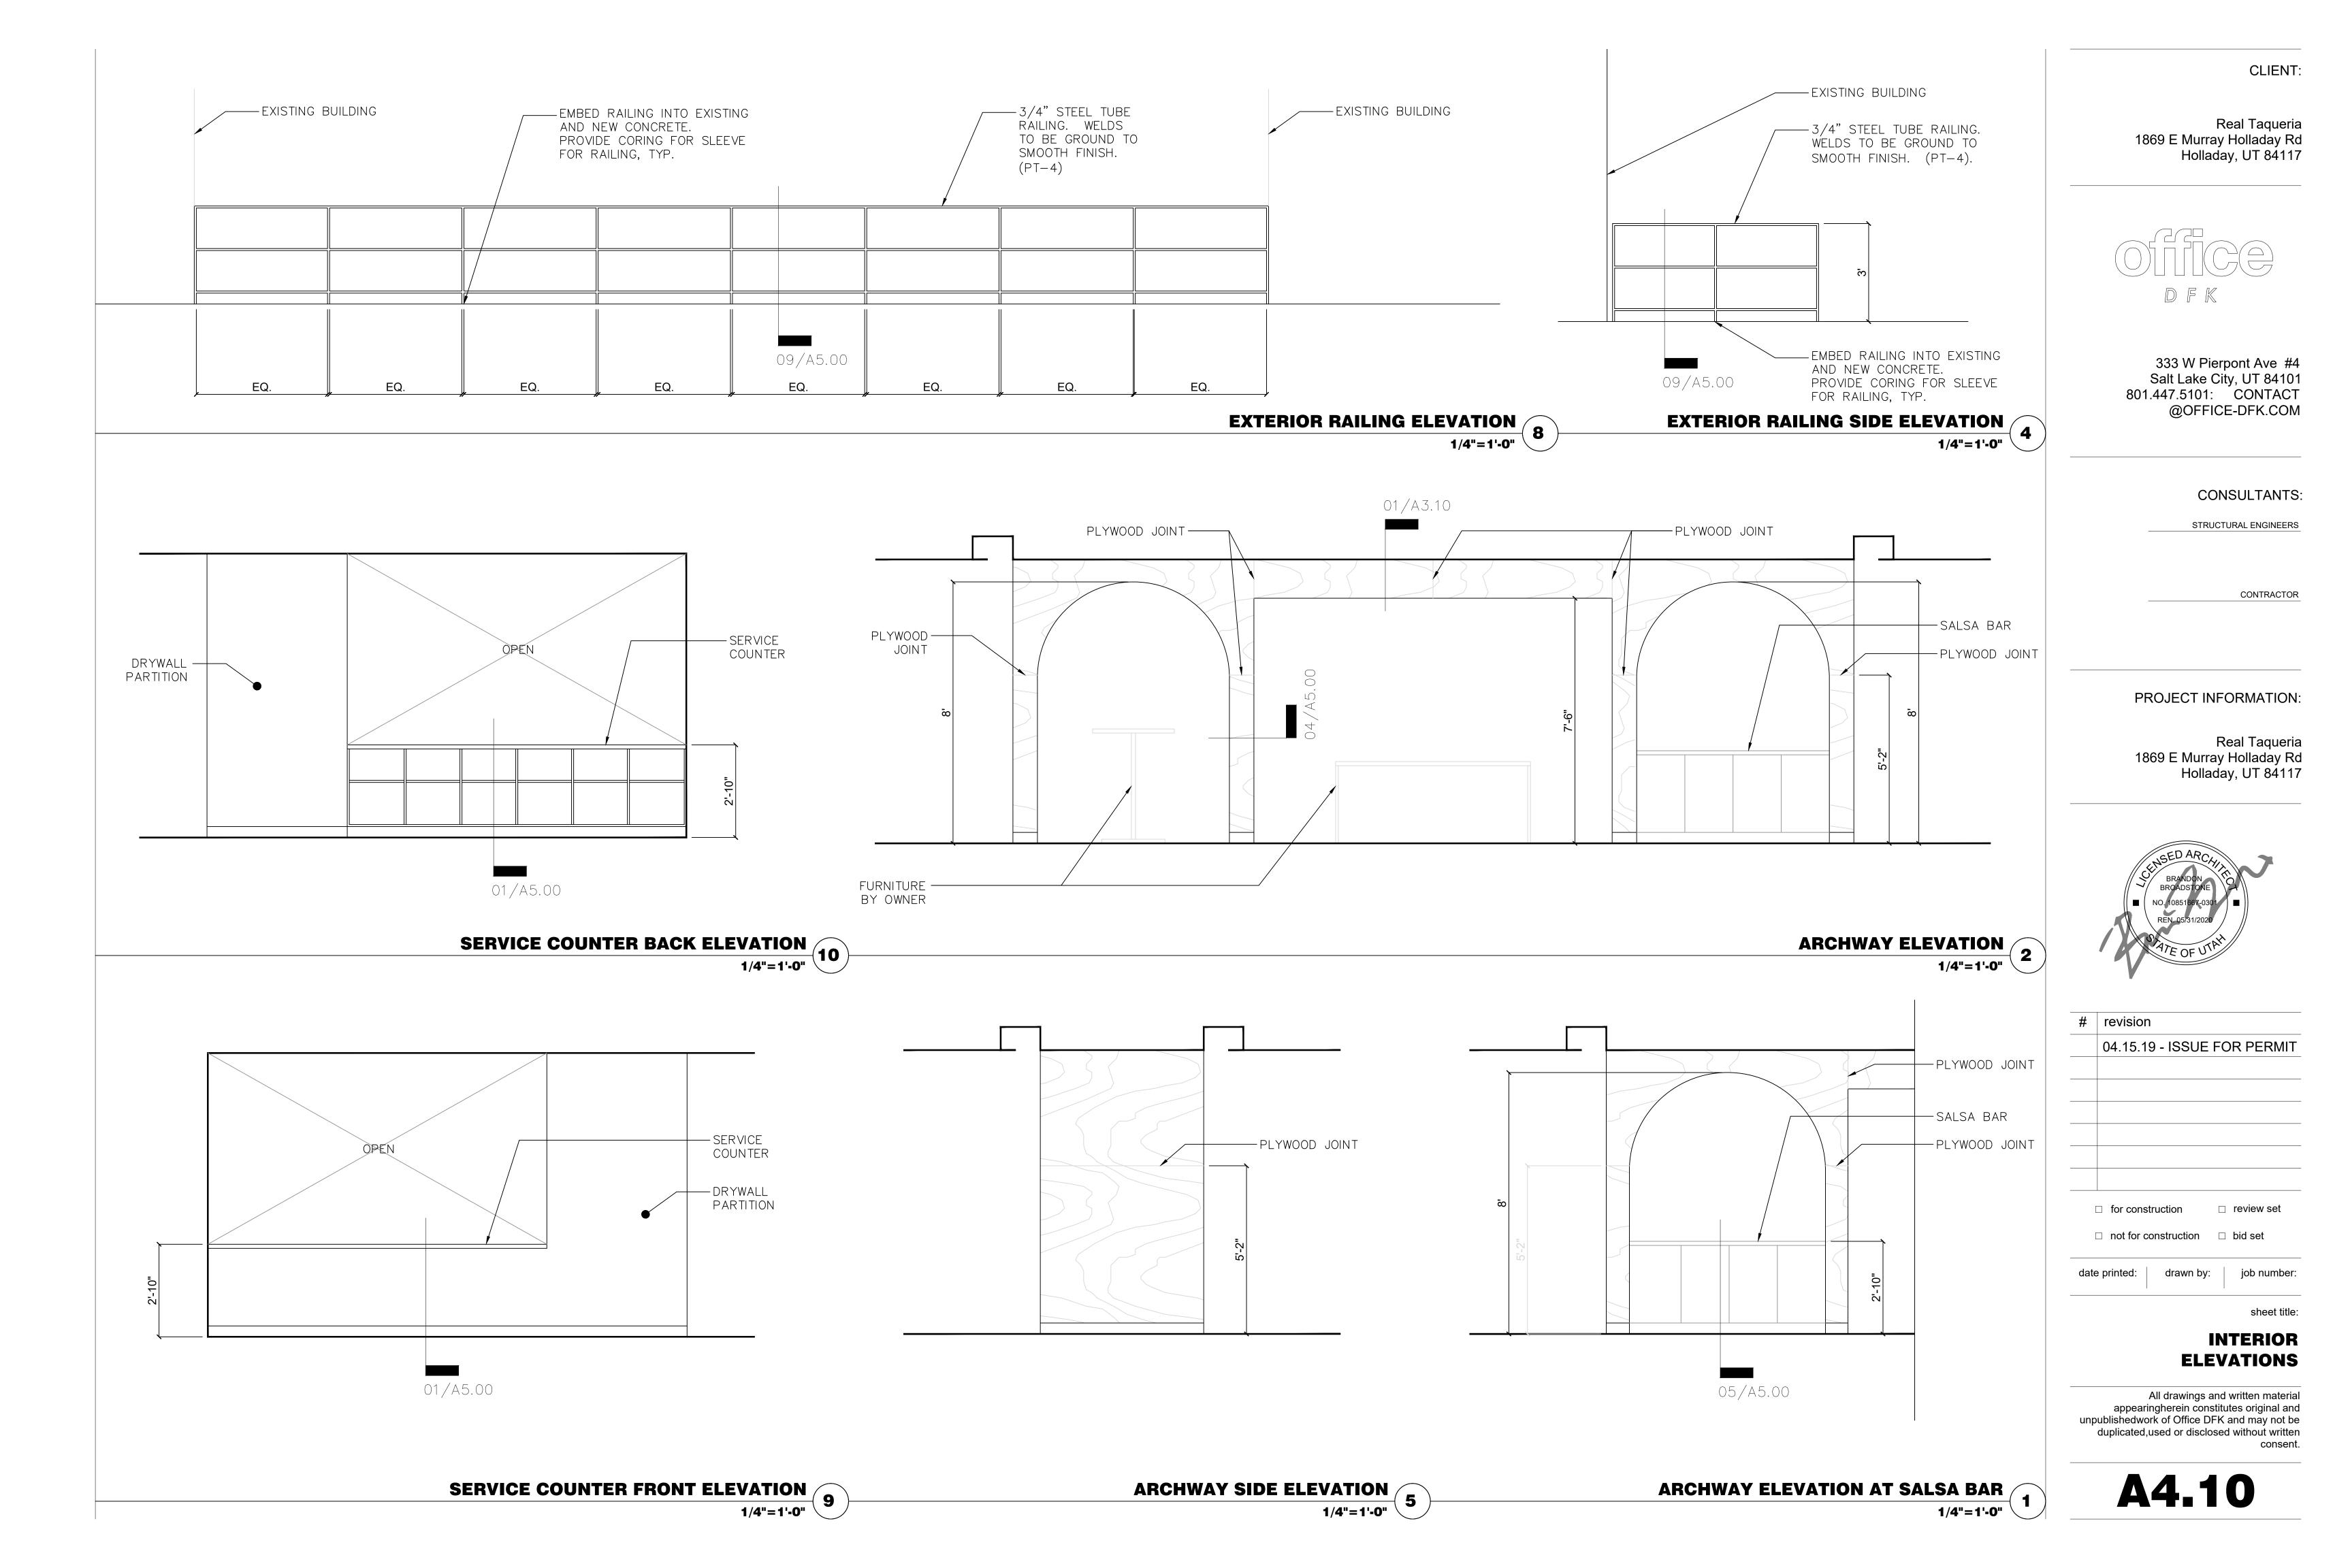
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FINISH PLAN

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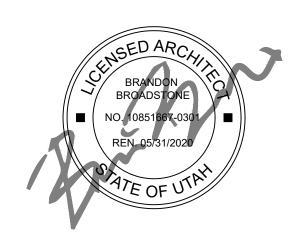
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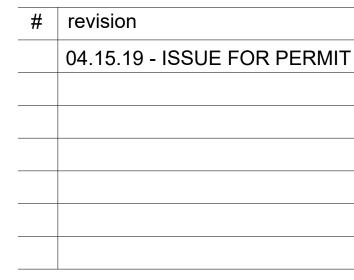
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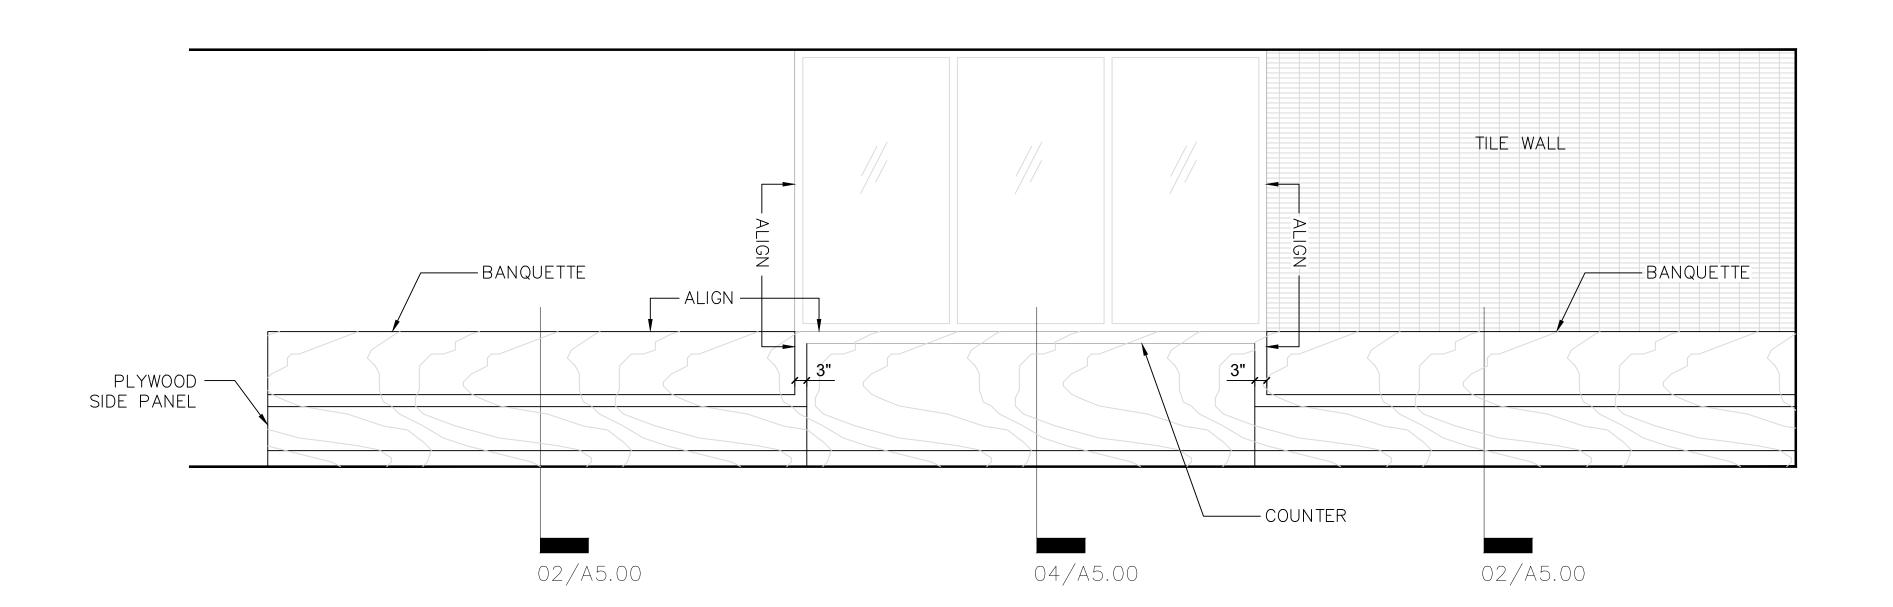
INTERIOR ELEVATIONS

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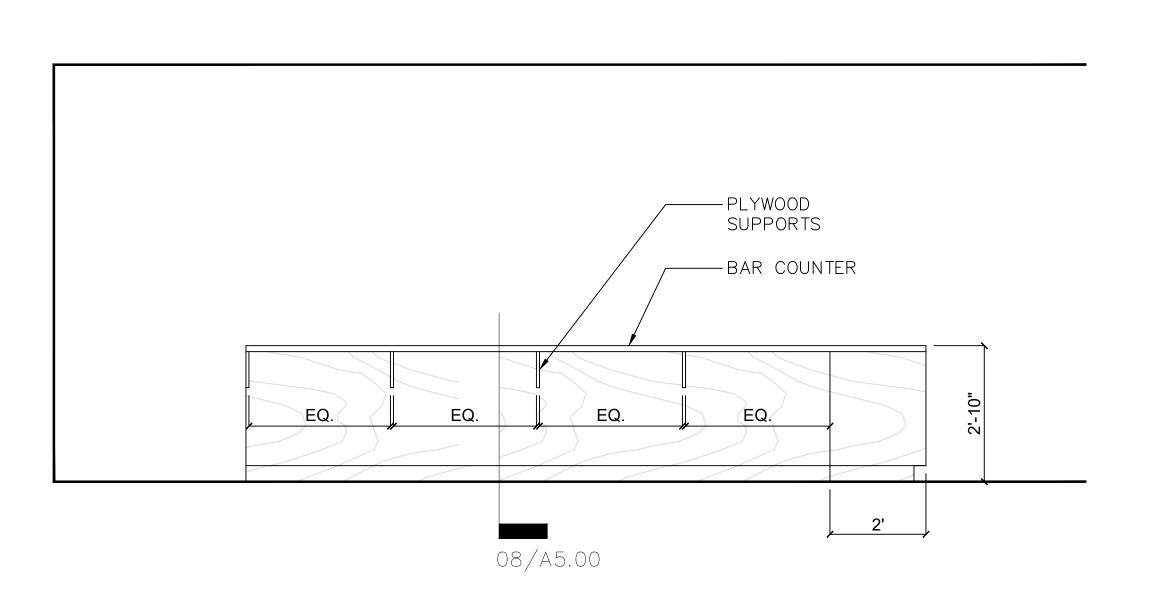
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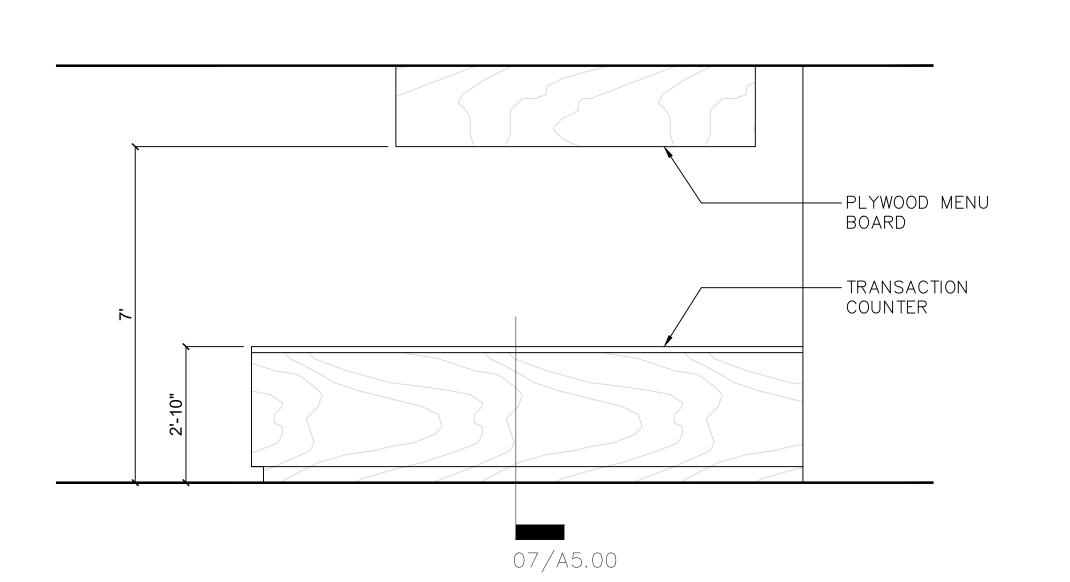
---PLYWOOD JOINT — FIXED PLYWOOD SHELVING

SHELVING ELEVATION 1/4"=1'-0" 4



BANQUETTE ELEVATION 1/4"=1'-0" 2





BAR ELEVATION 1 1/4"=1'-0"

TRANSACTION COUNTER ELEVATION
1/4"=1'-0"
9

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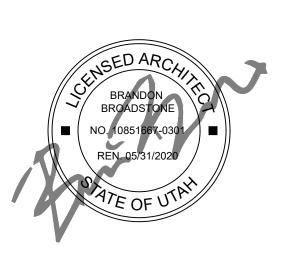
CONSULTANTS:


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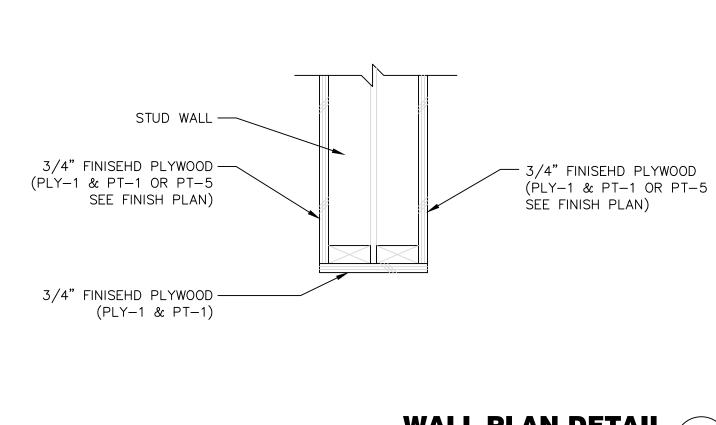


sheet title: **PARTITION SCHEDULE AND DETAILS**

job number:


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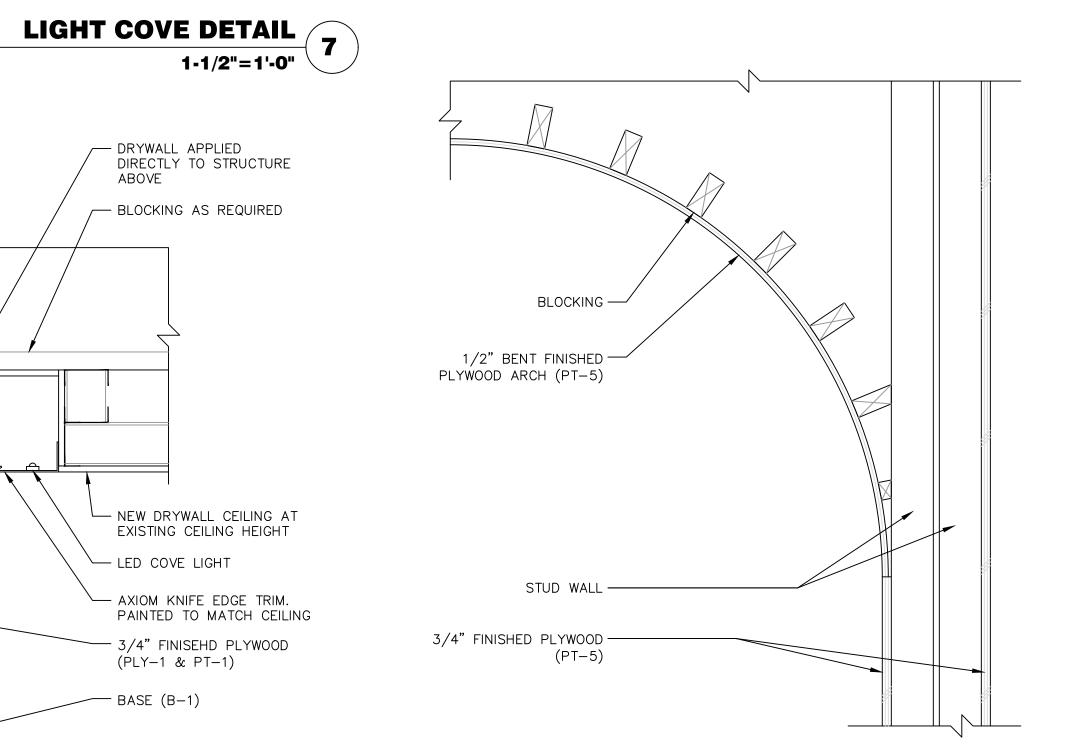
WALL PLAN DETAIL

1-1/2"=1'-0"

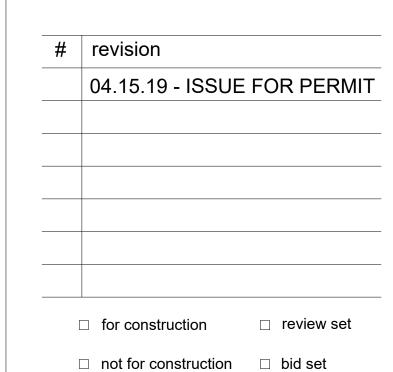


ARCHWAY WALL SECTION DETAIL

1-1/2"=1'-0"

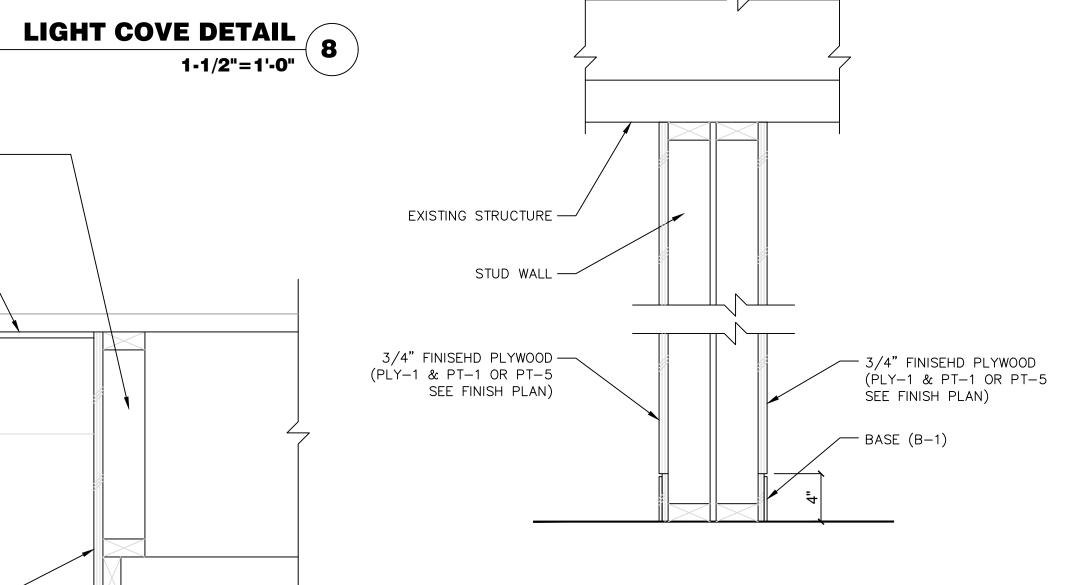

ARCHWAY DETAIL 1-1/2"=1'-0"

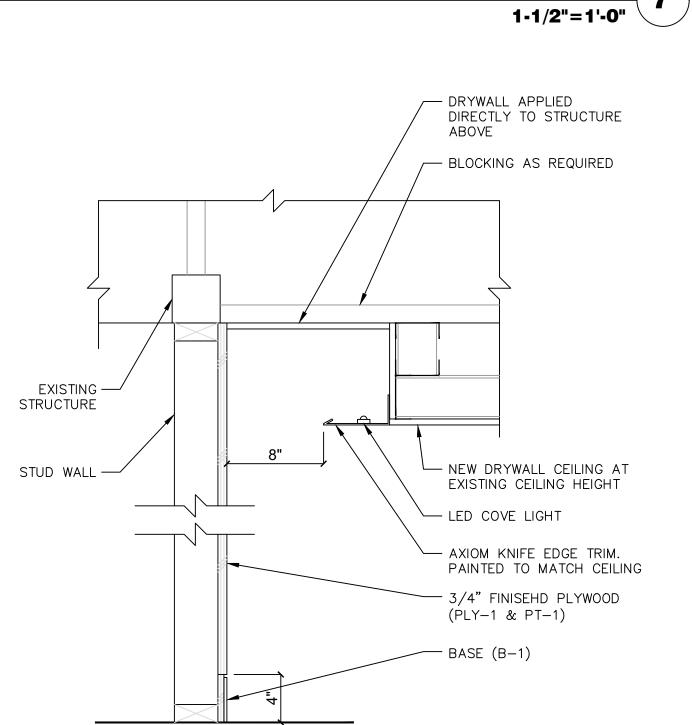

LIGHT COVE DETAIL

1-1/2"=1'-0"

FRAMED SOFFIT ----

DRYWALL APPLIED ---

DIRECTLY TO STRUCTURE
ABOVE

BLOCKING AS REQUIRED —

NEW DRYWALL CEILING AT — EXISTING CEILING HEIGHT

AXIOM KNIFE EDGE TRIM. —— PAINTED TO MATCH CEILING

3/4" FINISEHD PLYWOOD — (PLY-1 & PT-1)

1/2" BENT FINISHED — PLYWOOD ARCH (PT-5)

DIRECTLY TO STRUCTURE

BLOCKING AS REQUIRED —

NEW DRYWALL CEILING AT — EXISTING CEILING HEIGHT

3/4" FINISEHD PLYWOOD —

3/4" FINISEHD PLYWOOD -(PLY-1 & PT-5 SEE)

(PLY-1 & PT-1)

LED COVE LIGHT —

LED COVE LIGHT -

FRAMED SOFFIT -

DRYWALL APPLIED ----

3/4" STEEL TUBE RAILING. — WELDS TO BE GROUND TO SMOOTH FINISH. (PT-4)

PATIO RAILING DETAIL

3"=1'-0" 9

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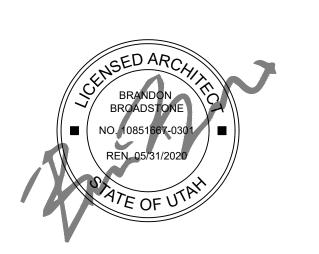
CONSULTANTS:


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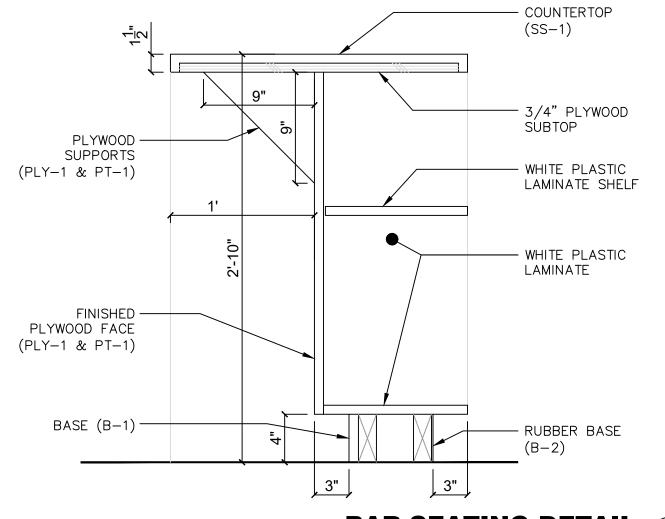
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job number:

CABINETRY DETAILS


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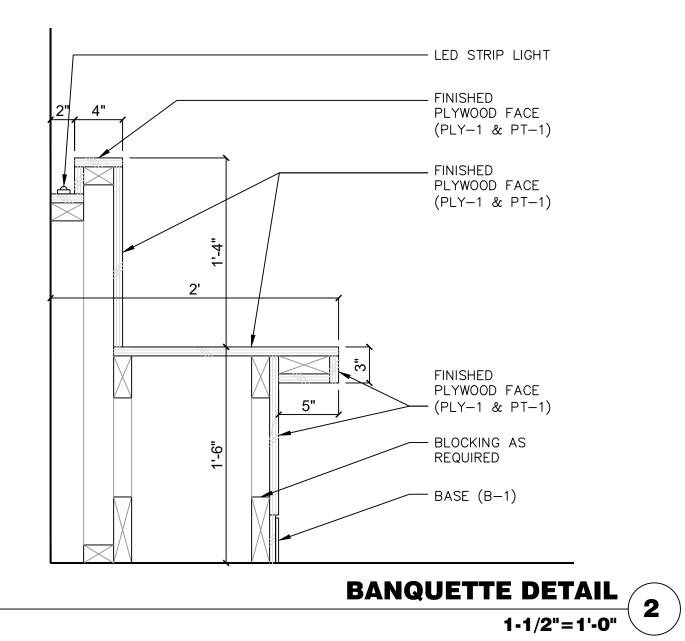
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BAR SEATING DETAIL

1-1/2"=1'-0"



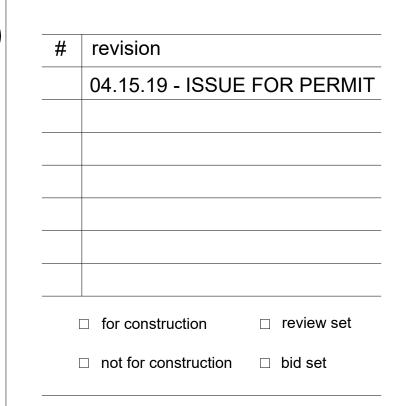

- LED STRIP LIGHT

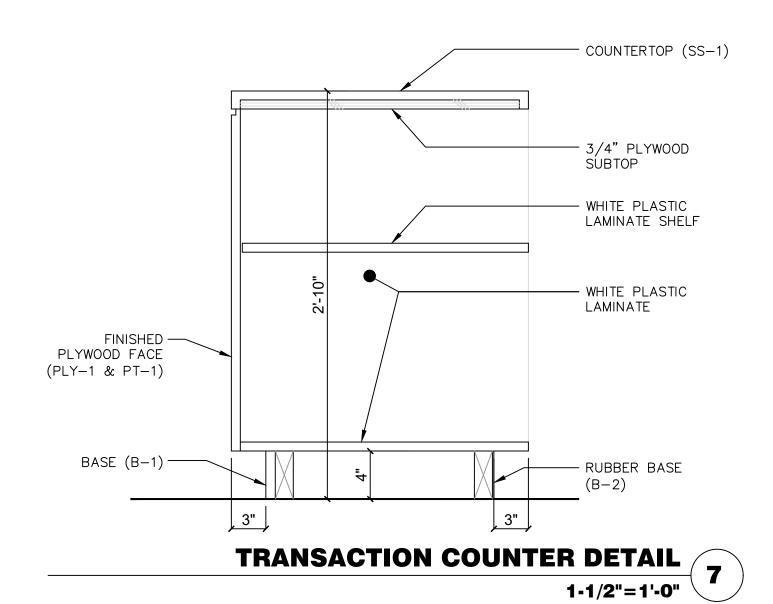
— FINISHED PLYWOOD FACE (PLY-1 & PT-1)


— FINISHED PLYWOOD FACE (PLY-1 & PT-1)

— FINISHED PLYWOOD FACE (PLY-1 & PT-1)

1-1/2"=1'-0" 4

— BASE (B−1)

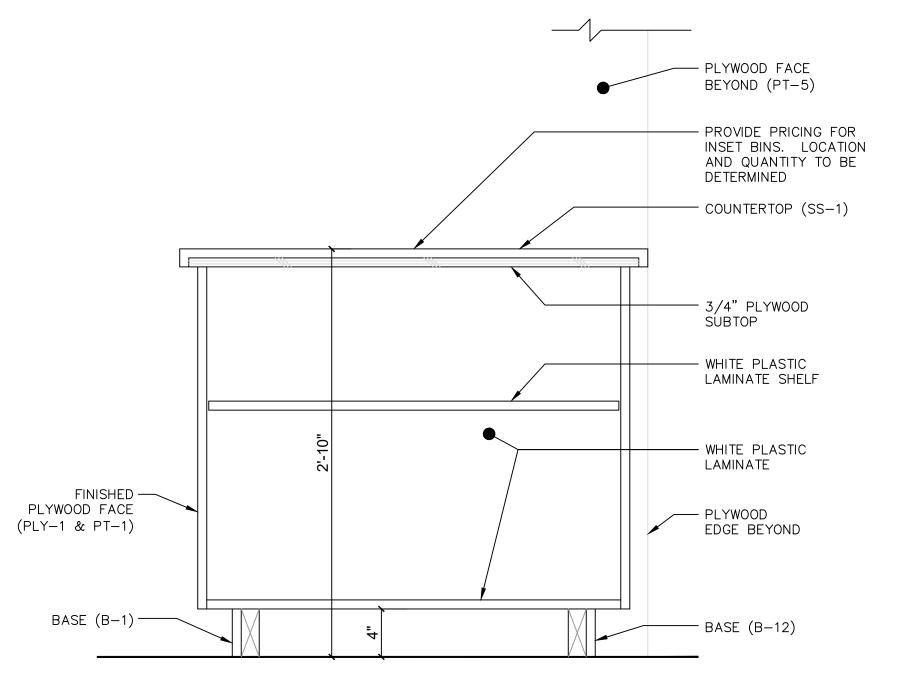

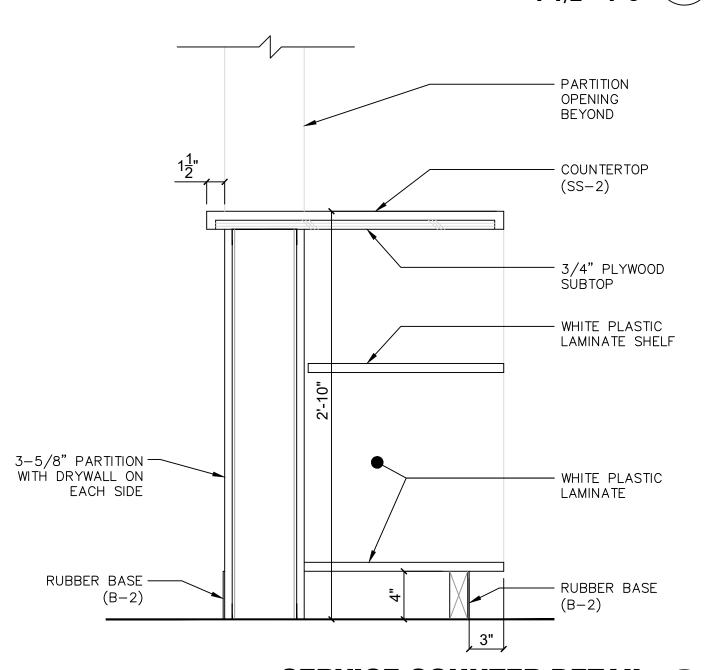

SERVICE COUNTER DETAIL 1-1/2"=1'-0" 1-1/2"=1'-0"

SALSA BAR DETAIL