

OCCUPANT LOAD TABLE:

MAXIMUN FLOOR AREA ALLOWANCES (IBC Table 1004.5)

OCCUPANCY FUNCTION OF SPACE AREA (sf) ACCESSORY FACTOR OCCUPANTS
B OFFICE 5165 N 150 34.43333333

SUB TOTAL: 34.43333333

TOTAL: 35

PLUMBING FIXTURE REQUIREMENTS (IBC TABLE 2902.1): WATER CLOSETS LAVATORIES WATER WATER LAVATORIES LAVATORIES DRINKING OCCUPANCY OCCUPANTS Male (1:40) | Female (1:40) | REQUIRED* | FOUNTAINS CLOSETS... CLOSETS... PROVIDED Male (1:25) Female (1:25) 1 per 100 0.4375 0.875 0.4375 SUB TOTALS: 1.4 SUB TOTALS: 0.875 TOTALS: TOTALS:

* NOTE: MINIMUM 1 SERVICE SINK IS REQUIRED; MINIMUM ONE WATER CLOSET AND ONE LAVATORY FOR EACH MEN'S AND WOMEN'S.

ROCKY MOUNTAIN Dermatology

TENANT IMPROVEMENT 5748 South Adams Avenue Washington Terrace, Utah

	DRAWING INDEX	
G100	CODE REVIEW & LIFE SAFETY	
D101	DEMOLITION PLAN	
MD101	MECHANICAL DEMOLITION PLAN	
ED101	ELECTRICAL DEMOLITION PLAN	
A001	ARCHITECTURAL NOTES	
A101	FLOOR PLAN	
A102	REFLECTED CEILING PLAN	
A401	INTERIOR ELEVATIONS	
A402	INTERIOR ELEVATIONS	
A501	DETAILS & WALL TYPES	
A601	DOOR SCHEDULE & DETAILS	
P001	PLUMBING SCHEDULES	
P101	WASTE AND VENT PLAN	
P102	PLUMBING PLAN	
P501	PLUMBING DETAILS	
M001	MECHANICAL SCHEDULES	
M101	MECHANICAL PLAN	
M501	MECHANICAL DETAILS	
E001	ELECTRICAL LEGEND	
EL101	ELECTRICAL LIGHTING PLAN	
EP101	ELECTRICAL POWER PLAN	
EP501	ELECTRICAL DETAILS	
EP601	ELECTRICAL SCHEDULES & DIAGRAMS	
EP701	ELECTRICAL PANEL SCHEDULES	


Reviewed for Compliance

Tyler D. Seaman

Building Official

THE CITY OF

12/11/2020 Washington Terrace

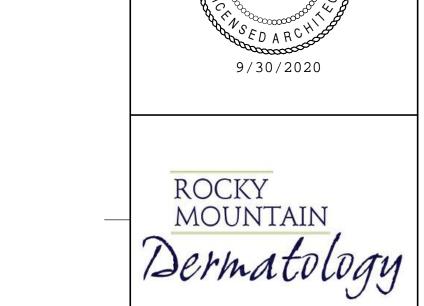

STAMP

Tenant Improvement

ARCHITECTS

ENGINEERS

Case, Lowe & Hart, Inc. • 2484 Washington Blvd

801.399.5821 • www.clhae.com

Suite 510 • Ogden, Utah • 84401

CONSULTANT

5748 South Adams Avenue Washington Terrace, Utah

MARK DATE DESCRIPTION

ISSUE DATE:	1/1/202X
PROJECT NO:	20330
CAD DWG FILE:	
DRAWN BY:	Author
CHK'D BY:	Checker

Project Status
01 January 202X

SHEET TITLE

CODE REVIEW & LIFE SAFETY


SHEET NO:


G100


LAVATORIES DRINKING

A4 EGRESS PLAN

1/8" = 1'-0"

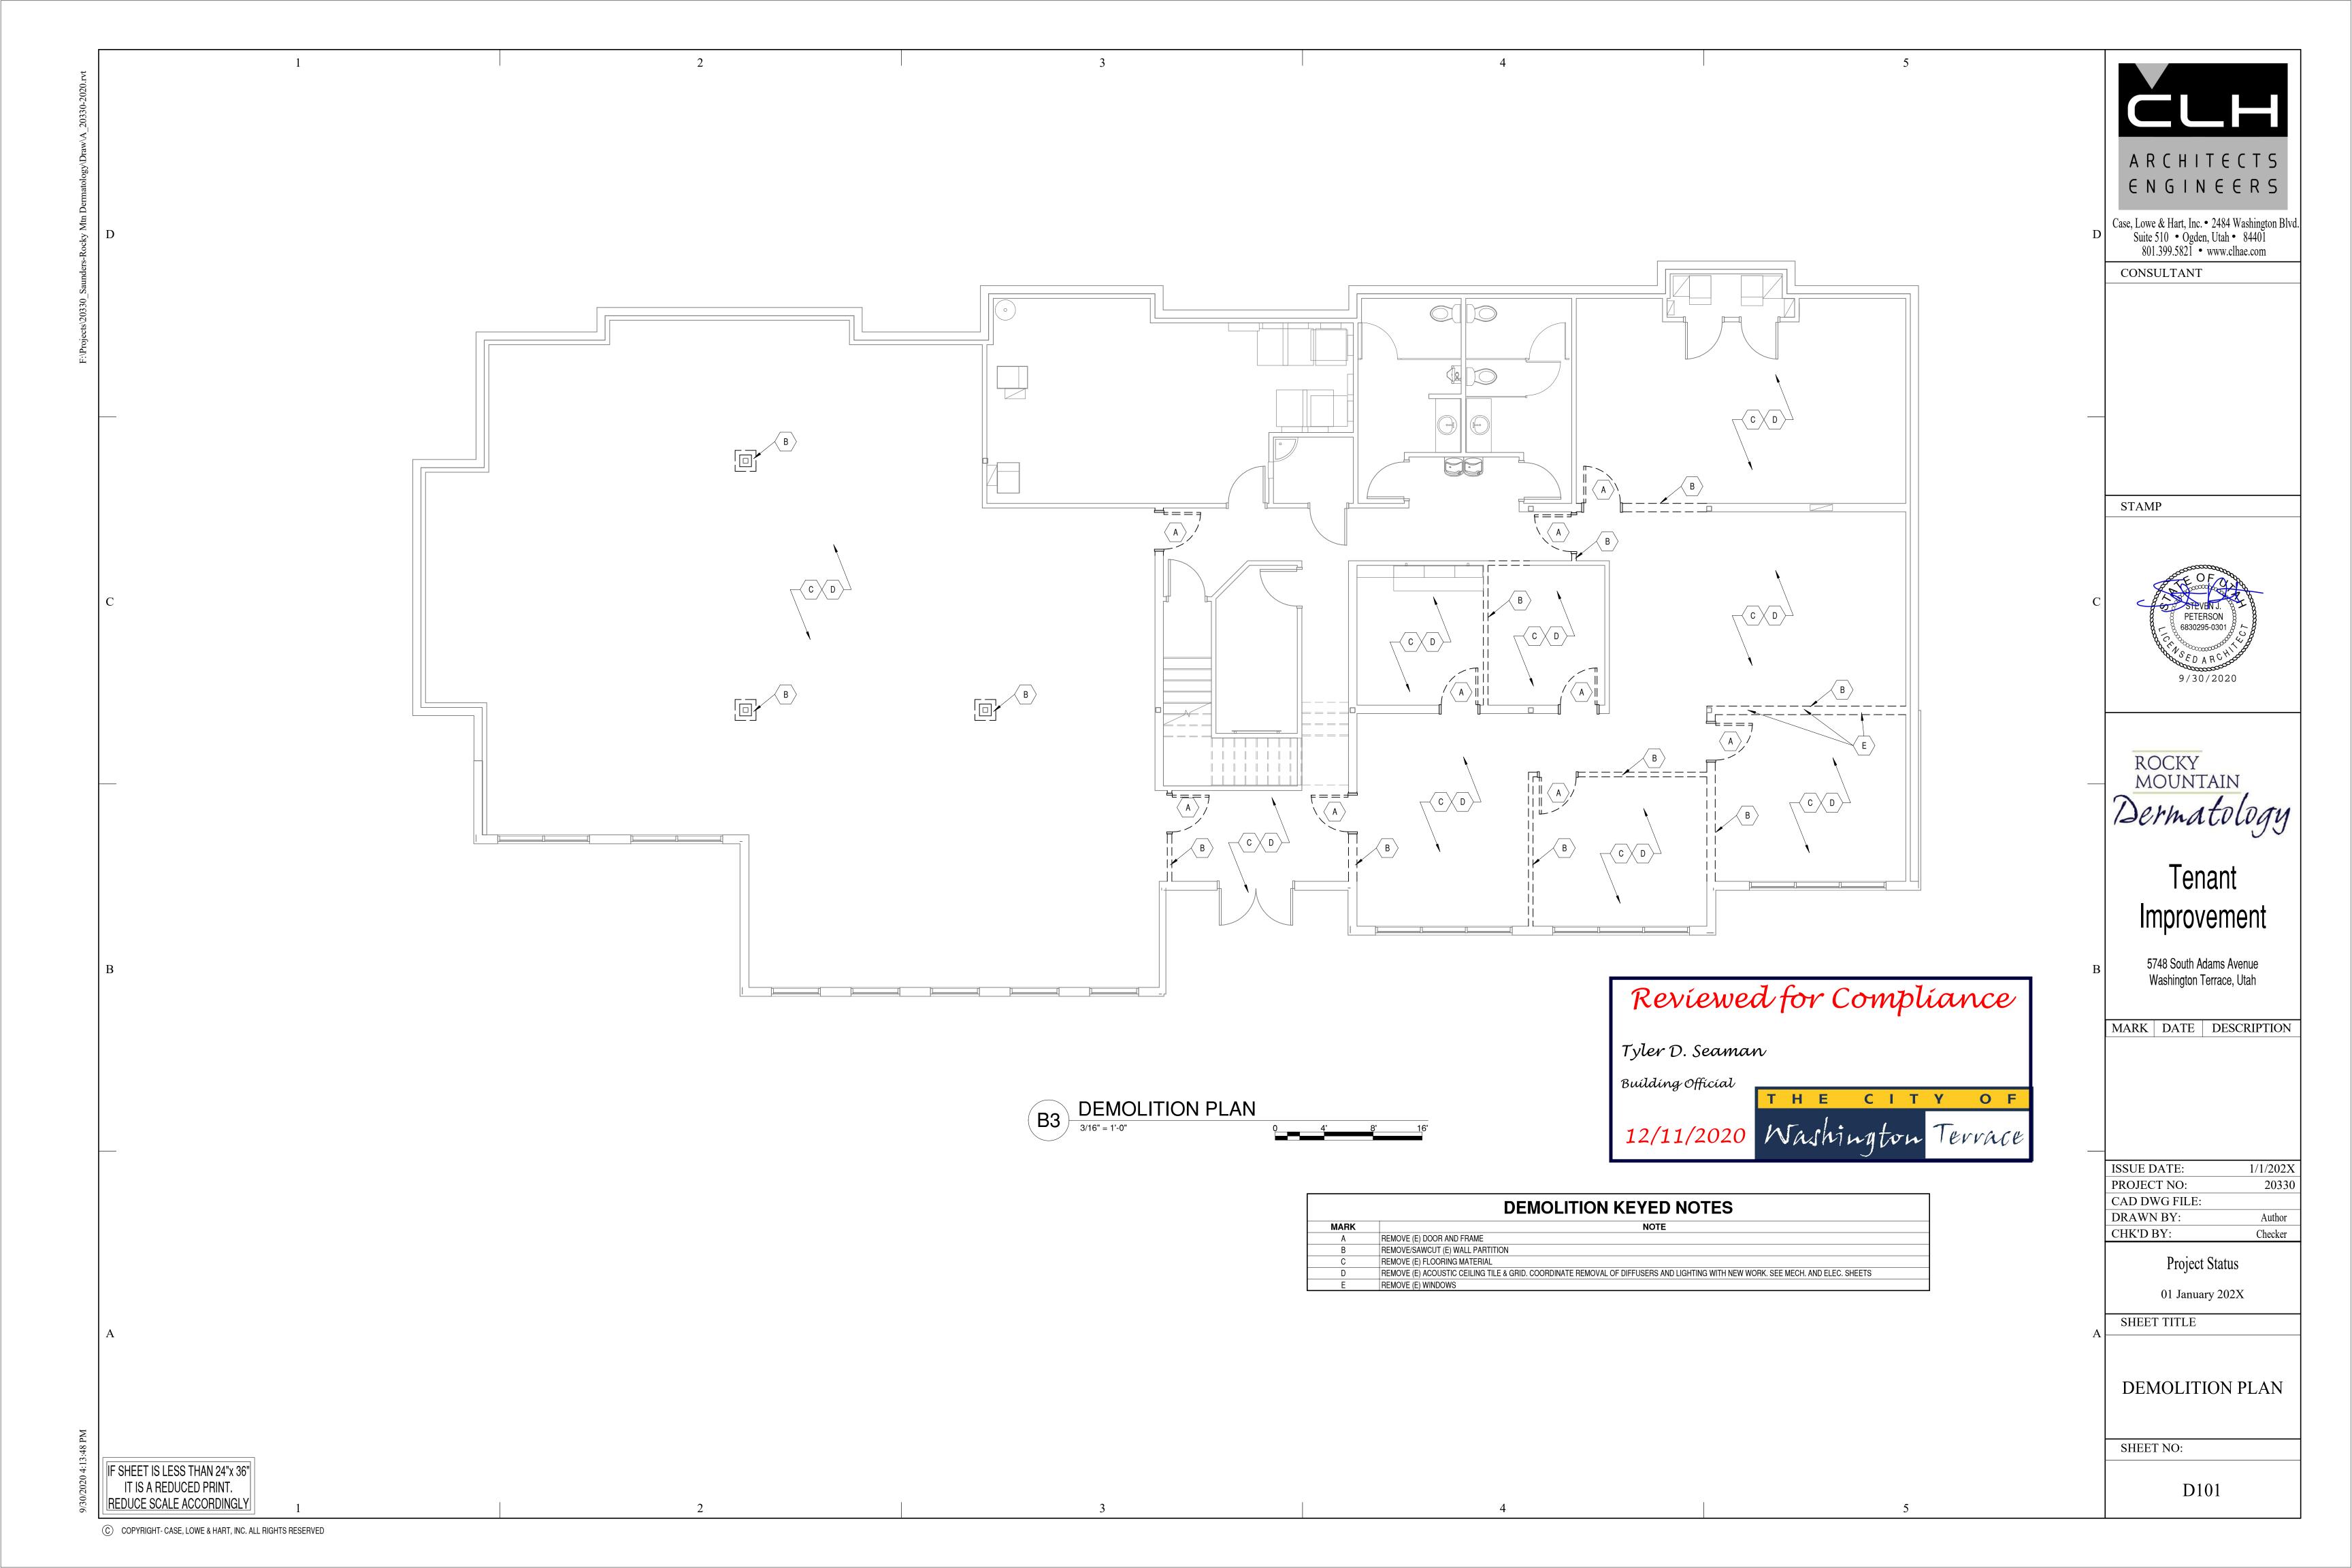

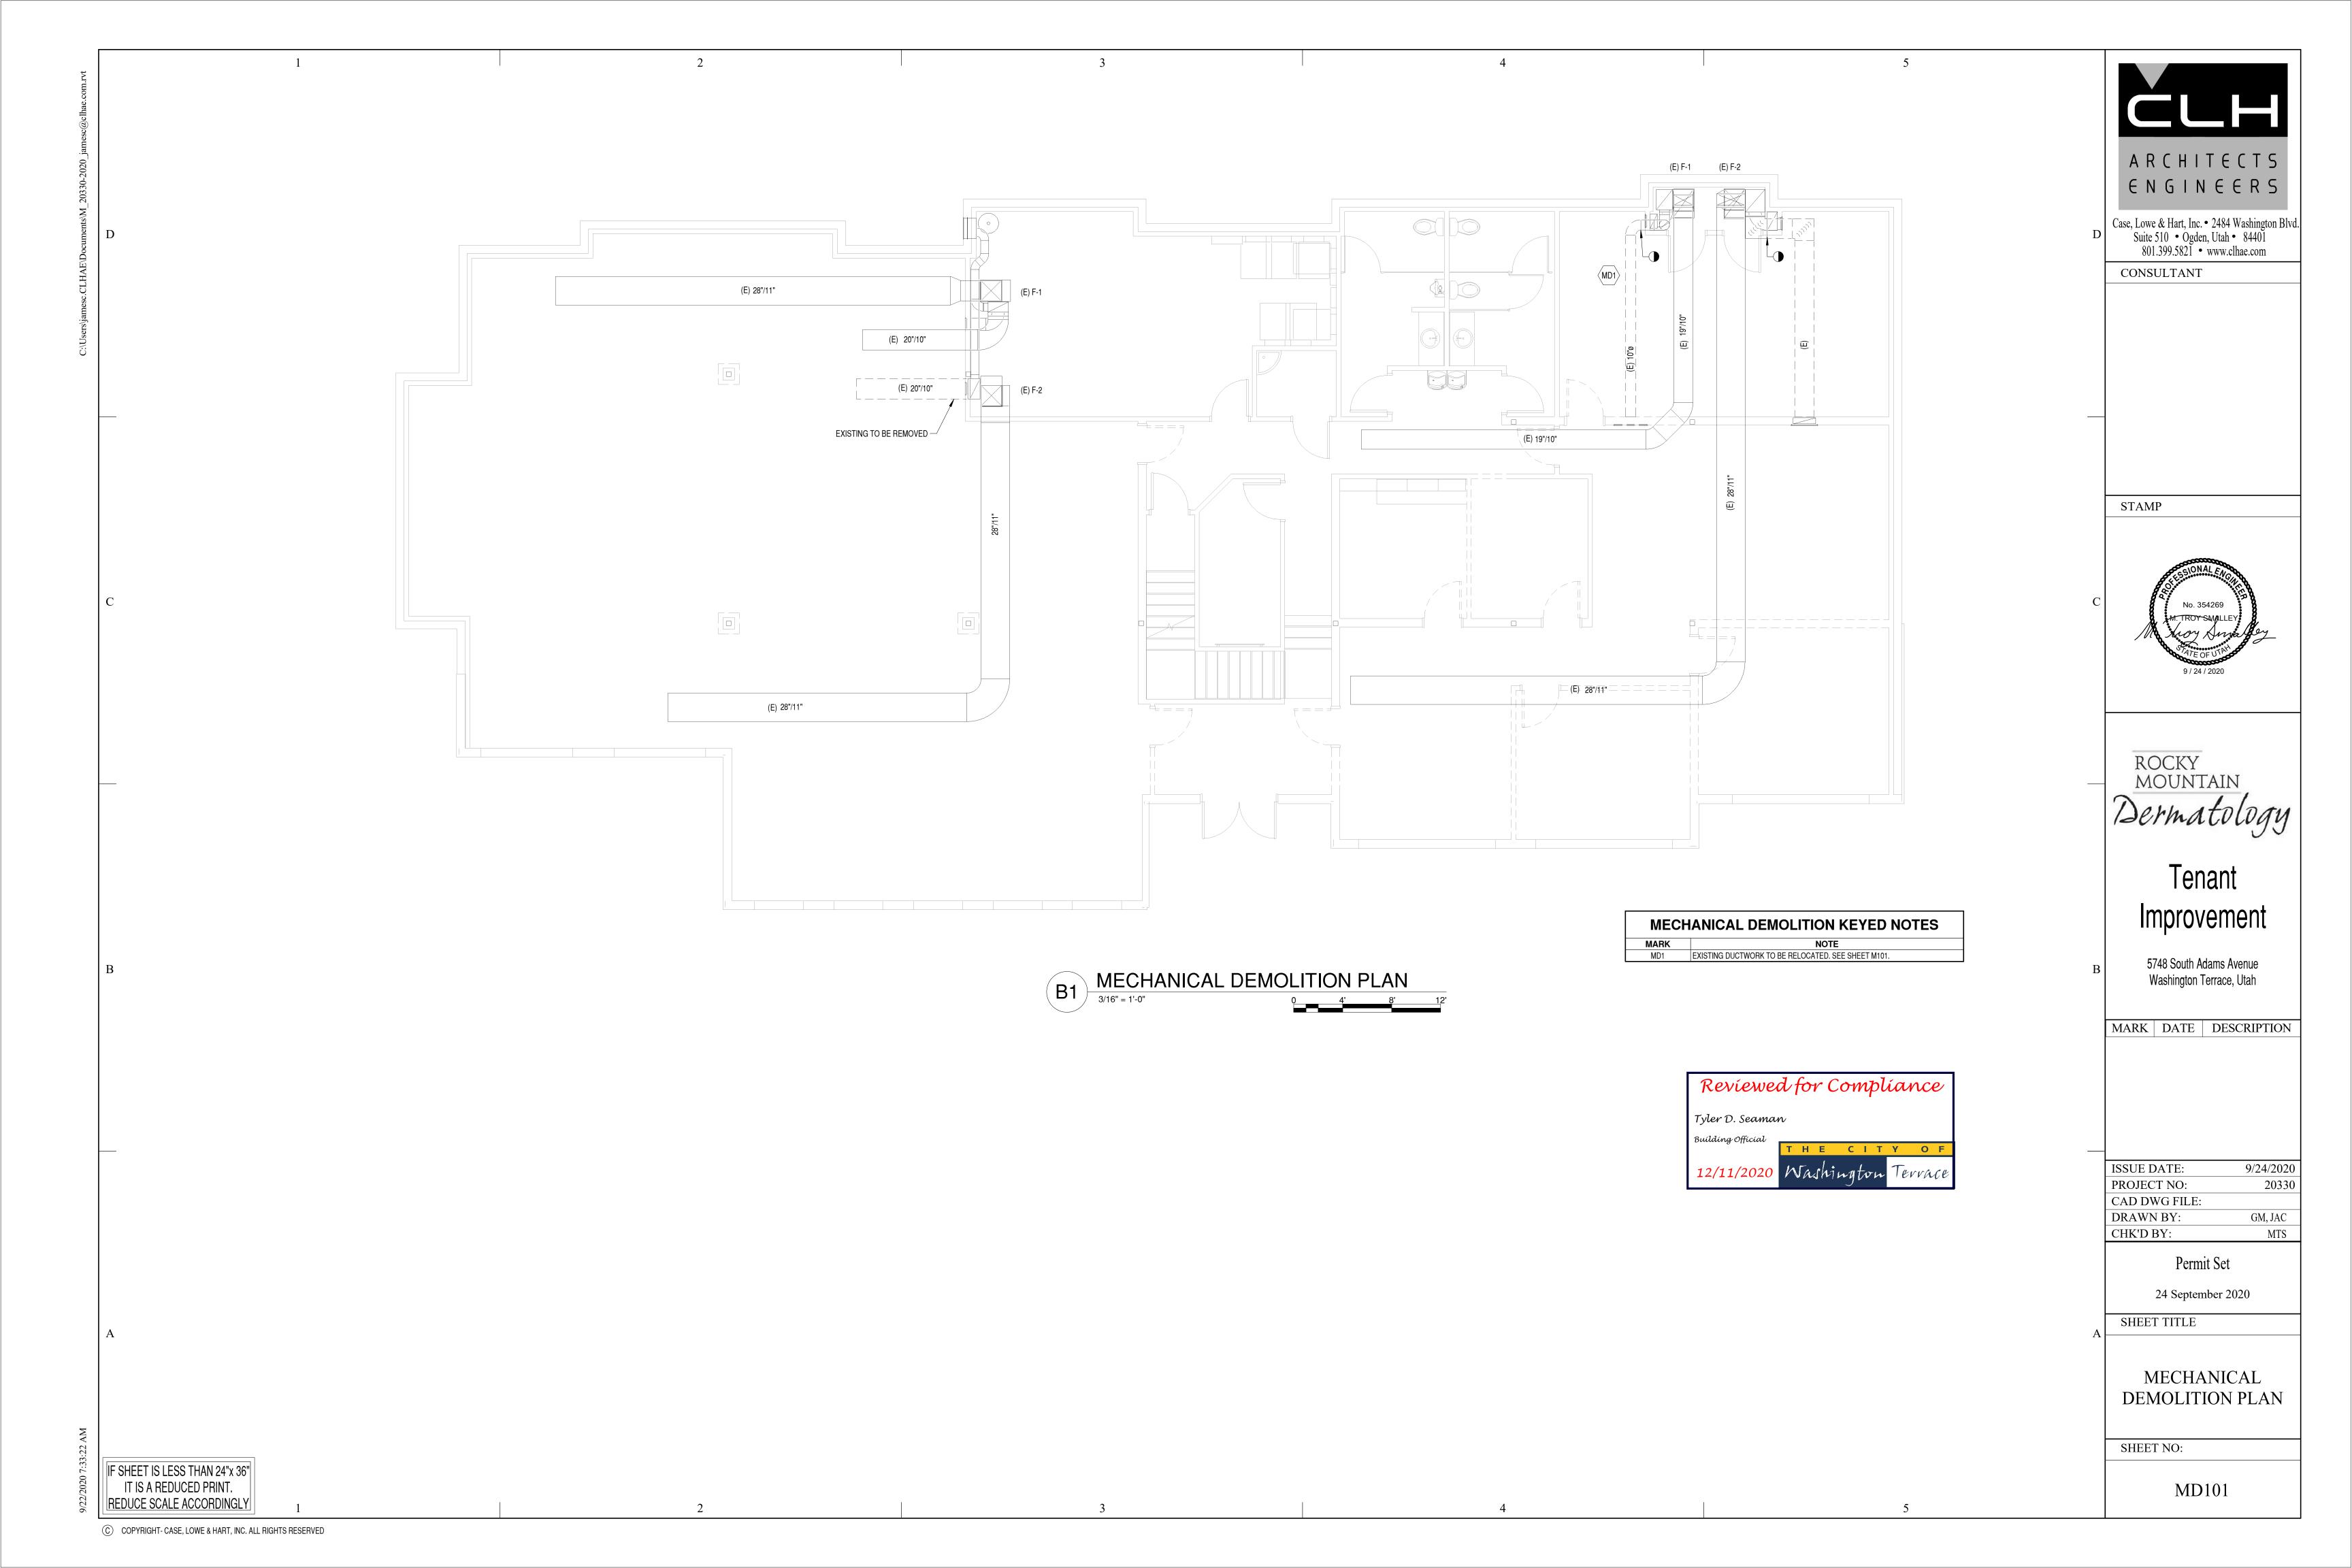


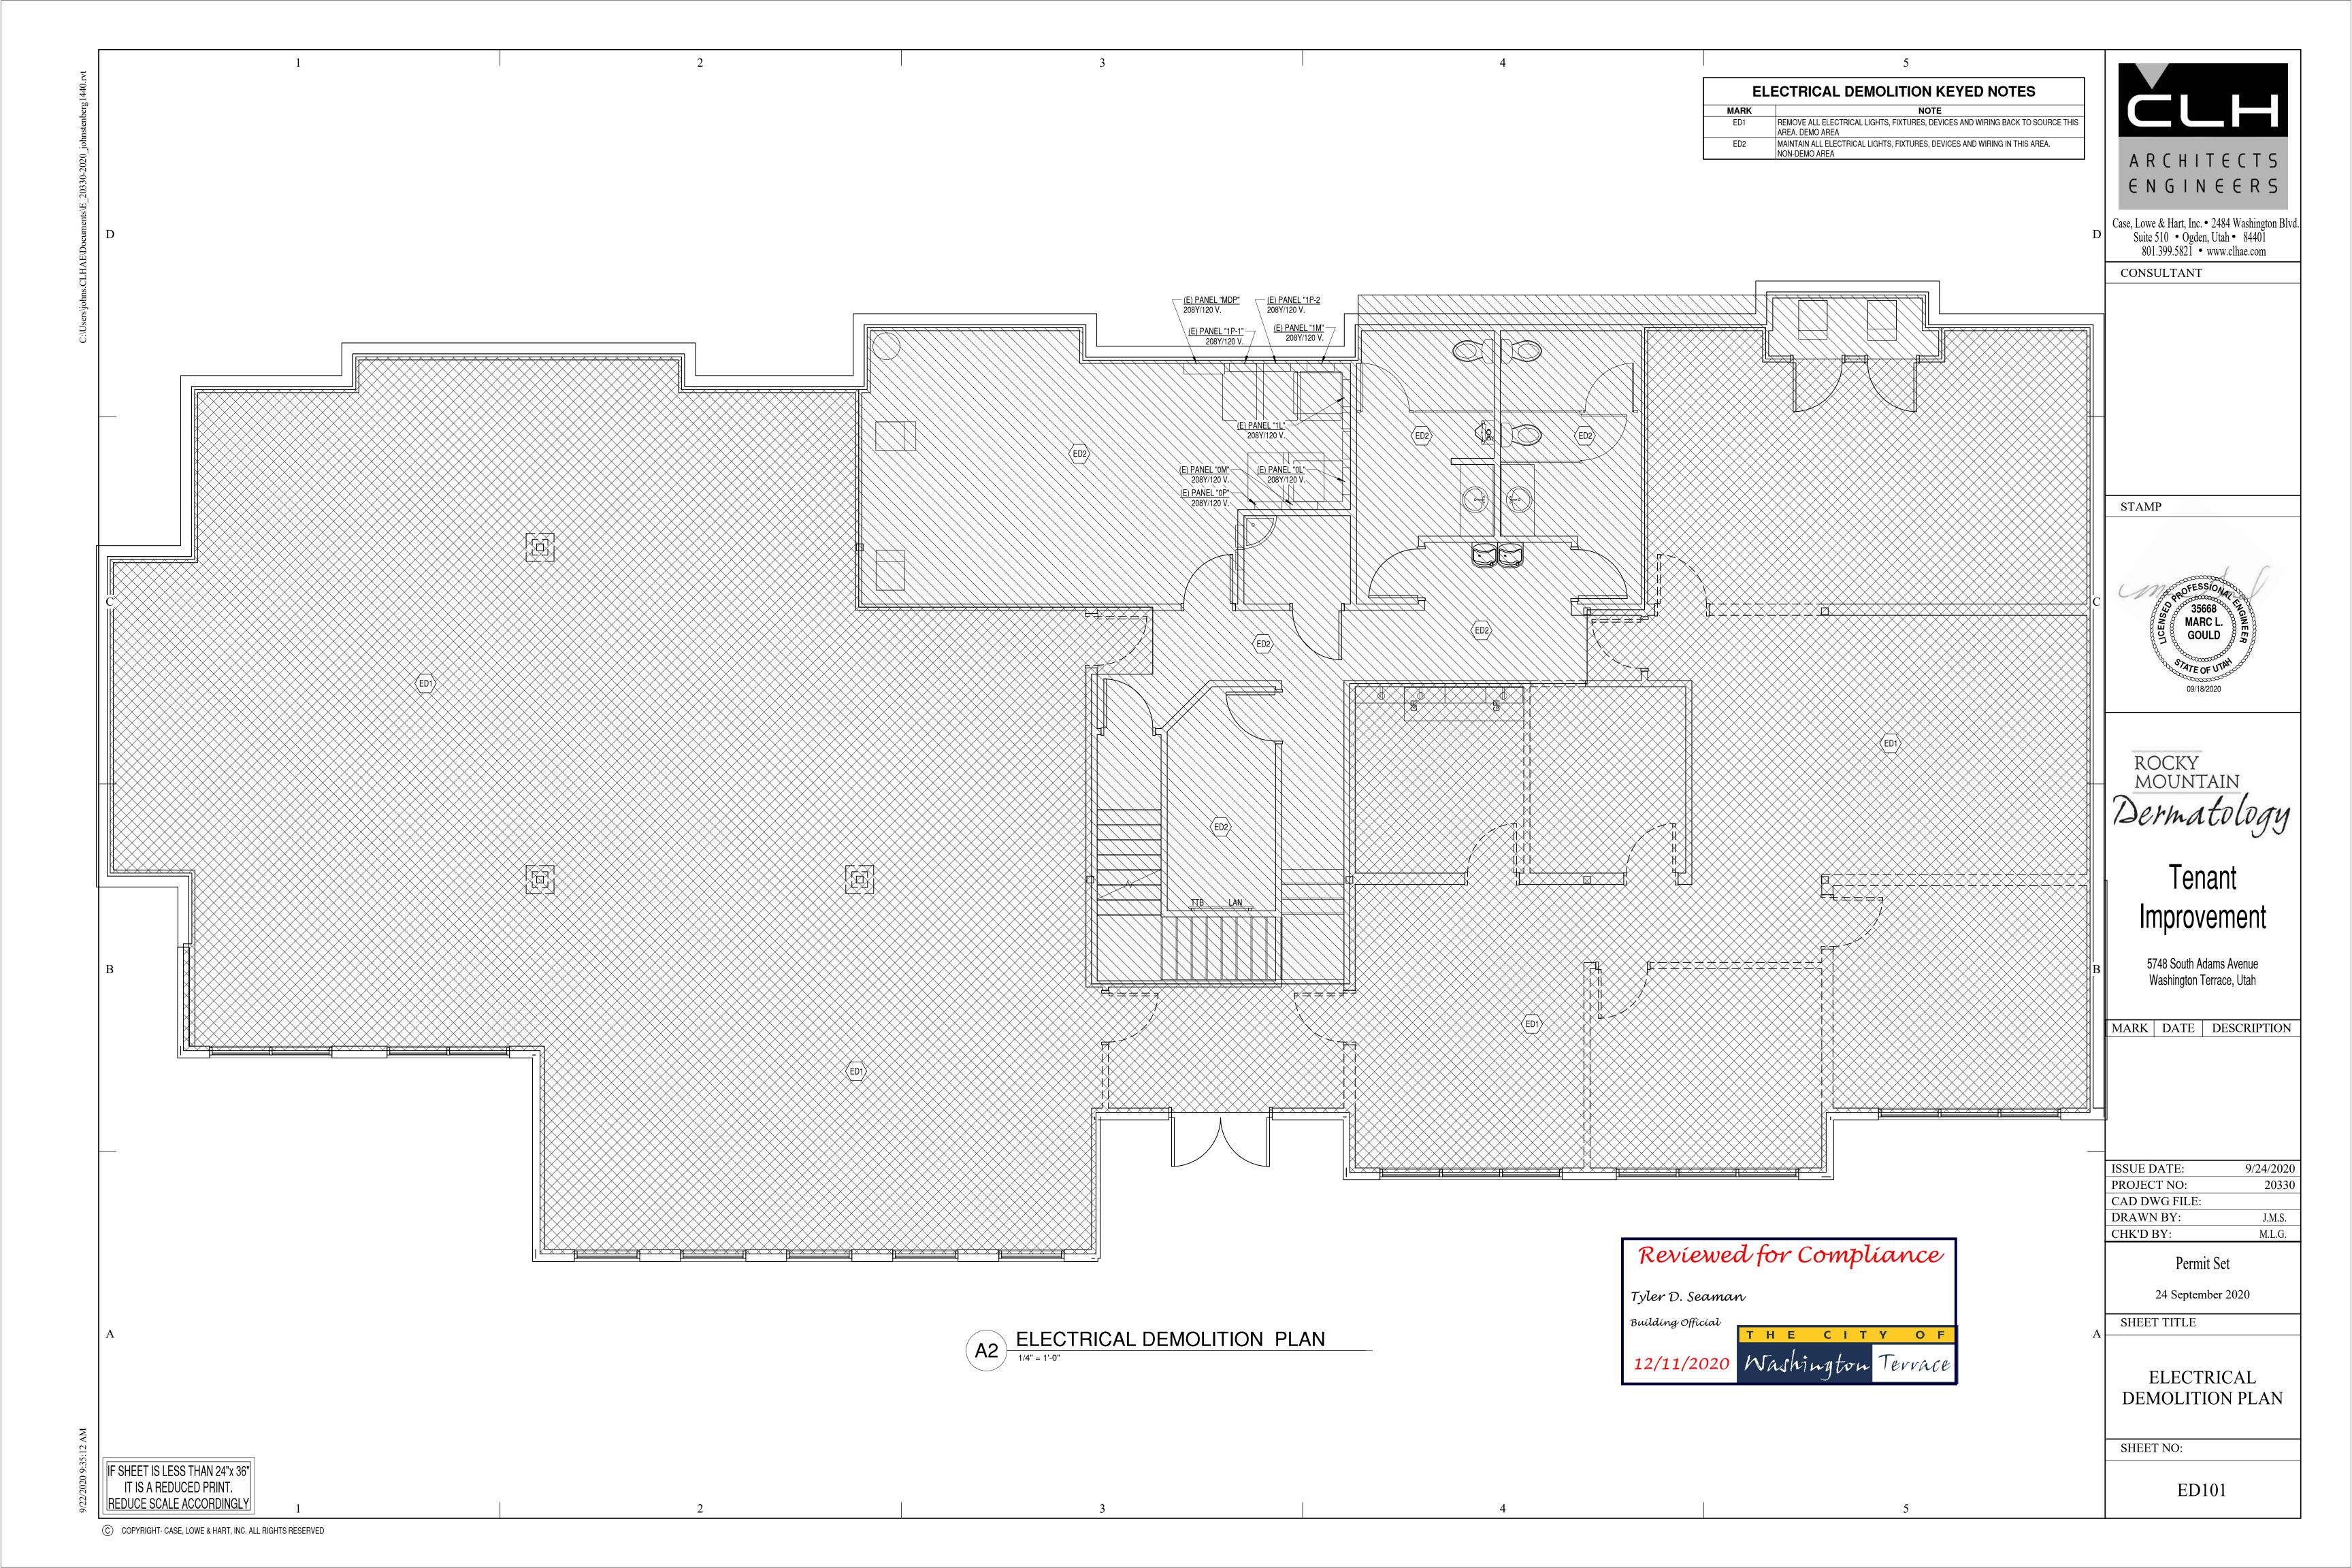

- 1. THE ARCHITECTURAL DRAWINGS ARE THE PRIMARY CONTRACT DOCUMENTS.
 ANY CONFLICTS BETWEEN ARCHITECTURAL DRAWINGS AND EXISTING
 CONDITIONS AND/OR DRAWINGS OF OTHER DISCIPLINES SHALL BE IMMEDIATELY
 REPORTED TO THE ARCHITECT.
- THE CONTRACTOR SHALL VERIFY ALL EXISTING CONDITIONS PRIOR TO AY WORK.
 ITEMS AND DIMENSIONS BETWEEN EXISTING AND NEW PORTIONS OF THE
 PROJECT SHALL BE VERIFIED TO ENSURE COORDINATION.
- 3. THE CONTRACTOR SHALL SUBMIT ANY PROPOSED CHANGES OR MODIFICATIONS OF THE CONTRACT DOCUMENTS, IN WRITING, TO THE ARCHITECT BEFORE PROCEEDING WITH ANY ACTION.
- WHERE SPECIFIC DETAILS ARE NOT PROVIDED, TYPICAL OR SIMILAR INDUSTRY STANDARD DETAILS SHALL APPLY. IF FURTHER DETAIL IS REQUIRED CONTACT ARCHITECT.
- 5. DETAILS ARE PROVIDED FOR VISUAL REPRESENTATION OF DESIGN INTENT. OFTEN THE DETAILS ARE BASED ON A BASIS-OF-DESIGN PRODUCT AND/OR MATERIAL AND MAY BE DIAGRAMMATIC IN NATURE.
- 6. IF A DIFFERENT PRODUCT OR MATERIAL FROM THAT INDICATED ON THE DRAWINGS OR SPECIFICATIONS IS SUBSTITUTED, IT IS THE RESPONSIBILITY OF THE CONTRACTOR TO PROVIDE ALTERNATE DETAILS AS REQUIRED FOR THE ARCHITECT TO REVIEW.
- GENERALLY, DIMENSIONS SHOWN OF ARCHITECTURAL DRAWINGS ARE TAKEN FROM THE CORE STRUCTURE FACE (IE. CONCRETE WALL=FACE OF WALL; STUD WALL=FACE OF STUD).
- ANY ADDITIONAL BLOCKING, BRACING, TRIM, FLASHING, SEALANTS, ETC. REQUIRED FOR INSTALLATION OF COMPLETE SYSTEMS_ PERTAINING TO DOORS, WINDOWS, OPENINGS, PENETRATIONS, ETC. ARE EXPECTED TO BE PROVIDED AND INSTALLED BY THE CONTRACTOR.
- ASSUME ALL GYP. BD. WALLS TO HAVE TOPSET RUBBER BASE INSTALLED UNLESS NOTED OTHERWISE.
- 0.
 PROVIDE SEALANT OR TRIM AS APPROPRIATE WHERE DISSIMILAR MATERIALS COME IN CONTACT.
- PROVIDE FLOORING TRANSITION WHERE DISSIMILAR FLOORING MATERIALS

 12. OCCUR.


PAINT ALL MISCELLANEOUS SURFACES, SUPPORTS, METALS, ETC. IF PERMANENTLY ATTACHED TO PAINTED SURFACE OR EXPOSED TO THE ELEMENTS.

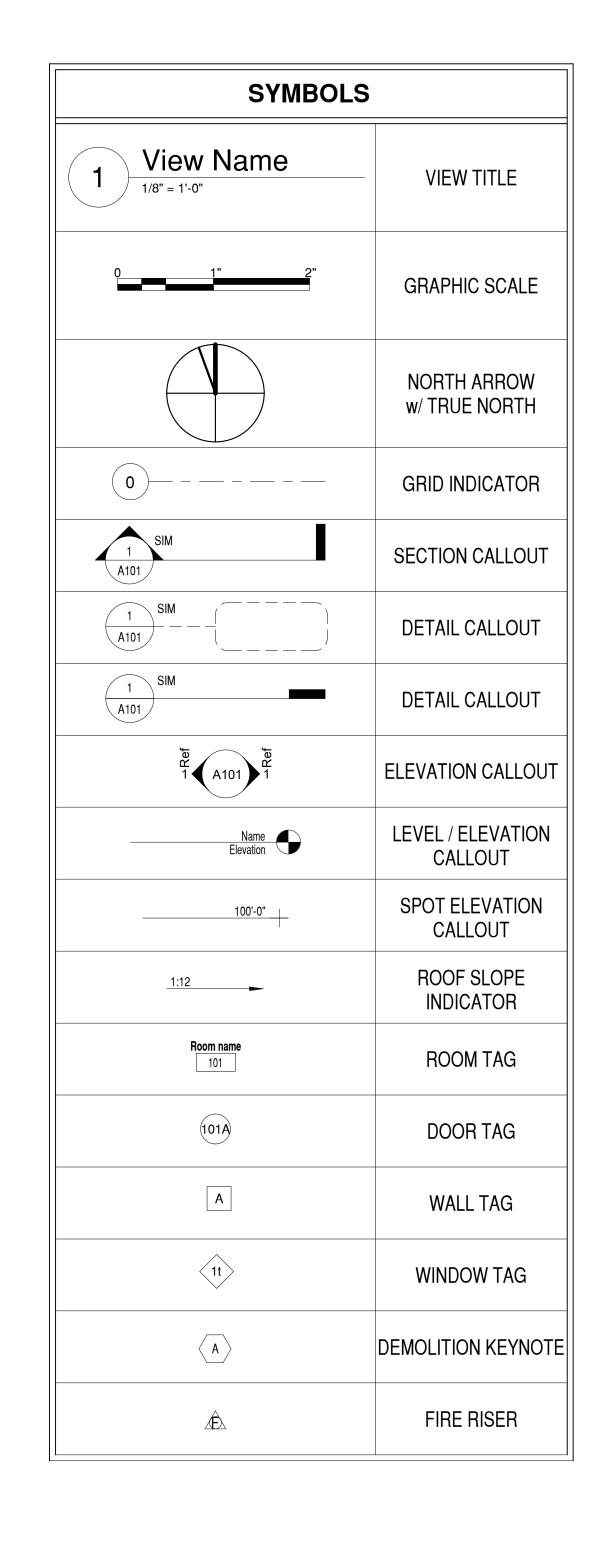

& L @ #	AND ANGLE AT POUND OR NUMBER	JAN JST JT	JANITOR JOIST JOINT
AC	ACOUSTICAL	K.O.	KNOCK OUT
A.F.F. ALUM APPROX ARCH	ABOVE FINISH FLOOR ALUMINUM APPROXIMATE ARCHITECTURAL	LAM LAV MAX	LAMINATE LAVATORY MAXIMUM
ASPH BD BITUM BLDG BLKG BRG BTM C	AND THE CTURAL ASPHALT BOARD BITUMINOUS BUILDING BLOCKING BEARING BOTTOM TOP OF FINISH CONCRETE	MAS MECH MEMB MTL MFTR MH MIN MISC M.O.	MASONRY MECHANICAL MEMBRANE METAL MANUFACTURER MANHOLE MINIMUM MISCELLANEOUS MASONRY OPENING MOUNTED
C.I. C.J. C.L. CLG CLR C.M.U. C.O.	CAST IRON CONTROL JOINT CENTER LINE CEILING CLEAR CONCRETE MASONRY UNIT CLEAN OUT	N N.I.C. NO or # NOM N.T.S.	NORTH NOT IN CONTRACT NUMBER NOMINAL NOT TO SCALE
C.O.T.G. COL CONC CONN CONSTR CONT CONT	CLEAN OUT AT GRADE COLUMN CONCRETE CONNECTION CONSTRUCTION CONTINUOUS CERAMIC TILE	O.C. O.D. OFF OH OPNG OPP	ON CENTER OUTSIDE DIAMETER (DIM) OFFICE OVERHEAD OPENING OPPOSITE
CTR D.C.W. D.H.W. D.F. DTL DIA DIM	CENTER DOMESTIC COLD WATER DOMESTIC HOT WATER DRINKING FOUNTAIN DETAIL DIAMETER DIMENSION	PL PLAM PLYWD P.O.C. PNL PR PT	PLATE PLASTIC LAMINATE PLYWOOD POINT OF CONNECTION PANEL PAIR POINT
DISP DN DRN DS DWG	DIMENSION DISPENSER DOWN DRAIN DOWNSPOUT DRAWING	Q.T. RAD R.D. REF REINF	QUARRY TILE RADIUS ROOF DRAIN REFERENCE REINFORCED
E EA E.I.F.S. E.J. EL ELEC ENGR	EAST EACH EXTERIOR INSULATION FINISH SYSTEM EXPANSION JOINT ELEVATION ELECTRICAL ENGINEER	REINF REQD RESIL RFG RM RS R.O.	REQUIRED RESILIENT ROOFING ROOM RESINOUS FLOORING ROUGH OPENING
EQ EQUIP (E) EXP EXT	EQUAL EQUIPMENT EXISTING EXPANSION EXTERIOR	S SCH SECT SHT SIM SPECS	SOUTH SCHEDULE SECTION SHEET SIMILAR SPECIFICATION
F.A. F.D. FDN F.E. F.E.C. FIN FLR FLASH FLUOR F.O. F.R.	FIRE ALARM FLOOR DRAIN FOUNDATION FIRE EXTINGUISHER FIRE EXTINGUISHER CABINET FINISH FLOOR FLASHING FLUORESCENT FACE OF FIRE RATED	SC S	SQUARE SANITARY SEWER STAINLESS STEEL STANDARD STEEL STORAGE STRUCTURAL SUSPENDED SYMMETRICAL SYSTEM
FT FTG FUT	FOOR OR FEET FOOTING FUTURE GAUGE	TLT TRTD T & B T.O. TRANS	TOILET (ROOM) TREATED (PRESERVATIVE TOP & BOTTOM TOP OF TRANSFORMER
GALV GND GR G.W.B. GYP	GAUGL GALVANIZED GROUND GRADE GYPSUM WALL BOARD GYPSUM	TYP U.N.O. UT	TYPICAL UNLESS NOTED OTHERWISE URINAL
H.B. HC H.M. HORIZ HGT	HOSE BIBB HANDICAP HOLLOW METAL HORIZONTAL HEIGHT	VERT VEST W w/ WC	VERTICAL VESTIBULE WEST WITH WATER CLOSET
I.D. IN INSUL INT	INSIDE DIAMETER (DIM) INCH, INCHES INSULATION INTERIOR	WD W/O WP	WATER GLOSET WOOD WITHOUT WATERPROOF

ABBREVIATIONS



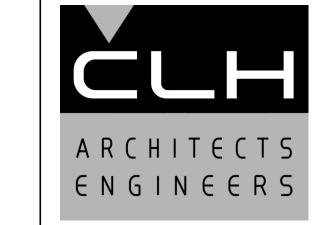

Case, Lowe & Hart, Inc. • 2484 Washington Blvd. Suite 510 • Ogden, Utah • 84401 801.399.5821 • www.clhae.com

CONSULTANT

STAMP





Tenant Improvement

5748 South Adams Avenue Washington Terrace, Utah

MARK DATE DESCRIPTION

ISSUE DATE: 1/1/202X
PROJECT NO: 20330
CAD DWG FILE:
DRAWN BY: Author
CHK'D BY: Checker

Project Status


01 January 202X


SHEET TITLE

ARCHITECTURAL NOTES


SHEET NO:


A001

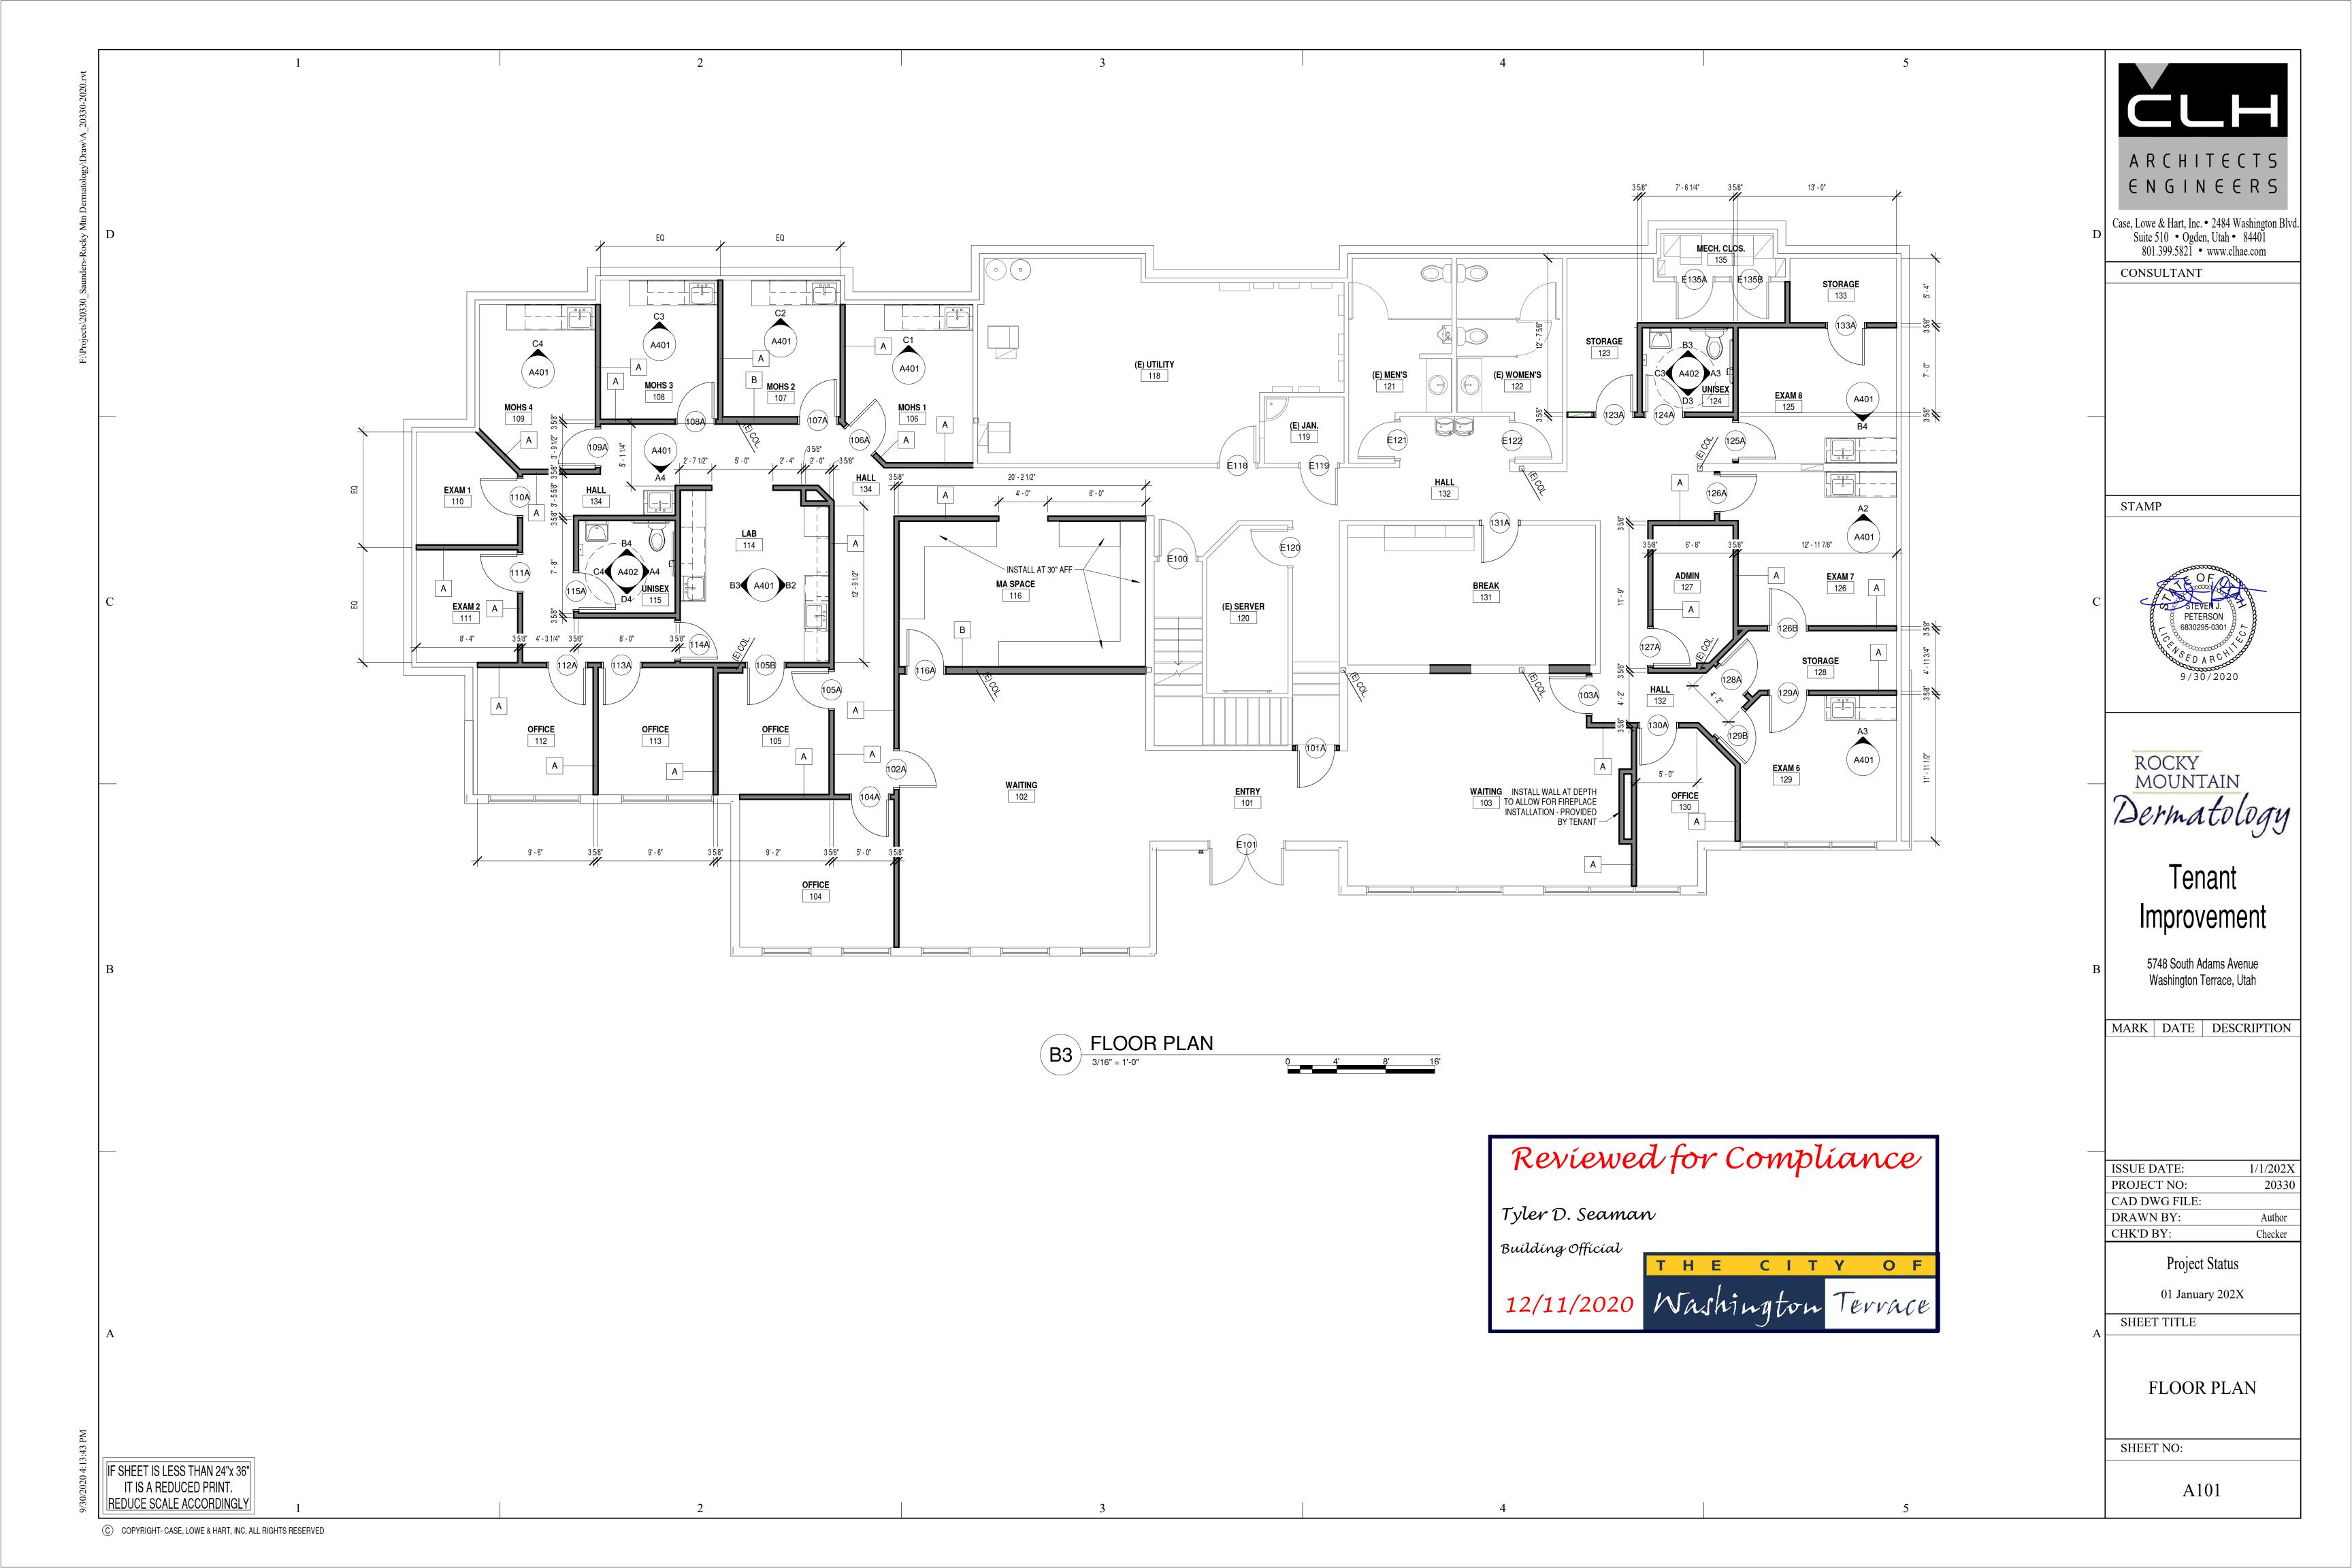


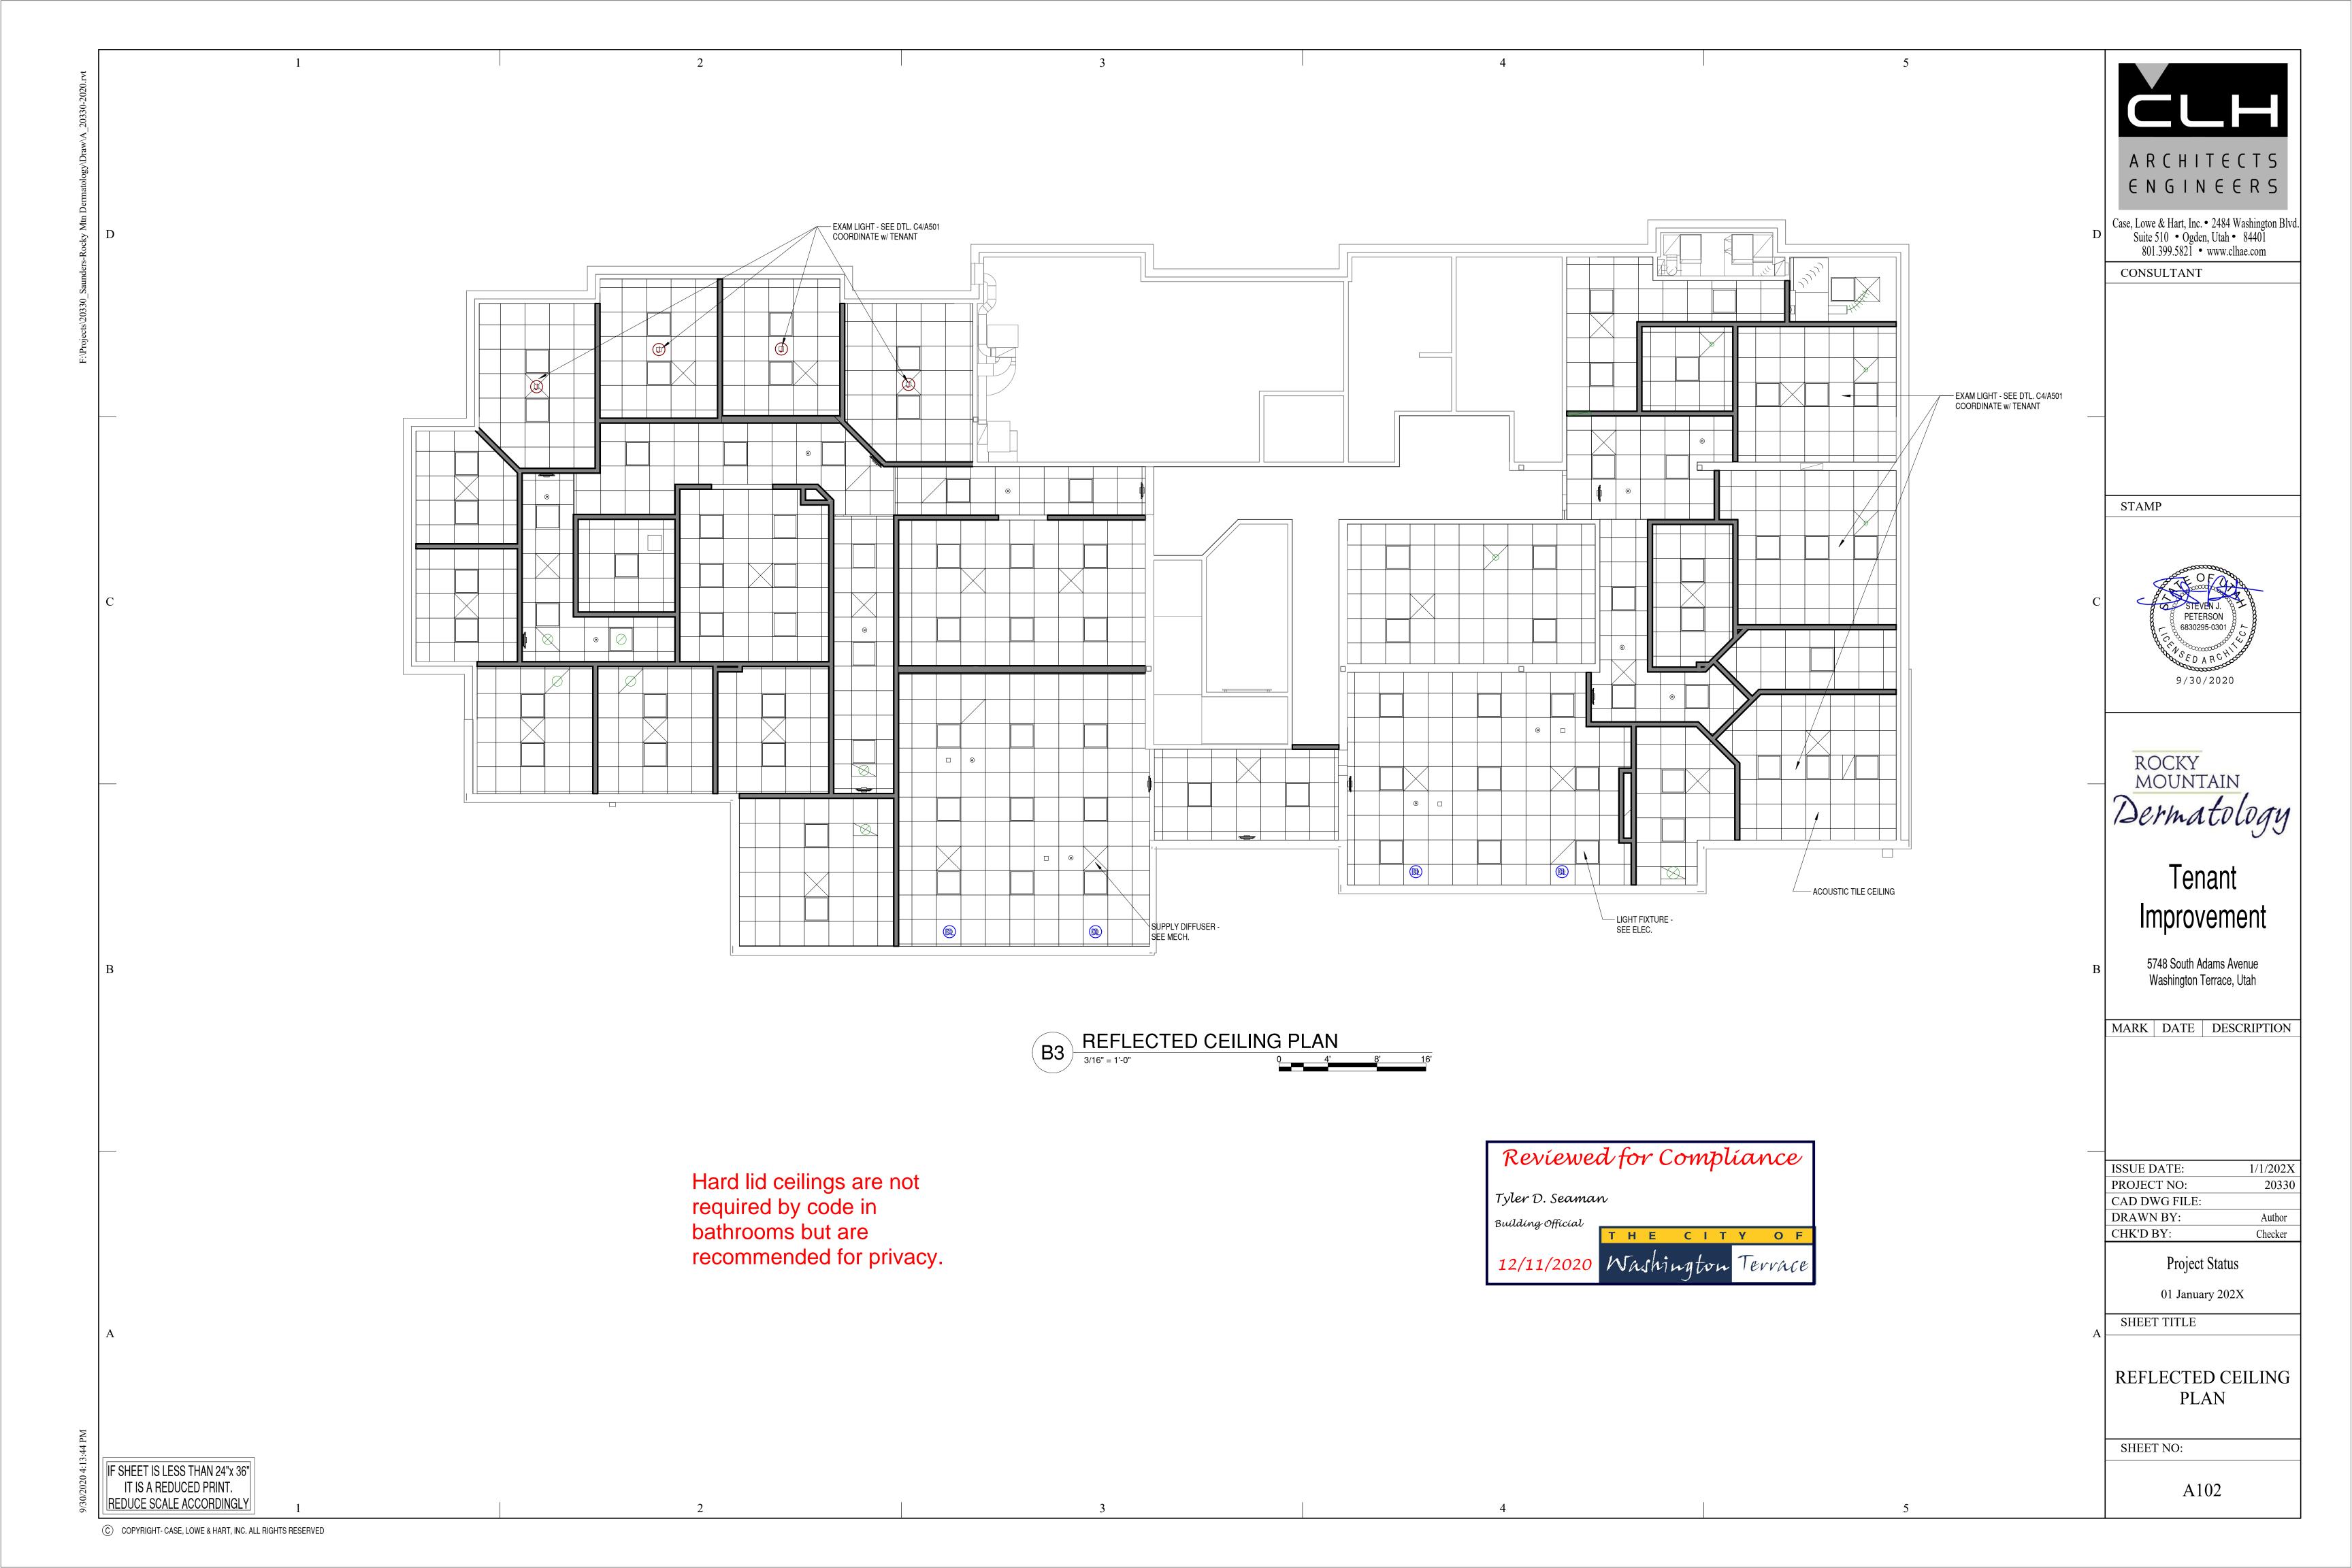



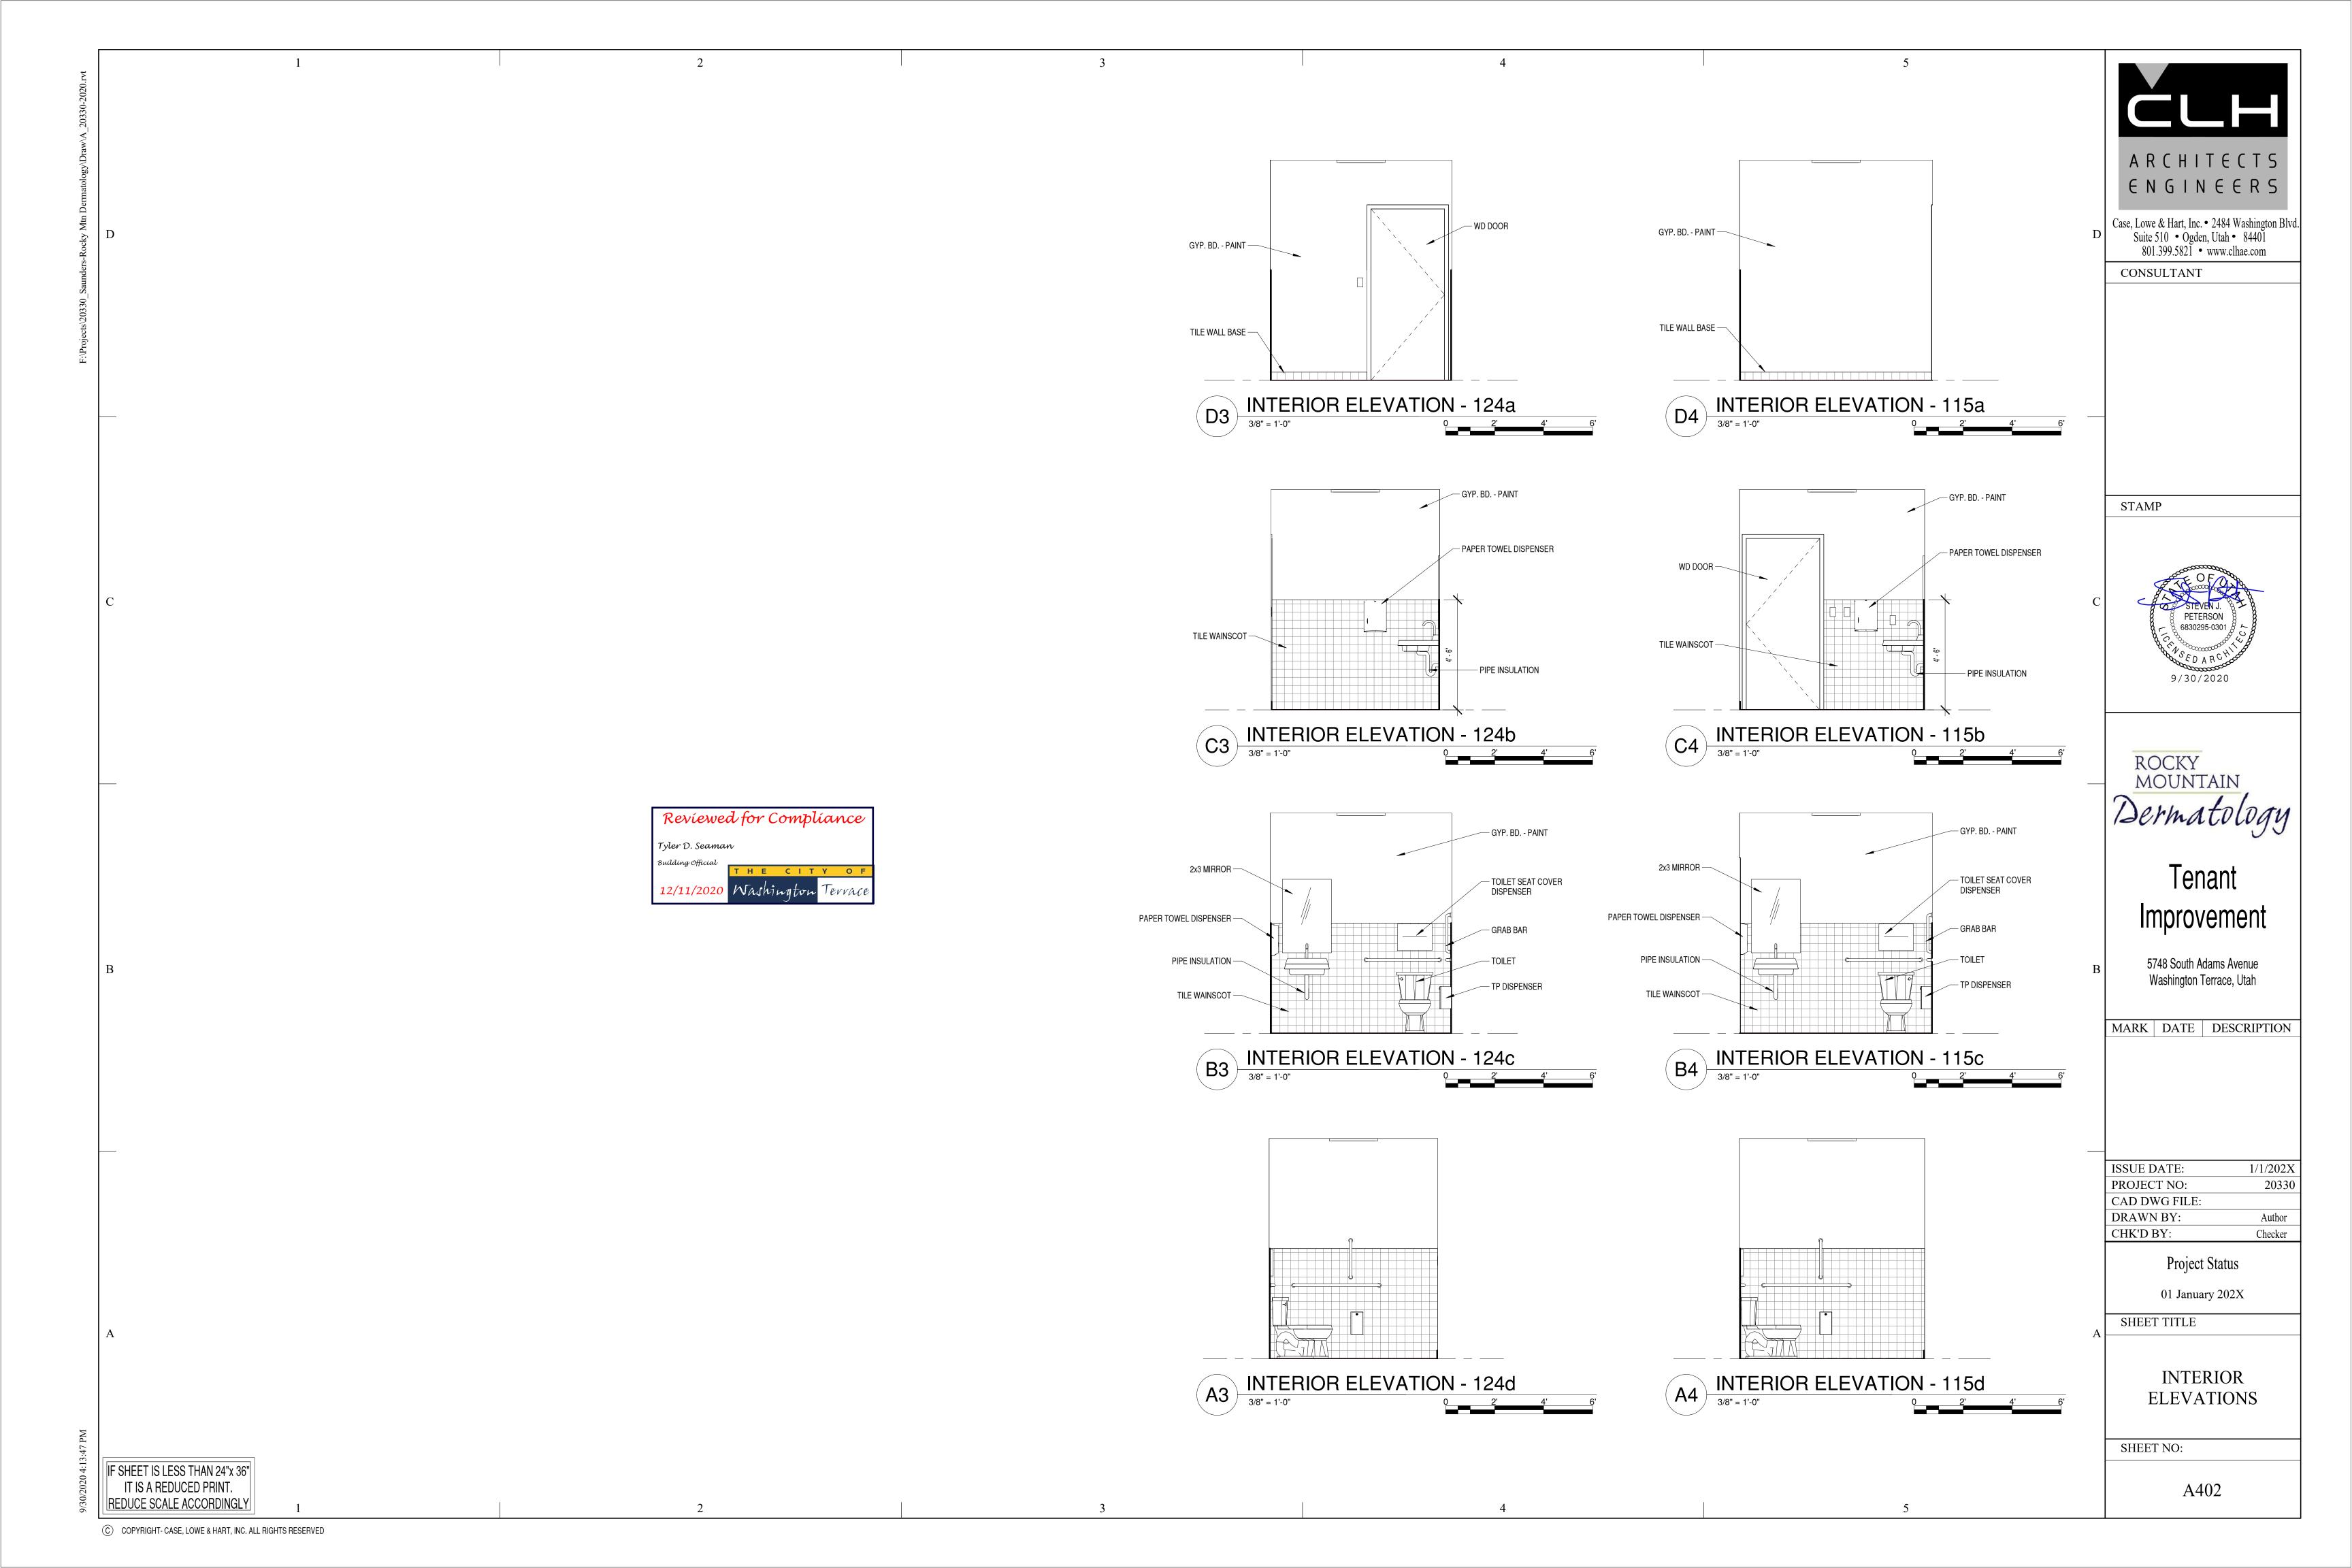

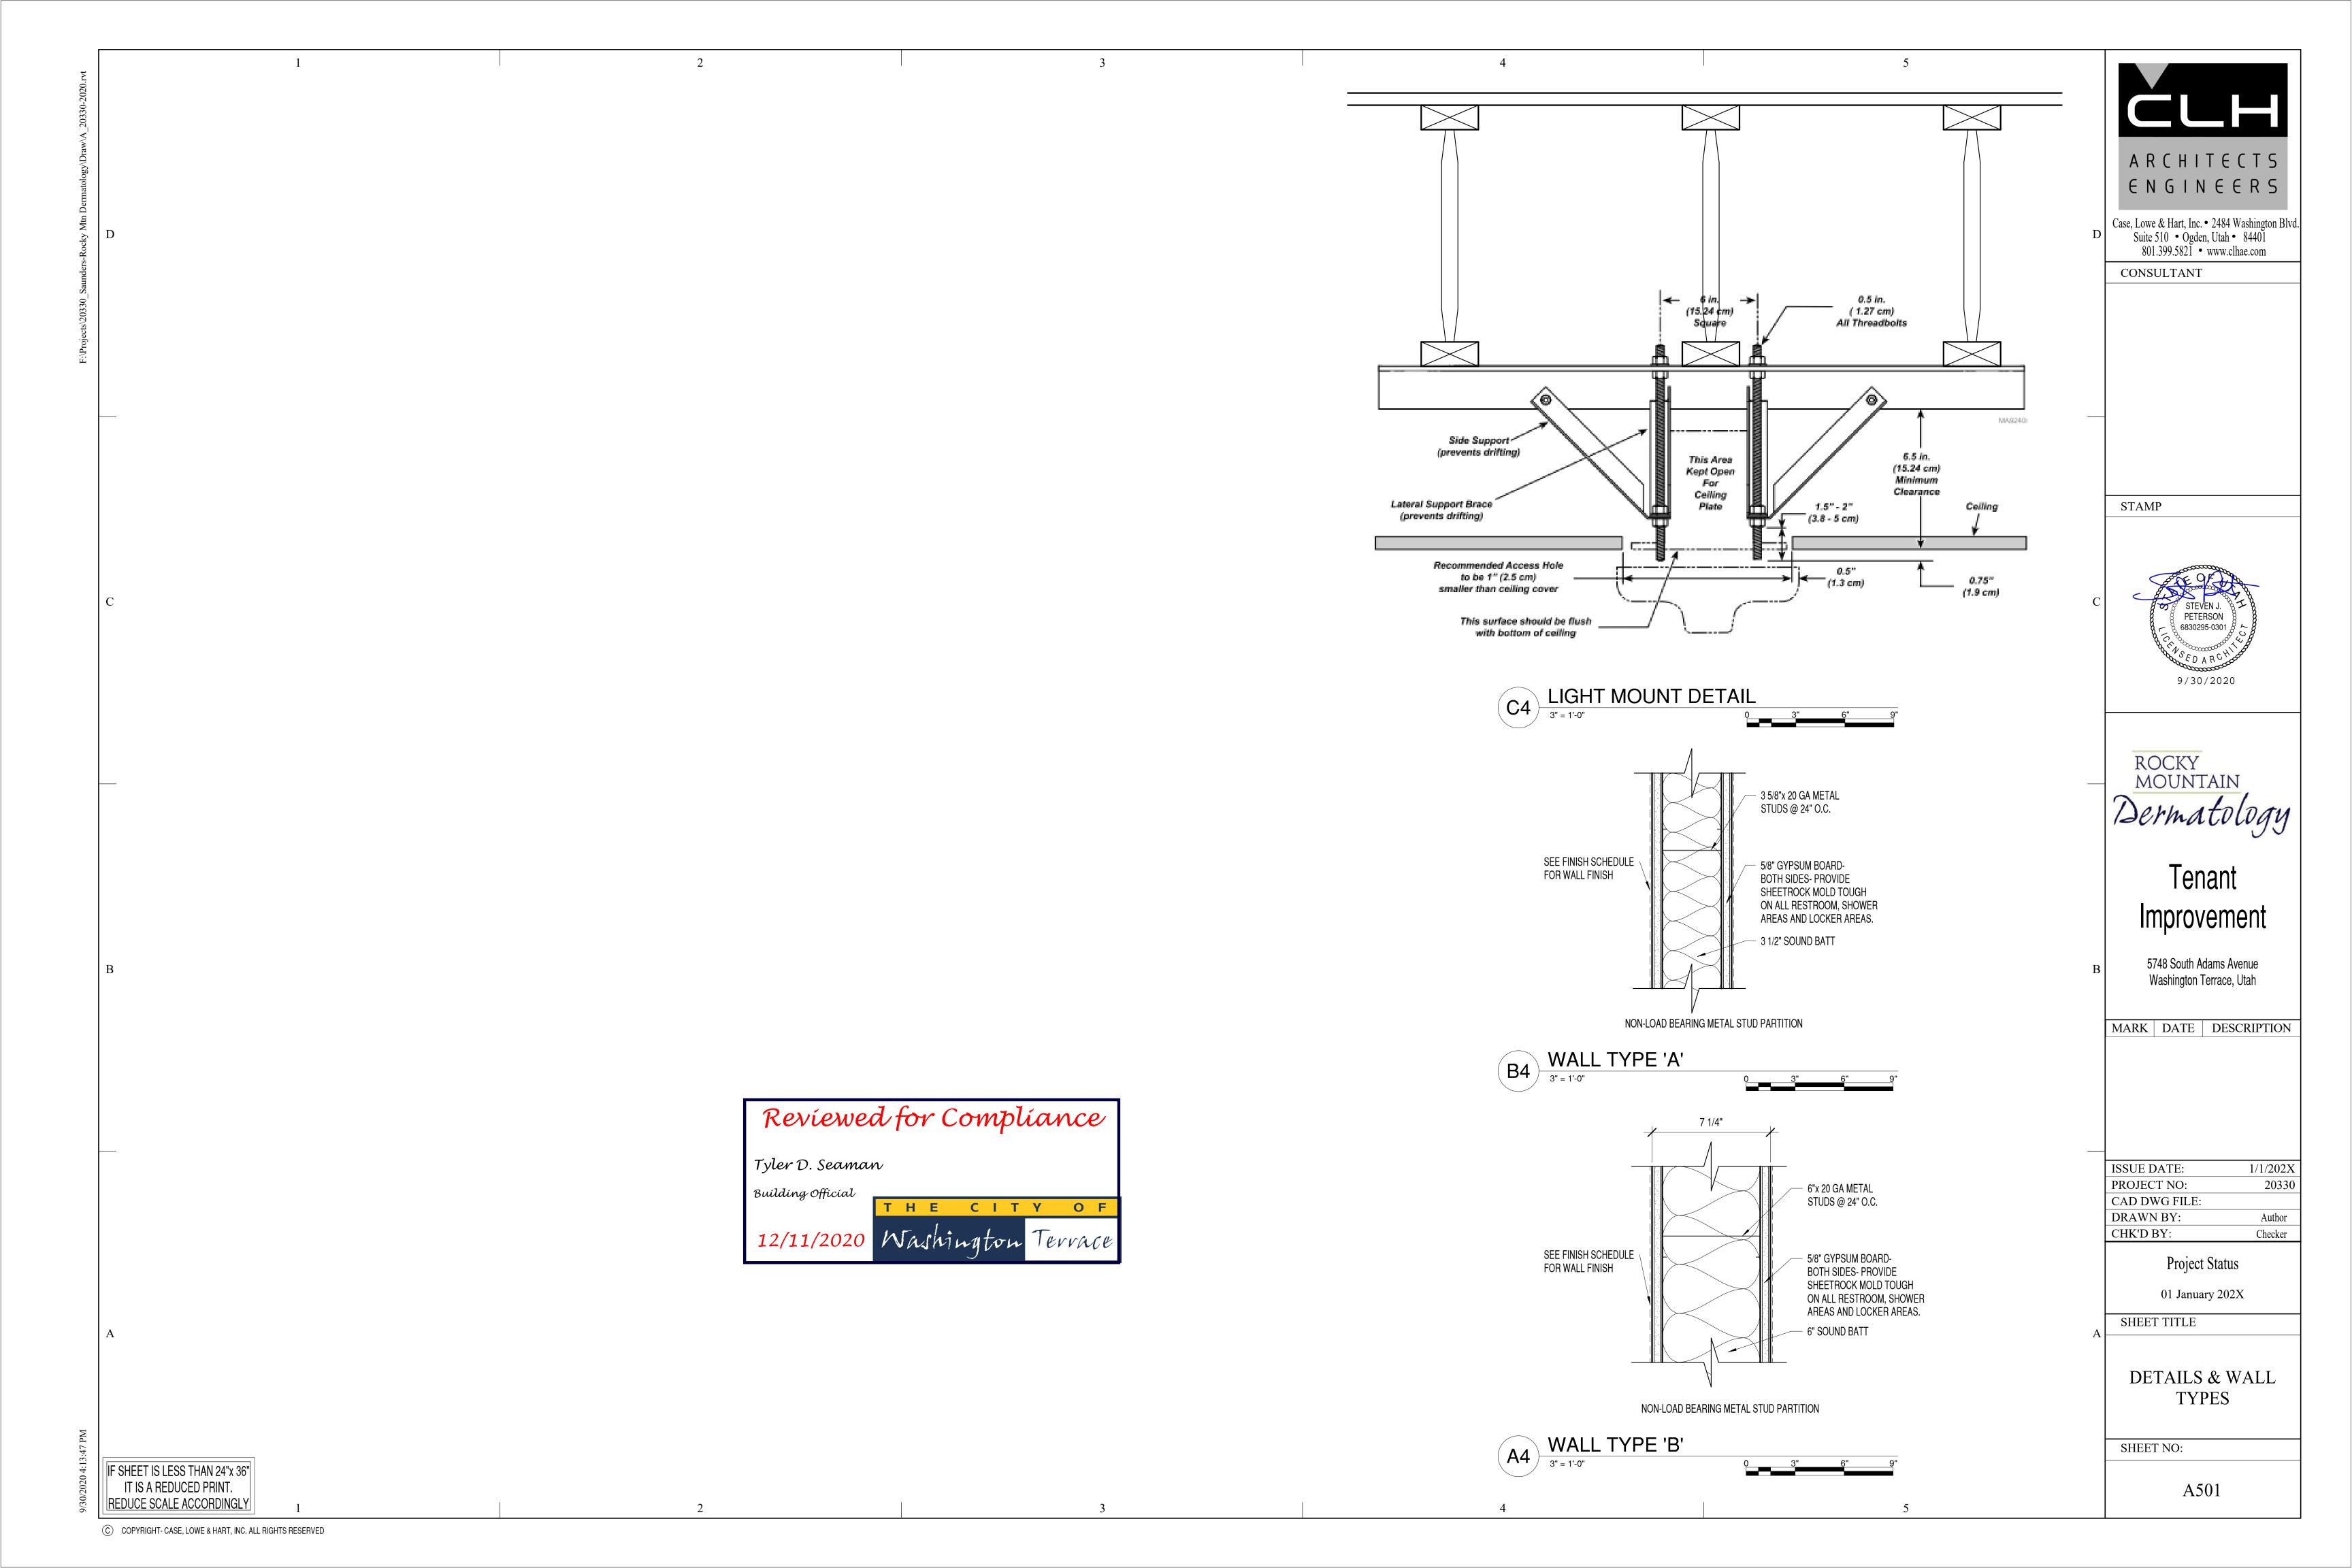

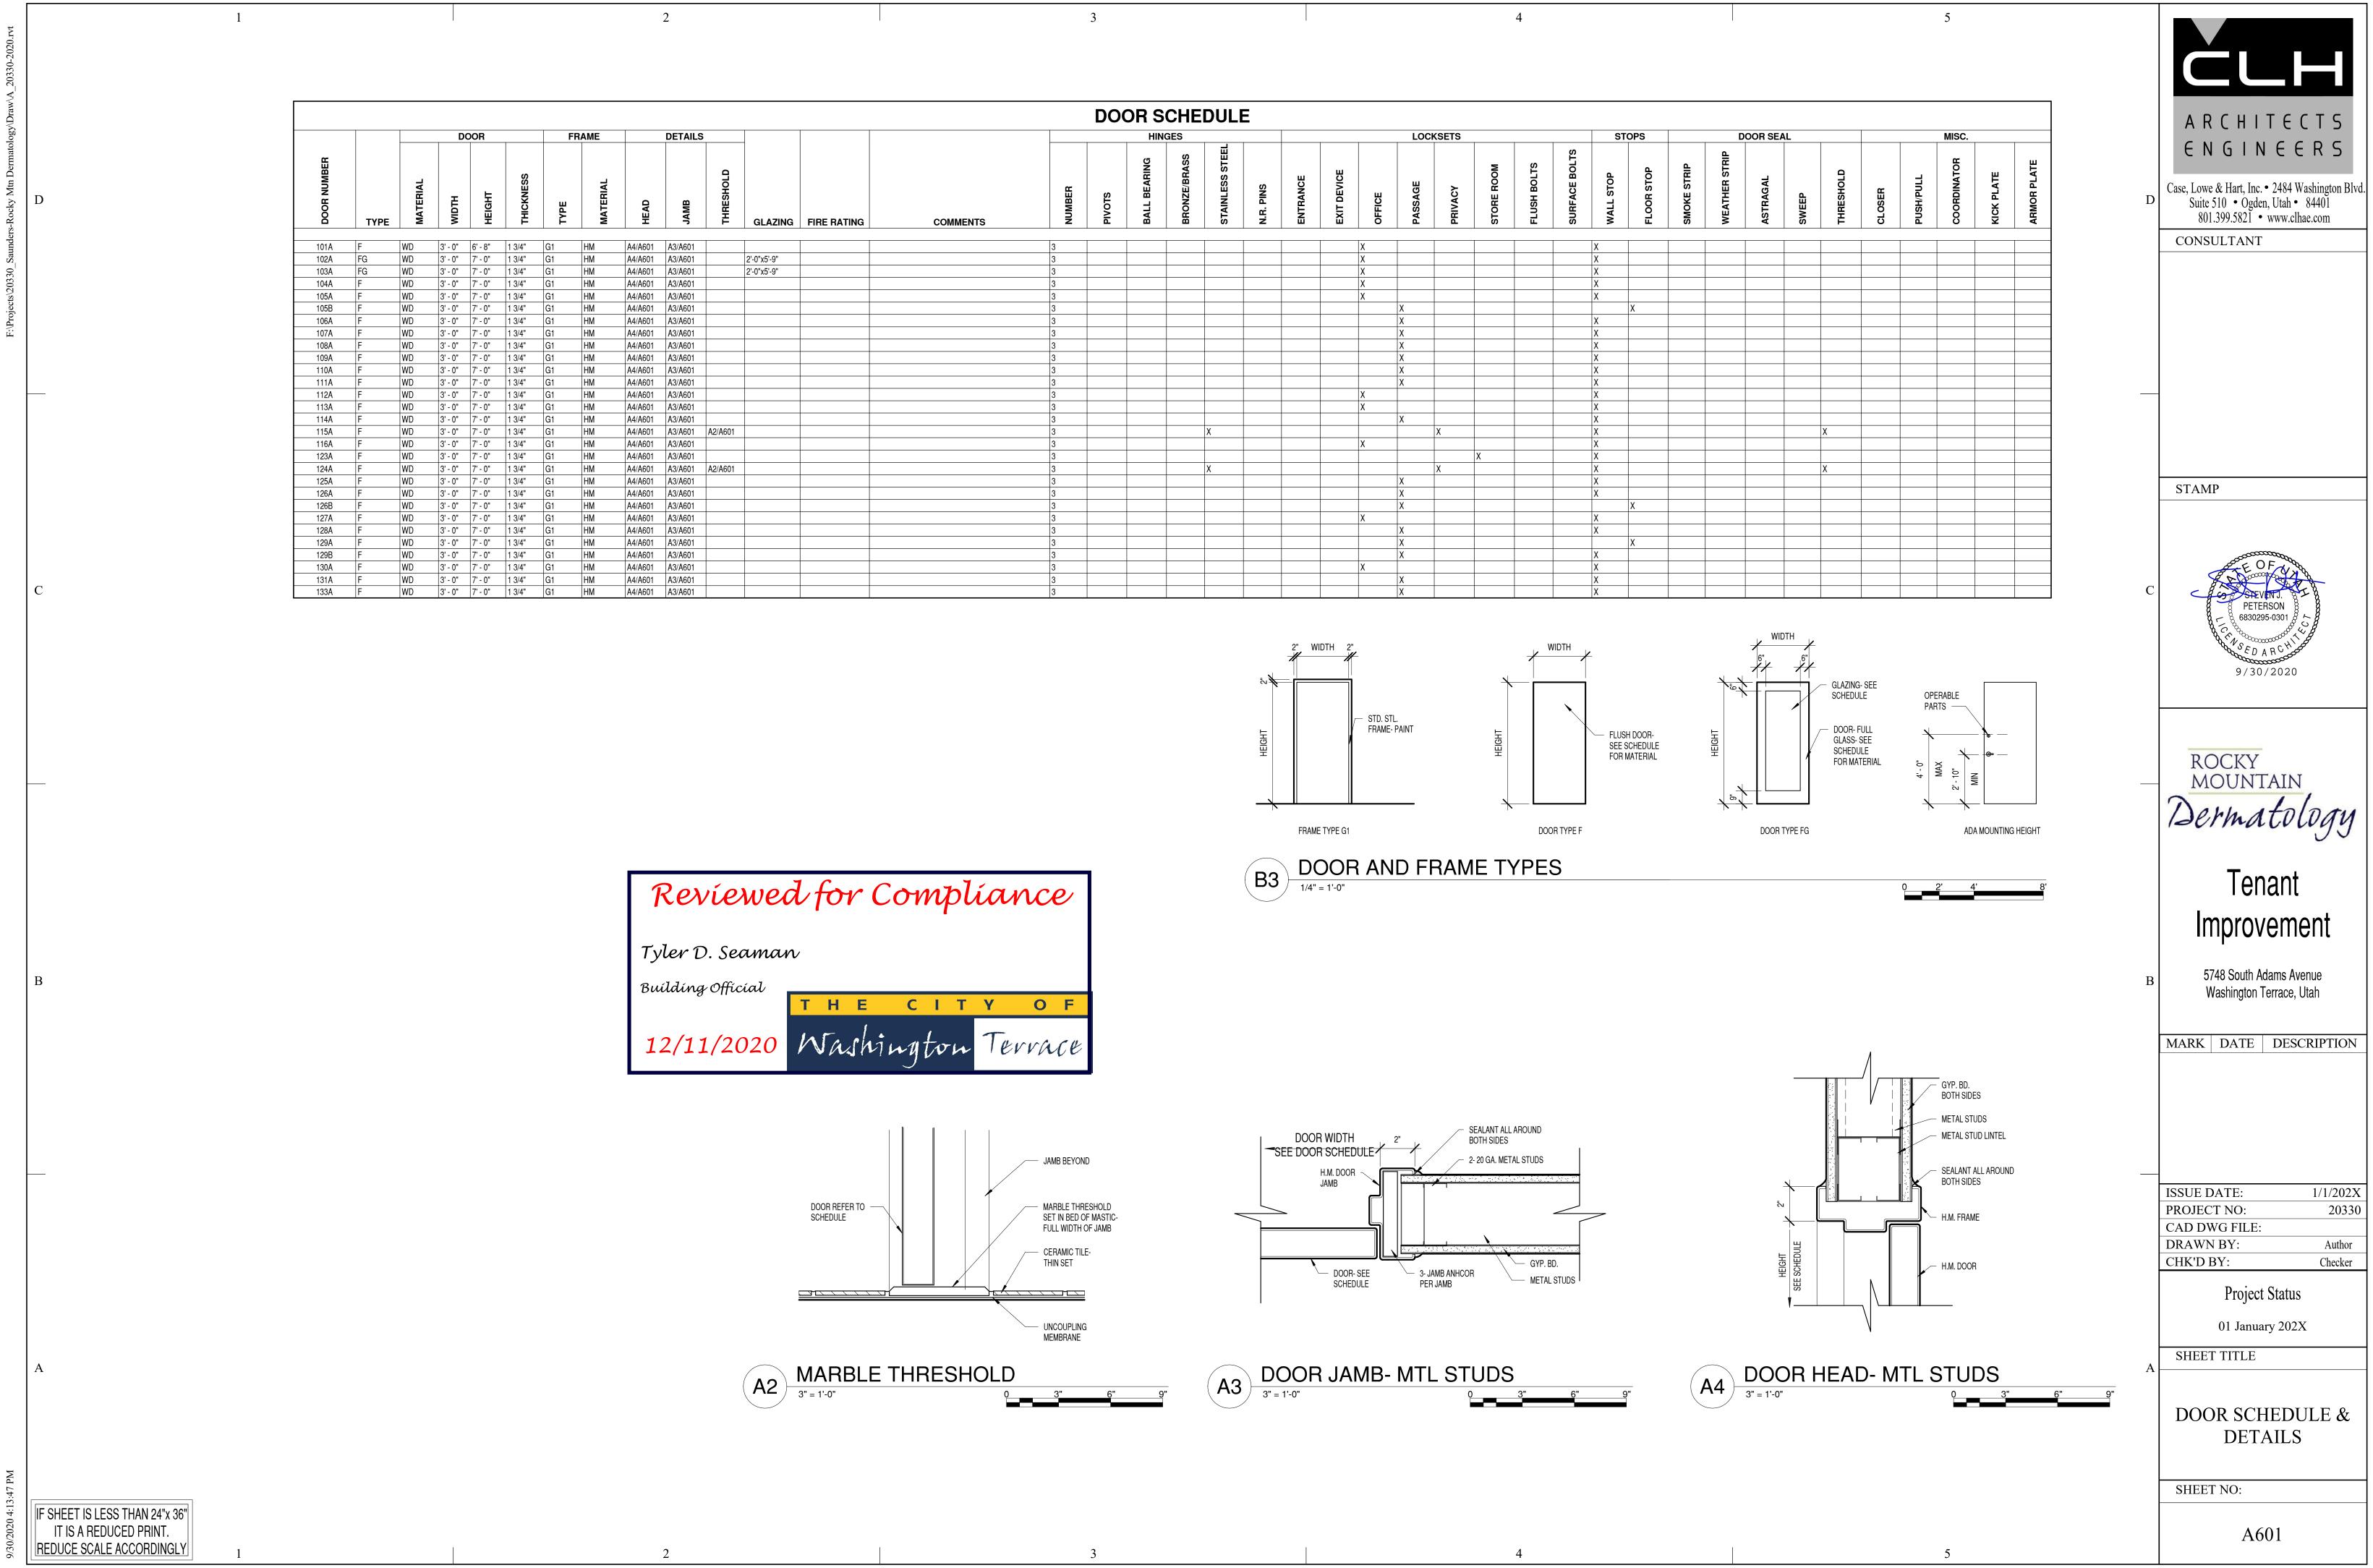

ISSUE DATE:	1/1/202X
PROJECT NO:	20330
CAD DWG FILE:	
DRAWN BY:	Author
CHK'D BY:	Checker

INTENDED TO SOLE SOURCE EQUIPMENT MANUFACTURER.

2. THE CONTRACTOR SHALL NOT SHUT-OFF (PUT OUT OF SERVICE) ANY SYSTEM SERVICES WITHOUT FIRST COORDINATING ALL DOWNTIME WITH THE OWNERS PERSONNEL. UTILITY INTERRUPTIONS REQUIRED TO ACCOMMODATE NEW CONNECTIONS MAY REQUIRE ODD HOUR WORK.

1. ALL EQUIPMENT MANUFACTURERS SHOWN AS A BASIS OF DESIGN. NOT

PLUMBING GENERAL NOTES

3. PIPE ROUTING IS APPROXIMATE, DIAGRAMMATIC AND IS NOT TO BE SCALED. WHERE ALTERNATE ROUTING, OFFSETS AND TRANSITIONS ARE REQUIRED FOR COORDINATION OF ALL WORK. THE CONTRACTOR SHALL MAKE CHANGES WITHOUT ADDITIONAL COSTS.

4. THE CONTRACTOR SHALL CLOSELY COORDINATE NEW PLUMBING WITH ALL ELECTRICAL, MECHANICAL, ARCHITECTURAL AND STRUCTURAL MEMBERS.

5. ALL PIPING AND PLUMBING SYSTEMS SHALL BE INSTALLED IN ACCORDANCE WITH THE LATEST EDITION OF THE INTERNATIONAL PLUMBING CODE, NATIONAL FIRE CODE AND INTERNATIONAL FUEL GAS CODE.

6. WHEN CONNECTING NEW PIPING TO EXISTING, CONTRACTOR TOMATCH EXISTING PIPING MATERIAL UNLESS OTHERWISE NOTED.

7. PRIME AND PAINT ALL EXPOSED PIPES AND PIPE SUPPORT.

8. ALL EXTERIOR SUPPORTS, BRACES, ANCHORS, ETC. WITH OPEN ENDS TO BE CAPPED AND SEALED WEATHERTIGHT.

9. ROOF FLASHING MATERIALS: UNLESS NOTED ELSEWHERE, PROVIDEROOF FLASHING AS REQUIRED/RECOMMENDED BY ROOFING AND/OR PIPING MANUFACTURERS.

10. PIPING SEISMIC SUPPORTS SHALL NOT BE REQUIRED IF PIPING IS SUPPORTED BY ROD HANGERS; HANGERS IN THE PIPE RUN 12 INCH OR LESS IN LENGTH FROM TOP OF THE PIPE TO THE SUPPORTING STRUCTURE. PIPING WITH ROD HANGERS: HANGERS IN THE PIPE RUN OVER 12 INCHES IN LENGTH FROM THE TOP OF THE PIPE TO THE SUPPORT STRUCTURE WILL BEREQUIRED TO BE SEISMICALLY RESTRAINED.

11. PROVIDE ACCESS PANELS FOR SERVICING OF WALL HYDRANT, TRAP PRIMERS AND WATER HAMMER ARRESTORS.

12. SIZE AND SELECT ALL WATER HAMMER ARRESTORS PER MANUFACTURERES RECOMMENDATIONS.

13. ALL WETTED SURFACES OF POTABLE WATER PIPES, PIPE FITTINGS, PLUMBING FITTINGS AND FIXTURES MEET A WEIGHTED AVERAGE LEAD CONTENT OF NO MORE THAN 0.25 PERCENT PER ANSI 61 AND ANSI 372.

14. EXISTING UTILITY LOCATIONS AND SIZES ARE ESTIMATED. CONTRACTOR TO FELD VERIFY.

	ELECTRIC WATER HEATER SCHEDULE											
MARK	MARK MANUFACTURER & SYSTEM SERVED SERVED CAPACITY (GAL) NO. OF ELEMENTS KW RECOVERY (GAL) VOLTS / PHASE WEIGHT (LBS) DIMENSIONS HXWXD (IN)											
WH-1	LOCKINVAR KSA030KDB	DERMATOLOGY SUITE	28	1	4.5	43	240/1	310	30 X 20			

		P	LUMB	ING	FIXTL	JRE SO	CHED	ULE
MADIZ	DESCRIPTION	MANUFACTURER &	GPM		CONNECTIONS			NOTES
MARK	DESCRIPTION	MODEL	GPW	CW	HW	WASTE	VENT	NOTES
FCO	FLOOR CLEANOUT	J.R. SMITH 4020 SERIES	-	-	-	MATCH LINE SIZE	-	MATCH CLEANOUT SIZE TO PIPE IT SERVES
<u>FD-1</u>	SQUARE HEAD FLOOR DRAIN	J.R. SMITH 2005Y-B-2692	-	-	-	2"	1 1/2"	NICKEL BRONZE STRAINER HEAD, QUAD CLOSE TRAP SEAL DEVICE
<u>S-1</u>	DOUBLE BOWL KITCHEN SINK - ADA	ELKAY LRAD33224 SINK	1.5	1/2	1/2	1 1/2"	-	PROFLO 1 1/2" SS BASKET, STRAINER, & P-TRAP, BADGER 5 DISPOSAL, BRASS CRAFT KWIK TURN STOPS, CHROME MOEN 7430 FAUCET WITH SPRAYER
<u>S-2</u>	COUNTER UNDERMOUNT LAVATORY - ADA	AMERICAN STANDARD 0614.300	0.5	1/2"	1/2"	1 1/4"	1 1/2"	AMERICAN STANDARD 6055.105 LV10 BATTERY POWERED SENSOR FAUCET AND 605XTMV MIXING VALVE, SINGLE HOLE DRILL FOR FAUCET, PROTECTIVE ADA WRAP ON PIPES
LAV-1	WALL HUNG LAVATORY - ADA	AMERICAN STANDARD 0124.131	1	1/2"	1/2"	1 1/2"	1 1/2"	AMERICAN STANDARD 6055.105 LV10 BATTERY POWERED SENSOR FAUCET, 4" DECK PLATE, AMERICAN STANDARD 605XTMV MIXING VALVE, CONCEALED ARM
TSD-1	TRAP SEAL DEVICE	J.R. SMITH 2692	-	-	-	MATCH LINE SIZE	-	QUAD CLOSE TRAP SEAL DEVICE
<u>WC-1</u>	FLOOR MOUNTED WATER CLOSET - ADA	AMERICAN STANDARD 211AA.104	1.28 GPF	1/2"		3"	1 1/2"	WHITE ELONGATED BOWL, EVER CLEAN SURFACE FINISH, AMERICAN STANDARD STOP SEAT (5325.010), HANDLE TO BE ON WIDE SIDE, REFERENCE ARCH PLANS FOR MOUNTING HEIGHT
WCO	WALL CLEANOUT	J.R. SMITH 4472T	-	-	-	MATCH LINE SIZE	-	PROVIDE WALL ACCESS

	CIRCULATING PUMP SCHEUDLE											
	MANUFACTURER OVOTEM OF DVED				HEAD		FLUID		MOTOR		WEIGHT	
MARK	& MODEL	SYSTEM SERVED	TYPE			TEMP	AMP	HP	VOLT/ PHASE	(LBS)	NOTES	
P-1	TACO IL009	HOT WATER RECIRC.	IN LINE	1.75	30	WATE R	110	1.4	0.125	115/1	9.5	

	EXPANSION TANK SCHEDULE												
MARK	MANUFACTURER & MODEL	SYSTEM SERVED	TYPE	MAX TEMP (°F)	FLUID	TANK VOL (GAL)	ACCEPT VOL (GAL)	MAX PRESSURE (PSI)	DIMENSIONS DIAxH (IN)	WEIGHT (LB)	NOTES		
ET-1	AMTROL ST-5	DERMATOLOGY SUITE	DIAPHRAM	200	WATER	2	0.9	150	8 X 13	5			

ľ	MINIMUM PIPE INSULATION THICKNESS TABLE													
FLUID DESIGN	VAPOR	INSULATION CON	DUCTIVITY	ľ	NOMINAL P	IPE OR TU	BE SIZE (IN)						
OPERATING TEMP RANGE (°F)	BARRIER RATING (PERMS)	CONDUCTIVITY (BTU-IN/(H-FT2-°F))	MEAN RATING TEMP (°F)	<1"	1" TO <1 1/2"	1 1/2" TO <4"	4" TO <8"	>8"						
201-250	-	0.27-0.30	150	2.5	2.5	2.5	3.0	3.0						
141-200	-	0.25-0.29	125	1.5	1.5	2.0	2.0	2.0						
105-140	-	0.21-0.28	100	1.0	1.0	1.5	1.5	1.5						
40-60	<0.05	0.21-0.27	75	0.5	0.5	1.0	1.0	1.0						
<40	<0.02	0.20-0.26	50	0.5	1.0	1.0	1.0	1.5						

Reviewed for Compliance

Tyler D. Seaman

Building Official

THE CITY OF

12/11/2020 Washington Terrace

ARCHITECTS ENGINEERS Case, Lowe & Hart, Inc. • 2484 Washington Blvd. Suite 510 • Ogden, Utah • 84401 801.399.5821 • www.clhae.com

PLUMBING LEGEND

VENT PIPING

TRAP PRIMER PIPING

CONDENSATE DRAIN

NATURAL GAS PIPING

ROOF DRAIN PIPING

PLANT VACUUM

ACID WASTE PIPING

ACID VENT PIPING

DIRECTION OF FLOW BACKFLOW PREVENTER

TRAP PRIMER DEVICE

LUBRICATED PLUG VALVE

LOOR CLEANOUT

GATE VALVE

GLOBE VALVE

BALL VALVE

CHECK VALVE

Y-STRAINER

—— OR ——

 $-\!\bigcirc$

>>>

Ø OR 🔯

 \odot

 Θ

COTG

FCO

THRU

VTR WCO BUTTERFLY VALVE

CALIBRATED BALANCING VALVE

STRAINER WITH BLOWDOWN CONCENTRIC REDUCER

ECCENTRIC REDUCER

BLIND FLANGE OR CAP PIPING TEE DOWN

THERMOMETER

PIPING TEE UP

PIPING ELBOW UP PIPING ELBOW DOWN

PRESSURE GAUGE

UNION OR FLANGE

ROOF DRAIN

WALL CLEANOUT

DETAIL CALLOUT

ABOVE FINISH FLOOR

CLEANOUT TO GRADE

FLOOR CLEANOUT

NOT IN CONTRACT

SANITARY SEWER

STAINLESS STEEL

VENT THRU ROOF

WALL CLEANOUT

THROUGH

TYPICAL

HUMIDISTAT

BETWEEN **BELOW** BOTTOM CLEANOUT

DOWN

EXISTING

POINT OF CONNECTION POINT OF DISCONNECTION

PLUMBING FIXTURE CALLOUT

HOSE BIBB

AIR LINE QUICK CONNECT

FLOOR DRAIN OR FLOOR SINK

PRESSURE GAUGE w/ SYPHON & COCK

PRESSURE REDUCING VALVE (PRV)

WATER HAMMER ARRESTER

COMPRESSED AIR PIPING

SOFTENED WATER PIPING

OVERFLOW ROOF DRAIN PIPING

PROCESS COLD WATER PIPING (NON-POTABLE)

PROCESS HOT WATER PIPING (NON-POTABLE)

DESCRIPTION

DOMESTIC COLD WATER PIPING (DCW)

DOMESTIC HOT WATER PIPING (DHW)

RECIRCULATING HOT WATER PIPING (DHR)


SANITARY SEWER PIPING (ABOVE GROUND)

SANITARY SEWER PIPING (UNDERGROUND)

SYMBOL

CONSULTANT

STAMP

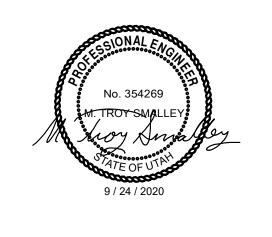

Dermatology

Tenant Improvement

5748 South Adams Avenue Washington Terrace, Utah

MARK DATE DESCRIPTION

9/24/2020 **ISSUE DATE:** 20330 PROJECT NO: **CAD DWG FILE** GM, JAC DRAWN BY: CHK'D BY: MTS


> Permit Set 24 September 2020


SHEET TITLE


PLUMBING SCHEDULES

SHEET NO:

P001

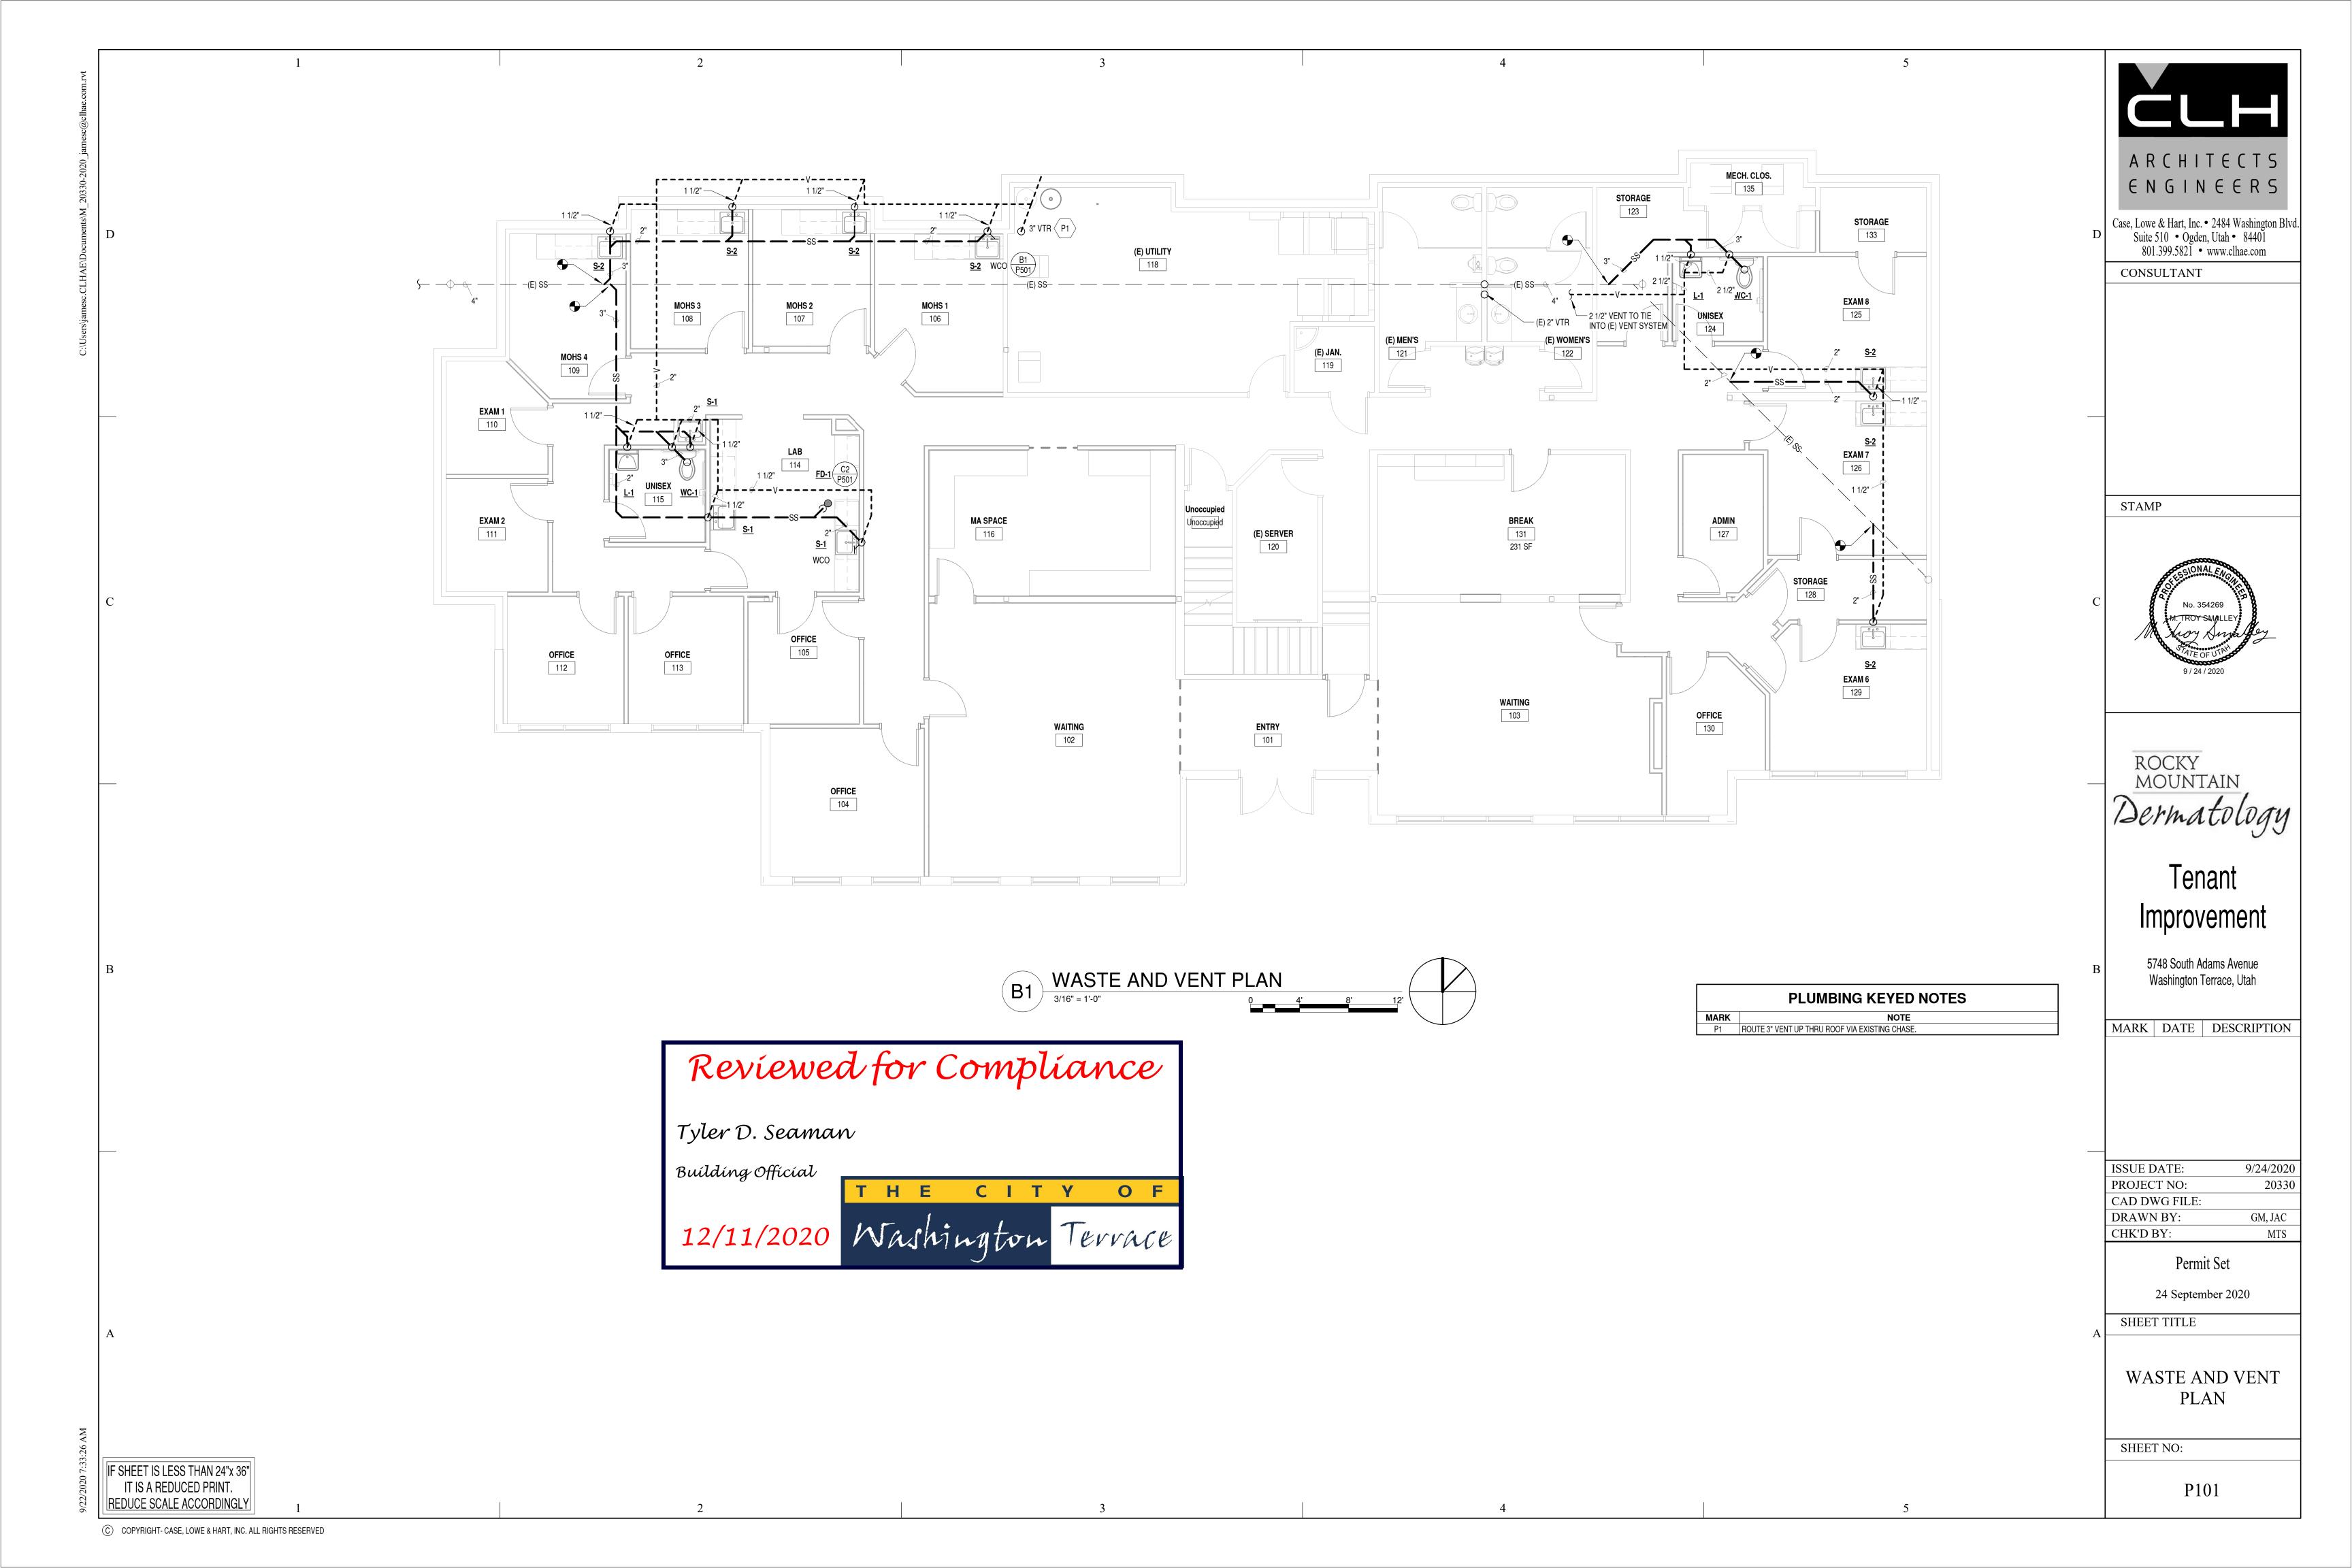

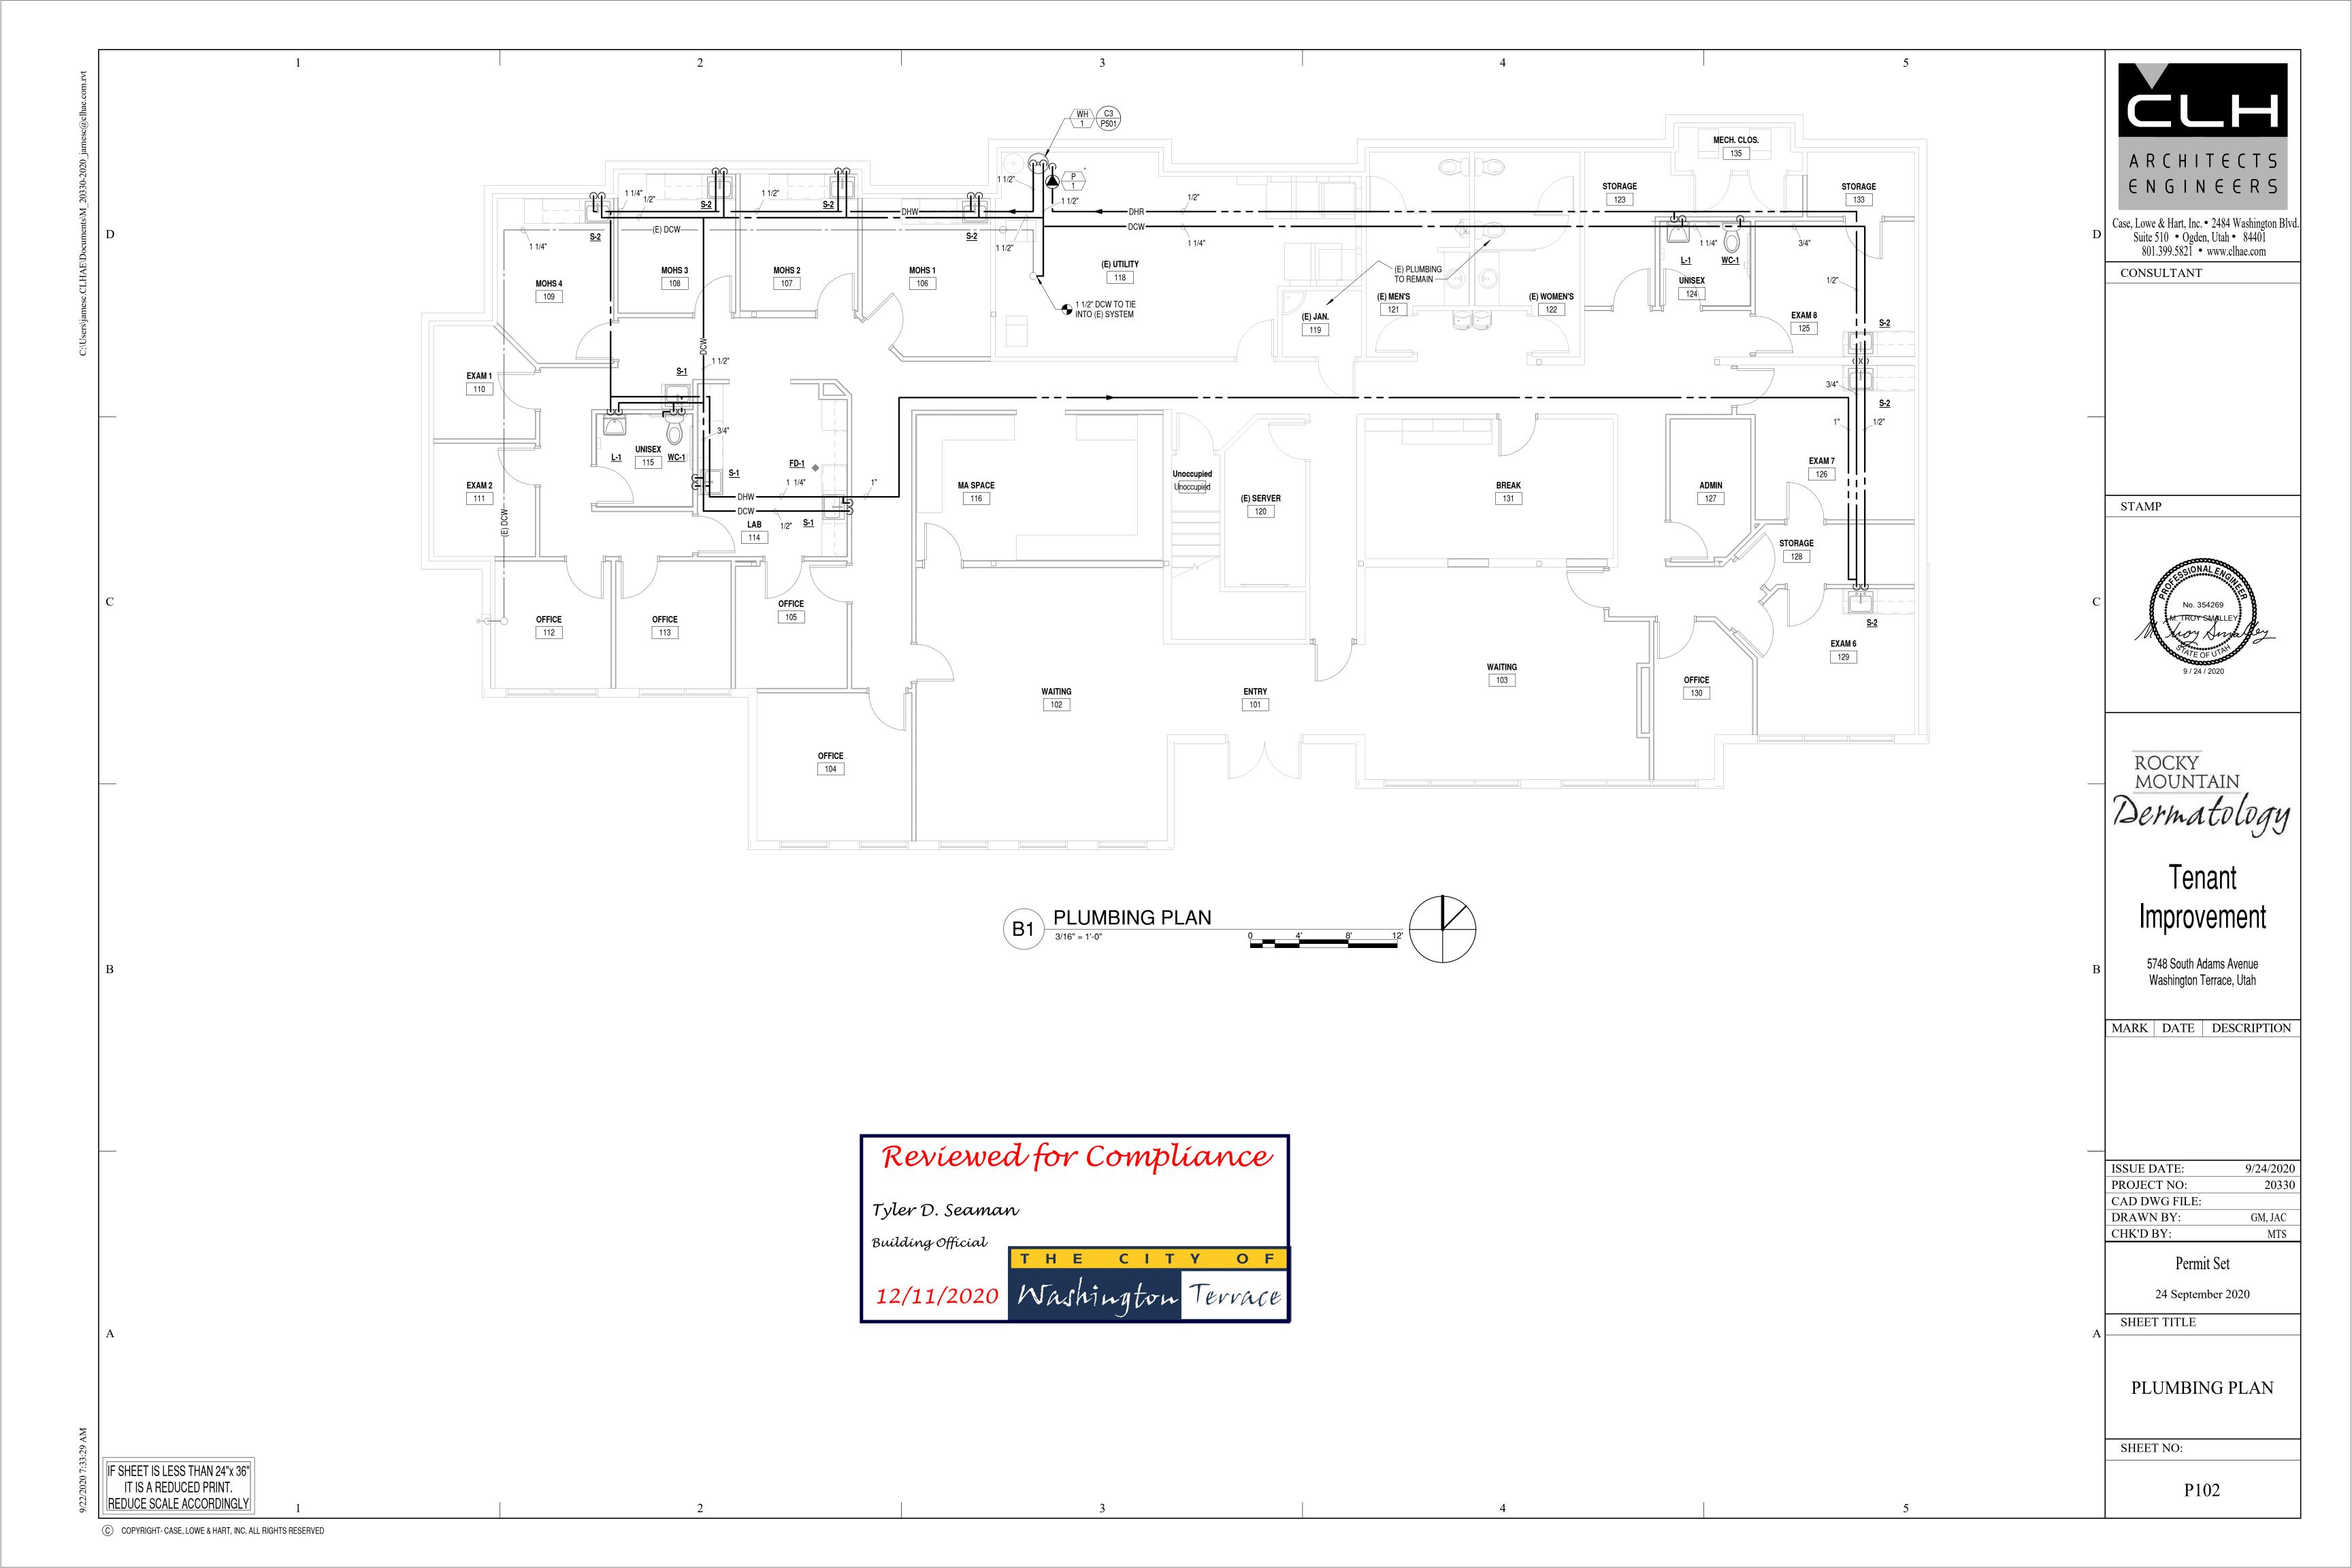

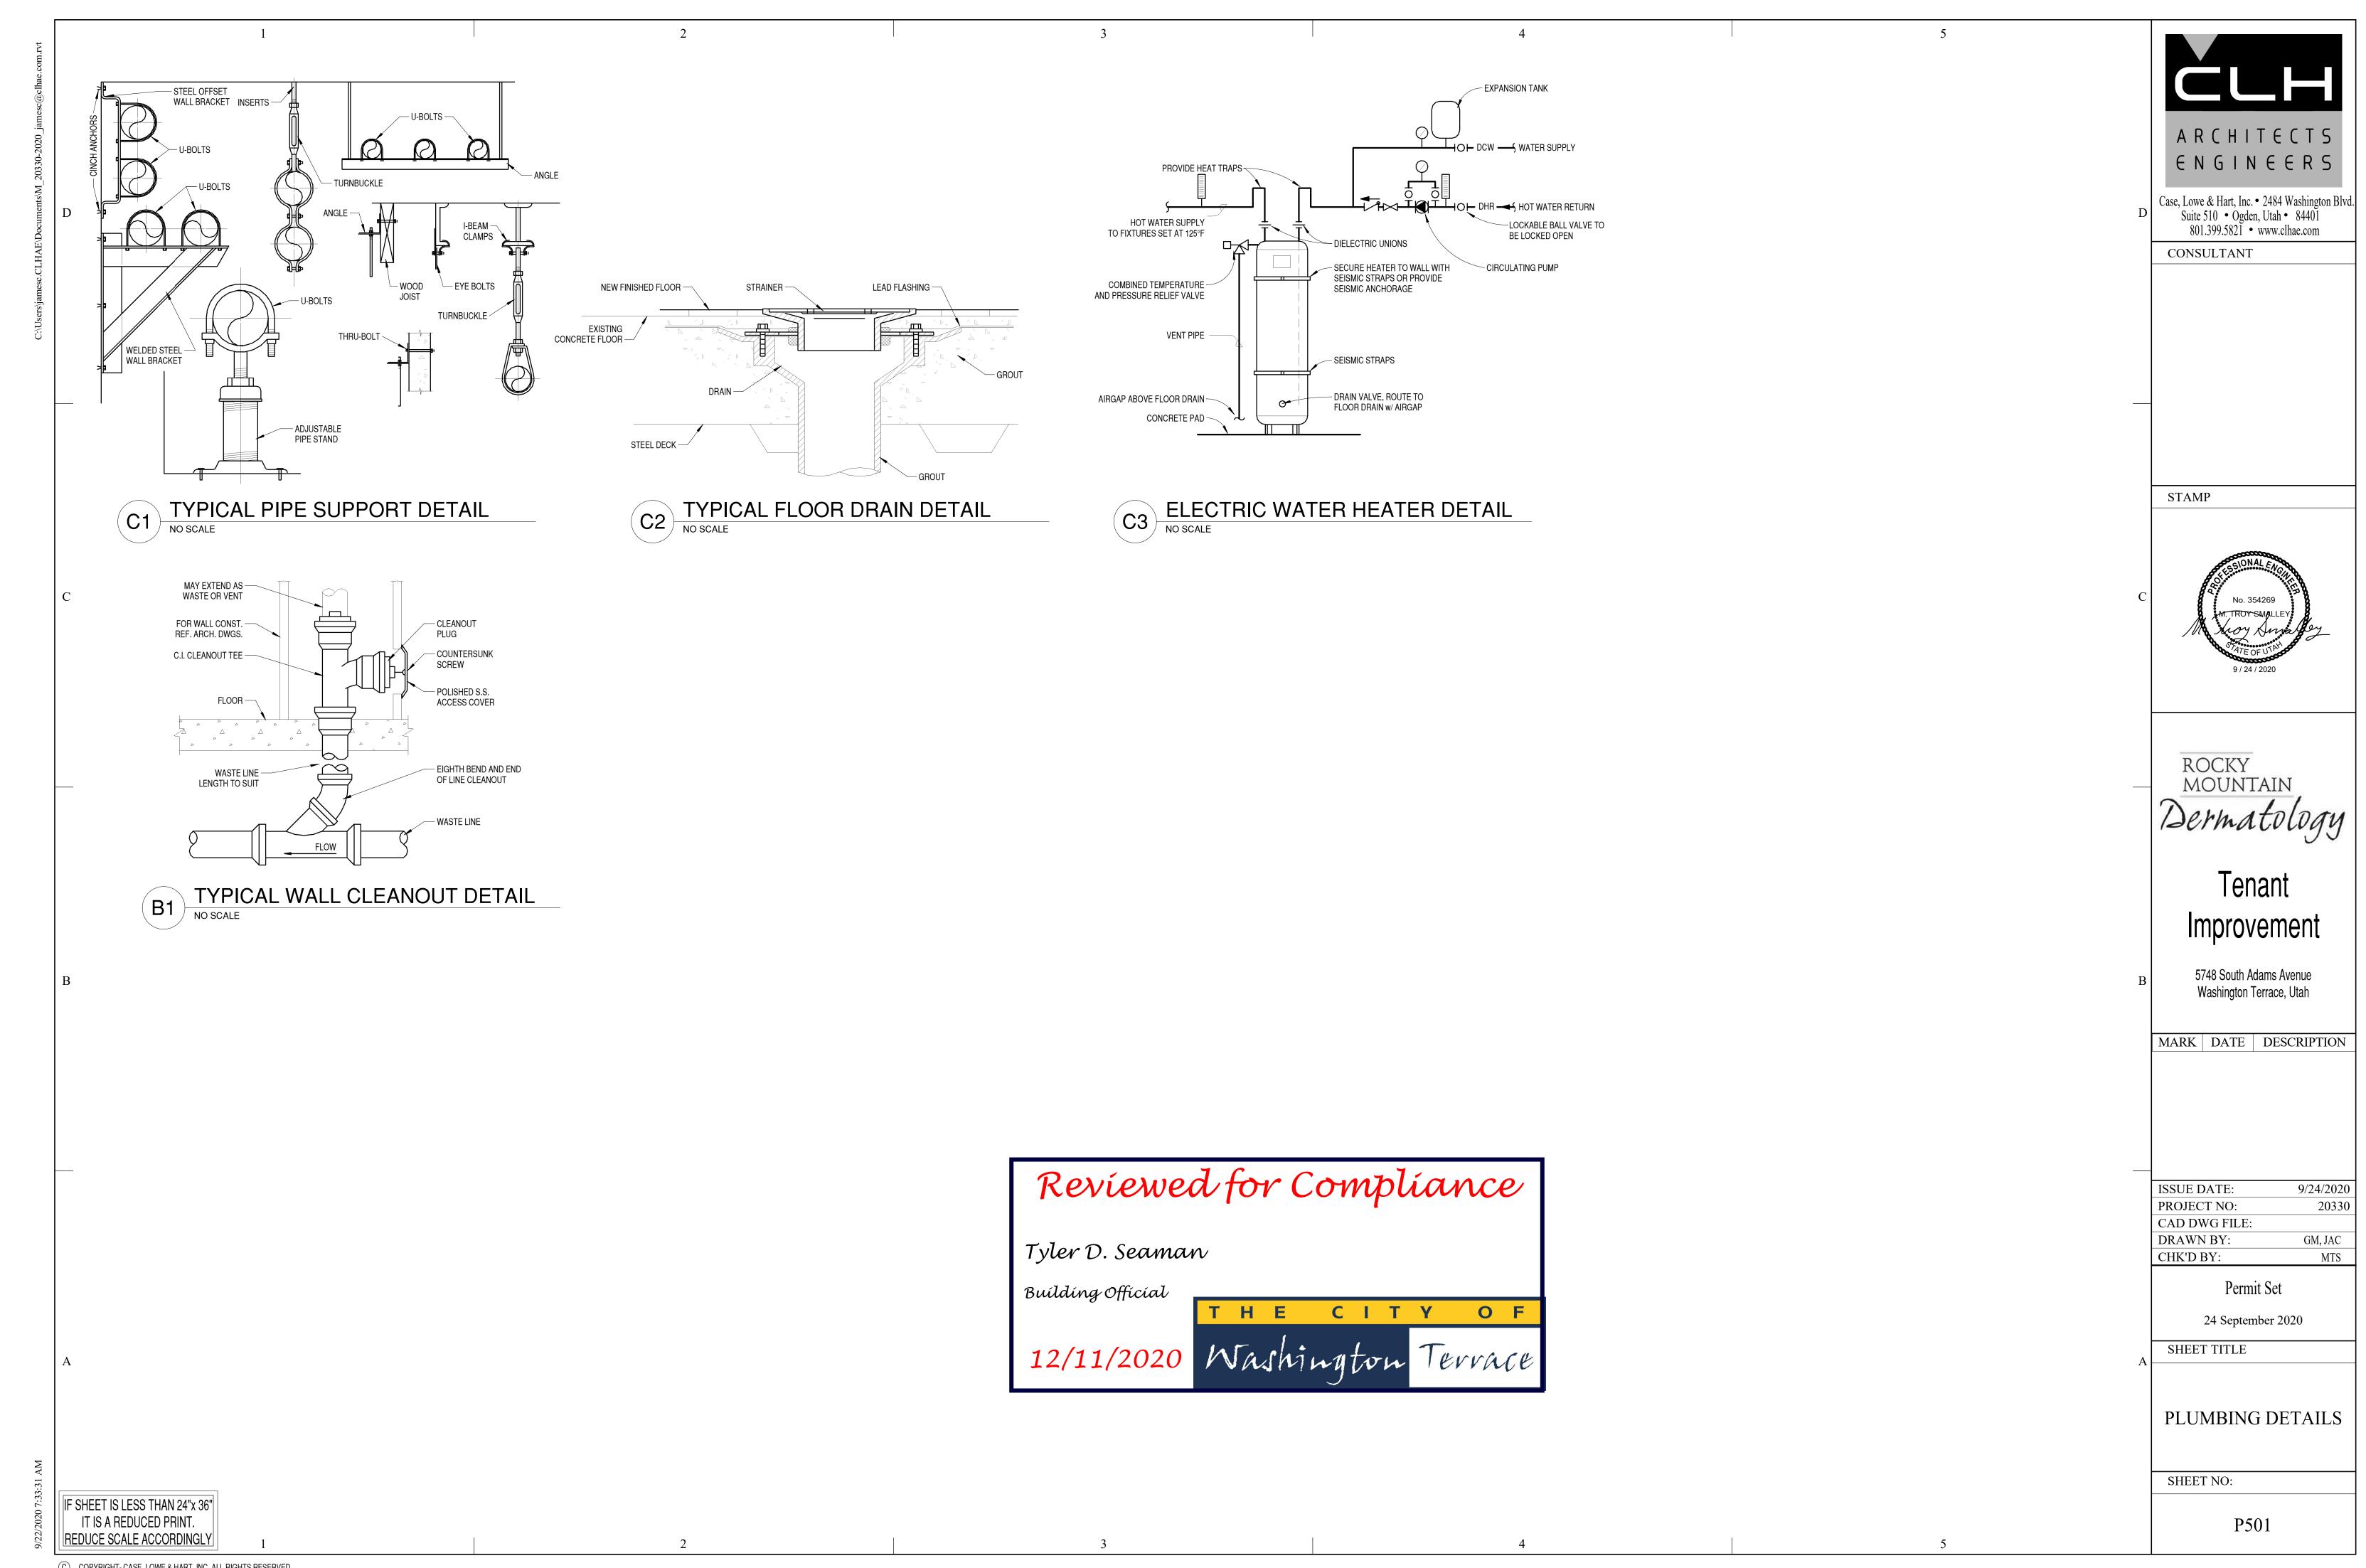

© COPYRIGHT- CASE, LOWE & HART, INC. ALL RIGHTS RESERVED

	EXHAUST FAN SCHEDULE													
	MANUFACTURER	NUEACTURER			STATIC	SOUND	ELECTRICAL		WEIGHT					
MARK	& MODEL	DESCRIPTION	AREA SERVED	CFM	PRESS. (IN WC)	RPM	RATING (dBA)	WATTS	VOLTS/ PHASE	(LBS)	NOTES			
EF-1	PRICE T100	CEILING VENTILATOR	UNISEX 115	90	0.25	940		8.4	120/1	25				
EF-2	GREENHECK SQ-90 VG	INLINE FAN	EAST SUITE	330	0.5	1645	56	1/6 HP	120/1	50				

	GRILLE, REGISTER & DIFFUSER SCHEDULE												
MARK	MANUFACTURER & MODEL	DESCRIPTION	MATERIAL	FINISH	FRAME	DAMPER	MAX NC	MAX CFM	NECK SIZE	MODULE SIZE (in)	NOTES		
S-1	PRICE SCD	LAY-IN SQUARE CONE	ALUMINUM	WHITE	CEILING GRID	10"	30	545	10" RND	20 X 20			
R-1	PRICE PDR	PERFORATED RETURN	ALUMINUM	WHITE	CEILING GRID		29	625	10 X 10	12 X 12			
R-2	PRICE PDR	PERFORATED RETURN	ALUMINUM	WHITE	CEILING GRID		25	750	10 X 22	10 X 22			
R-3	PRICE PDR	PERFORATED RETURN	ALUMINUM	WHITE	CEILING GRID		26	2353	22 X 22	22 X 22			

	GAS FURNACE SCHEDULE																
MARK	MANUFACTURER & MODEL	AREA SERVED	CFM	ESP ("WC)	GAS TYPE	HTG CAPACITY (MBH)	NOTES										
F-1 (EXIST)	LENNOX 48CXA1A	NORTH EAST	1600	1	NG	48											
F-2 (EXIST)	COLEMAN CE60C3XC1A	SOUTH EAST	2000	1	NG	60											
F-3 (EXIST)	COLEMAN CE60C3XC1A	NORTH WEST	2000	1	NG	60											
F-3 (EXIST)	NORTH WEST 2000 1 NG 60																
NOTE:	OUTPUT CAPACITY	SHOWN AT 443	39' ABO'	VE SEA I	EVEL.	NOTE: OUTPUT CAPACITY SHOWN AT 4439' ABOVE SEA LEVEL.											

DUOT TYPE		DUCT LOCATION	١	SMACNA
DUCT TYPE	EXTERIOR	UNCONDITIONED SPACE	CONDITIONED SPACE	SEAL CLASS
SUPPLY	R-12 / R-8	R-6	NONE	Α
RETURN	R-12 / R-8	R-6	NONE	А
EXHAUST	NONE	NONE	NONE	А


	MECHAN	ICAL LEGEND
	SYMBOL	DESCRIPTION
	L	LIQUID REFRIGERANT
	s	SUCTION REFRIGERANT
	OR T	MANUAL VOLUME CONTROL DAMPER
_	OR 🔀	EXHAUST AIR DUCT - UP / DOWN
	OR 🖊	RETURN/OUTSIDE AIR DUCT - UP / DOWN
	OR 🔀	SUPPLY AIR DUCT - UP / DOWN
		MITERED ELBOW W/ TURNING VANES
	TITT OR HHH	FLEX DUCT (MAX. LENGTH 4 FT.)
	1	THERMOSTAT
_		EQUIPMENT SYMBOL
	DET# SHT#	DETAIL SYMBOL
	M1	SHEET KEYNOTE
4	•	POINT OF CONNECTION
	•	POINT OF DISCONNECTION
1		AIRFLOW DIRECTION
-	AFF (E)	ABOVE FINISH FLOOR EXISTING
	N.I.C.	NOT IN CONTRACT
	N.O.	NORMALLY OPEN
1	N.C.	NORMALLY CLOSED
	TYP	TYPICAL
	1	

MECHANICAL GENERAL NOTES:

- I. ALL EQUIPMENT MANUFACTURES SHOWN AS A BASIS OF DESIGN. NOT INTENDED TO SOLE SOURCE EQUIPMENT MANUFACTURER.
- 2. ALL EQUIPMENT SHALL BE INSTALLED IN ACCORDANCE WITH THE LATEST STATE ADOPTED EDITION OF THE INTERNATIONAL MECHANICAL CODE AND
- 3. MECHANICAL PLANS ARE DIAGRAMMATIC ONLY. CONTRACTOR SHALL COORDINATE THEIR WORK WITH OTHER TRADES, AND ACTUAL JOB SITE CONDITIONS. CONTRACTOR TOFIELD VERIFY QUANTITIES AND DIMENSIONS.
- 4. CONTRACTOR TO PROVIDE ALL NECESSARY MATERIALS, DUCTWORK, HANGERS, FITTINGS, OFFSETS, INSULATION AND ACCESSORIES LOGICALLY REQUIRED FOR A COMPLETE FUNCTIONAL AIR DELIVERY SYSTEM.
- DUCTWORK GAUGE TO BE 26 GAUGE.

5. DUCT DIMENSIONS ON DRAWINGS ARE INSIDE DIMENSIONS. MINIMUM

- 6. CONTRACTOR SHALL COORDINATE ALL SUPPLY DIFFUSER PLACEMENTS.
- 7. ALL SQUARE ELBOWS IN SUPPLY AND RETURN DUCTWORK SHALL HAVE SINGLETHICKNESS TURNING VANES.
- 8. INSULATED FLEXIBLE DUCT NOT TO EXCEED 4 FEET IN LENGTH.
- 9. CONNECTIONS TO SUPPLY DIFFUSERS TO BE MADE WITH A RIDGED CONNECTION SO THAT CLEAR AND UNOBSTRUCTED AIRFLOW IS ACHIEVED.
- 10. MOUNT BOTTOM OF THERMOSTAT 48 INCHES ABOVE FINISHED FLOOR. RUN WIRING FROM THERMOSTAT LOCATION TO AIR HANDLER AND TERMINATE TO PROVIDE FOR A FULLY FUNCTIONAL SYSTEM. REFER TO THE CONTROL DRAWINGS FOR SPECIFICS.
- 11. CONTRACTOR TO FURNISH FILTERS.
- 12. MAIN SUPPLY DUCTS ARE TO REMAIN AS EXISTING. ALL EXISTING RUNOUTS ARE TO BE REMOVED, ALONG WITH OBD CAP SEAL.
- 13. ALL PIPING THAT COMES IN CONTACT WITH A DISSIMILAR METAL TO BE PROTECTED AGAINST GALVANIC CORROSION.
- 14. REMOTE CONCEALED CEILING CABLE CONTROL SYSTEM REQUIRED FOR ALL MANUAL VOLUME DAMPERS IN HARD LID CEILING APPLICATIONS.
- 15. SEISMIC SUPPORTS ARE NOT REQUIRED FOR HVAC DUCTWORK IF DUCTS ARE SUSPENDED FROM HANGARS 12 INCH OR LESS IN LENGTH.
- 16. REFER TO STRUCTURAL DETAILS FOR ALL EQUIPMENT AND DUCT PENETRATIONS THROUGH ROOF. IF DETAIL IS NOT PRESENT THEN CONTACT
- 17. ALL EXPOSED DUCTWORK TO HAVE ALL LABELS AND WRITING REMOVED FROM DUCT.
- 18. AFTER AIR AND HYDRONIC SYSTEM BALANCING HAS BEEN COMPLETED, MARK ALL BALANCING DAMPER AND BALANCING VALVES TO PERMANENTLY INDICATE FINAL POSITION; IE AN ARROW OR DRAWING AN OUTLINE OF BALANCING HANDLE POSITION.

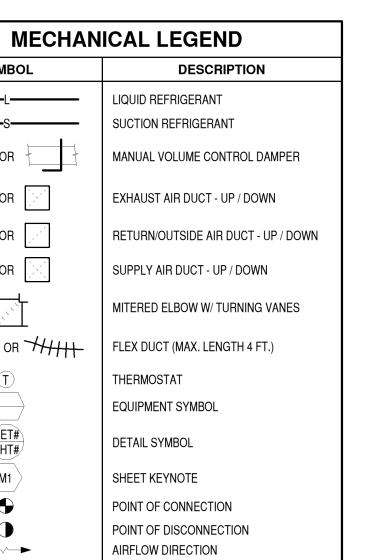





ARCHITECTS

ENGINEERS

Case, Lowe & Hart, Inc. • 2484 Washington Blvd. Suite 510 • Ogden, Utah • 84401 801.399.5821 • www.clhae.com

CONSULTANT

STAMP

Tenant Improvement

5748 South Adams Avenue Washington Terrace, Utah

MARK DATE DESCRIPTION

ISSUE DATE:	9/24/2020
PROJECT NO:	20330
CAD DWG FILE:	
DRAWN BY:	GM, JAC
CHK'D BY:	MTS

Permit Set

24 September 2020

SHEET TITLE

MECHANICAL

SCHEDULES


SHEET NO:


M001



© COPYRIGHT- CASE, LOWE & HART, INC. ALL RIGHTS RESERVED

IF SHEET IS LESS THAN 24"x 36" IT IS A REDUCED PRINT.

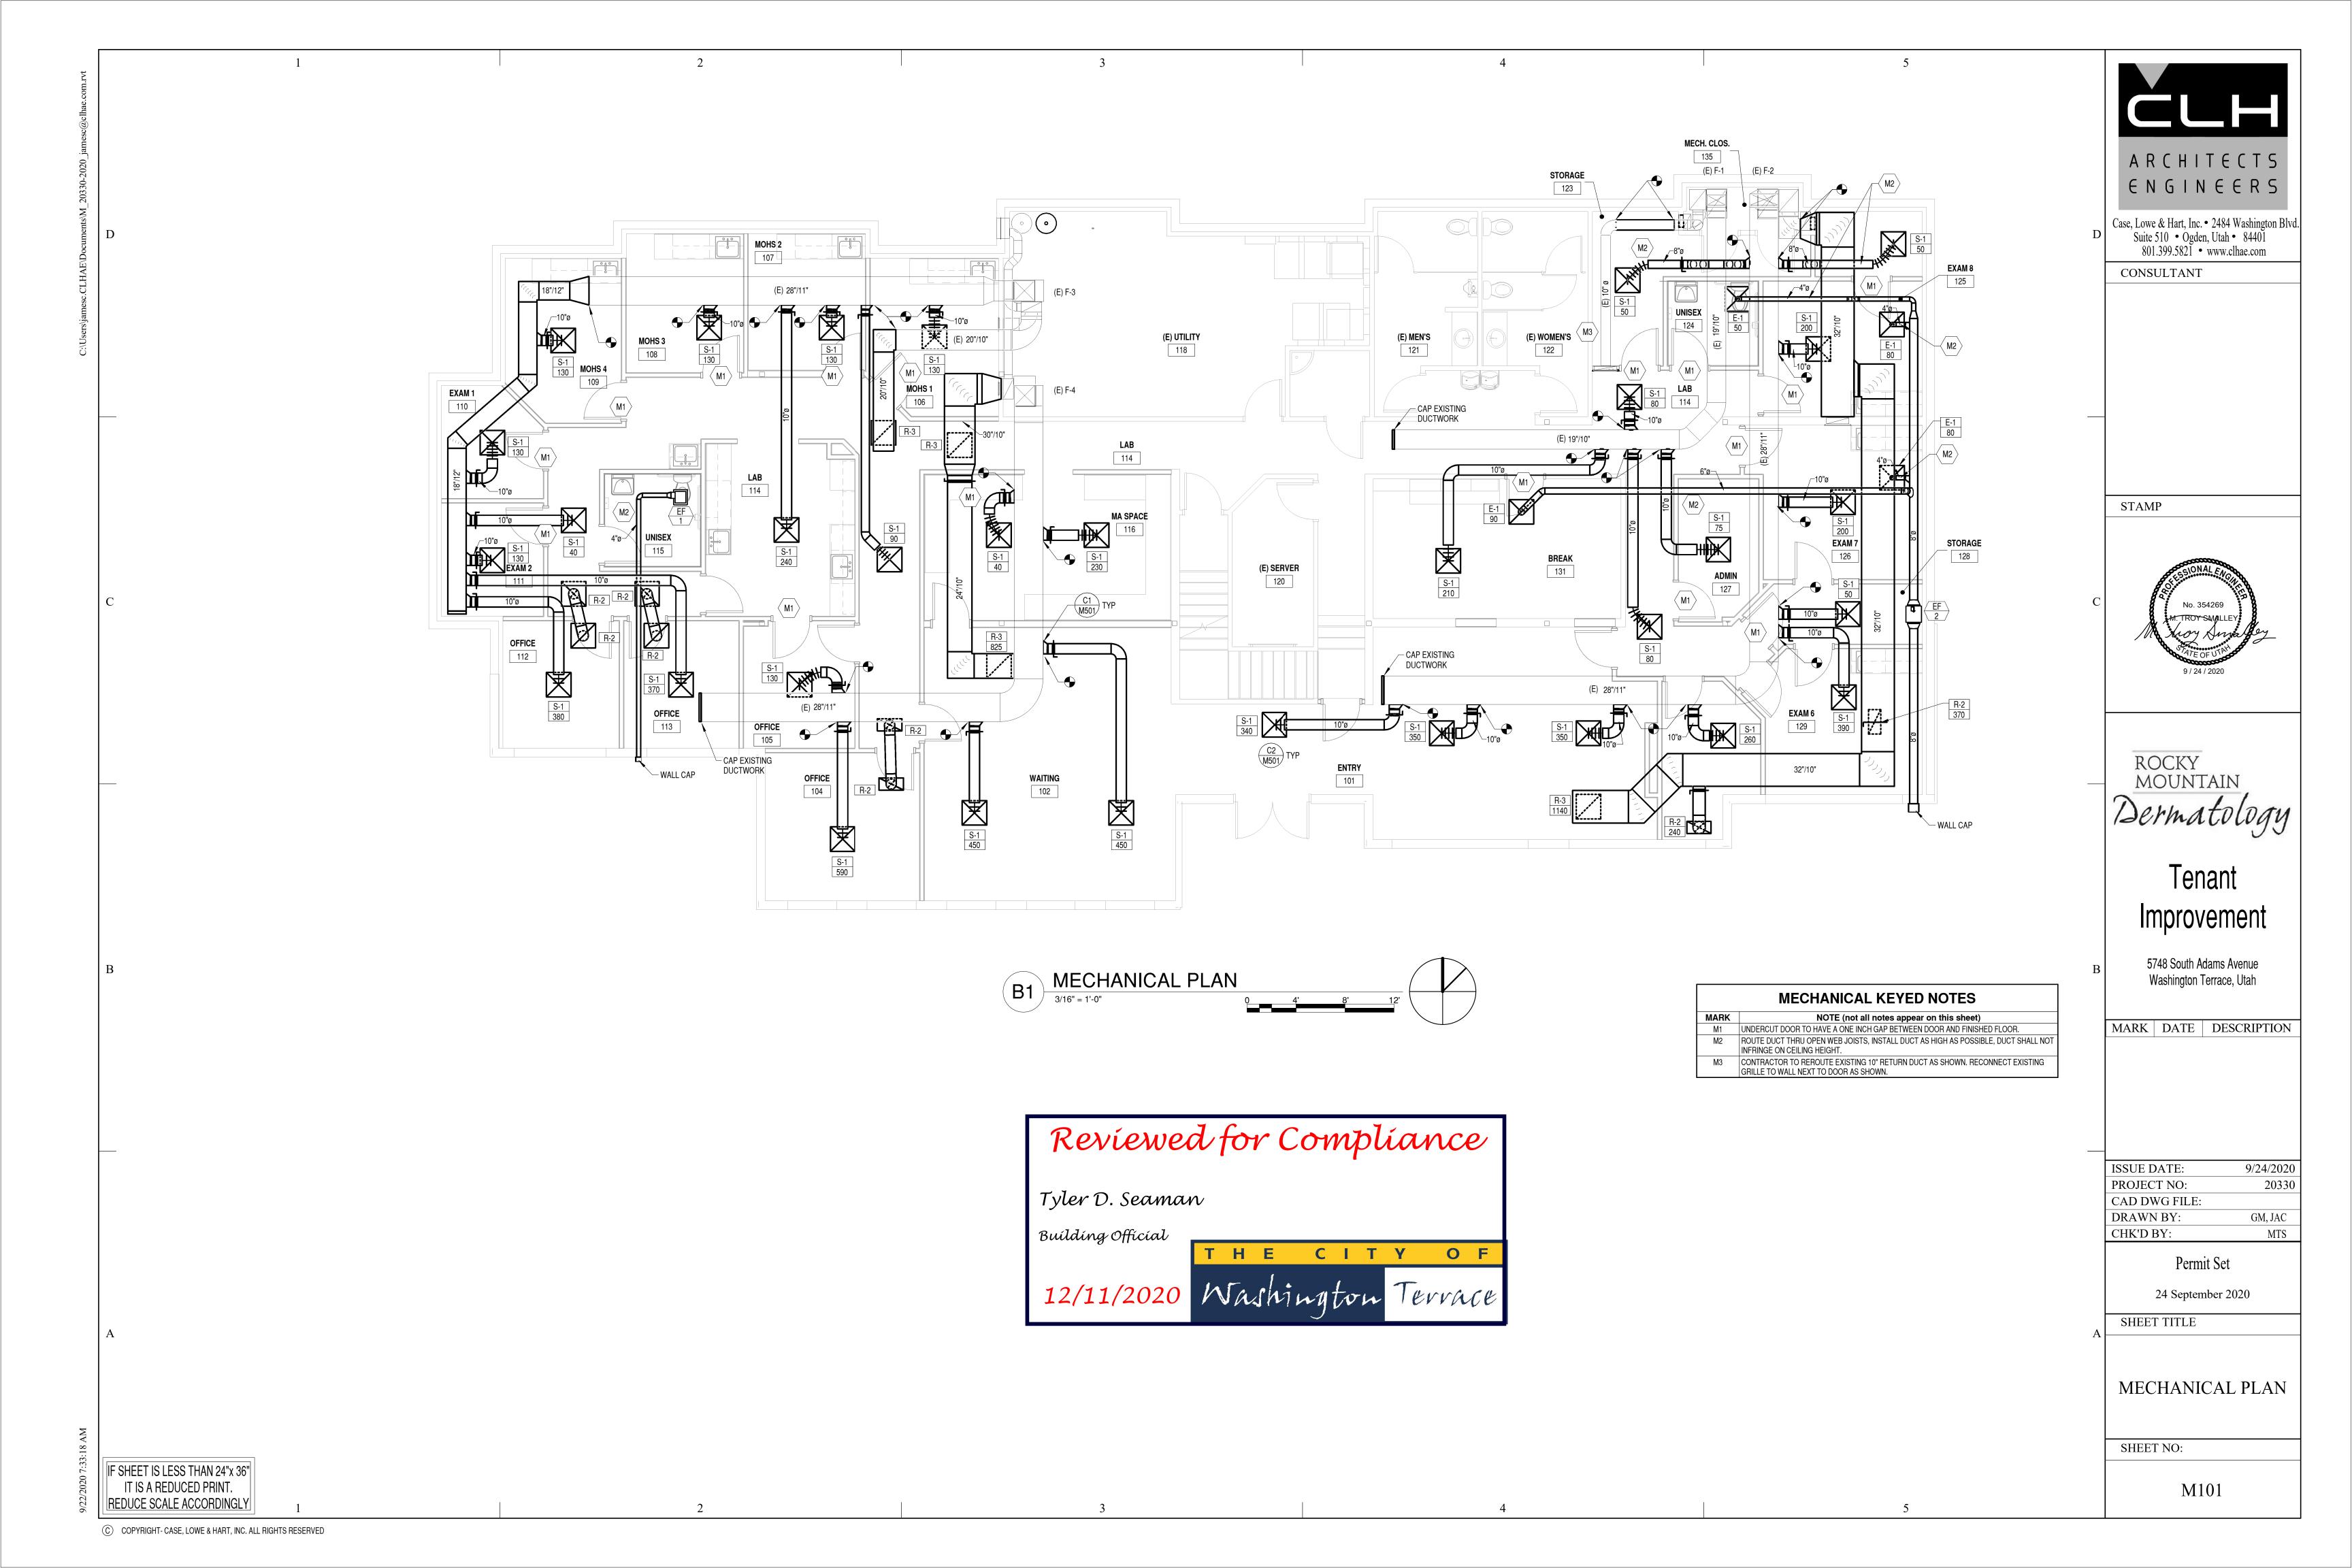

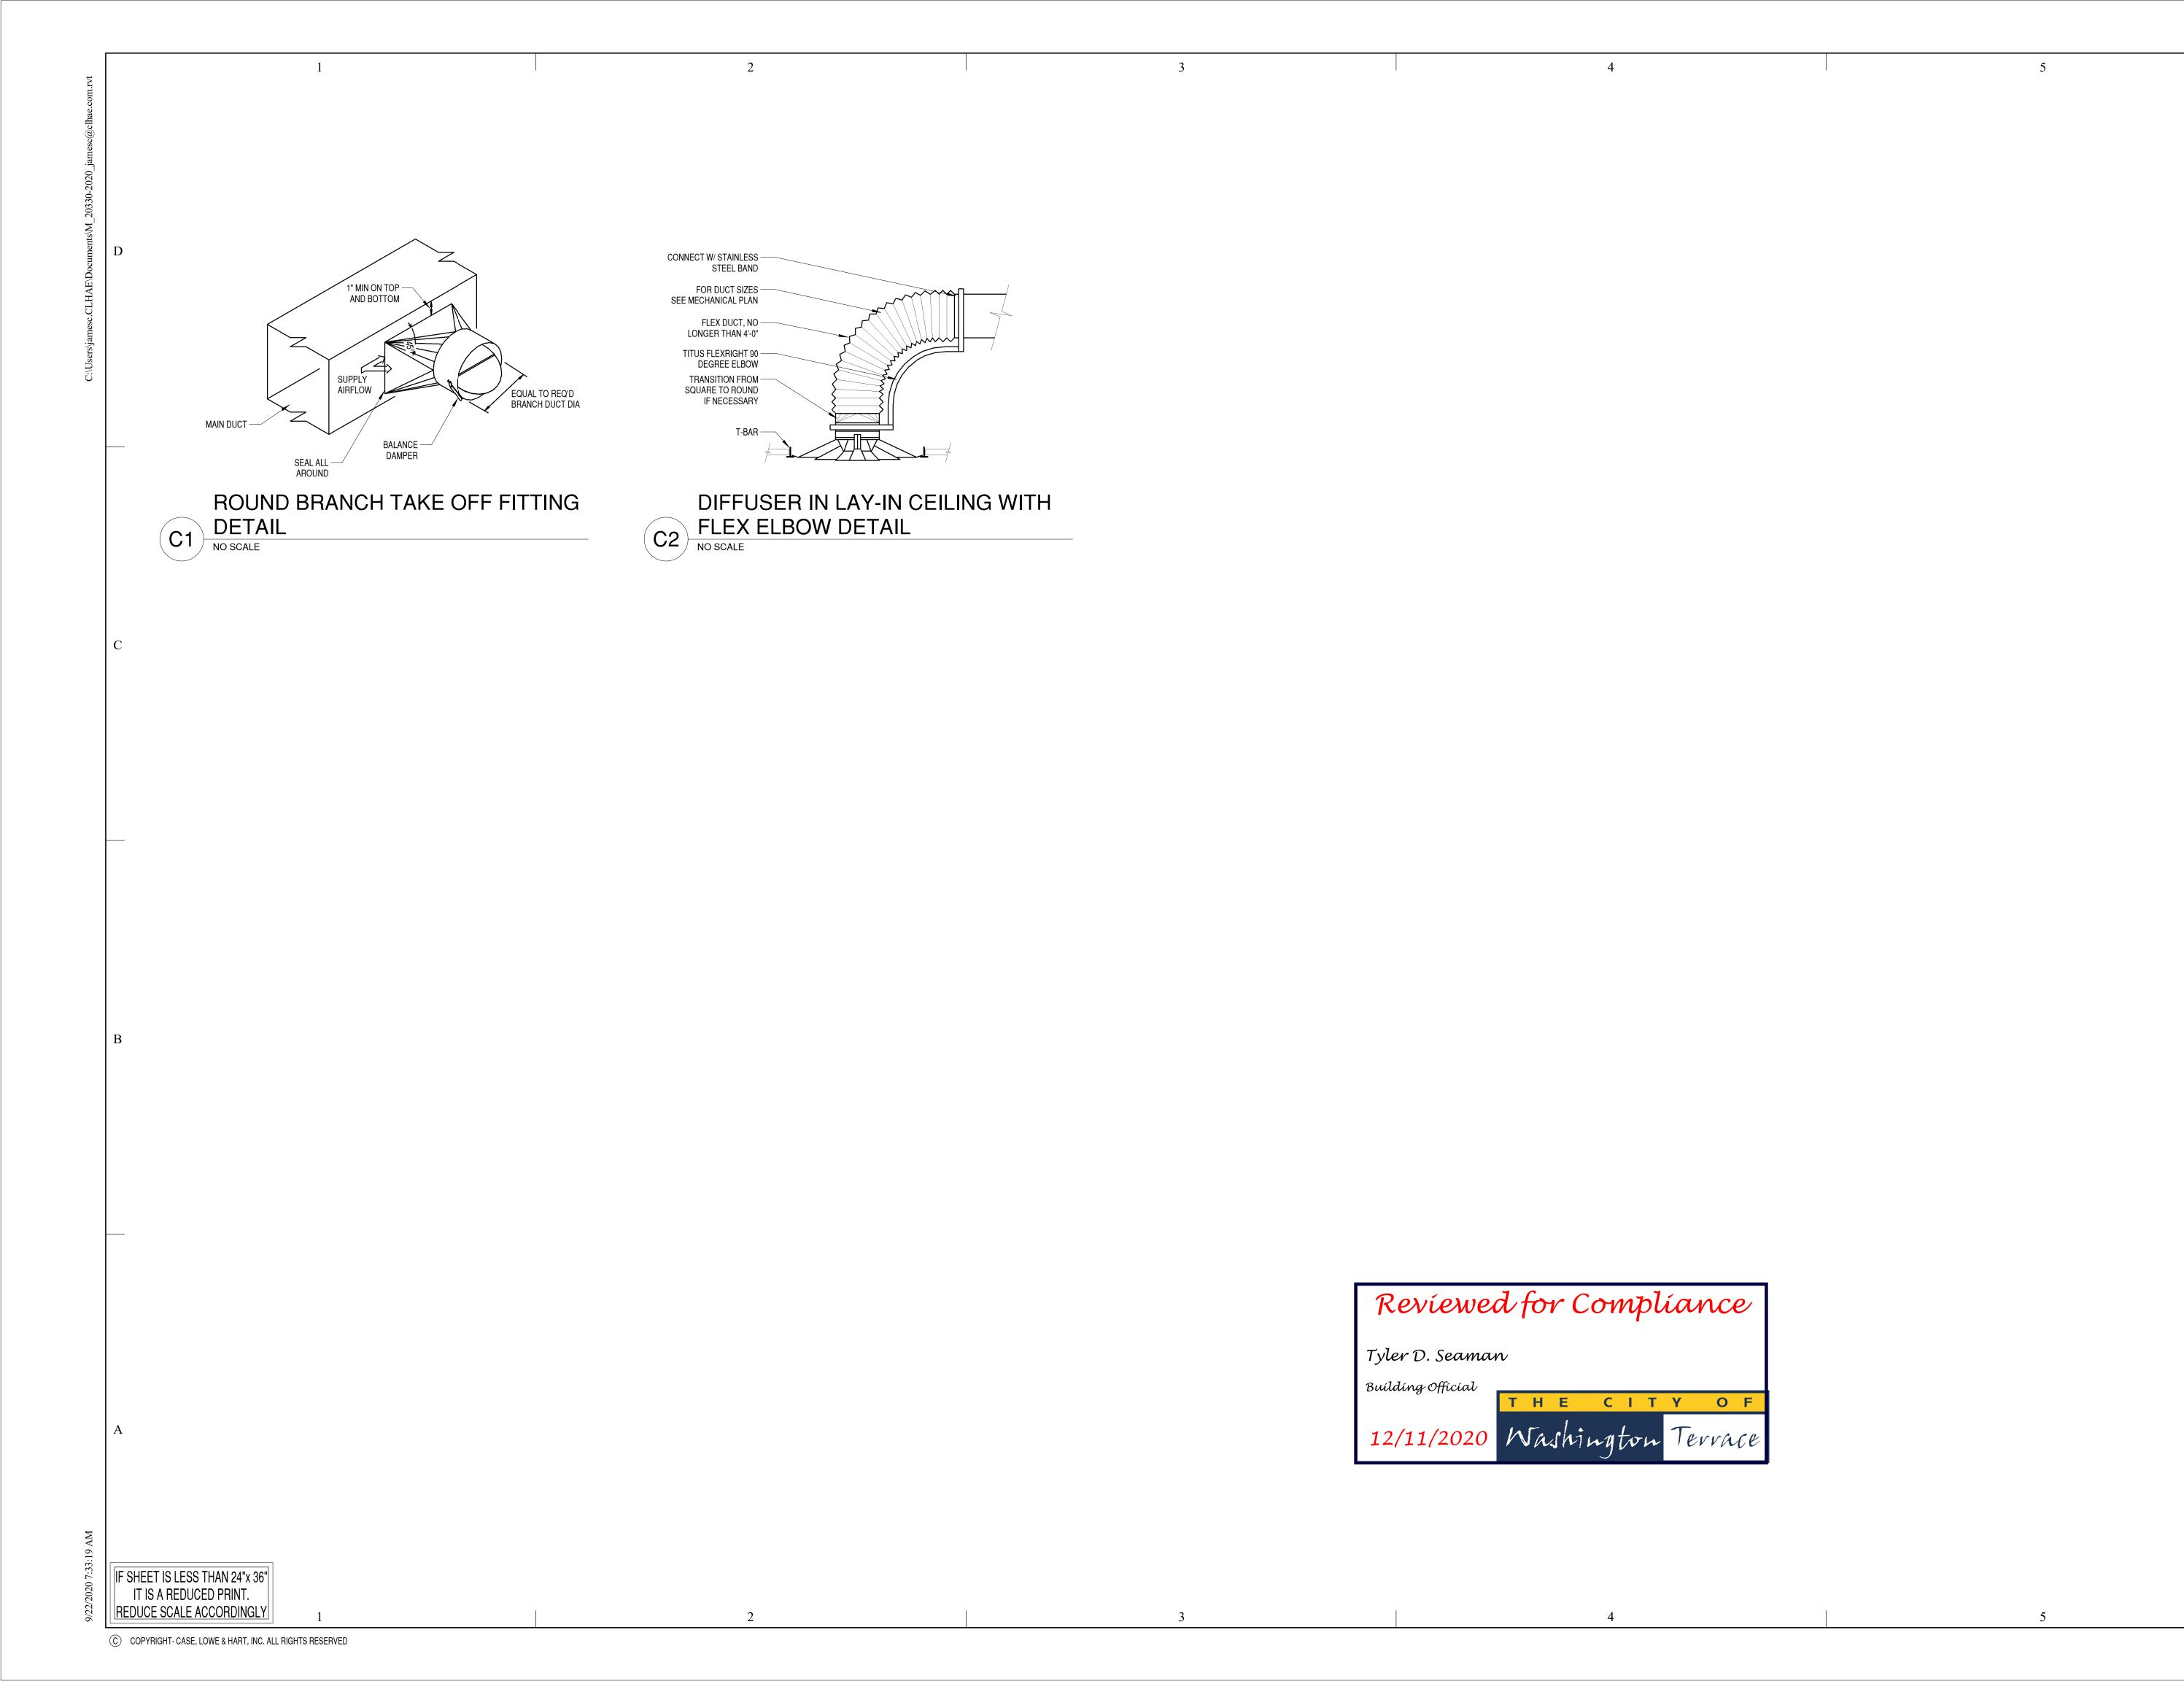


A R C H I T E C T S E N G I N E E R S

Case, Lowe & Hart, Inc. • 2484 Washington Blvd.
Suite 510 • Ogden, Utah • 84401
801.399.5821 • www.clhae.com

CONSULTANT

STAMP

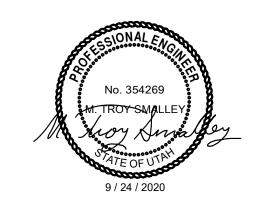



Tenant Improvement

5748 South Adams Avenue Washington Terrace, Utah

MARK DATE DESCRIPTION

ISSUE DATE:	9/24/202
PROJECT NO:	2033
CAD DWG FILE:	
DRAWN BY:	GM, JAC
CHK'D BY:	MTS

Permit Set


24 September 2020


SHEET TITLE


MECHANICAL DETAILS


SHEET NO:

M501

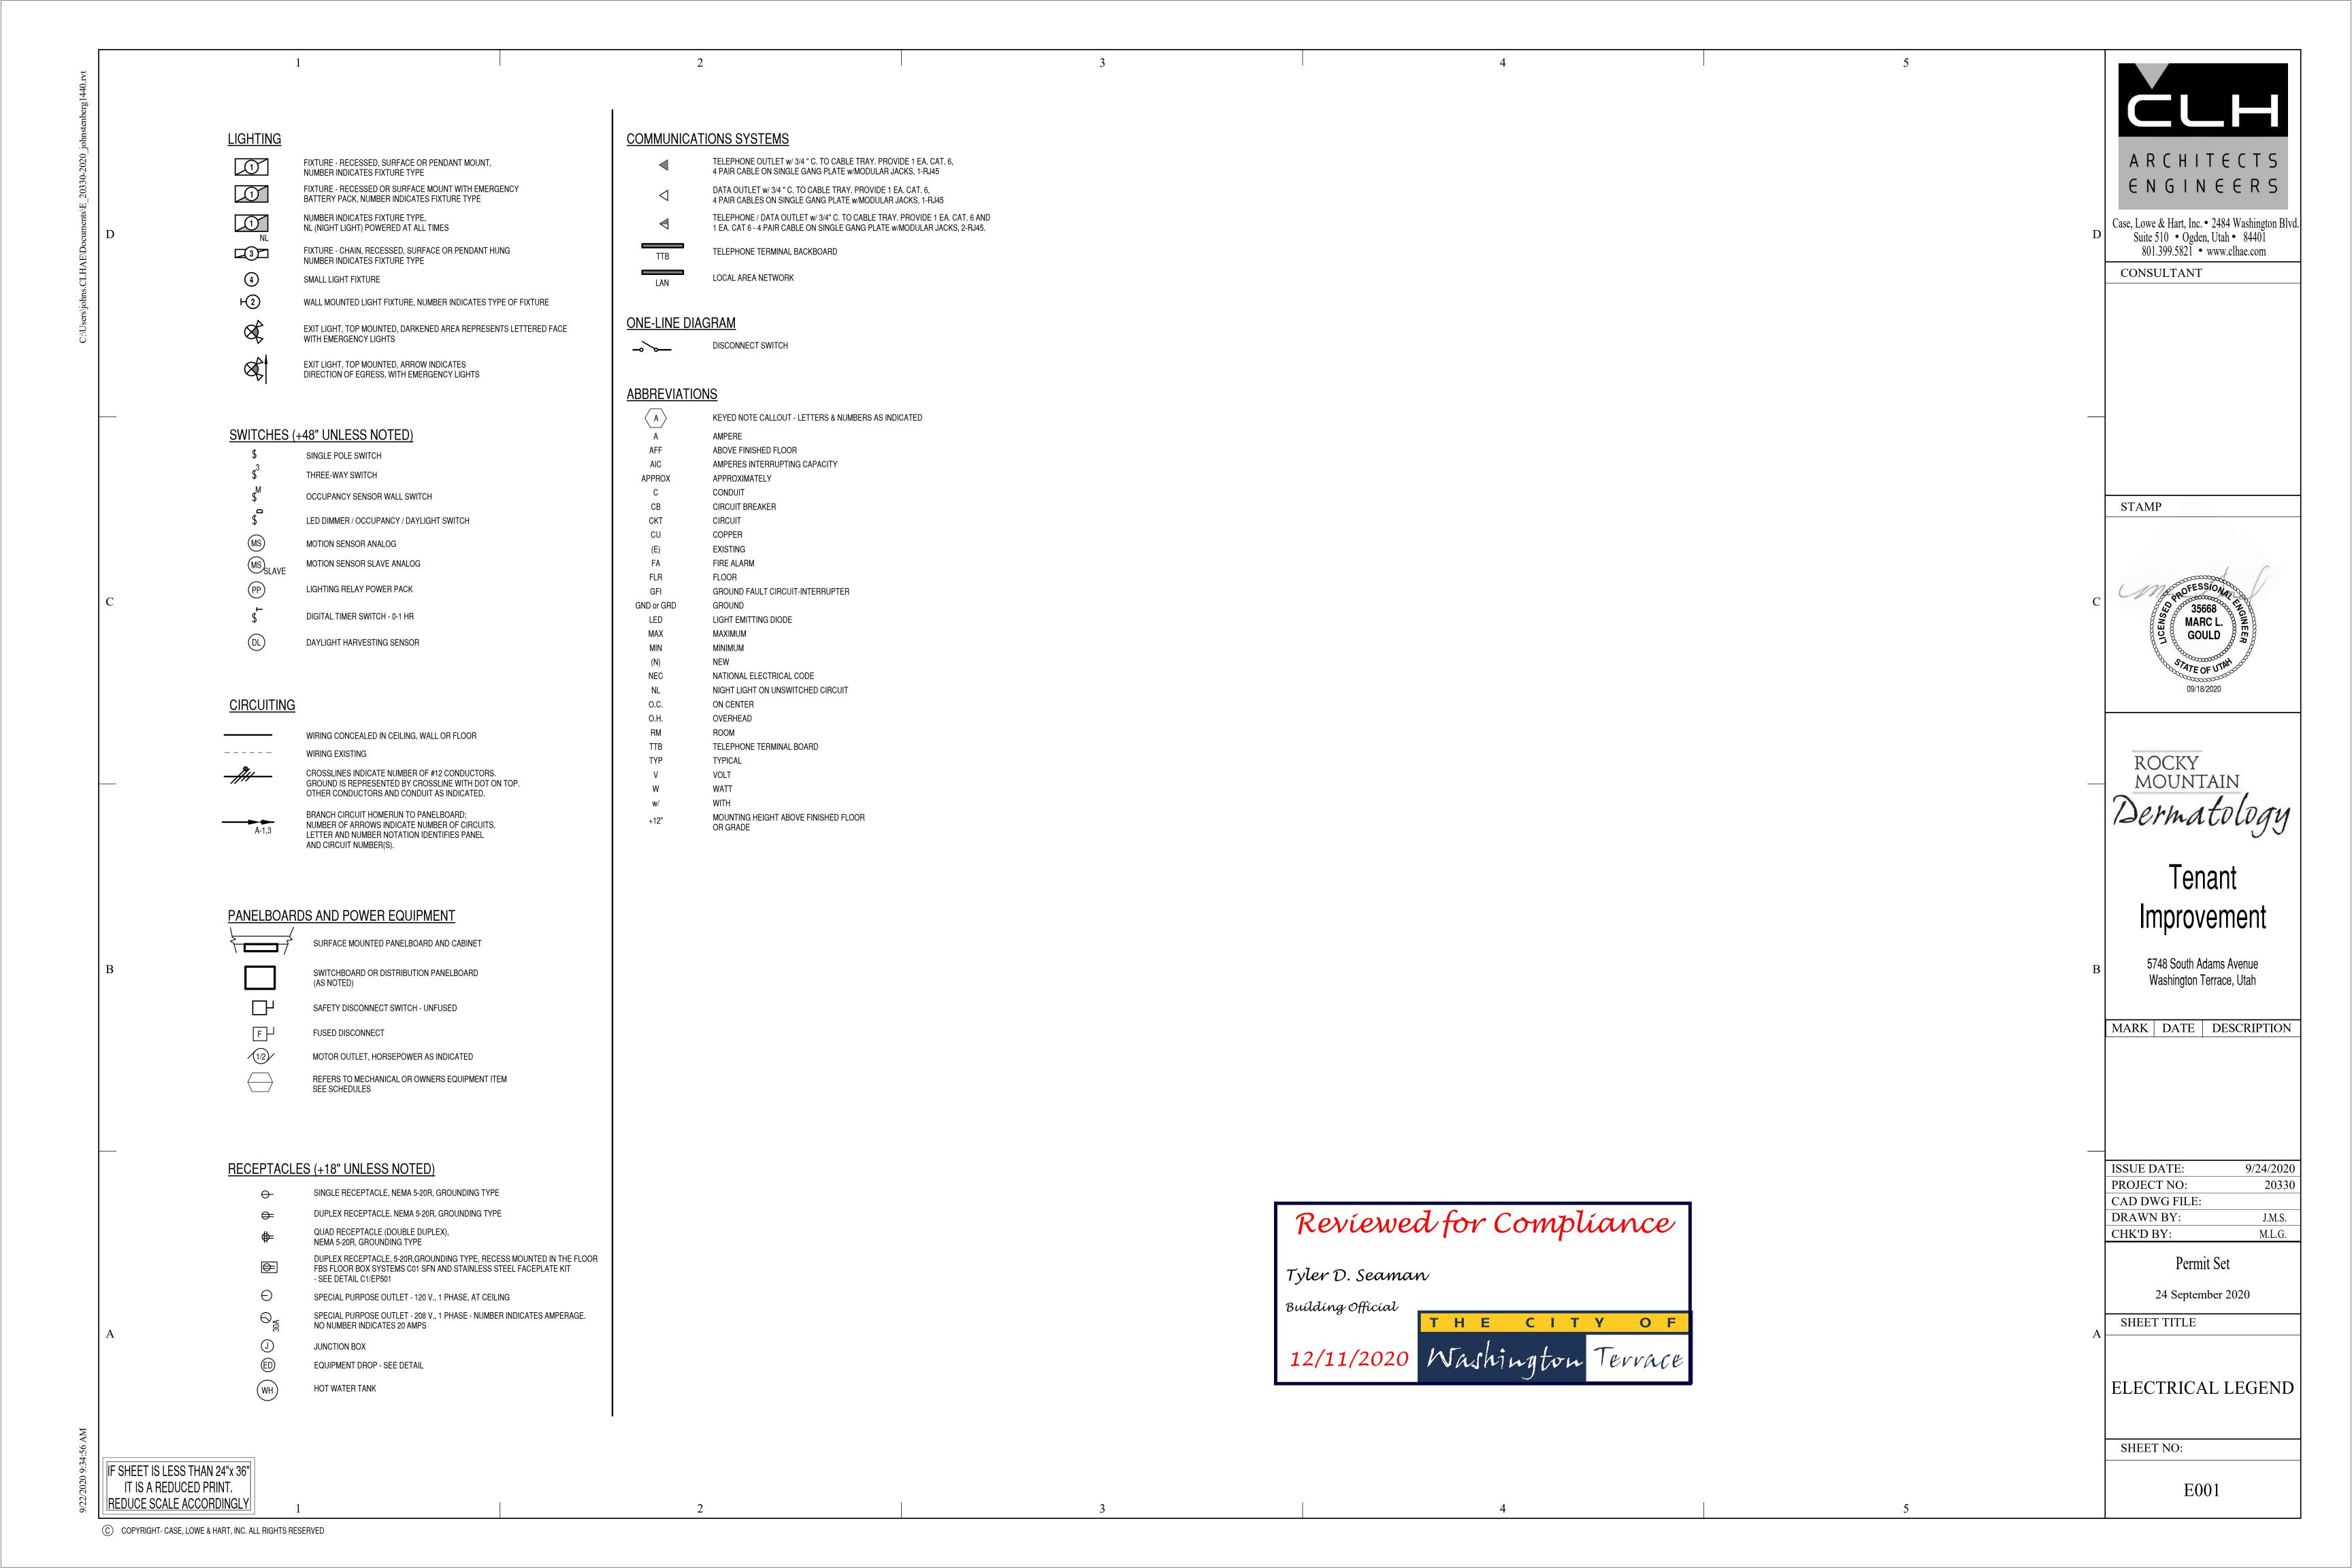

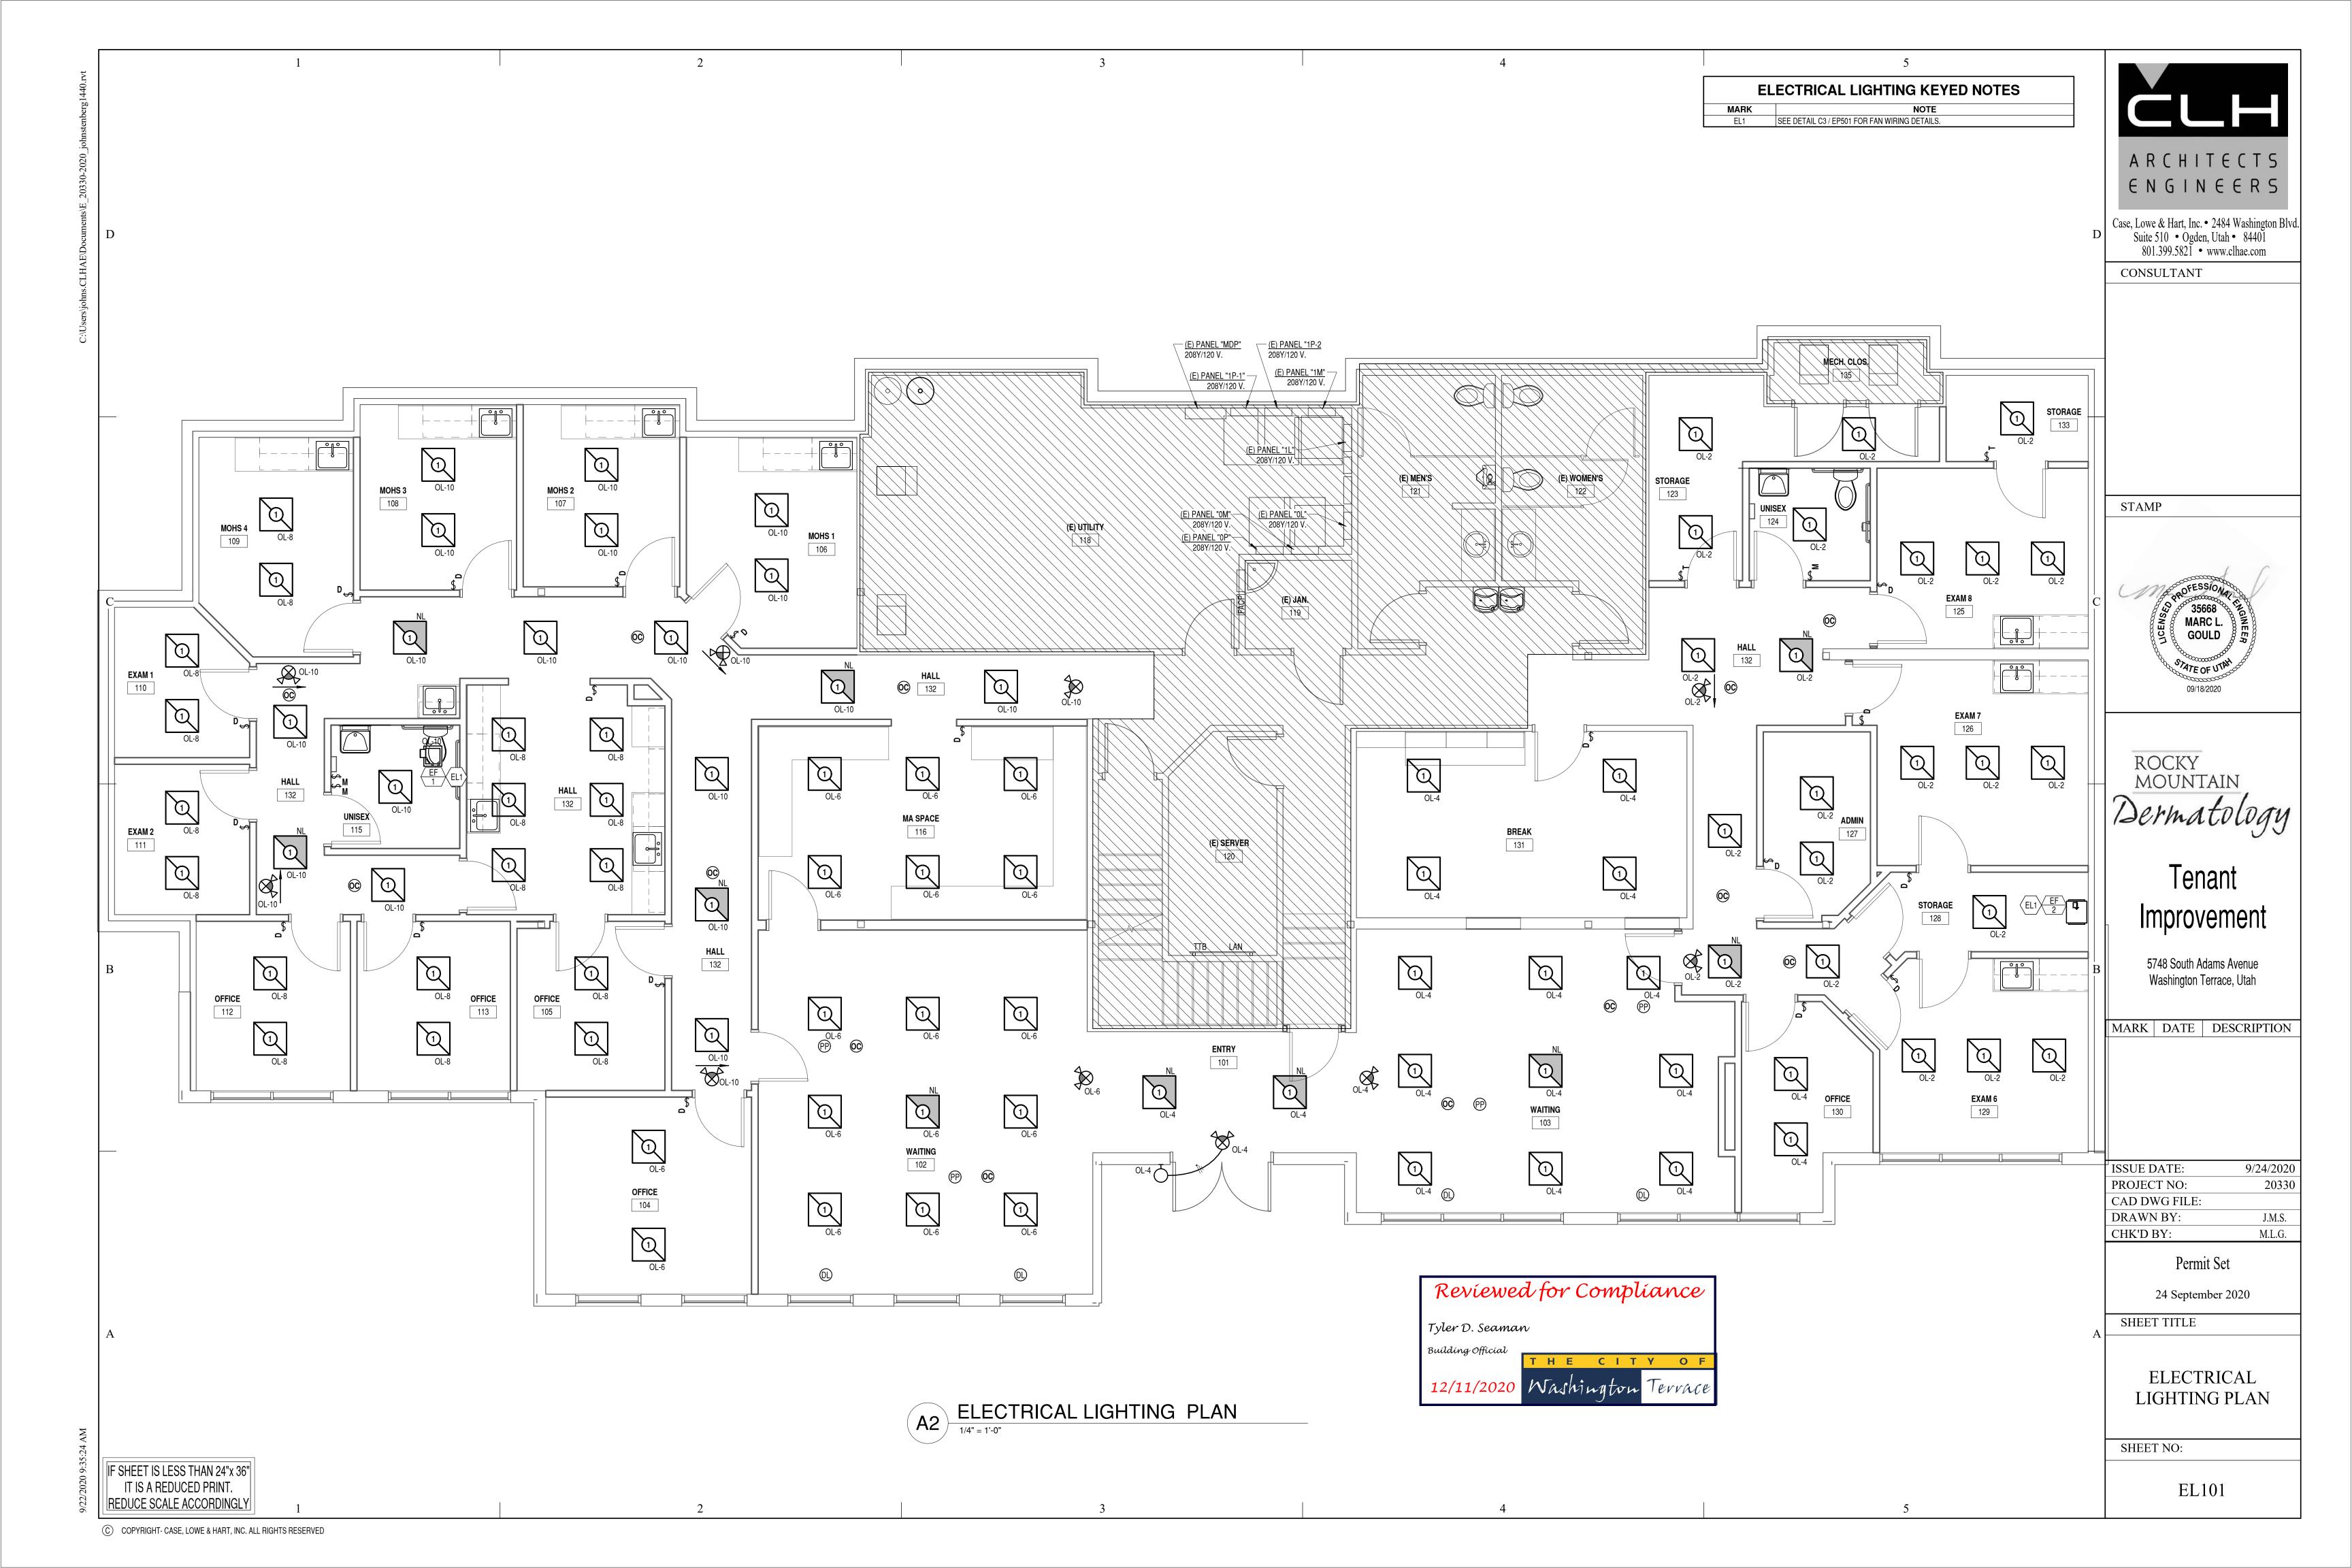

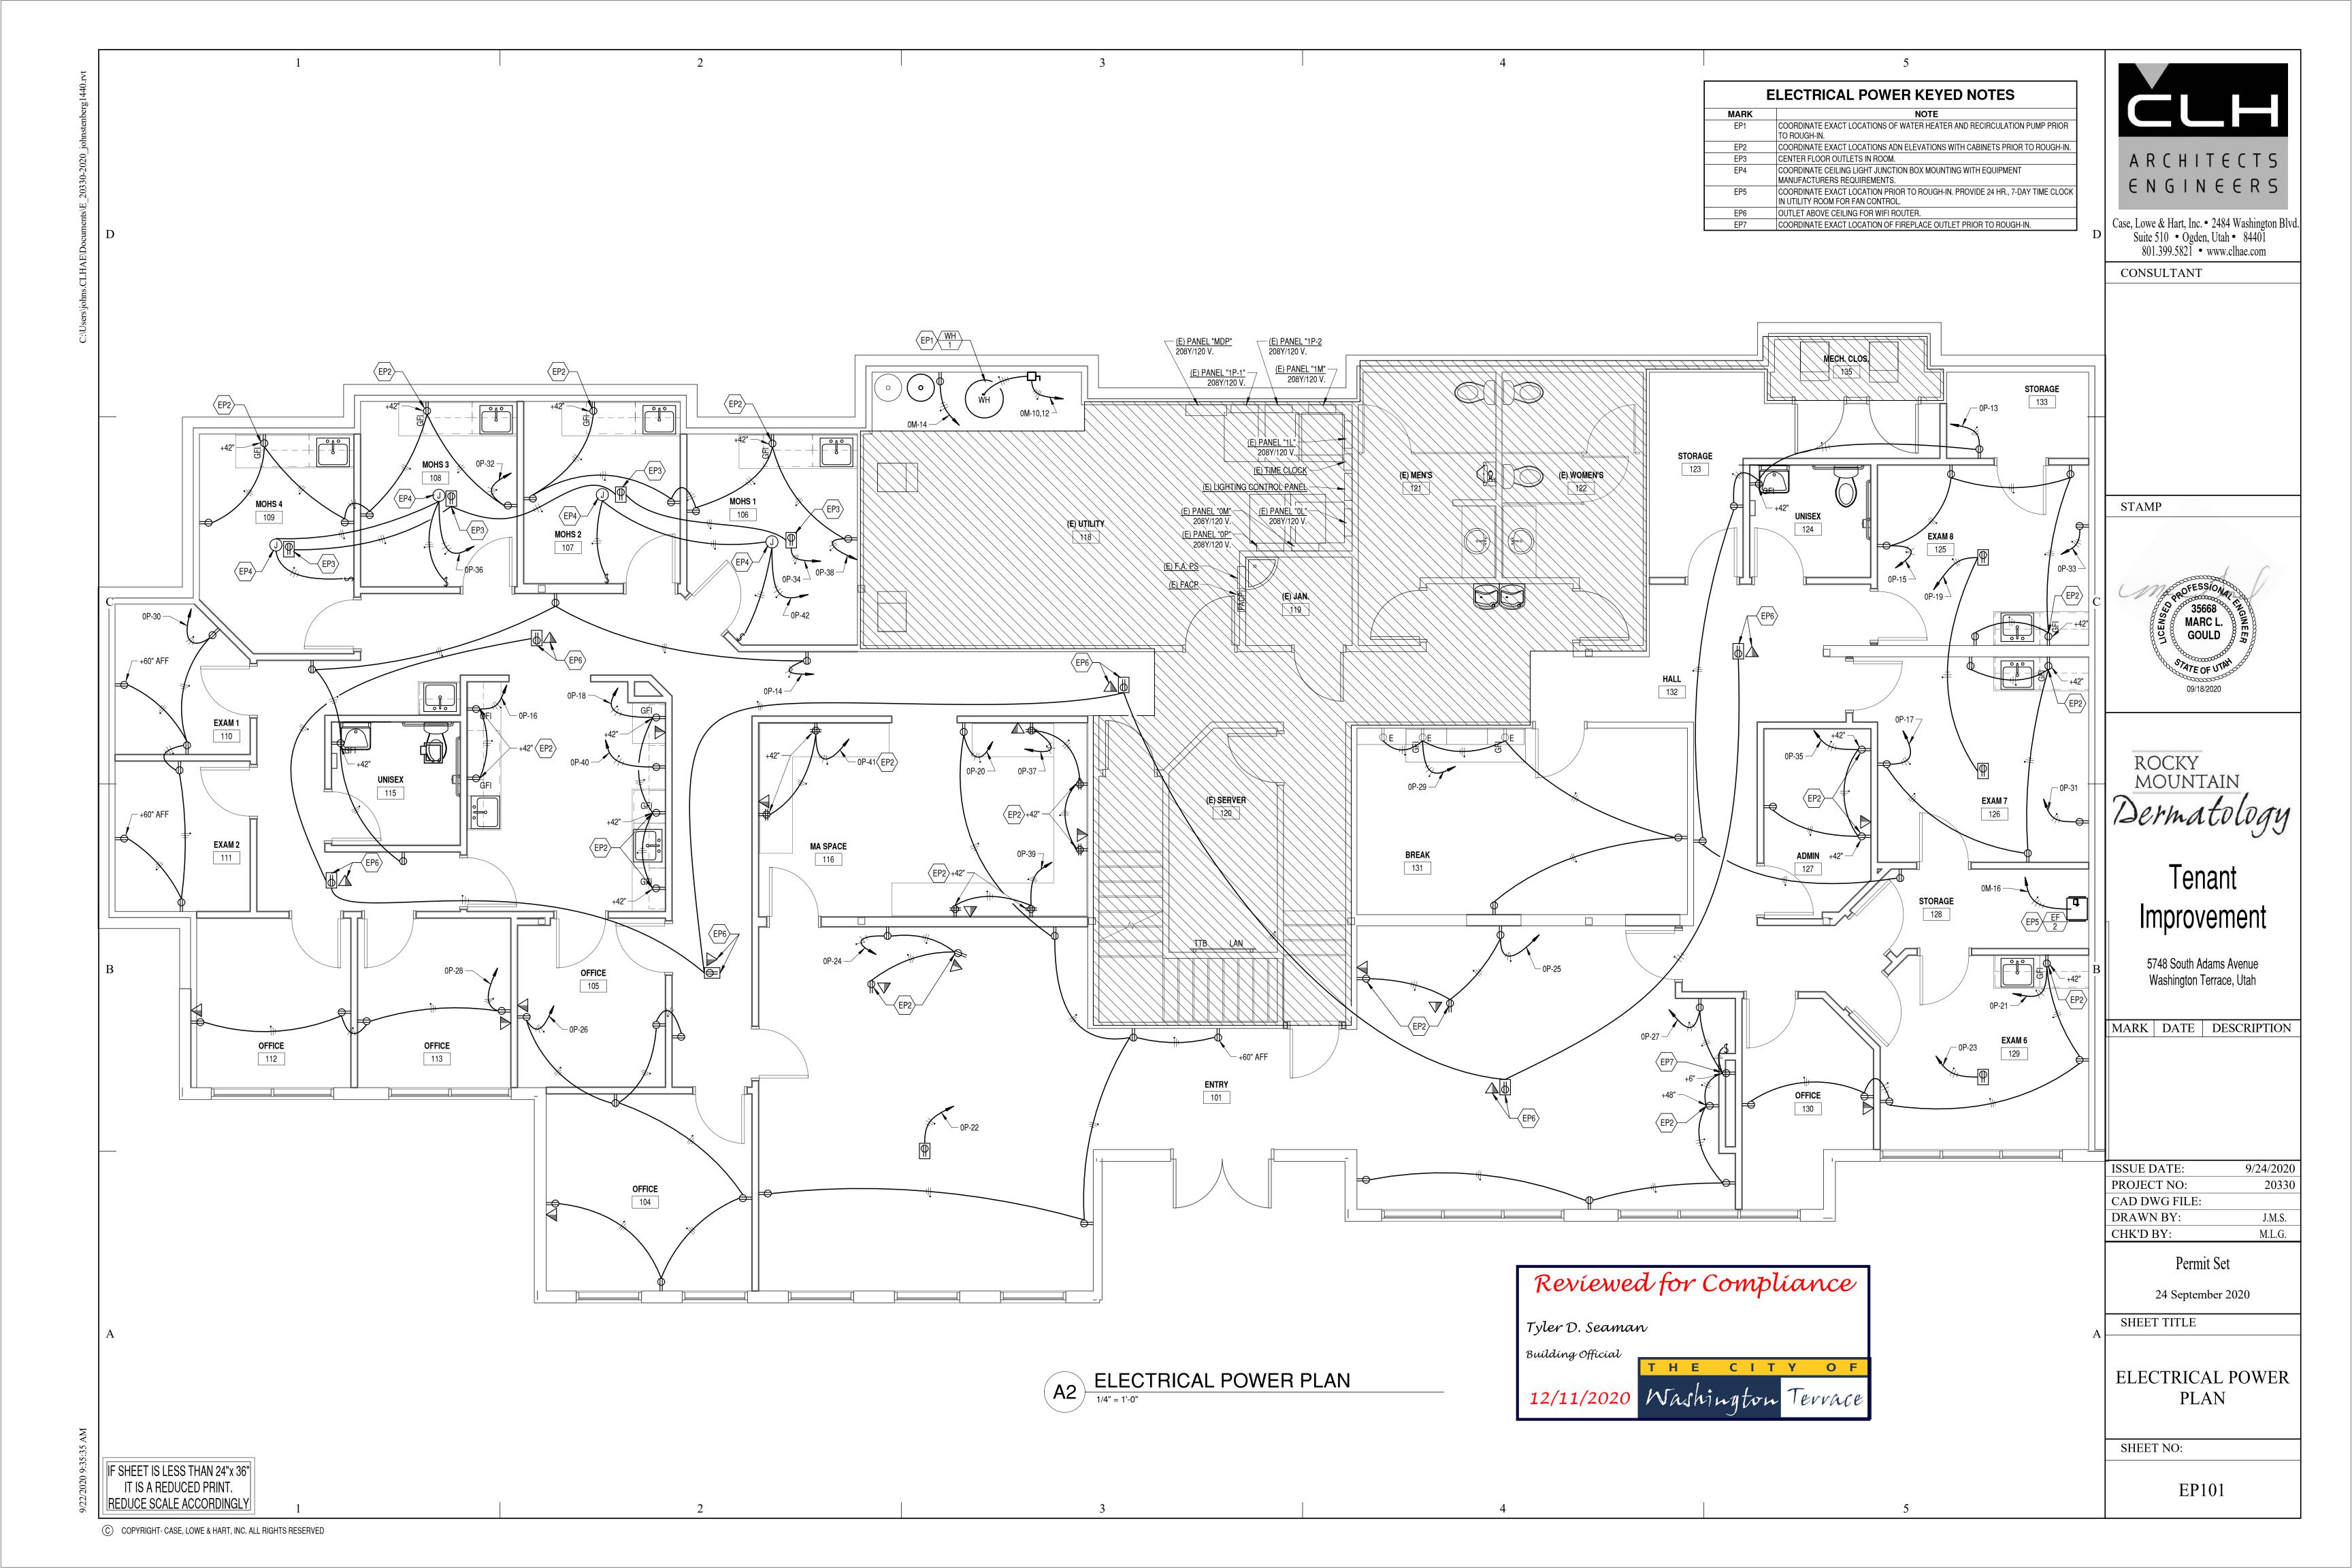

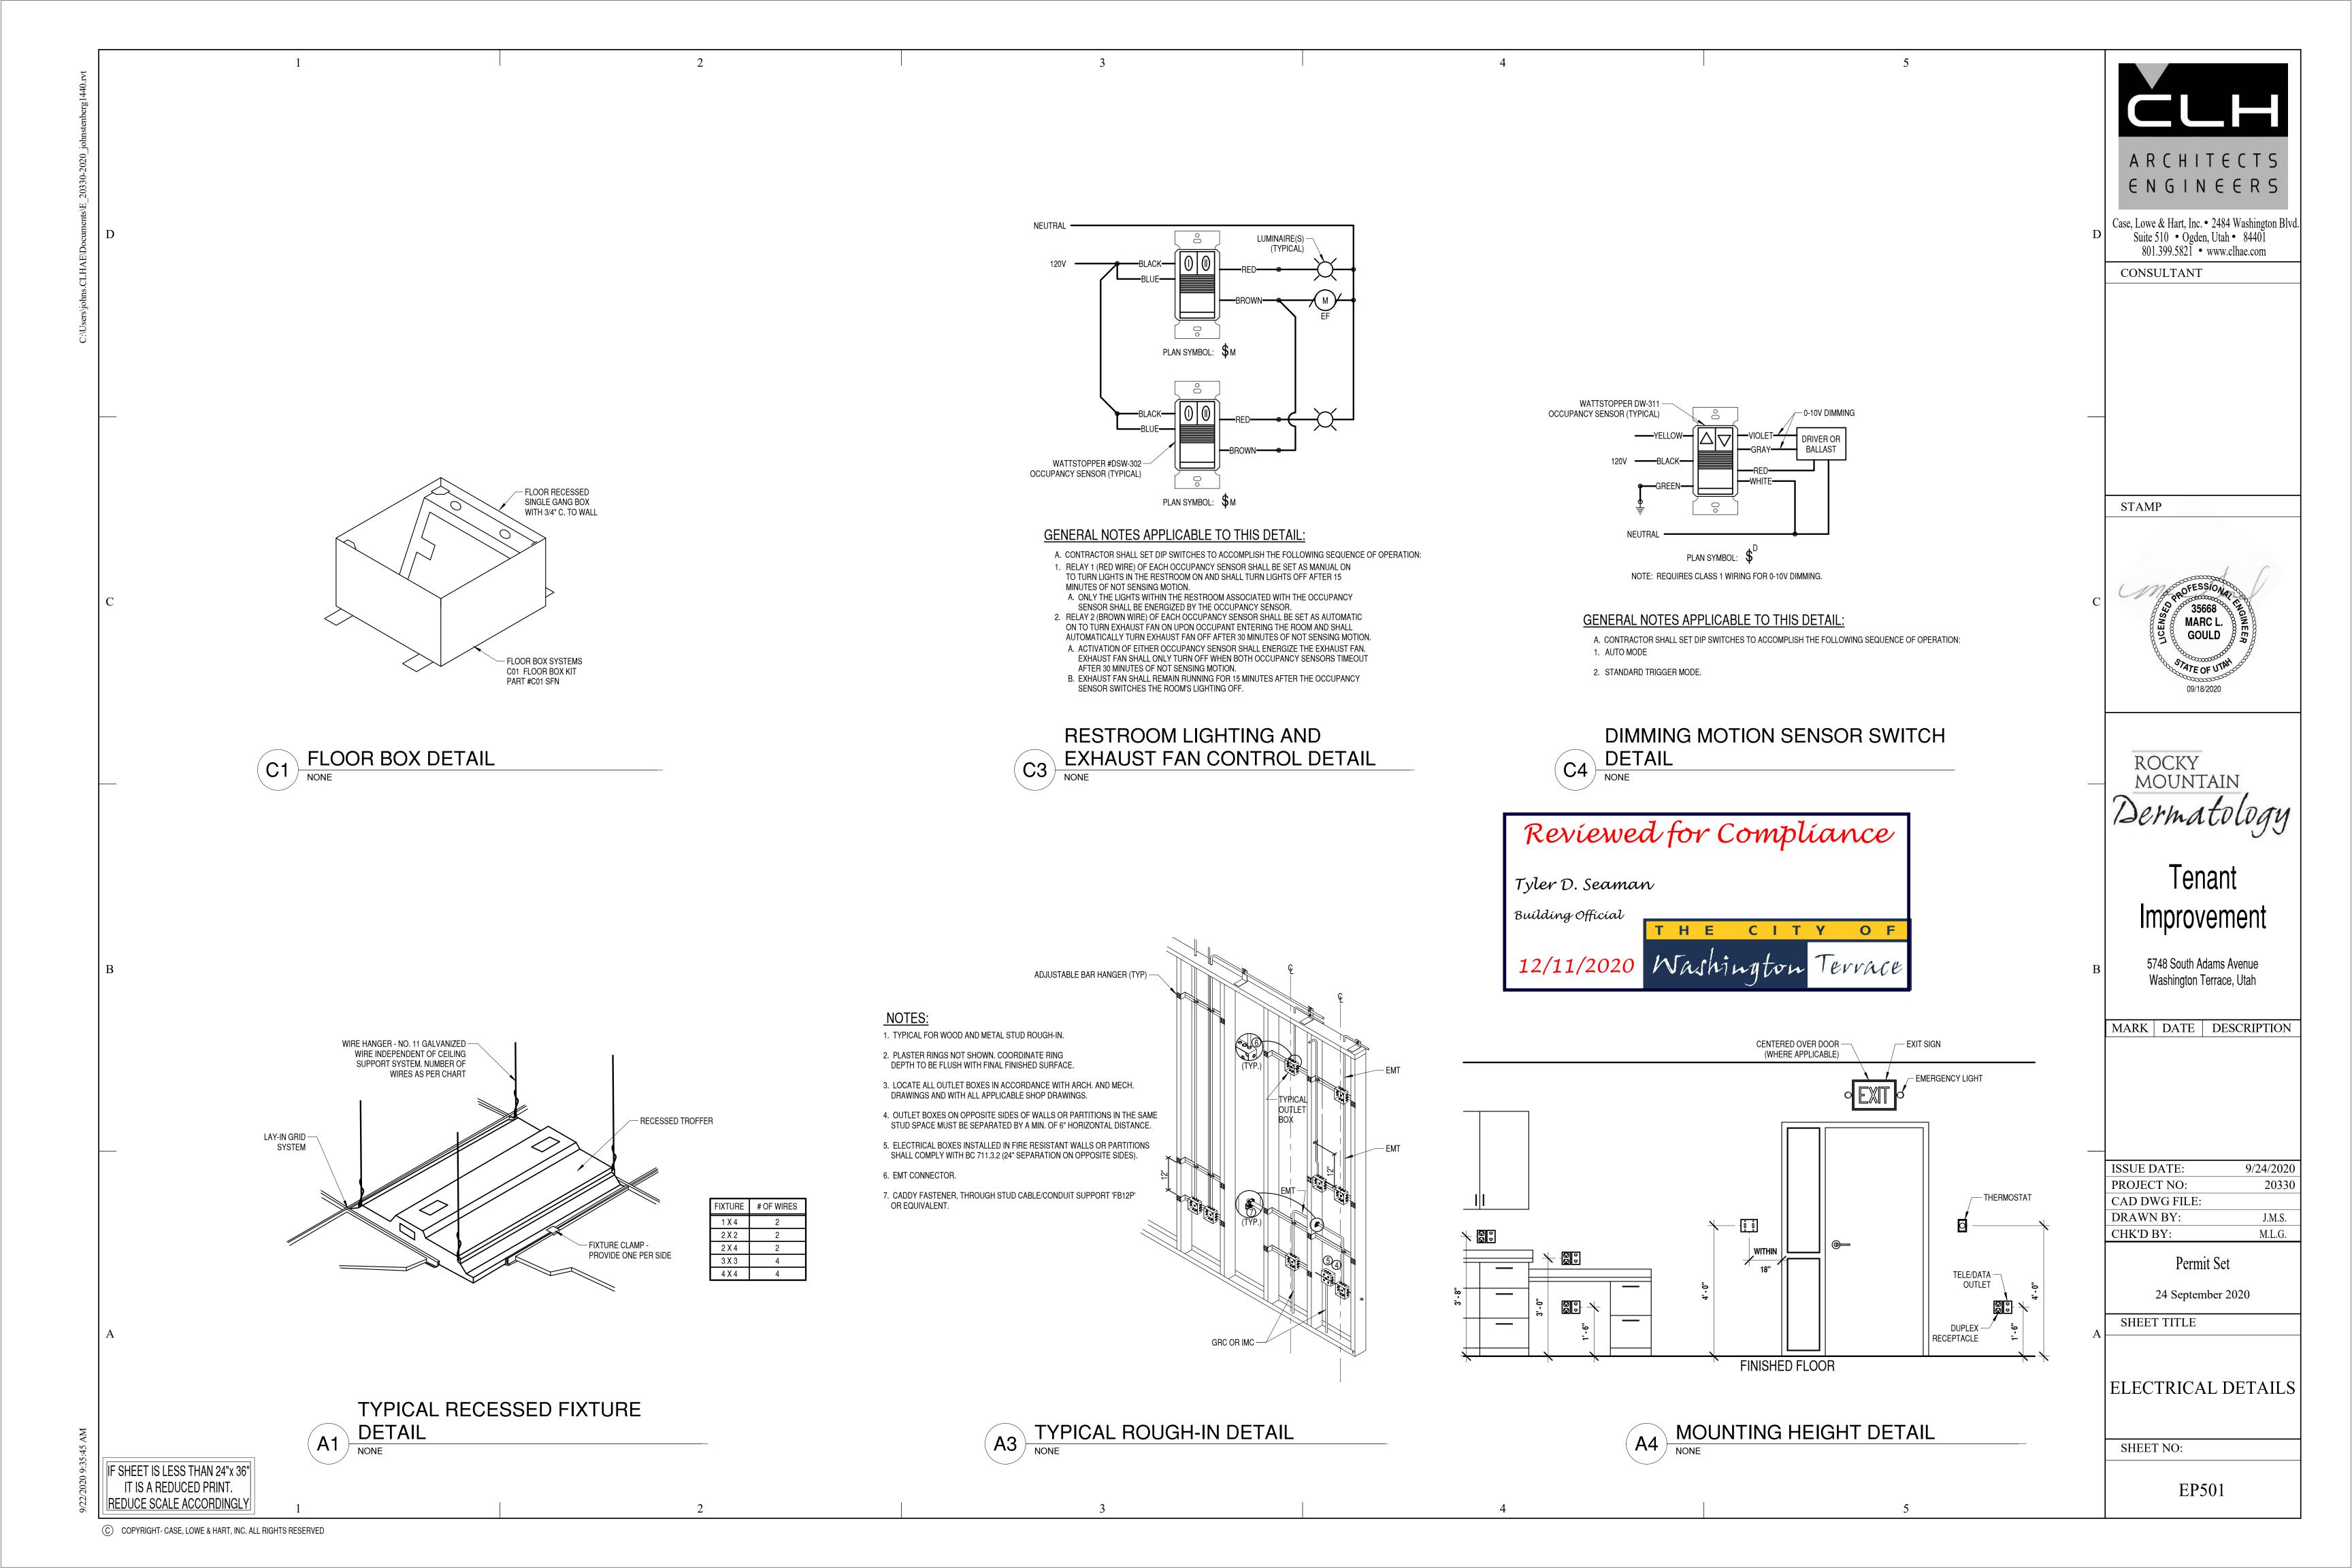

	LIGHT FIXTURE SCHEDULE														
									LAMP	S		В	ALLAST/DRIVE	R	MANUFACTURER & CATALOG NUMBER
NO	DESCRIPTION	VOLTS	MTG.	LENS	FINISH		TYP	PΕ	NO. OF			TYPE	NO. PER	INPUT	(NO SUBSTITUTIONS WITHOUT PRIOR DETAILS
	DEGGINI TIGH	VOLIG		LLIVO	i iidoii	F	н	L	LAMPS		s	E	LUMINAIRE		APPROVAL) COMMISSION ALL LIGHTING CONTROLS NOTE COMMISSION ALL LIGHTING CONTROLS
T-1	2 X 2 LED LAY-IN	120	CEILING SUSPENDED	ACRYLIC	WHITE			*	1	LED 4000K		*	1	40	C-LITE C-TR-A-FP22N
T-2	2' LINEAR	120/277	WALL	ACRYLIC	WHITE			E	1	LED 4000K		E	1	53	ARCHER HPW324 LED40 2U2D
E-1	COMBO EXIT/EMERGENCY LIGHT	120/277	WALL OR CEILING SURFACE	GREEN LETTERS	WHITE			*	1	LED		*	1	1.4	LITHONIA ECC G M6
E-2	COMBO EXIT/EMERGENCY LIGHT WITH	120/277	WALL OR CEILING SURFACE	GREEN LETTERS	WHITE			*	1	LED		*	1	1.4	LITHONIA ECC G REM M6 LITHONIA ERE W SGL WP RD

	EQUIPMENT SCHEDULE																
CRKT.	EQUIP. NO.	DESCRIPTION	VOLTS	PHASE	WATTS HP	BRK	STARTER SIZE	CONT	ROL P.B.	PILOT GRN RED		CONTACTS N.O. N.C.				CONTROL TRANS.	REMARKS
0L-10	EF-1	EXHAUST FAN	120	1	100 W	20	S								MOTION SENSOR SWITCH		
0M-16	EF-2	EXHAUST FAN	120	1	528 W	20	S								PROVIDE ELECTRONIC 7 DAY PROGRAMMABLE TIME CLOCK FOR CONTROL		
0M-10,1 2	WH-1	WATER HEATER	208	1	4500 W	30									30A NON-FUSED DISCONNECT		
OM-14	P-1	DOMESTIC WATER CIRCULATION PUMP	120	1	25W	20									CORD AND PLUG CONNECTION		





Case, Lowe & Hart, Inc. • 2484 Washington Blvd.
Suite 510 • Ogden, Utah • 84401
801.399.5821 • www.clhae.com

CONSULTANT

STAMP





Tenant Improvement

5748 South Adams Avenue Washington Terrace, Utah

MARK DATE DESCRIPTION

ISSUE DATE:	9/24/2020
PROJECT NO:	20330
CAD DWG FILE:	
DRAWN BY:	J.M.S.
CHK'D BY	MLG

Permit Set

24 September 2020

SHEET TITLE

ELECTRICAL SCHEDULES & DIAGRAMS

SHEET NO:

EP601

IF SHEET IS LESS THAN 24"x 36"
IT IS A REDUCED PRINT.
REDUCE SCALE ACCORDINGLY

© COPYRIGHT- CASE, LOWE & HART, INC. ALL RIGHTS RESERVED

EXISTING 0L

MAIN BREAKER

MAINS:	225 AMPS	MOUN	TING	:		SUR	FACE		LOCA	ATION	М	ECHANIC	CAL ROC	OM	RE	MARKS	:	EXISTI	NG	
1001	D DESCRIPTION	WIRE	Р	AMP	СКТ		KVA			PHASE			KVA		СКТ	AMP	Р	WIRE	104	AD DESCRIPTION
LOAL		WIIIL	Ľ	Alviii	OK!	PWR	LTS	C.O.	Α	В	С	C.O.	LTS	PWR	J.	AWII	Ľ	WIITE		DESCRIPTION
HALLWAY LI	GHTING	12	1	20	1				0.94				0.84	0.10	2	20	1	12	EAST EXAM	I ROOM & STORAGE LT
RESTROOM L	LIGHTING	12	1	20	3					0.68			0.68		4	20	1	12	EAST W	AITING RM & OFFICE LT
LEASE SPAC	E LIGHTING	12	1	20	5						0.68		0.68		6	20	1	12	WEST W	AITING RM & OFFICE LT
SPARE		12	1	20	7				0.72				0.72		8	20	1	12		EXAM & LAB LT
SPARE		12	1	20	9					0.86			0.76	0.10	10	20	1	12		MOHS & HALLWAY LTS
SPARE		12	1	20	11						0.00				12	20	1	12		SPAR
SPARE		12	1	20	13				0.00						14	20	1	12		SPAR
SPARE		12	1	20	15					0.00					16	20	1	12		SPAR
SPARE		12	1	20	17						0.00				18	20	1	12		SPAR
SPARE		12	1	20	19				0.00						20	20	1	12		SPAR
SPARE		12	1	20	21					0.00					22	20	1	12		SPAR
SPARE		12	1	20	23						0.00				24	20	1	12		SPAR
SPARE		12	1	20	25				0.00						26	20	1	12		SPAR
SPARE		12	1	20	27					0.00					28	20	1	12		SPAR
SPARE		12	1	20	29						0.00				30	20	1	12		SPAR
SPARE		12	1	20	31				0.00						32	20	1	12		SPAR
SPARE		12	1	20	33					0.00					34	20	1	12		SPAR
SPARE		12	1	20	35						0.00				36	20	1	12		SPAR
SPARE		12	1	20	37				0.00						38	20	1	12		SPAR
SPARE		12	1	20	39					0.00					40	20	1	12		SPAR
SPARE		12	1	20	41						0.00				42	20	1	12		SPAR
SUB-TOTAL ((KVA)					0.00	0.00	0.00	1.66	1.54	0.68	0.00	3.68	0.20		ı				
*PROVIDE GF	CI BREAKER	•				•			•	TYPE C	F LOAD)	•	C	ONNE	CTED		DIV	/ERSITY	DEMAND
**PROVIDE U	L LISTED FIRE ALAR	M BREAKE	R H	ANDLE						LIGH	HTING				3.68	8			100%	3.68
										PO	WER				0.20	ס			70%	0.20
										С	.0.				0.00)		NE	C 220.44	0.00
PANEL LO	DADING	5%								то	TAL				3.88	3			KVA	3.88
9/16/202	0.8.59										TAL				11				AMPS	11

VOLTAGE:

208 Y/ 120

PHASE: 3 WIRE: 4

PANEL:	EXISTING ON		MAI	IN B	REAKE	R		NONE		VOLT	ΓAGE:		208 Y/	120		PHA	ASE:	3	WIRE:	4	NEMA:	1	
MAINS:	225 AMPS	МО	UNTI	NG:	1		SUR	FACE		LOCA	NOITA	М	ECHANIC	AL RO	ОМ	REI	REMARKS:		EXISTING				
								KVA			PHASE			KVA									
LOA	D DESCRIPTION	WI	IRE	Р	AMP	CKT	PWR	LTS	C.O.	Α	В	С	c.o.	LTS	PWR	CKT	AMP	Р	WIRE	LO	AD DESCRIPTION	ON	
SPARE		1:	2	1	20	1				0.00						2	20	1	12			SPARE	
SPARE		1:	2	1	20	3					0.00					4	20	1	12			SPARE	
SPARE		1:	2	1	20	5						0.00				6	20					SPARE	
EX FURNAC	E	1:	2	1	20	7				0.00						8	30	2				SPARE	
SPARE		1:	2	1	20	9					2.75				2.75	10	20				0 LEVEL WATE	D UE ATER	
SPARE		1:	2	1	20	11						2.75			2.75	12	30	2			U LEVEL WATE	K HEATER	
SPARE		1:	2	1	20	13				0.03					0.03	14	20	1	12		CIRCULAT	TION PUME	
SPARE		1:	2	1	20	15					0.45				0.45	16	20	1	12			FANS	
SPARE		1:	2	1	20	17						1.08			1.08	18	20	1	12		WIF	ROUTERS	
SPARE		1:	2	1	20	19				0.00						20	20	1	12			SPARE	
SPARE		1:	2	1	20	21					0.00					22	20	1	12			SPARE	
SPARE		1:	2	1	20	23						0.00				24	20	1	12			SPARE	
SPARE		1:	2	1	20	25				0.00						26	20	1	12			SPARE	
SPARE		1:	2	1	20	27					0.00					28	20	1	12			SPARE	
SPARE		1:	2	1	20	29						0.00				30	20	1	12			SPARE	
SPARE		1:	2	1	20	31				0.00						32	20	1	12			SPARE	
SPARE		1:	2	1	20	33					0.00					34	20	1	12			SPARE	
SPARE		1:	2	1	20	35						0.00				36	20	1	12			SPARE	
SPARE		1:	2	1	20	37				0.00						38	20	1	12			SPARE	
SPARE		1:	2	1	20	39					0.00					40	20	1	12			SPARE	
SPARE		1:	2	1	20	41						0.00				42	20	1	12			SPARE	
SUB-TOTAL	(KVA)						0.00	0.00	0.00	0.03	3.20	3.83	0.00	0.00	7.06								
*PROVIDE G	FCI BREAKER										TYPE C	OF LOAD)		(CONNEC	CTED		DIV	ERSITY	DEMA	ND	
**PROVIDE (JL LISTED FIRE AL	ARM BREA	AKER	R HA	NDLE						LIGH	HTING				0.00				100% 0.00			
											РО	WER				7.06	6			70%	5.00)	
											С	.O.			0.00				NE	C 220.44	0.00)	
PANEL L	OADING	6%									то	TAL				7.06	6		KVA		5.00)	
9/22/20	20 7:30		\Box								ТО	TAL				20				AMPS	14		

MAIN BREAKER 208 Y/ 120 PHASE: 3 WIRE: **EXISTING OP** NONE **VOLTAGE:** NEMA: 1 REMARKS: EXISTING PANEL SURFACE LOCATION **225 AMPS** MECHANICAL ROOM PHASE LOAD DESCRIPTION LOAD DESCRIPTION WIRE P AMP CKT CKT AMP P WIRE PWR LTS C.O. A B C C.O. LTS PWR EXISTING **EXISTING** 12 1 20 1 2 20 1 12 **EXISTING EXISTING** 12 1 20 3 4 20 1 12 EXISTING 12 1 20 5 6 20 1 12 **EXISTING** SPARE **EXISTING** 12 1 20 7 8 20 1 12 0.00 10 20 1 12 EXISTING 12 1 20 9 W WAITING/SAMPLE/ENTRY.. SPARE 12 1 20 11 12 20 1 12 EAST HALLWAY / STORAGE... 14 20 1 12 **WEST HALLWAY OUTLETS** 12 1 20 13 0.90 16 20 1 12 **EXAM 8 OUTLETS** 0.90 LAB OUTLETS 12 1 20 15 EXAM 7 OUTLTES 0.72 0.54 LAB OUTLETS 12 1 20 17 18 20 1 12 W WAITING/SAMPLE/ENTRY.. EXAM 8 & 7 FLOOR OUTLETS 20 20 1 12 12 1 20 19 0.36 OFFICE / EXAM 6 OUTLETS 12 1 20 21 0.72 0.18 22 20 1 12 W WAITING FLOOR OUTLET 0.18 24 20 1 12 **EXAM 6 FLOOR OUTLET** 12 1 20 23 W WAITING COUNTER OUTLETS 26 20 1 12 E WAITING COUNTER OUTLETS 12 1 20 25 0.54 1.26 **EMIL'S OFFICE** 1.80 1.08 0.72 28 20 1 12 PA OFFICE **E WAITING OUTLETS** 12 1 20 27 12 1 20 29 30 20 1 12 BREAK ROOM OUTLETS 0.90 0.72 **EXAM 1 & 2 OUTLETS** 0.18 1.24 32 20 1 12 **EXAM 7 OUTLET** 12 1 20 31 MOHS 3 & 4 WALL OUTLETS 34 20 1 12 EXAM 8 OUTLETS 0.72 MOHS FLOOR OUTLETS 12 1 20 33 0.18 36 20 1 12 12 1 20 35 0.54 0.36 **MOHS 3 & 4 CEILING OUTLETS** MA SPACE OUTLETS 0.36 38 20 1 12 12 1 20 37 MOHS 1 & 2 WALL OUTLETS 40 20 1 12 0.36 LAB OUTLETS MA SPACE OUTLERS 12 1 20 39 0.18 0.72 0.36 42 20 1 12 MA SPACE OUTLETS 0.36 MOHS 1 & 2 CEILING OUTLETS 12 1 20 41 0.00 | 0.00 | 8.28 | 7.70 | 5.40 | 6.30 | 11.12 | 0.00 | 0.00 SUB-TOTAL (KVA) **TYPE OF LOAD** CONNECTED DIVERSITY DEMAND *PROVIDE GFCI BREAKER **PROVIDE UL LISTED FIRE ALARM BREAKER HANDLE LIGHTING 0.00 0.00 **POWER** 0.00 0.00 70% 19.40 14.70 **PANEL LOADING** TOTAL 19.40 18% KVA 14.70 TOTAL

9/16/2020 8:58




AMPS



Case, Lowe & Hart, Inc. • 2484 Washington Blvd. Suite 510 • Ogden, Utah • 84401 801.399.5821 • www.clhae.com

CONSULTANT

STAMP

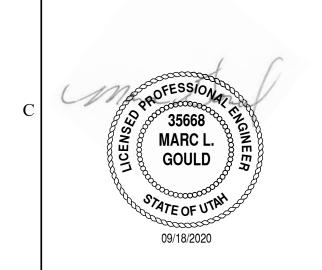

Dermatology

Tenant Improvement

5748 South Adams Avenue Washington Terrace, Utah

MARK DATE DESCRIPTION

ISSUE DATE:	9/24/2020
PROJECT NO:	20330
CAD DWG FILE:	
DRAWN BY:	J.M.S.
CHK'D BY:	M.L.G.

Permit Set 24 September 2020

SHEET TITLE

ELECTRICAL PANEL SCHEDULES

SHEET NO:

EP701