

EXTEND HOT AND COLD WATER TO WASHER - PROVIDE DRAIN AND LEAD PAN

**KEYED NOTES** 

DRYER VENT TO EXTERIOR - PROVIDE BACK DRAFT PREVENTER AND BUG **SCREEN AT EXTERIOR** 

PROTECT BOTTOM OF STAIRS WITH 5/8" GYP BD

STAIRS - MAX 8" RISE AND 10" TREAD - HANDRAIL AT 36" ABOVE THE NOSE OF STAIRS (TYP) GUARD RAIL AT WALKWAY AND STAIR - 36" HIGH - NO OPENINGS THAT WILL ALLOW A 4" SPHERE TO PASS THROUGH

1/2" RIGID INSULATION

RAIN GUTTER AND DOWN SPOUTS - OPTIONAL

2 x 6 EXTERIOR STUD WALLS W/ R-19 BATT INSULATION - 1/2" GYP BD - TAPE, TEXTURE AND PAINT (TYPICAL EXTERIOR WALLS)

2 x 4 INTERIOR STUD WALLS - 1/2" GYP BD - TAPE, TEXTURE AND PAINT

PRIOR TO INSTALLING PLUMBING FIXTURES VERIFY THAT THE SEWER WILL HAVE PROPER FALL TO SEWER IN STREET

ASPHALT SHINGLES ON PRIMARY UNDERLAYMENT (VAPOR BARRIER) - ASPHALT OR APPROVED SYNTHETIC - RIDGE CAPS TO ALSO BE INSTALLED - SEE KEYED

GARAGE DOOR OPENER

R-49 CEILING INSULATION - TYPICAL - RIGID INSULATION

ROOF VENT 1 /300 OF ROOF WITH VENTS - TOTAL VENTING IN ROOF TO BE 1/300 OF ROOF AREA WITH 50 PERCENT AT RIDGE AND 50 PERCENT AT EAVES - ADU SF / 650 = 1.08 OR 2 SF OF VENTS

DRYER VENT W/ BACK DRAFT AND BUG SCREEN - MAX LENGTH IN ACCORDANCE WITH IRC 2015 M1502.4.5

1 1/2" GUARDRAIL REQUIRED - 36" HIGH IF THE AREA IS 30" ABOVE ADJACENT FINISH GRADE-NO OPENING TO ALLOW A 4" SPHERE TO PASS

DRAIN & DRY WELL

FLOOR INSULATION - R 30 AT UNFINISHED BASEMENT

STRUCTURAL COLUMN - SEE STRUCTURAL

2 x 6 STUD WALLS

STUCCO FINISH - 3 COAT APPLICATION ON WIRE OVER 5/8" GLASSMAT - FOLLOW MANUFACTURERS RECOMMENDATIONS FOR EXPANSION/CONTROL JOINTS

## **GENERAL NOTES**

BALUSTERS SHALL BE PLACED SO THAT A (4") DIA. SPHERE CANNOT PASS

THROUGH (CODE SECTION 316.2)

ALL TUB / SHOWERS TO HAVE ANTI-SCALD VALVES

ALL COUNTERTOPS TO BE STANDARD DEPTH, ALL PLUMBING TO BE PROTECTED AGAINST FREEZING, PLUMBING IN EXTERIOR WALLS TO BE WRAPPED W/ BATT.

RAIN GUTTERS ARE OPTIONAL

TOP OF FOUNDATION WALL A MIN. OF 6" ABOVE FINISHED GRADE R404.1.6

PROVIDE PROPER WALL ANCHORAGE WITH 3 x 3 x 0.029 SQUARE WASHERS. IF WASHER WITH ELONGATED HOLE IS USED PLACE AN APPROVED CUT FOUNDATION WASHER ON TOP OF THE SQUARE WASHER; SEE STRUCTURAL, WHICH GOVERNS

COORDINATE PLUMBING AND MECHANICAL WITH STRUCTURAL MEMBERS

SPRAY FOAM BEHIND ALL OUTLETS ON EXTERIOR WALLS 10. THERMAL INSULATION TO BE: ATTIC: R-38 OR BETTER, EXTERIOR WALLS: R-19 OR

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13. EMERGENCY FLOOR DRAINS SHALL BE INSTALLED AT WATER HEATERS, LAUNDRIES, ETC. AND INCLUDE A DEEP SEAL TRAP

14. GLAZING WITHIN 5 FT OF STAIRS TO BE SAFETY GLAZING (TEMPERED OR SIMILAR)

15. CONNECTIONS TO UTILITIES (CULINARY WATER, NATURAL GAS, SANITARY SEWER, ETC.) TO BE EXTERIOR OF BUILDING.

#### **GENERAL NOTES**

OWNER TO HAVE FIRST RIGHT OF REFUSAL TO ALL DEMOLITION ITEMS

2. PROPERLY PROTECT EXISTING RESIDENCE - COVER TO PROTECT FROM DUST,

PROPERLY SHORE ANY STRUCTURAL ITEM TO REMAIN

PROTECT PUBLIC FROM CONSTRUCTION ACTIVITIES

5. ALL EXPOSED SURFACES TO BE PAINTED - TYP.

6. VERIFY DEPTH OF SEWER IN STREET AND THAT THE NEW SEWER LINE IN THE BASEMENT WILL HAVE PROPER SLOPE TO SEWER MAIN LINE

7. FURNITURE IS NIC (NOT IN CONTRACT)

8. VERIFY ALL DIMENSIONS PRIOR TO COMMENCEMENT OF CONSTRUCTION ACTIVITIES - BRING ANY DISCREPANCIES TO THE ATTENTION OF THE OWNER AND /

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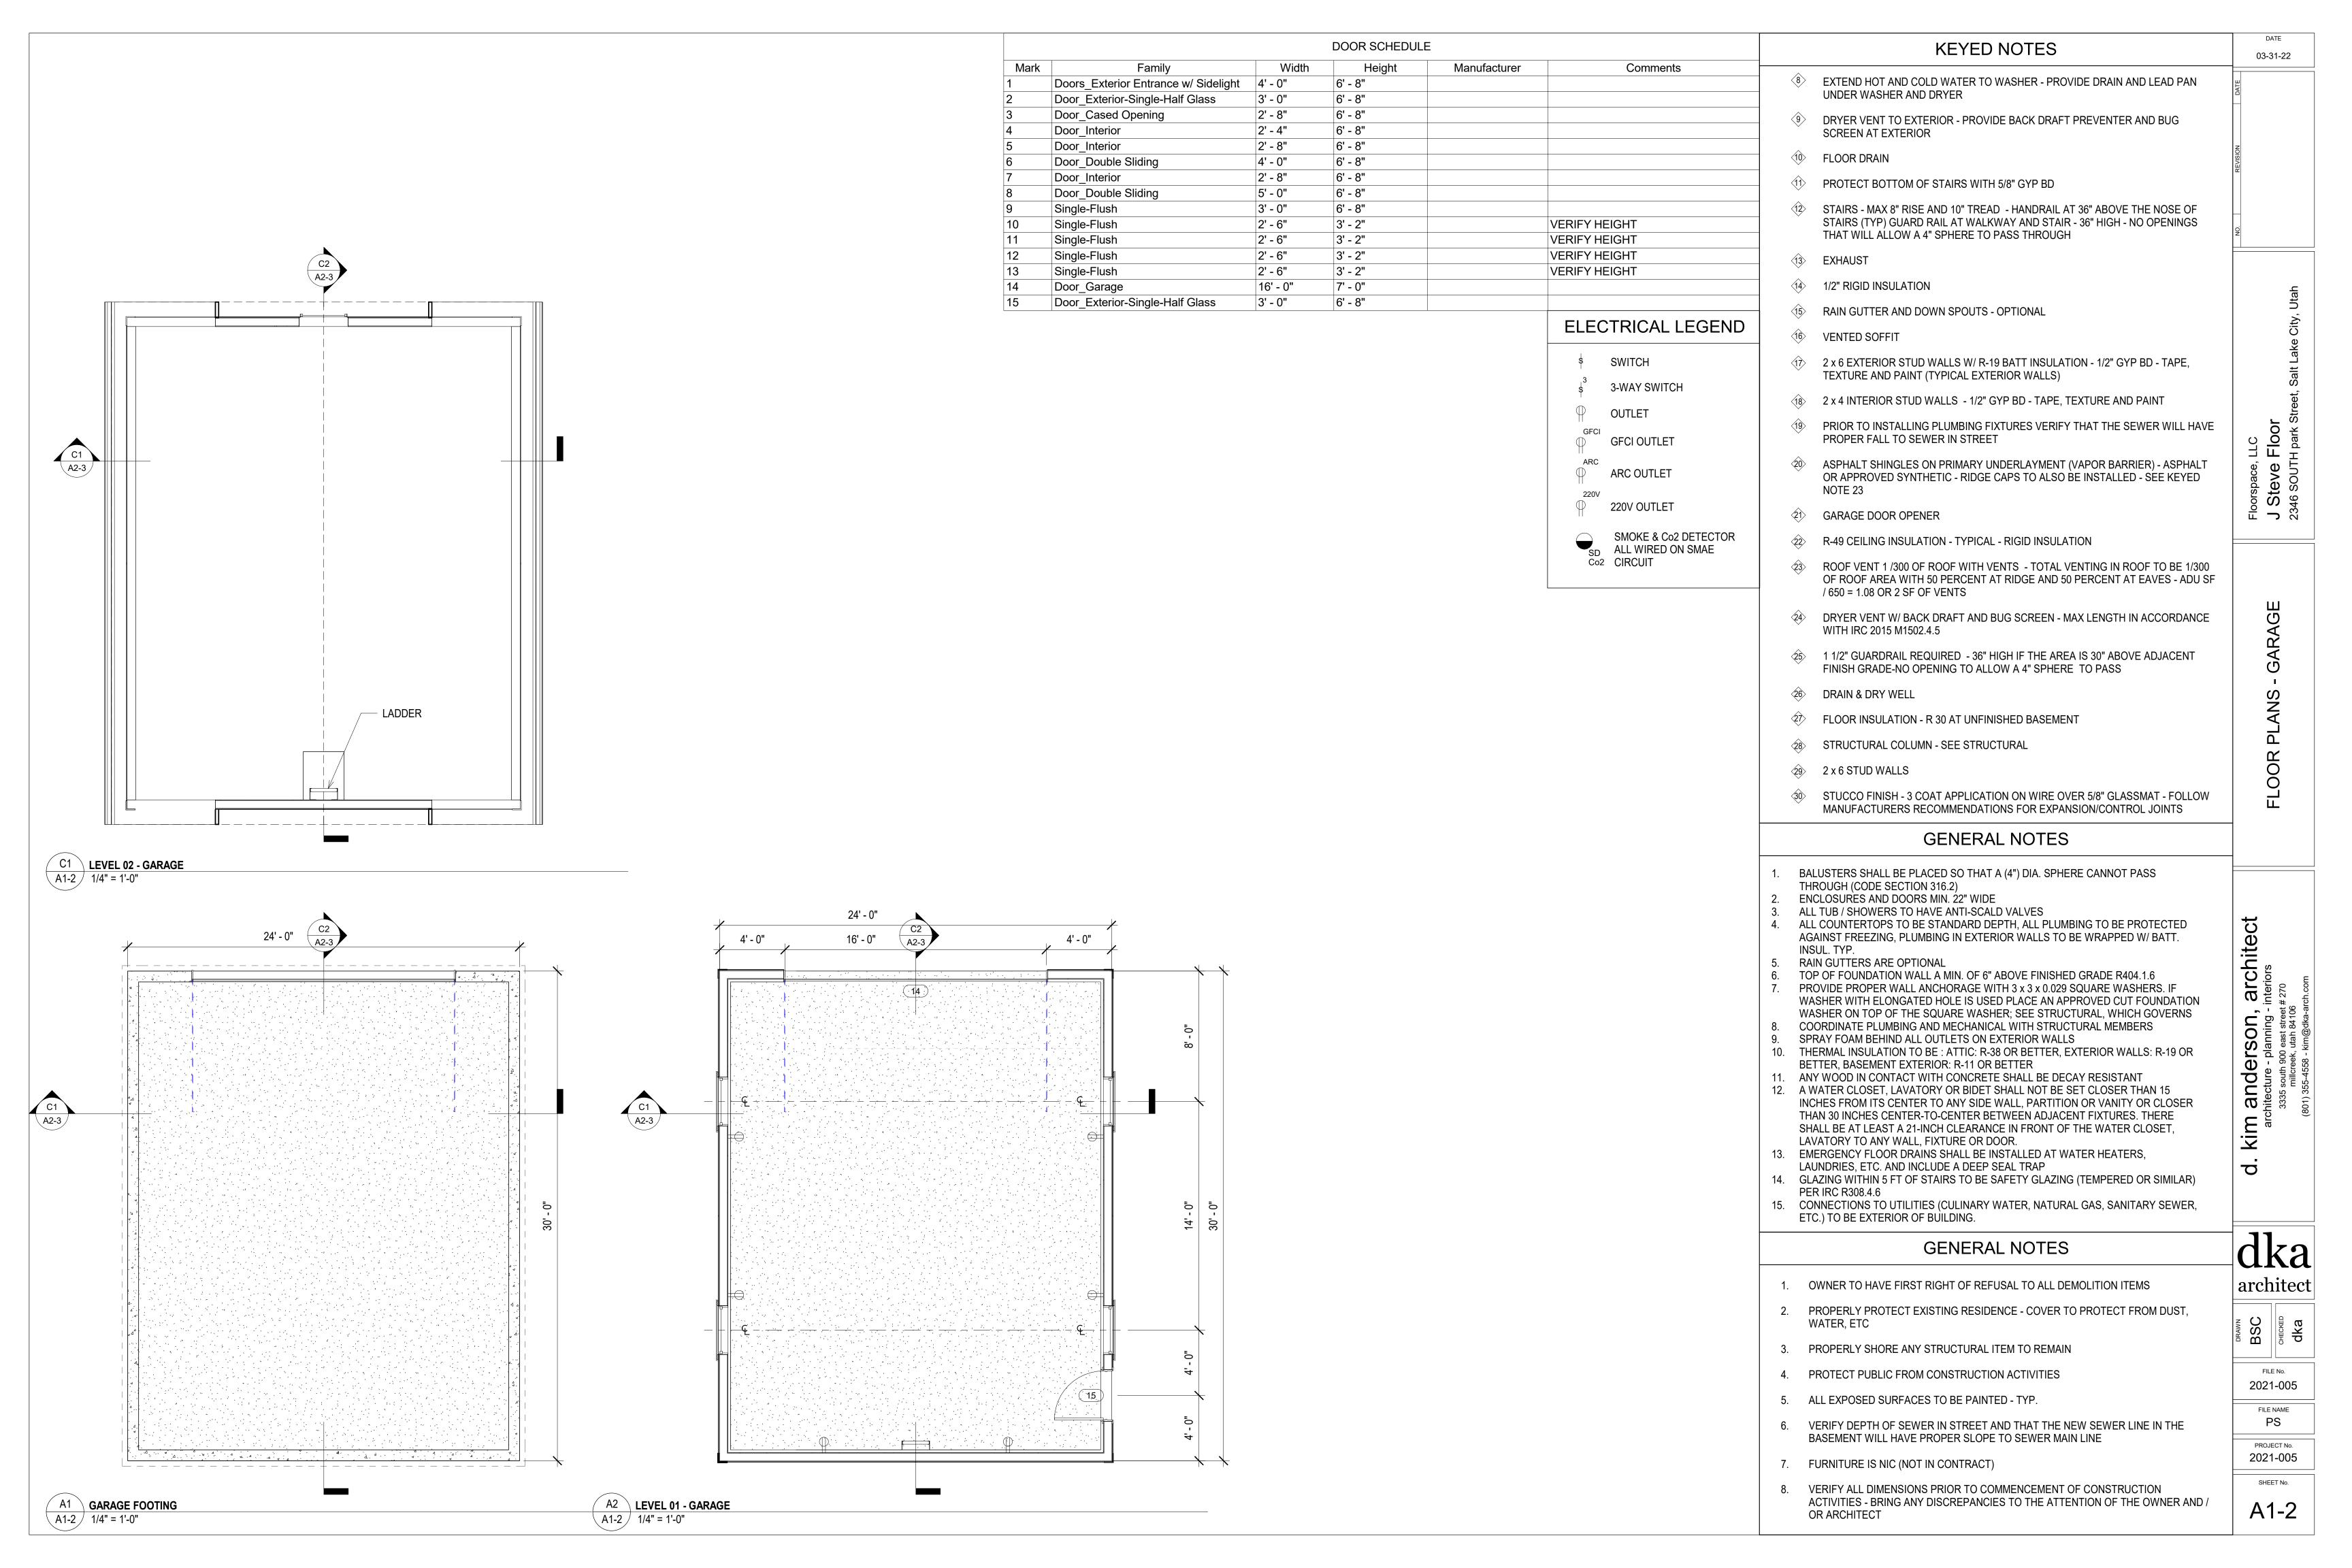
architect


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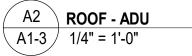


A1 22 12" 5 12" 12" 5 12" 12" 5 12" 12" 5 12" 12"

A2-3

32' - 2 3/4"

A1 ROOF - GARAGE
A1-3 1/4" = 1'-0"

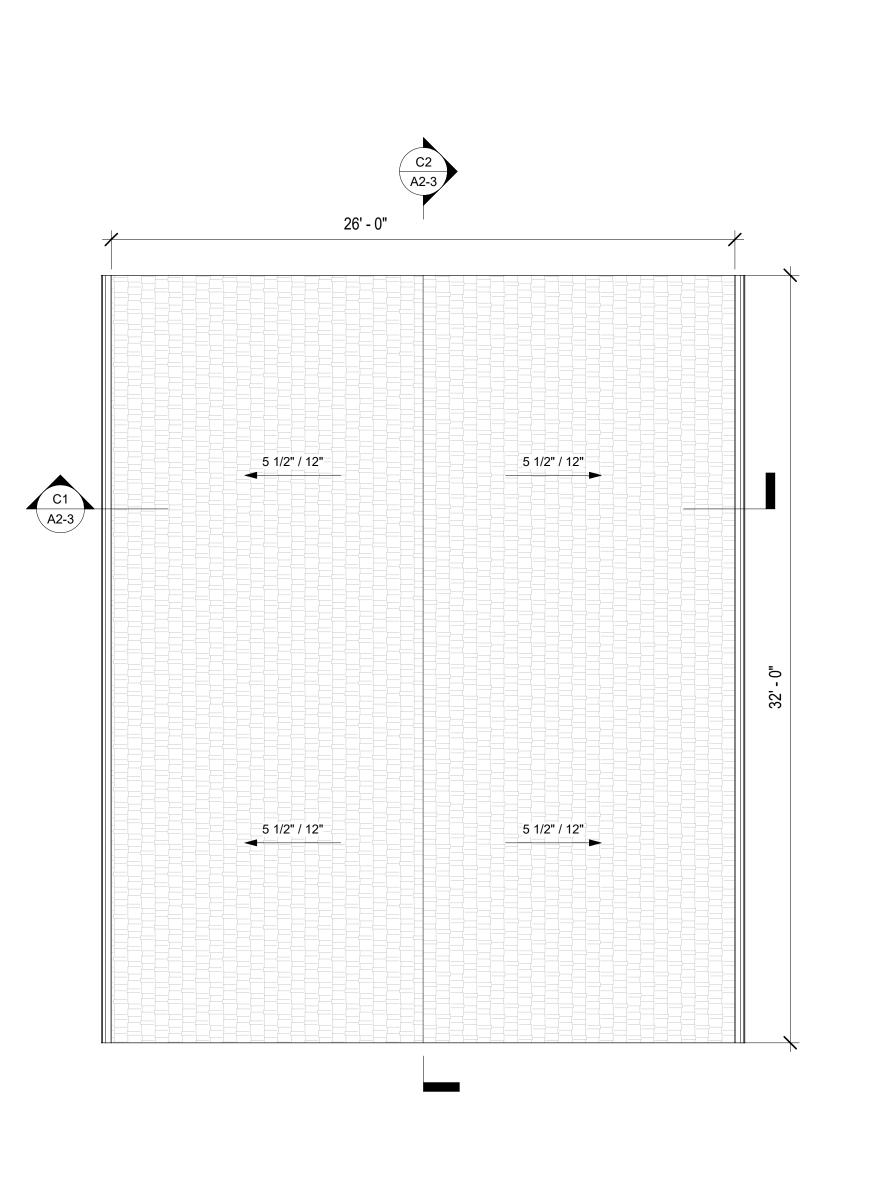

**KEYED NOTES** 

8 EXTEND HOT AND COLD WATER TO WASHER - PROVIDE DRAIN AND LEAD PAN UNDER WASHER AND DRYER

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03-31-22

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kim arc

dka architect


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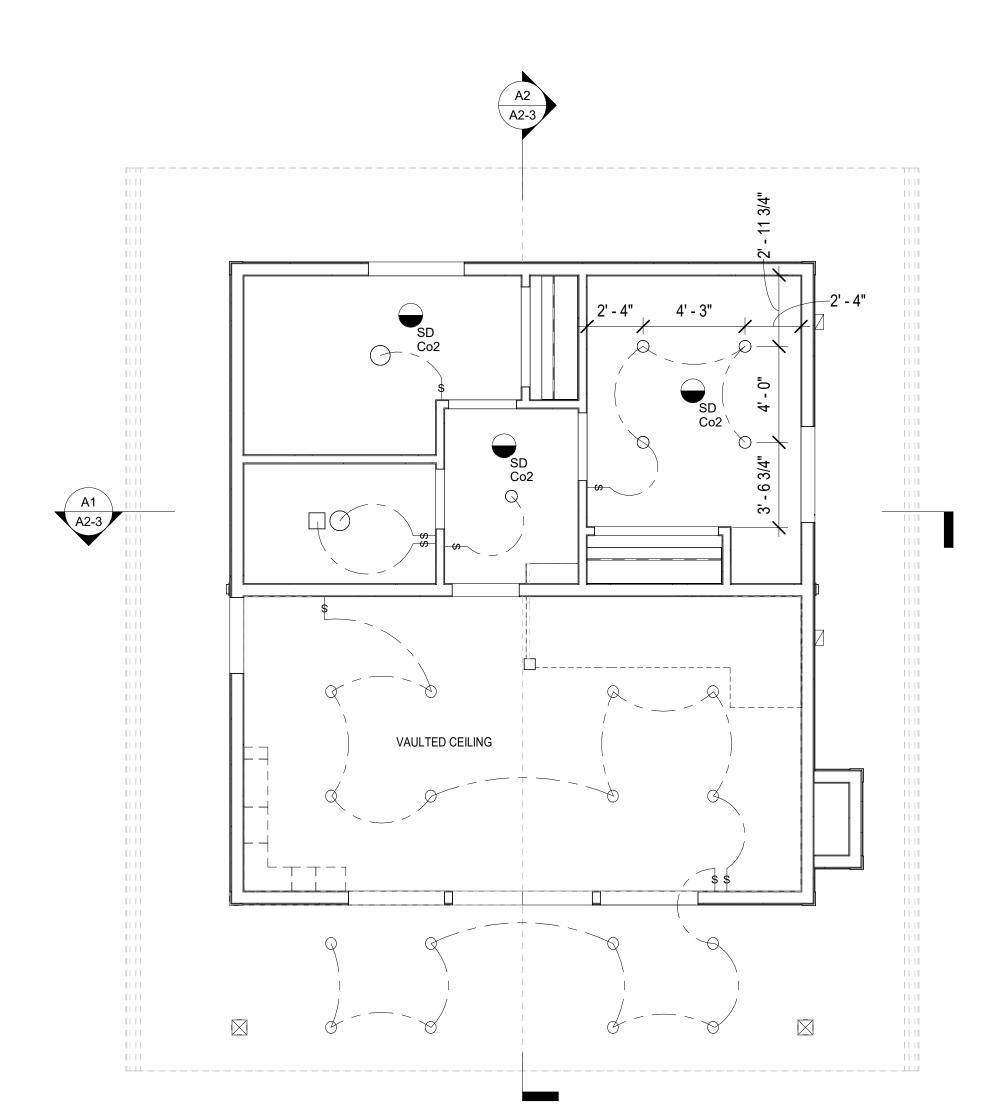
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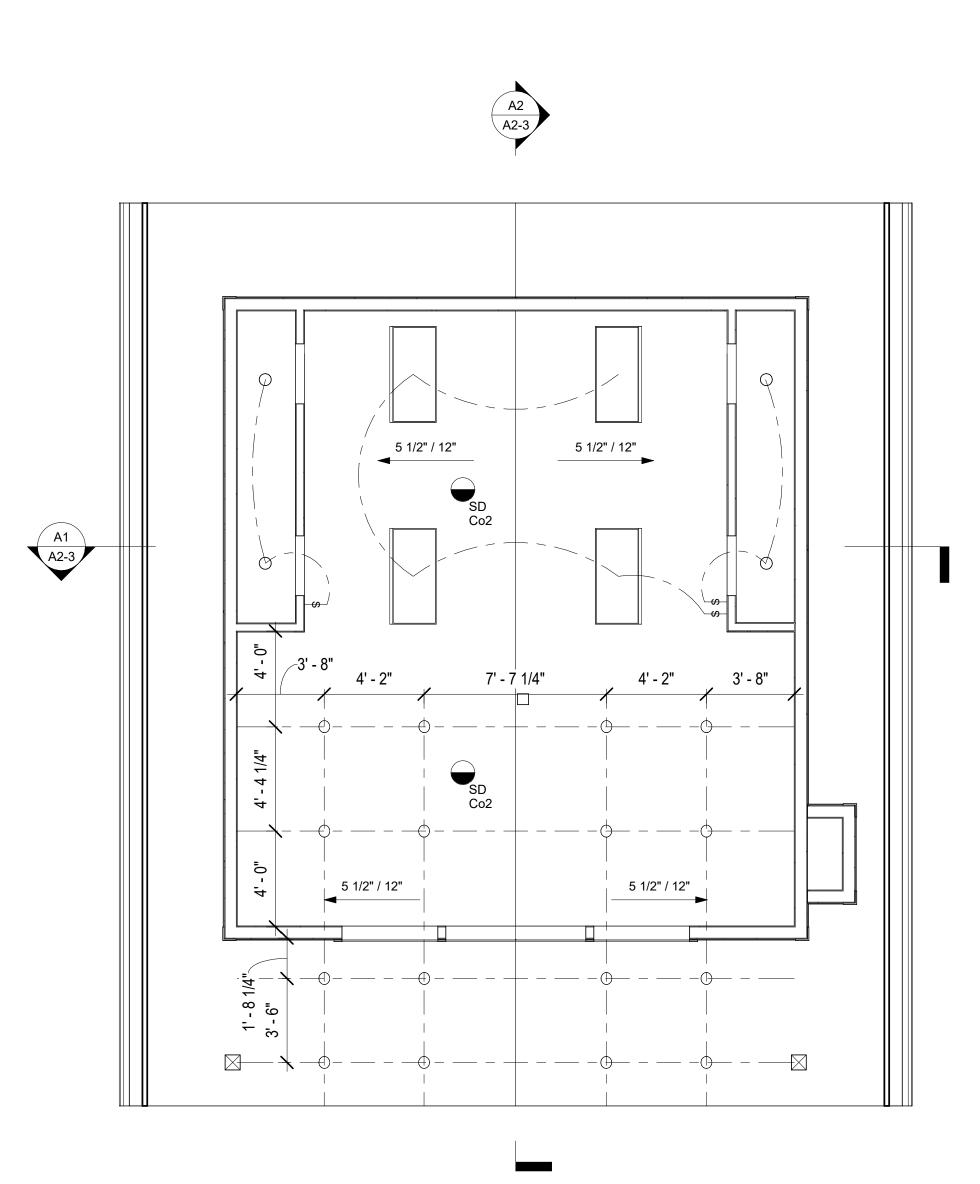
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A1-3



C1 LEVEL 01 - GARAGE A1-4 / 1/4" = 1'-0"



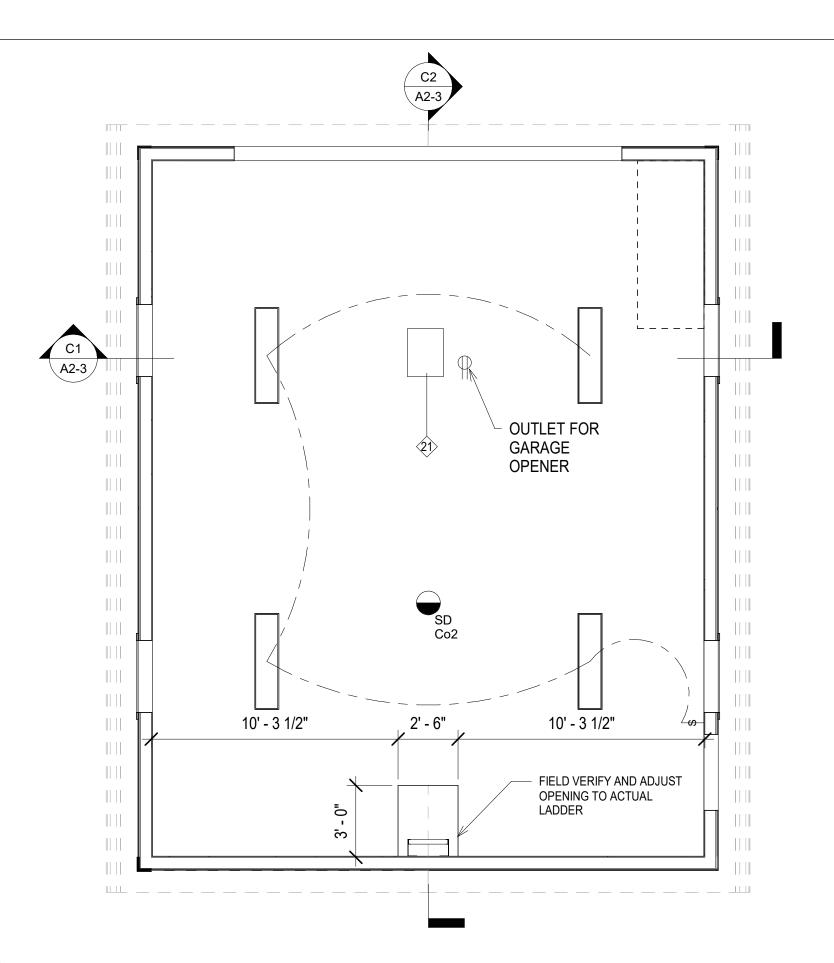

A2 LEVEL 02 - ADU

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ELECTRICAL LEGEND **KEYED NOTES** 8 EXTEND HOT AND COLD WATER TO WASHER - PROVIDE DRAIN AND LEAD PAN SWITCH UNDER WASHER AND DRYER 3-WAY SWITCH 9 DRYER VENT TO EXTERIOR - PROVIDE BACK DRAFT PREVENTER AND BUG SCREEN AT EXTERIOR OUTLET **GFCI** 10 FLOOR DRAIN **GFCI OUTLET** PROTECT BOTTOM OF STAIRS WITH 5/8" GYP BD ARC OUTLET STAIRS - MAX 8" RISE AND 10" TREAD - HANDRAIL AT 36" ABOVE THE NOSE OF STAIRS (TYP) GUARD RAIL AT WALKWAY AND STAIR - 36" HIGH - NO OPENINGS 220V OUTLET THAT WILL ALLOW A 4" SPHERE TO PASS THROUGH SMOKE & Co2 DETECTOR (13) EXHAUST ALL WIRED ON SMAE Co2 CIRCUIT 1/2" RIGID INSULATION RAIN GUTTER AND DOWN SPOUTS - OPTIONAL **VENTED SOFFIT** 2 x 6 EXTERIOR STUD WALLS W/ R-19 BATT INSULATION - 1/2" GYP BD - TAPE, TEXTURE AND PAINT (TYPICAL EXTERIOR WALLS) 2 x 4 INTERIOR STUD WALLS - 1/2" GYP BD - TAPE, TEXTURE AND PAINT PRIOR TO INSTALLING PLUMBING FIXTURES VERIFY THAT THE SEWER WILL HAVE PROPER FALL TO SEWER IN STREET ASPHALT SHINGLES ON PRIMARY UNDERLAYMENT (VAPOR BARRIER) - ASPHALT OR APPROVED SYNTHETIC - RIDGE CAPS TO ALSO BE INSTALLED - SEE KEYED GARAGE DOOR OPENER R-49 CEILING INSULATION - TYPICAL - RIGID INSULATION ROOF VENT 1 /300 OF ROOF WITH VENTS - TOTAL VENTING IN ROOF TO BE 1/300 OF ROOF AREA WITH 50 PERCENT AT RIDGE AND 50 PERCENT AT EAVES - ADU SF / 650 = 1.08 OR 2 SF OF VENTS DRYER VENT W/ BACK DRAFT AND BUG SCREEN - MAX LENGTH IN ACCORDANCE WITH IRC 2015 M1502.4.5 25 1 1/2" GUARDRAIL REQUIRED - 36" HIGH IF THE AREA IS 30" ABOVE ADJACENT FINISH GRADE-NO OPENING TO ALLOW A 4" SPHERE TO PASS 26 DRAIN & DRY WELL FLOOR INSULATION - R 30 AT UNFINISHED BASEMENT STRUCTURAL COLUMN - SEE STRUCTURAL 29 2 x 6 STUD WALLS STUCCO FINISH - 3 COAT APPLICATION ON WIRE OVER 5/8" GLASSMAT - FOLLOW MANUFACTURERS RECOMMENDATIONS FOR EXPANSION/CONTROL JOINTS **GENERAL NOTES** BALUSTERS SHALL BE PLACED SO THAT A (4") DIA. SPHERE CANNOT PASS THROUGH (CODE SECTION 316.2) ENCLOSURES AND DOORS MIN. 22" WIDE ALL TUB / SHOWERS TO HAVE ANTI-SCALD VALVES ALL COUNTERTOPS TO BE STANDARD DEPTH, ALL PLUMBING TO BE PROTECTED AGAINST FREEZING. PLUMBING IN EXTERIOR WALLS TO BE WRAPPED W/ BATT. INSUL. TYP. RAIN GUTTERS ARE OPTIONAL TOP OF FOUNDATION WALL A MIN. OF 6" ABOVE FINISHED GRADE R404.1.6 COORDINATE PLUMBING AND MECHANICAL WITH STRUCTURAL MEMBERS SPRAY FOAM BEHIND ALL OUTLETS ON EXTERIOR WALLS BETTER, BASEMENT EXTERIOR: R-11 OR BETTER ANY WOOD IN CONTACT WITH CONCRETE SHALL BE DECAY RESISTANT LAVATORY TO ANY WALL, FIXTURE OR DOOR. 13. EMERGENCY FLOOR DRAINS SHALL BE INSTALLED AT WATER HEATERS, LAUNDRIES, ETC. AND INCLUDE A DEEP SEAL TRAP

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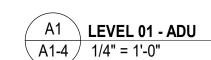
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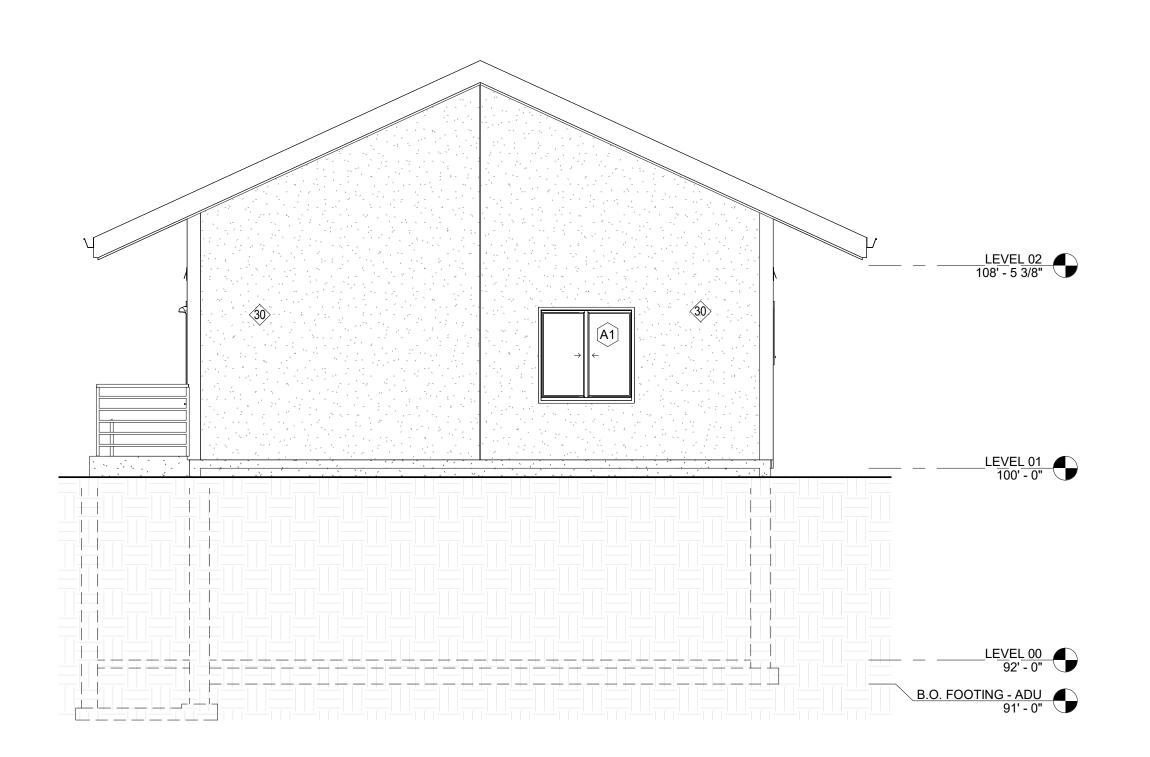
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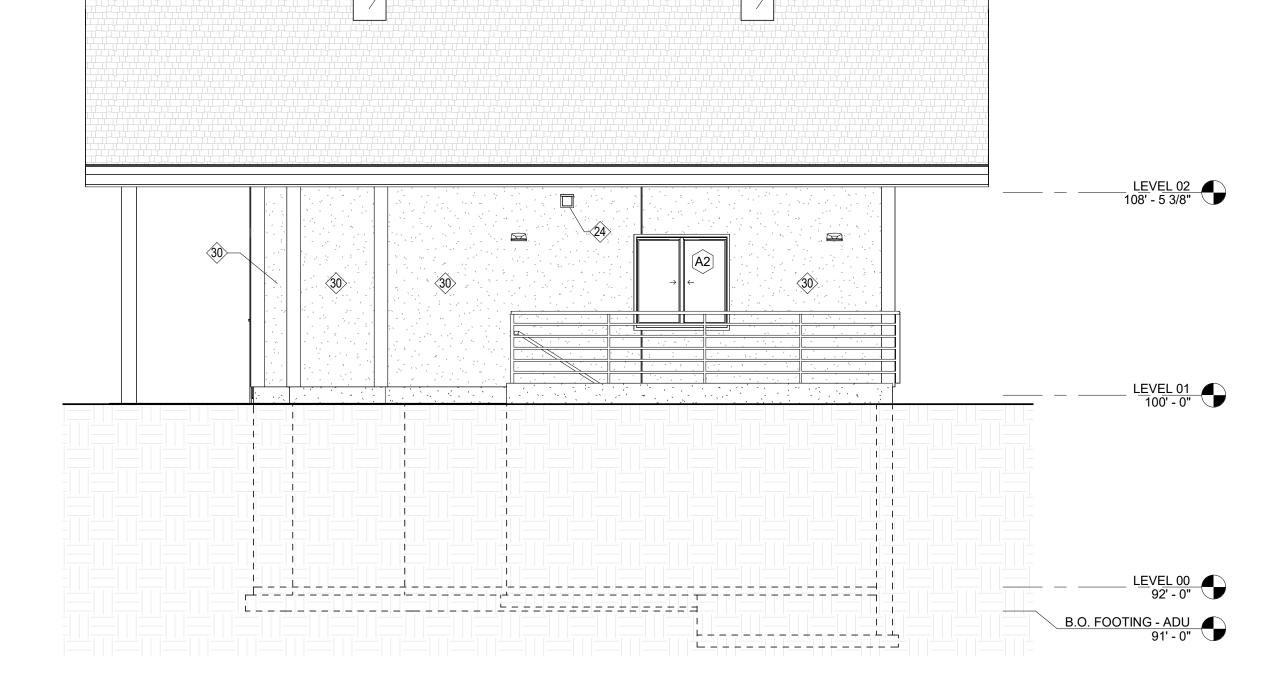
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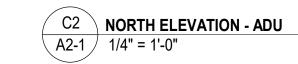


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Mark	Width	Height	Manufacturer	Model	U Value Minimum	Comments
A1	4' - 0"	4' - 0"			0.32	
A2	4' - 0"	4' - 0"			0.32	OBSCURE WINDOW
A3	4' - 0"	4' - 0"			0.32	TRAPEZOID WINDOW
A4	4' - 0"	3' - 4"			0.32	
A5	5' - 10"	7' - 10"			0.32	HEIGHT TO BOTTOM OF SLOPE
A6	4' - 0"	4' - 0"			0.32	TRAPEZOID WINDOW
A7	3' - 0"	2' - 0"			0.32	OPTIONAL OBSCURE PANE
A8	3' - 0"	3' - 0"			0.32	
B1	3' - 0"	4' - 0"				
B2	3' - 0"	4' - 0"				
B3	3' - 0"	4' - 0"				
B4	3' - 0"	4' - 0"				

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<del>\</del> 1	4' - 0"	4' - 0"			0.32	
12	4' - 0"	4' - 0"			0.32	OBSCURE WINDOW
43	4' - 0"	4' - 0"			0.32	TRAPEZOID WINDOW
٦4	4' - 0"	3' - 4"			0.32	
<b>\</b> 5	5' - 10"	7' - 10"			0.32	HEIGHT TO BOTTOM OF SLOPE
46	4' - 0"	4' - 0"			0.32	TRAPEZOID WINDOW
<del>۱</del> 7	3' - 0"	2' - 0"			0.32	OPTIONAL OBSCURE PANE
48	3' - 0"	3' - 0"			0.32	
31	3' - 0"	4' - 0"				
32	3' - 0"	4' - 0"				
33	3' - 0"	4' - 0"				
34	3' - 0"	4' - 0"				









A2 SOUTH ELEVATION - ADU

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oorspace, | **Steve** | 346 SOUTH
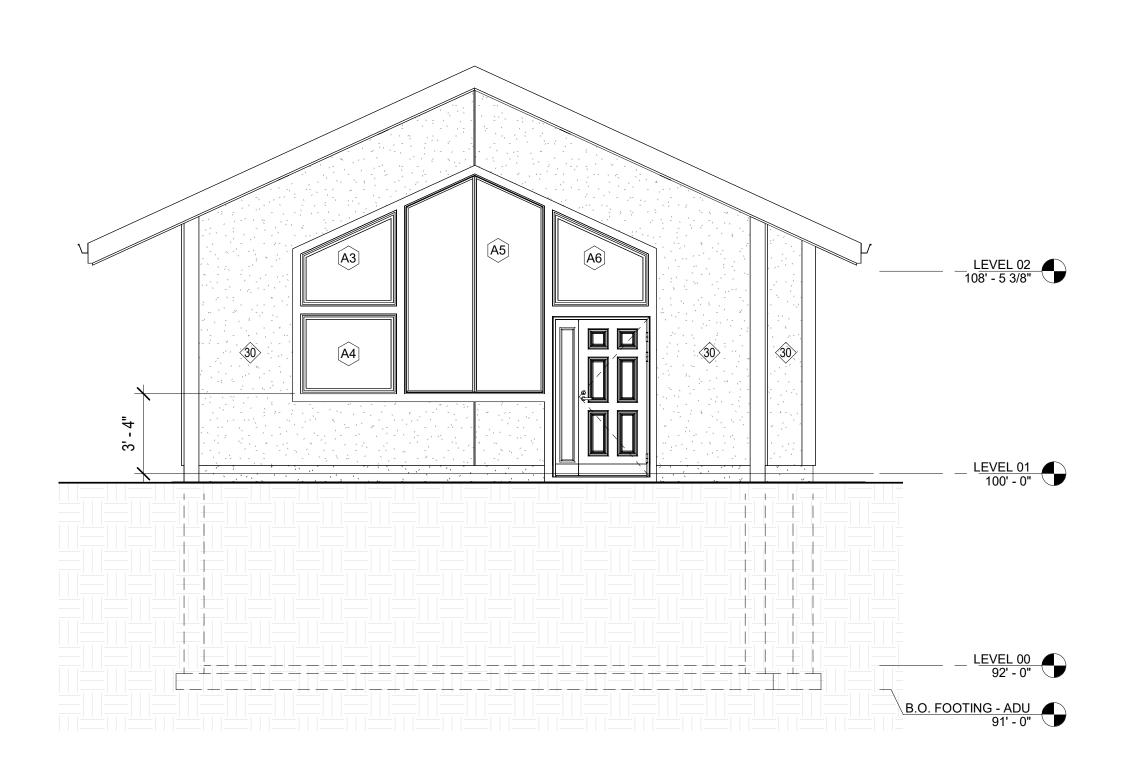
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FILE No. 2021-005
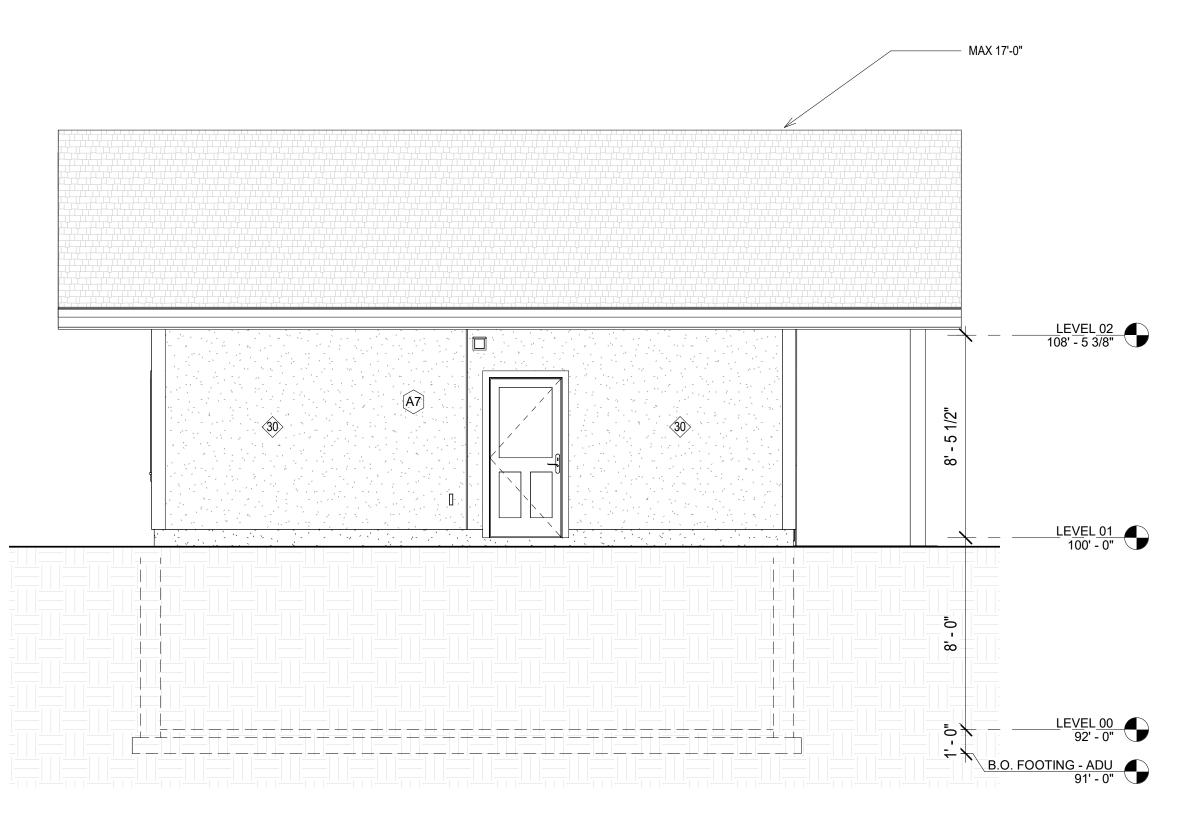
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A2-1

A1 EAST ELEVATION - ADU A2-1 1/4" = 1'-0"

C1 WEST ELEVATION - ADU

A2-1 1/4" = 1'-0"

\_\_\_\_\_\_ <u>LEVEL</u> 02 - <u>GARAGE</u> 109' - 0"

LEVEL 01 100' - 0"

\_\_\_\_\_GARAGE FOOTING 97' - 9 1/2"

4' - 0"

4' - 0"

|3' - 0"

3' - 0"

<u>(8)</u>	EXTEND HOT AND COLD WATER TO WASHER - PROVIDE DRAIN AND LEAD PAN UNDER WASHER AND DRYER
9	DRYER VENT TO EXTERIOR - PROVIDE BACK DRAFT PREVENTER AND BUG SCREEN AT EXTERIOR
<del>(10)</del>	FLOOR DRAIN

STAIRS (TYP) GUARD RAIL AT WALKWAY AND STAIR - 36" HIGH - NO OPENINGS THAT WILL ALLOW A 4" SPHERE TO PASS THROUGH

PROTECT BOTTOM OF STAIRS WITH 5/8" GYP BD

2 x 6 EXTERIOR STUD WALLS W/ R-19 BATT INSULATION - 1/2" GYP BD - TAPE, TEXTURE AND PAINT (TYPICAL EXTERIOR WALLS)

**KEYED NOTES** 

STAIRS - MAX 8" RISE AND 10" TREAD - HANDRAIL AT 36" ABOVE THE NOSE OF

PRIOR TO INSTALLING PLUMBING FIXTURES VERIFY THAT THE SEWER WILL HAVE

ASPHALT SHINGLES ON PRIMARY UNDERLAYMENT (VAPOR BARRIER) - ASPHALT OR APPROVED SYNTHETIC - RIDGE CAPS TO ALSO BE INSTALLED - SEE KEYED

ROOF VENT 1 /300 OF ROOF WITH VENTS - TOTAL VENTING IN ROOF TO BE 1/300 / 650 = 1.08 OR 2 SF OF VENTS

DRYER VENT W/ BACK DRAFT AND BUG SCREEN - MAX LENGTH IN ACCORDANCE

25 1 1/2" GUARDRAIL REQUIRED - 36" HIGH IF THE AREA IS 30" ABOVE ADJACENT FINISH GRADE-NO OPENING TO ALLOW A 4" SPHERE TO PASS

29 2 x 6 STUD WALLS

BALUSTERS SHALL BE PLACED SO THAT A (4") DIA. SPHERE CANNOT PASS

ENCLOSURES AND DOORS MIN. 22" WIDE

ALL COUNTERTOPS TO BE STANDARD DEPTH, ALL PLUMBING TO BE PROTECTED AGAINST FREEZING, PLUMBING IN EXTERIOR WALLS TO BE WRAPPED W/ BATT.

PROVIDE PROPER WALL ANCHORAGE WITH 3 x 3 x 0.029 SQUARE WASHERS. IF WASHER WITH ELONGATED HOLE IS USED PLACE AN APPROVED CUT FOUNDATION

SPRAY FOAM BEHIND ALL OUTLETS ON EXTERIOR WALLS

BETTER, BASEMENT EXTERIOR: R-11 OR BETTER

12. A WATER CLOSET, LAVATORY OR BIDET SHALL NOT BE SET CLOSER THAN 15 INCHES FROM ITS CENTER TO ANY SIDE WALL, PARTITION OR VANITY OR CLOSER THAN 30 INCHES CENTER-TO-CENTER BETWEEN ADJACENT FIXTURES. THERE SHALL BE AT LEAST A 21-INCH CLEARANCE IN FRONT OF THE WATER CLOSET.

14. GLAZING WITHIN 5 FT OF STAIRS TO BE SAFETY GLAZING (TEMPERED OR SIMILAR)

15. CONNECTIONS TO UTILITIES (CULINARY WATER, NATURAL GAS, SANITARY SEWER,

#### **GENERAL NOTES**

OWNER TO HAVE FIRST RIGHT OF REFUSAL TO ALL DEMOLITION ITEMS

WATER, ETC

PROPERLY SHORE ANY STRUCTURAL ITEM TO REMAIN

PROTECT PUBLIC FROM CONSTRUCTION ACTIVITIES

5. ALL EXPOSED SURFACES TO BE PAINTED - TYP.

6. VERIFY DEPTH OF SEWER IN STREET AND THAT THE NEW SEWER LINE IN THE

8. VERIFY ALL DIMENSIONS PRIOR TO COMMENCEMENT OF CONSTRUCTION ACTIVITIES - BRING ANY DISCREPANCIES TO THE ATTENTION OF THE OWNER AND / OR ARCHITECT

<u>LEVEL</u> 02 - GARAGE 109' - 0" LEVEL 01 100' - 0"


B2

A2 SOUTH ELEVATION - GARAGE A2-2 1/4" = 1'-0"


**NORTH ELEVATION - GARAGE** 

A2-2

<sup>/</sup> 1/4" = 1'-0"

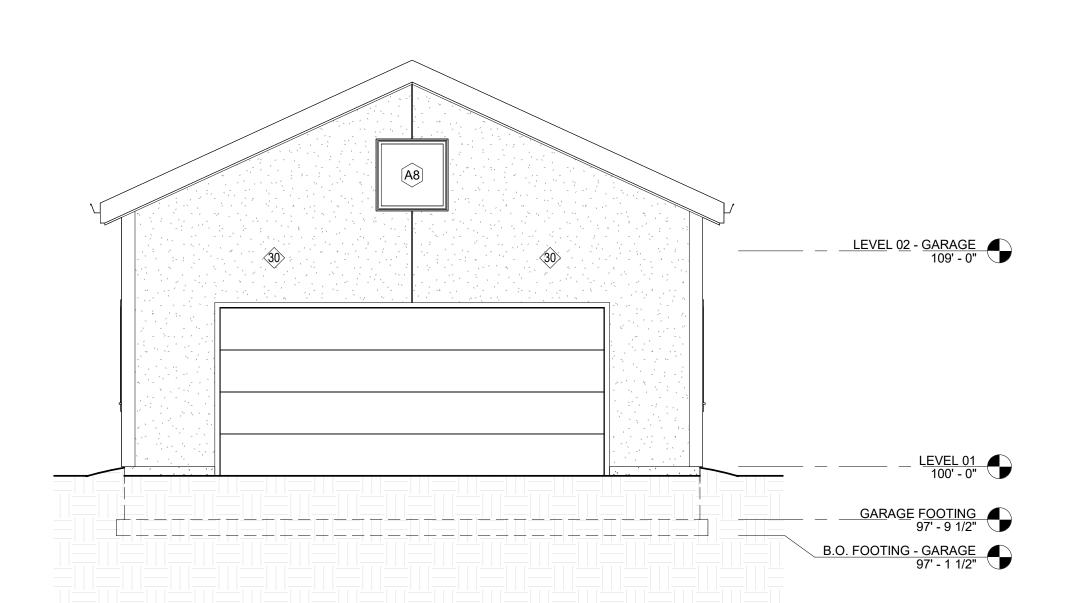

WEST ELEVATION - GARAGE A2-2 1/4" = 1'-0"

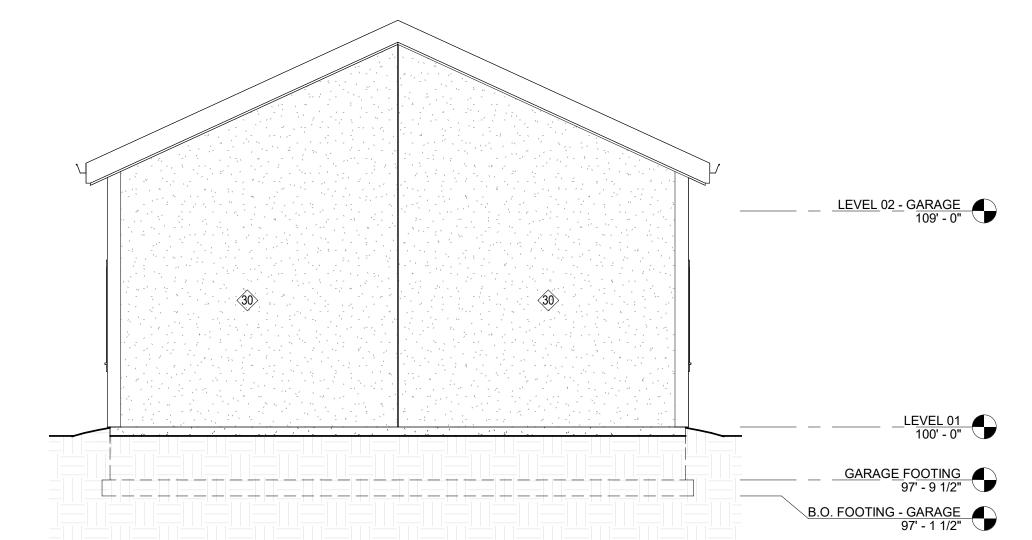

**EAST ELEVATION - GARAGE** A2-2 1/4" = 1'-0"

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architect interiors

anderson, aniloreek, utah 84106

(13) EXHAUST

1/2" RIGID INSULATION

RAIN GUTTER AND DOWN SPOUTS - OPTIONAL

**VENTED SOFFIT** 

2 x 4 INTERIOR STUD WALLS - 1/2" GYP BD - TAPE, TEXTURE AND PAINT

PROPER FALL TO SEWER IN STREET

GARAGE DOOR OPENER

R-49 CEILING INSULATION - TYPICAL - RIGID INSULATION

OF ROOF AREA WITH 50 PERCENT AT RIDGE AND 50 PERCENT AT EAVES - ADU SF

WITH IRC 2015 M1502.4.5

26 DRAIN & DRY WELL

FLOOR INSULATION - R 30 AT UNFINISHED BASEMENT

STRUCTURAL COLUMN - SEE STRUCTURAL

STUCCO FINISH - 3 COAT APPLICATION ON WIRE OVER 5/8" GLASSMAT - FOLLOW MANUFACTURERS RECOMMENDATIONS FOR EXPANSION/CONTROL JOINTS

## **GENERAL NOTES**

THROUGH (CODE SECTION 316.2)

ALL TUB / SHOWERS TO HAVE ANTI-SCALD VALVES

INSUL. TYP.

RAIN GUTTERS ARE OPTIONAL

TOP OF FOUNDATION WALL A MIN. OF 6" ABOVE FINISHED GRADE R404.1.6

WASHER ON TOP OF THE SQUARE WASHER; SEE STRUCTURAL, WHICH GOVERNS COORDINATE PLUMBING AND MECHANICAL WITH STRUCTURAL MEMBERS

10. THERMAL INSULATION TO BE: ATTIC: R-38 OR BETTER, EXTERIOR WALLS: R-19 OR

11. ANY WOOD IN CONTACT WITH CONCRETE SHALL BE DECAY RESISTANT

LAVATORY TO ANY WALL, FIXTURE OR DOOR. 13. EMERGENCY FLOOR DRAINS SHALL BE INSTALLED AT WATER HEATERS, LAUNDRIES, ETC. AND INCLUDE A DEEP SEAL TRAP

PER IRC R308.4.6

ETC.) TO BE EXTERIOR OF BUILDING.

2. PROPERLY PROTECT EXISTING RESIDENCE - COVER TO PROTECT FROM DUST,

BASEMENT WILL HAVE PROPER SLOPE TO SEWER MAIN LINE

7. FURNITURE IS NIC (NOT IN CONTRACT)

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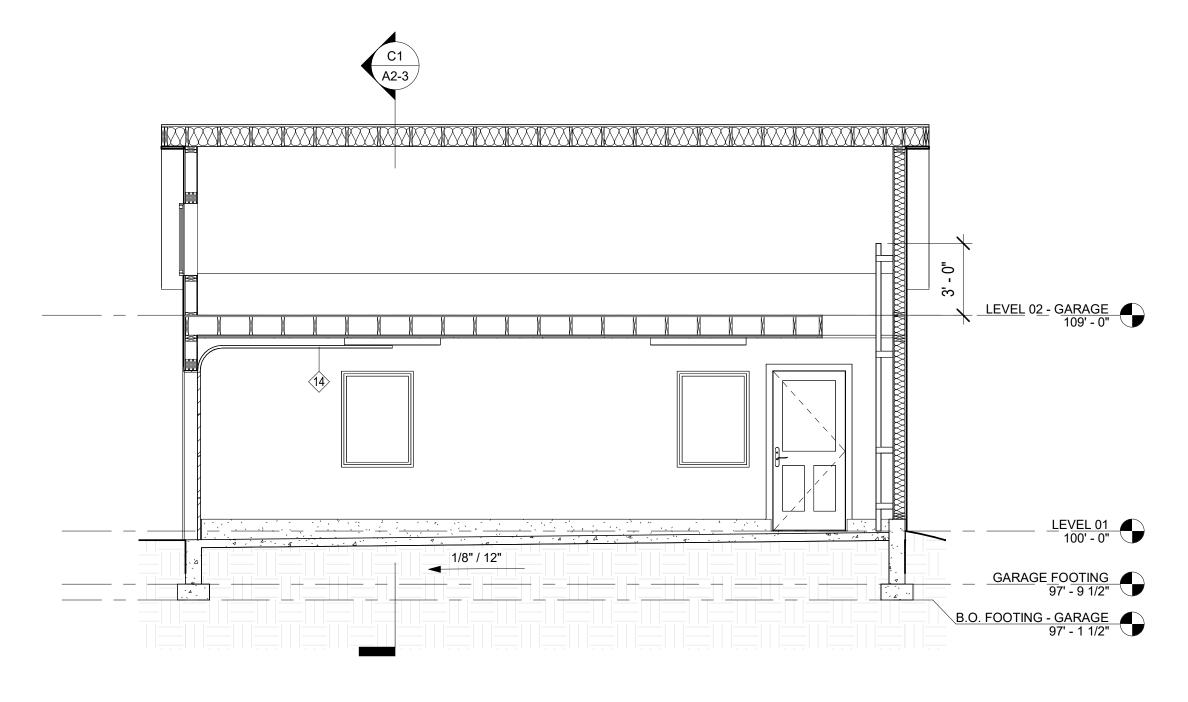
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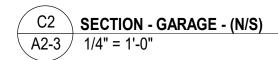
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2021-005 SHEET No.

A2-2





C1 SECTION - GARAGE - (E/W)
A2-3 1/4" = 1'-0"




GARAGE FOOTING 97' - 9 1/2"

B.O. FOOTING - GARAGE 97' - 1 1/2"

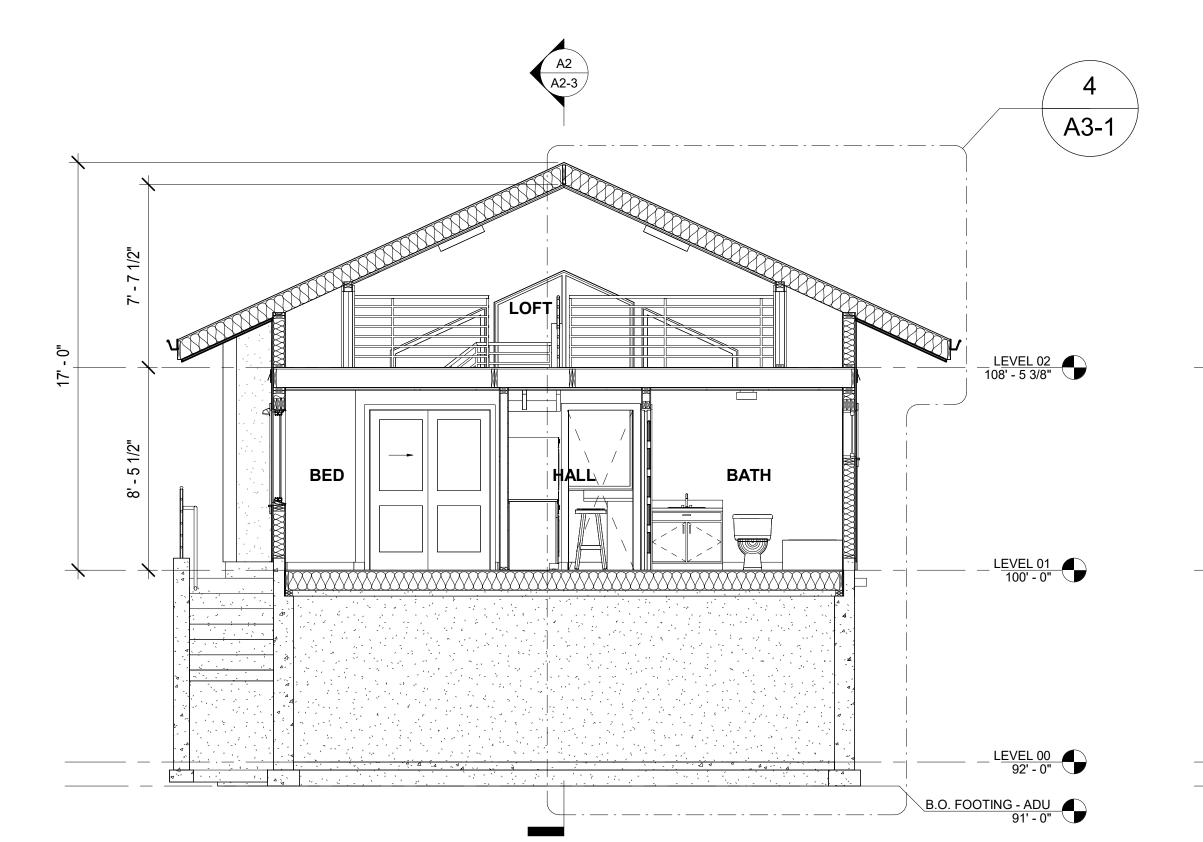

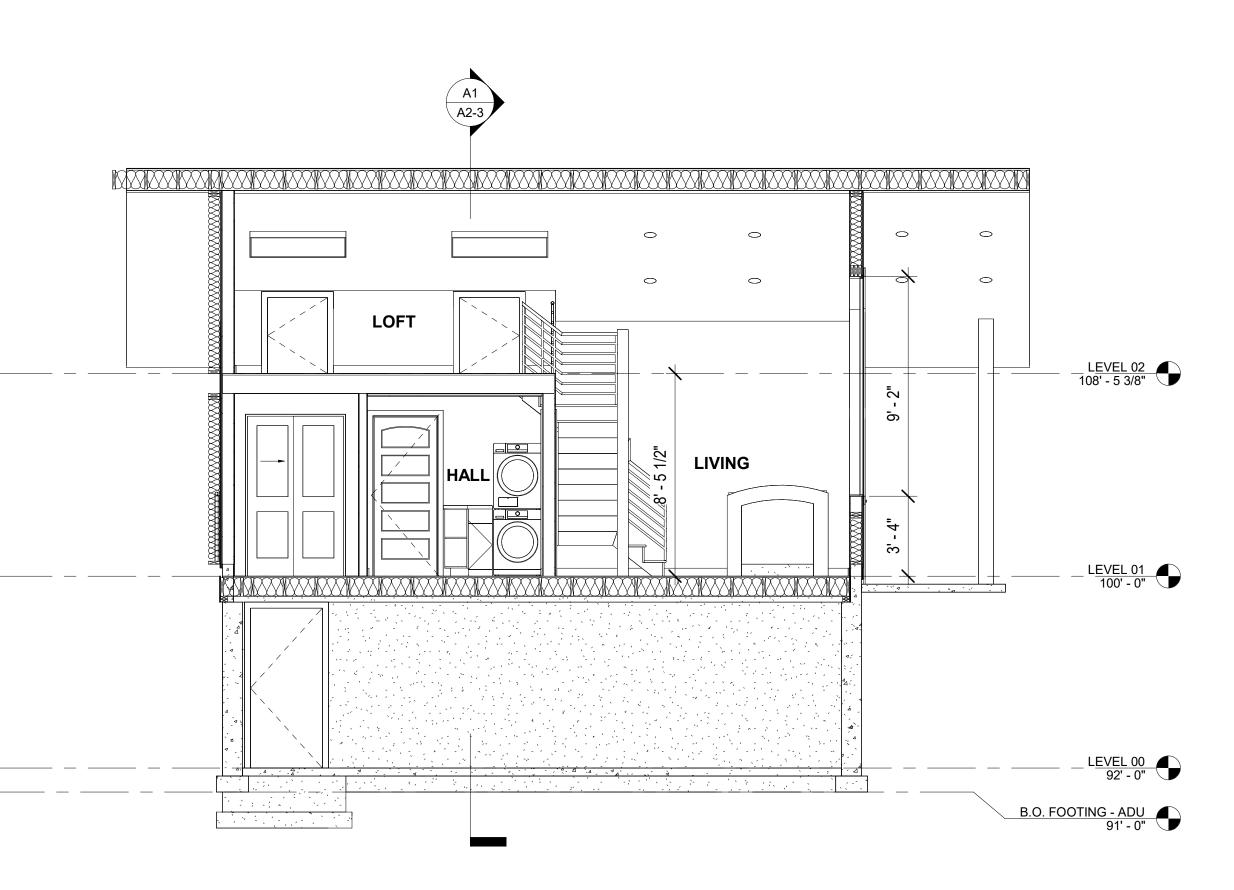

A1 SECTION - ADU - (E/W)
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KEYED NOTES

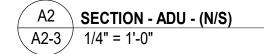8 EXTEND HOT AND COLD WATER TO WASHER - PROVIDE DRAIN AND LEAD PAN UNDER WASHER AND DRYER

DRYER VENT TO EXTERIOR - PROVIDE BACK DRAFT PREVENTER AND BUG SCREEN AT EXTERIOR

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PROTECT BOTTOM OF STAIRS WITH 5/8" GYP BD

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(13) EXHAUST

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WENTED SOFFIT

2 x 6 EXTERIOR STUD WALLS W/ R-19 BATT INSULATION - 1/2" GYP BD - TAPE, TEXTURE AND PAINT (TYPICAL EXTERIOR WALLS)

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ASPHALT SHINGLES ON PRIMARY UNDERLAYMENT (VAPOR BARRIER) - ASPHALT OR APPROVED SYNTHETIC - RIDGE CAPS TO ALSO BE INSTALLED - SEE KEYED NOTE 23

GARAGE DOOR OPENER

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②6 DRAIN & DRY WELL

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28 STRUCTURAL COLUMN - SEE STRUCTURAL

29 2 x 6 STUD WALLS

STUCCO FINISH - 3 COAT APPLICATION ON WIRE OVER 5/8" GLASSMAT - FOLLOW MANUFACTURERS RECOMMENDATIONS FOR EXPANSION/CONTROL JOINTS

# **GENERAL NOTES**

BALUSTERS SHALL BE PLACED SO THAT A (4") DIA. SPHERE CANNOT PASS

THROUGH (CODE SECTION 316.2)
2. ENCLOSURES AND DOORS MIN. 22" WIDE

B. ALL TUB / SHOWERS TO HAVE ANTI-SCALD VALVES

ALL COUNTERTOPS TO HAVE ANTI-SCALD VALVES

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INSUL. TYP. 5. RAIN GUTTERS ARE OPTIONAL

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treet, Salt Lake City, Utah

loorspace, LLC

| Steve Floor
346 SOUTH park Street,

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kim anderson, architect architect architecture - planning - interiors 3335 south 900 east street # 270 millcreek, utah 84106

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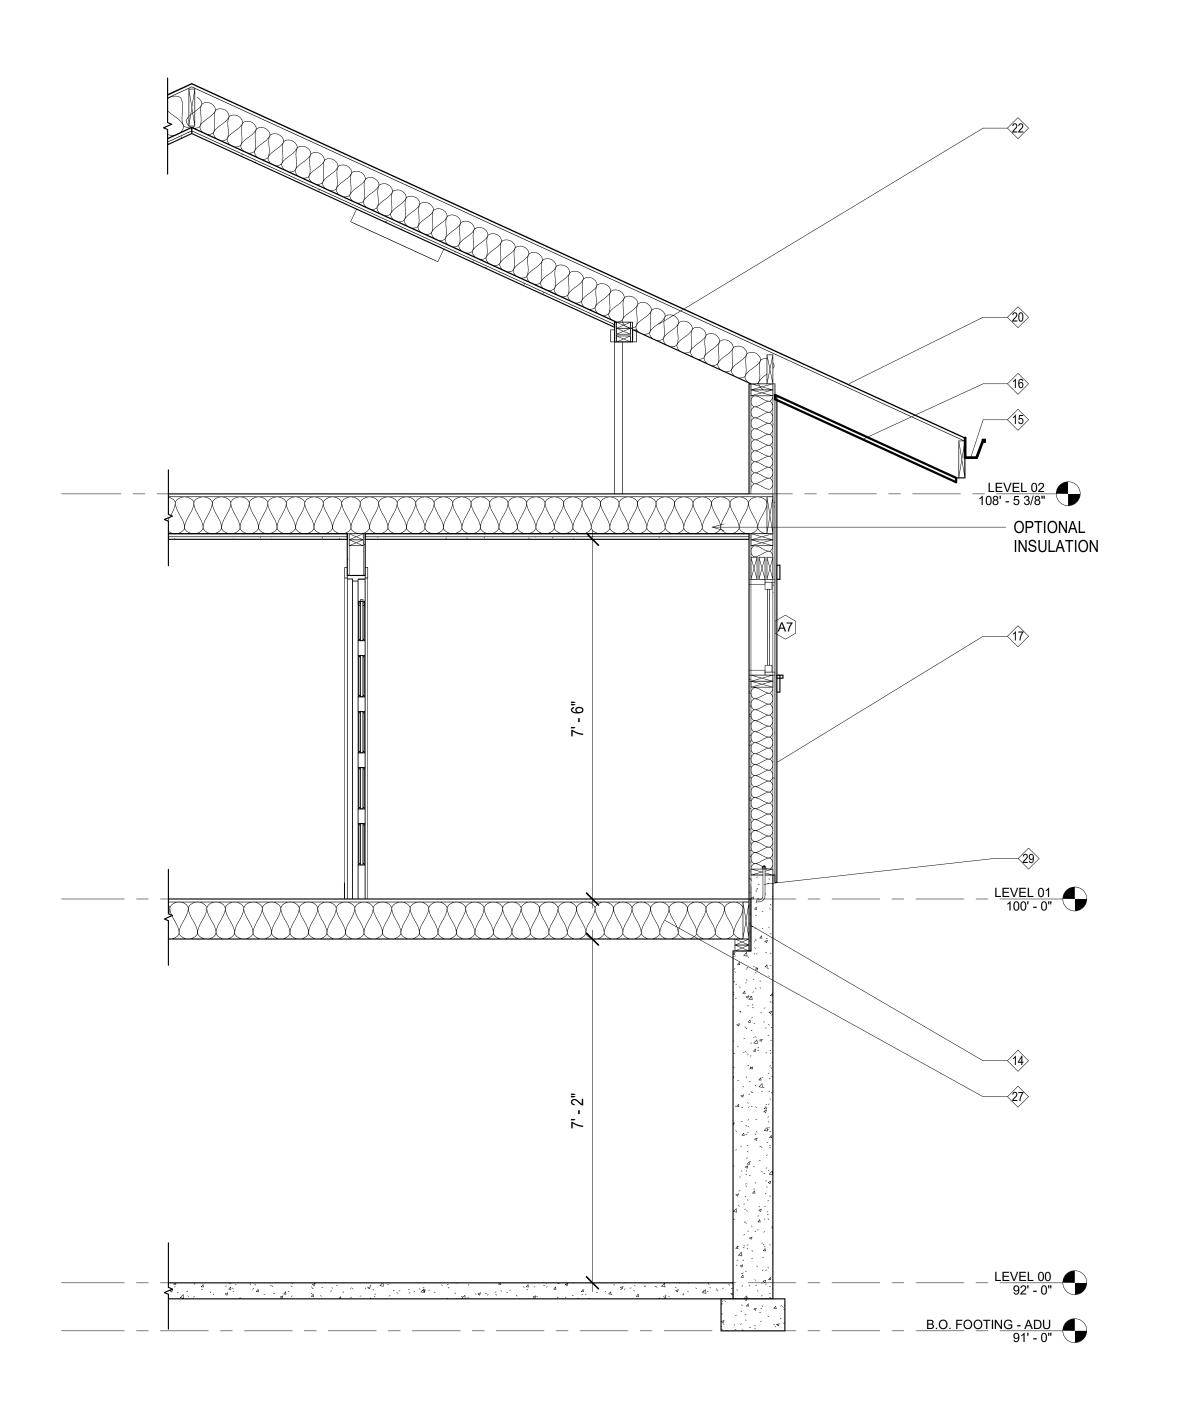
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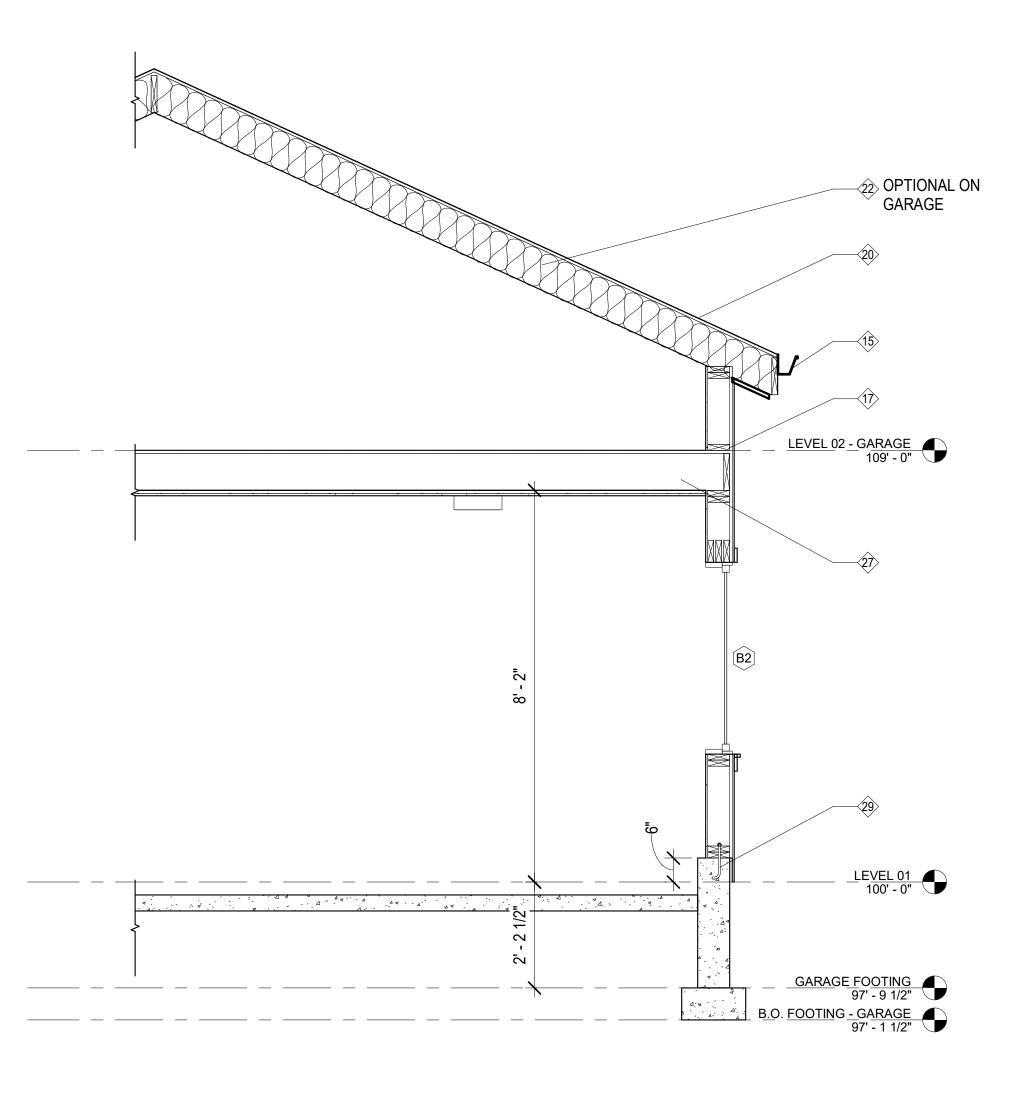
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PROJECT No. 2021-005

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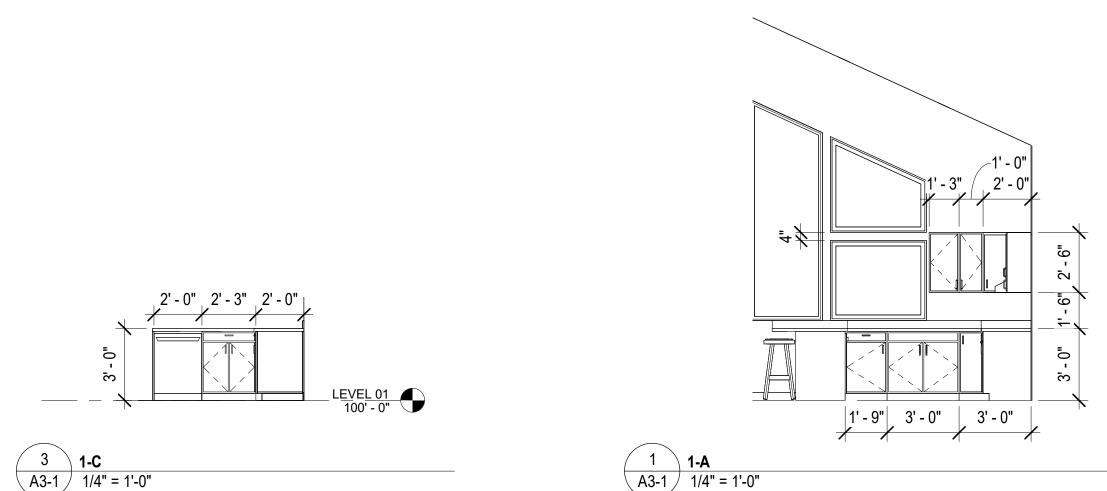
A2-3






5 WALL SECTION - GARAGE - (E/W) \ A3-1 / 1/2" = 1'-0"

WALL SECTION - ADU - (E/W) A3-1 / 1/2" = 1'-0"



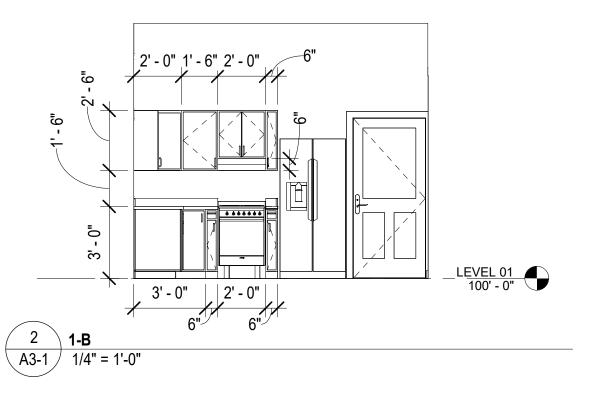

KEYED NOTES

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architect interiors

03-31-22

loorspace, LLC **Steve Floc** 346 SOUTH park

ECTIONS & INTERIO ELEVATIONS


architect

BSC CHECKED

FILE No. 2021-005

FILE NAME PS PROJECT No.

2021-005 SHEET No.

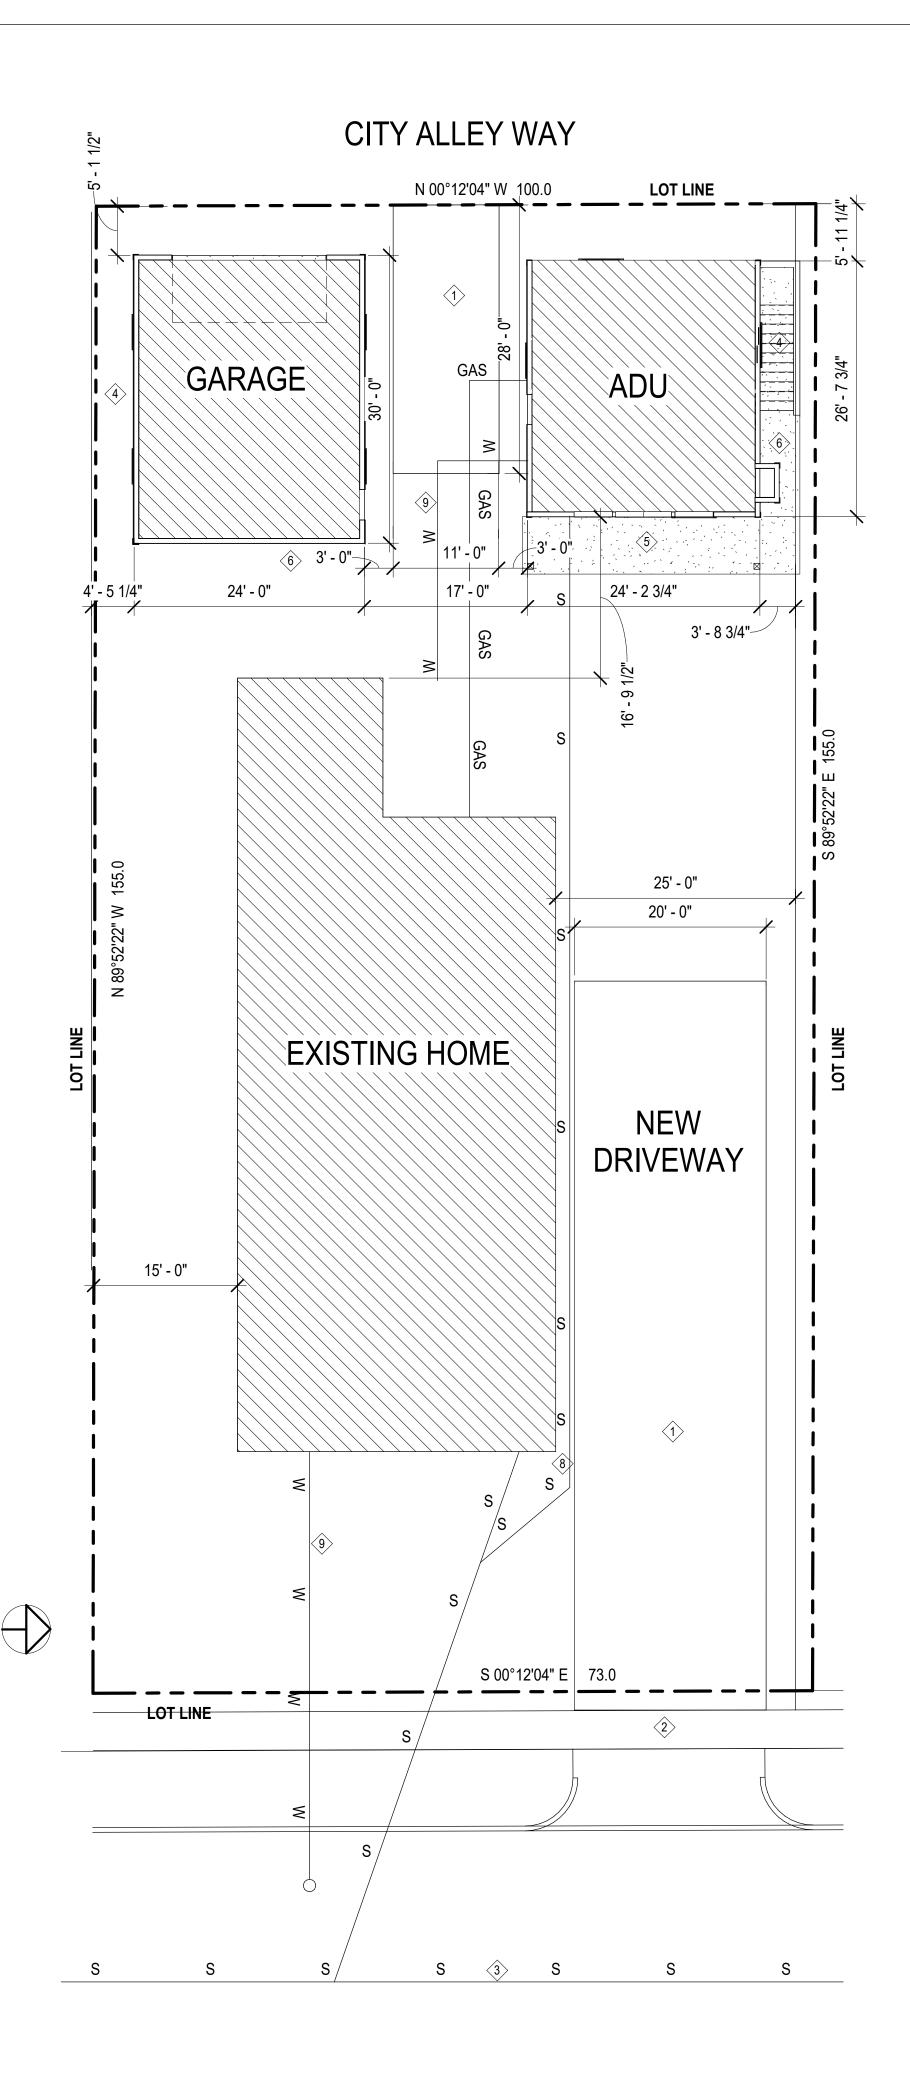



# ADU & GARAGE

2346 South Park Street Salt Lake City, UT

# ARCHITECT

d. kim anderson 3335 south 900 east, #270 millcreek, utah 84106 phone (801) 355-4558

#### STRUCTURAL ENGINEER

JUNE ENGINEERING, PLLC JUNE WANG 1908 VIEW STREET SLAT LAKE CITY, UTAH 84105 PHONE (801) 533-8090 03-31-22

#### CODE REVIEW

ZONING	REQUIRED	PROVIDED
ZONING	R1-7 7,000 SF MIN.	11,315 SF
FRONT YARD	30'	EXISTING
SIDE YARD	4' MIN ON PROPERTY LINE	4' - 0"
REAR YARD	4'	4' - 0" + -
HEIGHT	17' MAX	17' - 0"
AREAS	ADU - 650 SF GARAGE 720 SF EXISTING HOUSE 2,666 SF	TOTAL 4.034
LOT COVERAGE SEE MAX AREA SITE PLAN	60% MAXIMUM	35.65% - OK

#### FOLLOW ALL LOCAL AND CITY CODES - GOVERNING COD IS IRC-2015

	DRAWING INDEX		
Sheet No. Sheet Name			
ARCHITECT	URAL		
SD-1	COVER SHEET - SITE PLAN		
A1-1	FLOOR PLANS - ADU		
A1-2	FLOOR PLANS - GARAGE		
A1-3	ROOF PLANS		
A1-4	REFLECTED CEILING PLANS		
A2-1	BUILDING ELEVATIONS - ADU		
A2-2	BUILDING ELEVATIONS - GARAGE		
A2-3	BUILDING SECTIONS		
A3-1	WALL SECTIONS & INTERIOR ELEVATIONS		
STRUCTUR	AL		
S1	STRUC 1		
S2	STRUC 2		
S3	STRUC 3		

1 FULL BATH ROOM WITH SHOWER/TUB, TOILET AND SINK

1 DOUBLE KITCHEN SINK

1 WASHER HOOK-UP

1 OUTSIDE WATER FAUCETS

NO SINK ADJACENT TO WASHER / DRYER

# KEYED NOTES

- 1. OWNER TO HAVE FIRST RIGHT OF REFUSAL TO ALL DEMOLITION ITEMS
- PROPERLY PROTECT EXISTING RESIDENCE COVER TO PROTECT FROM DUST, WATER, ETC

GENERAL NOTES

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- 1 NEW DRIVEWAY
- ② EXISTING WALKWAY
- ③ SEWER IN STREET VERIFY 87" DEPTH OF EXISTING SEWER
- <a>♦ SIDE YARD</a>
- 5 4" CONCRETE LANDING ON GRAVEL 4" BASE
- RAIN GUTTER AND DOWN SPOUTS OPTIONAL
- ASPHALT SHINGLES ON PRIMARY UNDERLAYMENT (ASPHALT OR APPROVED SYNTHETIC) RIDGE CAPS TO ALSO BE INSTALLED (UNHEATED GARAGE)
- EXISTING GAS METER PROPERLY SIZE AND EXTEND GAS LINE
  TO FURNACE IN THE NEW ADDITION SIZED BY HVAC SUB
  CONTRACTOR
- NEW AND EXISTING WATER LINE



chitecture - planning - ir 3335 south 900 east street # millcreek, utah 84106



PROJECT No.

2021-005 SHEET No.

SD-1

